

500 West Big Beaver Troy, MI 48084 troymi.gov

248.524.3364 planning@troymi.gov

PLANNING COMMISSION MEETING AGENDA REGULAR MEETING

Tom Krent, Chairman, David Lambert, Vice Chairman Carlton Faison, Michael W. Hutson, Lakshmi Malalahalli, Marianna Perakis, Sadek Rahman, Jerry Rauch and John J. Tagle

October 12, 2021

7:00 P.M.

Council Chambers

- 1. ROLL CALL
- 2. <u>APPROVAL OF AGENDA</u>
- 3. APPROVAL OF MINUTES September 28, 2021
- 4. PUBLIC COMMENT For Items Not on the Agenda

SPECIAL USE REQUEST

 <u>PRELIMINARY SITE PLAN REVIEW (SU JPLN2021-0013)</u> - Proposed Center Court at Butterfield 52-unit townhome development, North side of Butterfield, South of Big Beaver, West of Crooks (Parcels 88-20-29-226-021, -022, -023), Section 29, Currently Zoned MF (Multiple-Family Residential) District

OTHER ITEMS

- 6. <u>PUBLIC COMMENTS</u> For Items on the Agenda
- 7. PLANNING COMMISSION COMMENT
- 8. <u>ADJOURN</u>
- **NOTICE:** People with disabilities needing accommodations for effective participation in this meeting should contact the City Clerk by e-mail at <u>clerk@troymi.gov</u> or by calling (248) 524-3317 at least two working days in advance of the meeting. An attempt will be made to make reasonable accommodations.

Chair Krent called the Regular meeting of the Troy City Planning Commission to order at 7:00 p.m. on September 28, 2021, in the Council Chamber of the Troy City Hall. Chair Krent presented opening remarks relative to the role of the Planning Commission and procedure of tonight's meeting.

1. ROLL CALL

<u>Present:</u> Carlton M. Faison Michael W. Hutson Tom Krent David Lambert Lakshmi Malalahalli Marianna Perakis Sadek Rahman Jerry Rauch John J. Tagle

Also Present:

R. Brent Savidant, Community Development Director Ben Carlisle, Carlisle Wortman Associates Julie Quinlan Dufrane, Assistant City Attorney Kathy L. Czarnecki, Recording Secretary

2. <u>APPROVAL OF AGENDA</u>

Resolution # PC-2021-09-068

Moved by: Faison Support by: Lambert

RESOLVED, To approve the Agenda as prepared.

Yes: All present (9)

MOTION CARRIED

3. <u>APPROVAL OF MINUTES</u>

Resolution # PC-2021-09-069

Moved by: Tagle Support by: Rahman

RESOLVED, To approve the minutes of the September 14, 2021, Regular meeting as submitted.

Yes: Faison, Hutson, Krent, Lambert, Malalahalli, Perakis, Rahman, Tagle Abstain: Rauch

MOTION CARRIED

4. <u>PUBLIC COMMENT</u> – For Items Not on the Agenda

There was no one present who wished to speak.

SPECIAL USE REQUEST

 <u>PUBLIC HEARING - SPECIAL USE AND PRELIMINARY SITE PLAN REVIEW (SU</u> <u>JPLN2021-001</u>) – Proposed Panera Bread Café (with Drive Through), East side of Coolidge, South of Maple (1484 Coolidge), Section 32, Currently Zoned MR (Maple Road) District

Mr. Carlisle gave a review of the proposed Special Use Request and Preliminary Site Plan application to convert a financial institution into a Panera Bread Café. He said the footprint would be the same and addressed site improvements such as removal of the existing canopy, additional stacking spaces to the drive-through, additional landscaping, outdoor seating area, additional internal sidewalks and striping, parking refiguration, façade improvements and new dumpster enclosure.

Mr. Carlisle referenced Zoning Ordinance Section 14.04.A as relates to a nonconforming structure. He reported the applicant is not increasing the building nonconformity and re-occupancy of the site is permitted but that the parking must be screened from Coolidge Highway.

Mr. Carlisle addressed engineering concerns noted in his report, the applicant's request to waiver the required loading space, trash enclosure screening, re-submission of a photometric plan, and transparency calculations.

Mr. Carlisle recommends approval of the Special Use and Preliminary Site Plan application with conditions as identified in his report dated September 21, 2021.

Project architect Todd Bundren of Lawrence Group was present. He said Panera is excited about the proposed move and re-use of an existing building, noting the new location offers a drive-through, outdoor patio and rapid pickup. Mr. Bundren addressed angle parking, stating that Panera believes the one-way drive would be safer.

Mr. Bundren said Panera cafes do not typically dedicate loading spaces in any of its locations. He said the larger WB 62 truck deliveries would be twice or three times a week in non-peak hours for approximately 20-30 minutes to unload; deliveries from smaller box trucks are every night after hours to deliver dough. Mr. Bundren asked the Board's consideration in waiving the required loading space and assured the Board that Panera would accommodate the conditions identified in the Planning Consultant report.

PUBLIC HEARING OPENED

There was no one present to speak.

PUBLIC HEARING CLOSED

There was discussion on:

- Moving handicapped parking to west side of building to accommodate easier access to outdoor patio seating.
- Location of loading space if waiver request not granted.
- Traffic concerns with access from Coolidge Highway.
 - Left-hand turn signal, potential traffic backup/congestion.
 - Traffic Consultant review of traffic safety.
 - Consideration of one-way entrance and exit drives.
- Angle parking; as relates to one-way / two-way traffic flow.
- Transparency requirements/calculations.
- Engineering standard to use curb stops.
- Clarification of required number of bicycle spaces.
- Screening of parking on Coolidge Highway.
- Proposed signage; off-site signage not permitted.
- Cross access easements; best management practice.

Resolution # PC-2021-09-070

Moved by: Lambert Support by: Faison

RESOLVED, That Special Use Approval and Preliminary Site Plan Approval for the proposed Panera Bread Café (with Drive Through), East side of Coolidge, South of Maple (1484 Coolidge), Section 32, Currently Zoned MR (Maple Road) District, be granted, subject to the following conditions:

- 1. Screen parking from Coolidge Highway and also screen the trash enclosure.
- 2. Provide transparency calculations.
- 3. Waive the loading space requirement.
- 4. Resubmit the photometric plan and lighting fixture details.
- 5. Address the Engineering Department noted items.
- 6. Move the handicapped parking to the west side of the building.
- 7. Review of the plan by the Traffic Engineer, and recommend that the Coolidge entrances be modified to one-way; south entrance be one-way to enter and north entrance be one-way to exit.

Yes: All present (9)

MOTION CARRIED

OTHER ITEMS

6. <u>PUBLIC COMMENTS</u> – For Items on the Agenda

There was no one present who wished to speak.

7. PLANNING COMMISSION COMMENT

Mr. Lambert encouraged members to listen to public comment at the September 27, 2021 City Council meeting.

Mr. Savidant reported on the following two items presented to City Council at their September 27, 2021 meeting.

- 1) Troy Crossing PUD Proposed Amendment (File No. PUD JPLN2021-0008); granted as initially submitted to Planning Commission.
- 2) Conditional Rezoning (File No. CR JPLN2021-001), Pine View Condominiums; applicant withdrew item.

8. <u>ADJOURN</u>

The Regular meeting of the Planning Commission adjourned at 7:49 p.m.

Respectfully submitted,

Tom Krent, Chair

Kathy L. Czarnecki, Recording Secretary

C:\Users\bob\Documents\Kathy\COT Planning Commission Minutes\2021\Jun through Dec 2021\2021 09 28 Regular Meeting_Draft.doc

DATE: October 7, 2021

- TO: Planning Commission
- FROM: R. Brent Savidant, Community Development Director
- SUBJECT: <u>PRELIMINARY SITE PLAN REVIEW (SU JPLN2021-0013)</u> Proposed Center Court at Butterfield 52-unit townhome development, North side of Butterfield, South of Big Beaver, West of Crooks (Parcels 88-20-29-226-021, -022, -023), Section 29, Currently Zoned MF (Multiple-Family Residential) District

The petitioner Eureka Building Co. submitted the above referenced Preliminary Site Plan application for a 52-unit condominium townhome development. Attached townhomes are permitted by right in the MF (Multiple-Family Residential) Zoning District.

The attached report prepared by Carlisle/Wortman Associates, Inc. (CWA), the City's Planning Consultant, summarizes the project. CWA prepared the report with input from various City departments including Planning, Engineering, Public Works and Fire. City Management supports the findings of fact contained in the report and the recommendations included therein.

Attachments:

1. Maps

- 2. Report prepared by Carlisle/Wortman Associates, Inc.
- 3. Preliminary Site Plan.

G:\SITE PLANS\SP JPLN2021-0013 CENTER COURT AT BUTTERFIELD\PC Memo 2021 10 12.docx

PROPOSED RESOLUTION

<u>PRELIMINARY SITE PLAN REVIEW (SU JPLN2021-0013)</u> - Proposed Center Court at Butterfield 52-unit townhome development, North side of Butterfield, South of Big Beaver, West of Crooks (Parcels 88-20-29-226-021, -022, -023), Section 29, Currently Zoned MF (Multiple-Family Residential) District

Resolution # PC-2021-10-

Moved by: Seconded by:

RESOLVED, The Planning Commission recommends that Preliminary Site Plan Approval, pursuant to Article 8 of the Zoning Ordinance, as requested for the proposed Center Court at Butterfield 52-unit townhome development, North side of Butterfield, South of Big Beaver, West of Crooks (Parcels 88-20-29-226-021, -022, -023), Section 29, Currently Zoned MF (Multiple-Family Residential) District, be granted, subject to the following:

- 1. Provide details of playground area
- 2. Landscape shrubs used to screen at grade equipment to be coniferous in order to provide year-round screening
- 3. Add recreational site amenities
- 4. Revise guest parking spaces

) or
(denied, for the following reasons:) or
(postponed, for the following reasons:)

Yes: No:

MOTION CARRIED/FAILED



1,189

GIS Online

0

595


1,189Feet



Note: The information provided by this application has been compiled from recorded deeds, plats, tax maps, surveys, and other public records and data. It is not a legally recorded map survey. Users of this data are hereby notified that the source information represented should be consulted for verification.



GIS Online

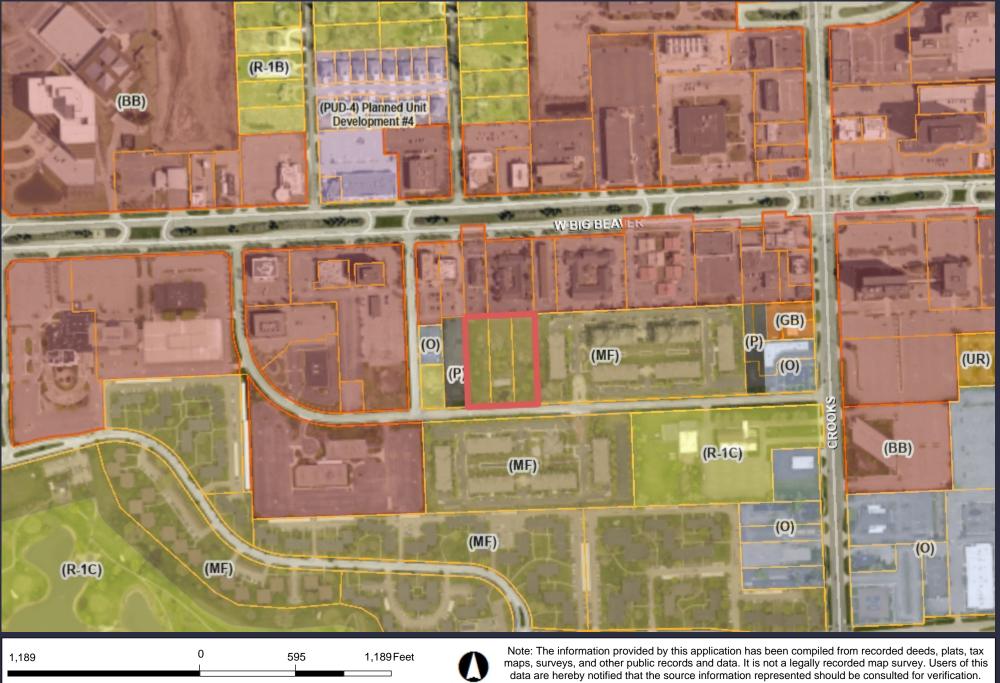



117 NORTH FIRST STREET SUITE 70 ANN ARBOR, MI 48104 734.662.2200 734.662.1935 FAX

Date:

October 5, 2021 October 7, 2021

Preliminary Site Plan For City of Troy, Michigan

Applicant:	Eureka Building Company
Project Name:	Center Court at Butterfield
Plan Date:	October 6, 2021
Location:	Northside of Butterfield Road
Zoning:	MF, Multiple Family Residential
Action Requested:	Preliminary Site Plan Approval

PROJECT AND SITE DESCRIPTION

We are in receipt of a Preliminary Site Plan application that includes a site plan, topographic survey, preliminary utility and grading plan, tree inventory, landscape plan, and floorplans and elevations. The subject site is 3.0 acres. The site is located on northside of Butterfield Road. Butterfield Road connects from Big Beaver to Crooks.

The applicant is requesting approval of a fifty-two (52) unit for sale attached condominium project. The fifty-two (52) units are distributed in twelve (12) buildings. All buildings are three (3) stories, 37-feet (to peak) in height. The proposed residential use is permitted in the MF, Multiple Family district. The development is accessed off of Butterfield and served with an internal private drive.

The site is currently three parcels, which will be combined as part of the development. The existing vacant home will be demolished as part of the development of the site.

Center Court at Butterfield. October 7, 2021

Location of subject site:

Northside of Butterfield Road

Location and Aerial Image of Subject Site



Size of subject site:

The property is 3.0 acres in area.

Proposed use of subject site:

The proposed use is for fifty-two (52) for-sale attached condominium units.

Current use of subject site:

The property currently has one (1) vacant single-family home.

Current Zoning:

The property is currently zoned MF, Multiple Family Residential District.

Surrounding Property Details:

Direction	Zoning	Use
North	BB, Big Beaver	Office
South	MF, Multiple Family Residential District	Multiple Family Residential
East	MF, Multiple Family Residential District	Multiple Family Residential
West	P, Vehicle Parking District	Parking, Stormwater

NATURAL RESOURCES

Topography – The site is relatively flat with little elevation changes.

Woodlands – The applicant has submitted a tree survey. Trees on site include Cottonwood, Ash, and Box Elder, which are non-regulated trees; however, the applicant is removing 10 protected trees.

Replacement Details		
Protected Tree	Inches Removed	Replacement Required
Landmark	102 inches	102 inches
Woodland	59 inches	30 inches
Preservation/Mitigation	Inches Preserved	Credit
Landmark	0 inches	0 inches
Woodland	0 inches	0 inches
Protected Replacement Required	132 Inches	
Preservation Credit	29.5 Inches	
Total 132-inches of replacement required		cement required
Total Tree Mitigation	132 inches of replac	ement required.
	Replacement require	ement shown on landscape
	plan	

Wetlands/Floodplain: 100 Year Flood Plain on site. EGLE Permit will be required. FEMA application may be necessary. City GIS indicates no wetlands on site.

Items to be Addressed: None

SITE ARRANGEMENT

The fifty-two (52) units are distributed in twelve (12) buildings. The development is accessed off of Butterfield and served with an internal-ring private drive. Private garages are directly accessed from the private drive. Eight (8) of the buildings "ring" the exterior of the site, with the buildings fronting on the exterior of the site. Four (4) buildings are internal to the site, and front on an interior courtyard.

Items to be Addressed: None

AREA, WIDTH, HEIGHT, SETBACKS

Required and Provided Dimensions:

Table 4.08.C establishes the requirements for the MF, Multiple Family District. The requirements and the proposed dimensions are as follows:

	<u>Required /</u> <u>Allowed:</u>	Provided:	<u>Compliance:</u>
Front	30 feet	30 feet	Complies
Rear	30 feet	30 feet	Complies
Side	30 feet	30 feet	Complies
Density	24 units an acre	17.3 units an acre	Complies
Maximum Height	8 stories	3 stories, 33-feet (to mid- point) 37-feet (to peak)	Complies
Maximum Lot Area Covered by Buildings	30%	27.4 %	Complies
Minimum Floor Area per Unit	600-1,200 sq/ft	Over 1,200 sq/ft per unit	Complies
Recreation Space. (450) square feet per dwelling unit. Such recreational facilities may include, but not be limited to, swimming pools, tennis courts, playgrounds, picnic areas, playfields, and jogging trails.	450 sq/ft x 52 = 23,400 sq/ft.	Applicant has shown the required area in the form of sidewalks and internal playground area. Details of the proposed playground was not shown.	Complies with additional items

Applicant should add additional site amenities to enhance the recreation area including additional landscaping, lighting, and sitting areas. We note that there are no such amenities provided on this site.

Items to be addressed: 1. Provide details of playground area; and 2). Add site amenities.

SITE ACCESS AND CIRCULATION

Vehicular Access:

Site access is directly from Butterfield. Vehicular circulation is provided via internal drive. Sheet C-2.0 indicates the internal drive accommodates the turning movement of a 40-foot long pumper truck. This will be verified by Fire during Final review. Fire lanes will be required to be posted.

A traffic study was not required as part of Engineering review.

Pedestrian Circulation:

The applicant is providing a complete pedestrian circulation system within development

Items to be Addressed: None

PARKING

Section 13.06.G of the Zoning Ordinance requires:

	Required	Provided
Condominium: 2 spaces per unit	52 Units = 104 spaces	104 spaces within garages
		+ 26 at-grade guest
		spaces
Barrier Free	1	1
Bicycle Parking	2	2
Loading	0	0
Total	104 automobile + 2 bicycle	130 spaces + 2 bicycle

Applicant will need to revise some of the guest parking. Reversing out of some of these spaces would be difficult, as there isn't enough space for a traditional 3-point turn.

Items to be Addressed: 1. Revise guest parking spaces.

LANDSCAPING

Landscaping is regulated by Section 13.02:

	Required:	Provided:	<u>Compliance:</u>
Butterfield Street Trees: The Ordinance	318 feet = 11	9 trees	Complies
requires that the greenbelt shall be	trees		
landscaped with a minimum of one (1)			
deciduous tree for every thirty (30) lineal			

feet, or fraction thereof, of frontage abutting a public road right-of-way.			
Site landscaping: A minimum of fifteen (15%) of the site area shall be comprised of landscape material. Up to twenty-five percent (25%) of the required landscape area may be brink, stone, pavers, or other public plaza elements, but shall not include any parking area or required sidewalks.	20%	30%	Complies
Parking Lot Trees: 1 per 8 spaces	26 spaces = 4 trees	4 trees	Complies
Mitigation	132 inches = 53 trees	53 trees	Complies

The applicant is proposing a 4-foot ornamental fence that runs along the front (Butterfield) and along the eastern property line. There is an existing wall along the northern and western property line that will remain.

Transformer / Trash Enclosure:

Each individual unit will have a trash bin and will be rolled out during trash pickup day.

Equipment:

Mechanical equipment, including HVAC, are not shown on the plans. A note on Sheet L-1.0 indicates that utility/AC units will be screened with landscape shrubs. Species of shrubs is not provided.

Items to be Addressed: Landscape shrubs used to screen at grade equipment to be coniferous in order to provide year-round screening.

FLOOR PLANS AND ELEVATIONS

The applicant is has submitted floor plans and elevations. Materials include a combination of brick, stone, and cement board siding. Couple of points of consideration:

- 1. The side elevations lack fenestration and little architectural details; and
- 2. How does this architecture, material choice, and color palette relate and complement the Regents Club?

Items to be Addressed: 1). Consider adding details to the side elevations; and 2). Provide narrative as to how does this architecture, material choice, and color palette relate and complement the Regents Club.

RECOMMENDATIONS

We recommend preliminary site plan approval with the following conditions:

Center Court at Butterfield. October 7, 2021

- 1. Provide details of playground area
- 2. Landscape shrubs used to screen at grade equipment to be coniferous in order to provide yearround screening.
- 3. Add site amenities
- 4. Revise guest parking spaces
- 5. Address elevations and materials as directed by the Planning Commission

R. Cali

CARLISLE/WORTMAN ASSOC., INC. Benjamin R. Carlisle, LEED AP, AICP

CENTER COURT DEVELOPMENT BUTTERFIELD ROAD EAST OF TODD DR. CITY OF TROY, OAKLAND COUNTY, MICHIGAN

DESIGN TEAM

DEVELOPER

EUREKA BUILDING COMPANY 5960 LIVERNOIS TROY, MI 48085 CONTACT: ERION NIKOLLA PHONE: 586.405.4080 EMAIL: EUREKABLD@GMAIL.COM

ARCHITECT

ARKO DESIGN ASSOCIATES 2298 YASMIN DRIVE COMMERCE TWP., MI 48382 PHONE: 248.802.8409

CIVIL ENGINEER

PEA GROUP 2430 ROCHESTER COURT, STE. 100 TROY, MI 48083-1872 CONTACT: GREG BONO, PE PHONE: 844.813.2949 EMAIL: GBONO@PEAGROUP.COM

LANDSCAPE ARCHITECT

PEA GROUP 45 W. GRAND RIVER AVE., STE. 501 DETROIT, MI 48226 CONTACT: NOAH BIRMELIN, PLA, ASLA PHONE: 844.813.2949 EMAIL: NBIRMELIN@PEAGROUP.COM

PRELIMINARY SITE PLANS



$\mathbf{P} = \mathbf{\Lambda}$ GROUP




	INDEX OF DRAWINGS
Sheet Number	Sheet Title
C-0.0	COVER SHEET
C-1.0	TOPOGRAPHIC SURVEY
C-2.0	PRELIMINARY SITE PLAN
C-3.0	PRELIMINARY GRADING PLAN
C-4.0	PRELIMINARY UTILITY PLAN
C-5.0	NOTES AND DETAILS
L-1.0	PRELIMINARY LANDSCAPE PLAN
T-1.0	TREE PRESERVATION PLAN
SL-1.0	PHOTOMETRIC PLAN
A0.1	4-UNIT FOUNDATION PLAN
A1.0	4-UNIT LOWER LEVEL FLOOR PLAN
A1.1	4-UNIT MAIN LEVEL FLOOR PLAN
A1.2	4-UNIT UPPER LEVEL FLOOR PLAN
A1.3	4-UNIT FRONT ELEVATION
A1.4	4-UNIT SIDE ELEVATION
A0.2	5-UNIT FOUNDATION PLAN
A2.0	5-UNIT LOWER LEVEL FLOOR PLAN
A2.1	5-UNIT MAIN LEVEL FLOOR PLAN
A2.2	5-UNIT UPPER LEVEL FLOOR PLAN
A2.3	5-UNIT FRONT ELEVATION
A2.4	5-UNIT SIDE ELEVATION

REVISIONS

DESCRIPTION ORIGINAL ISSUE DATE CITY COMMENTS

DATE 9/10/2021 10/6/2021



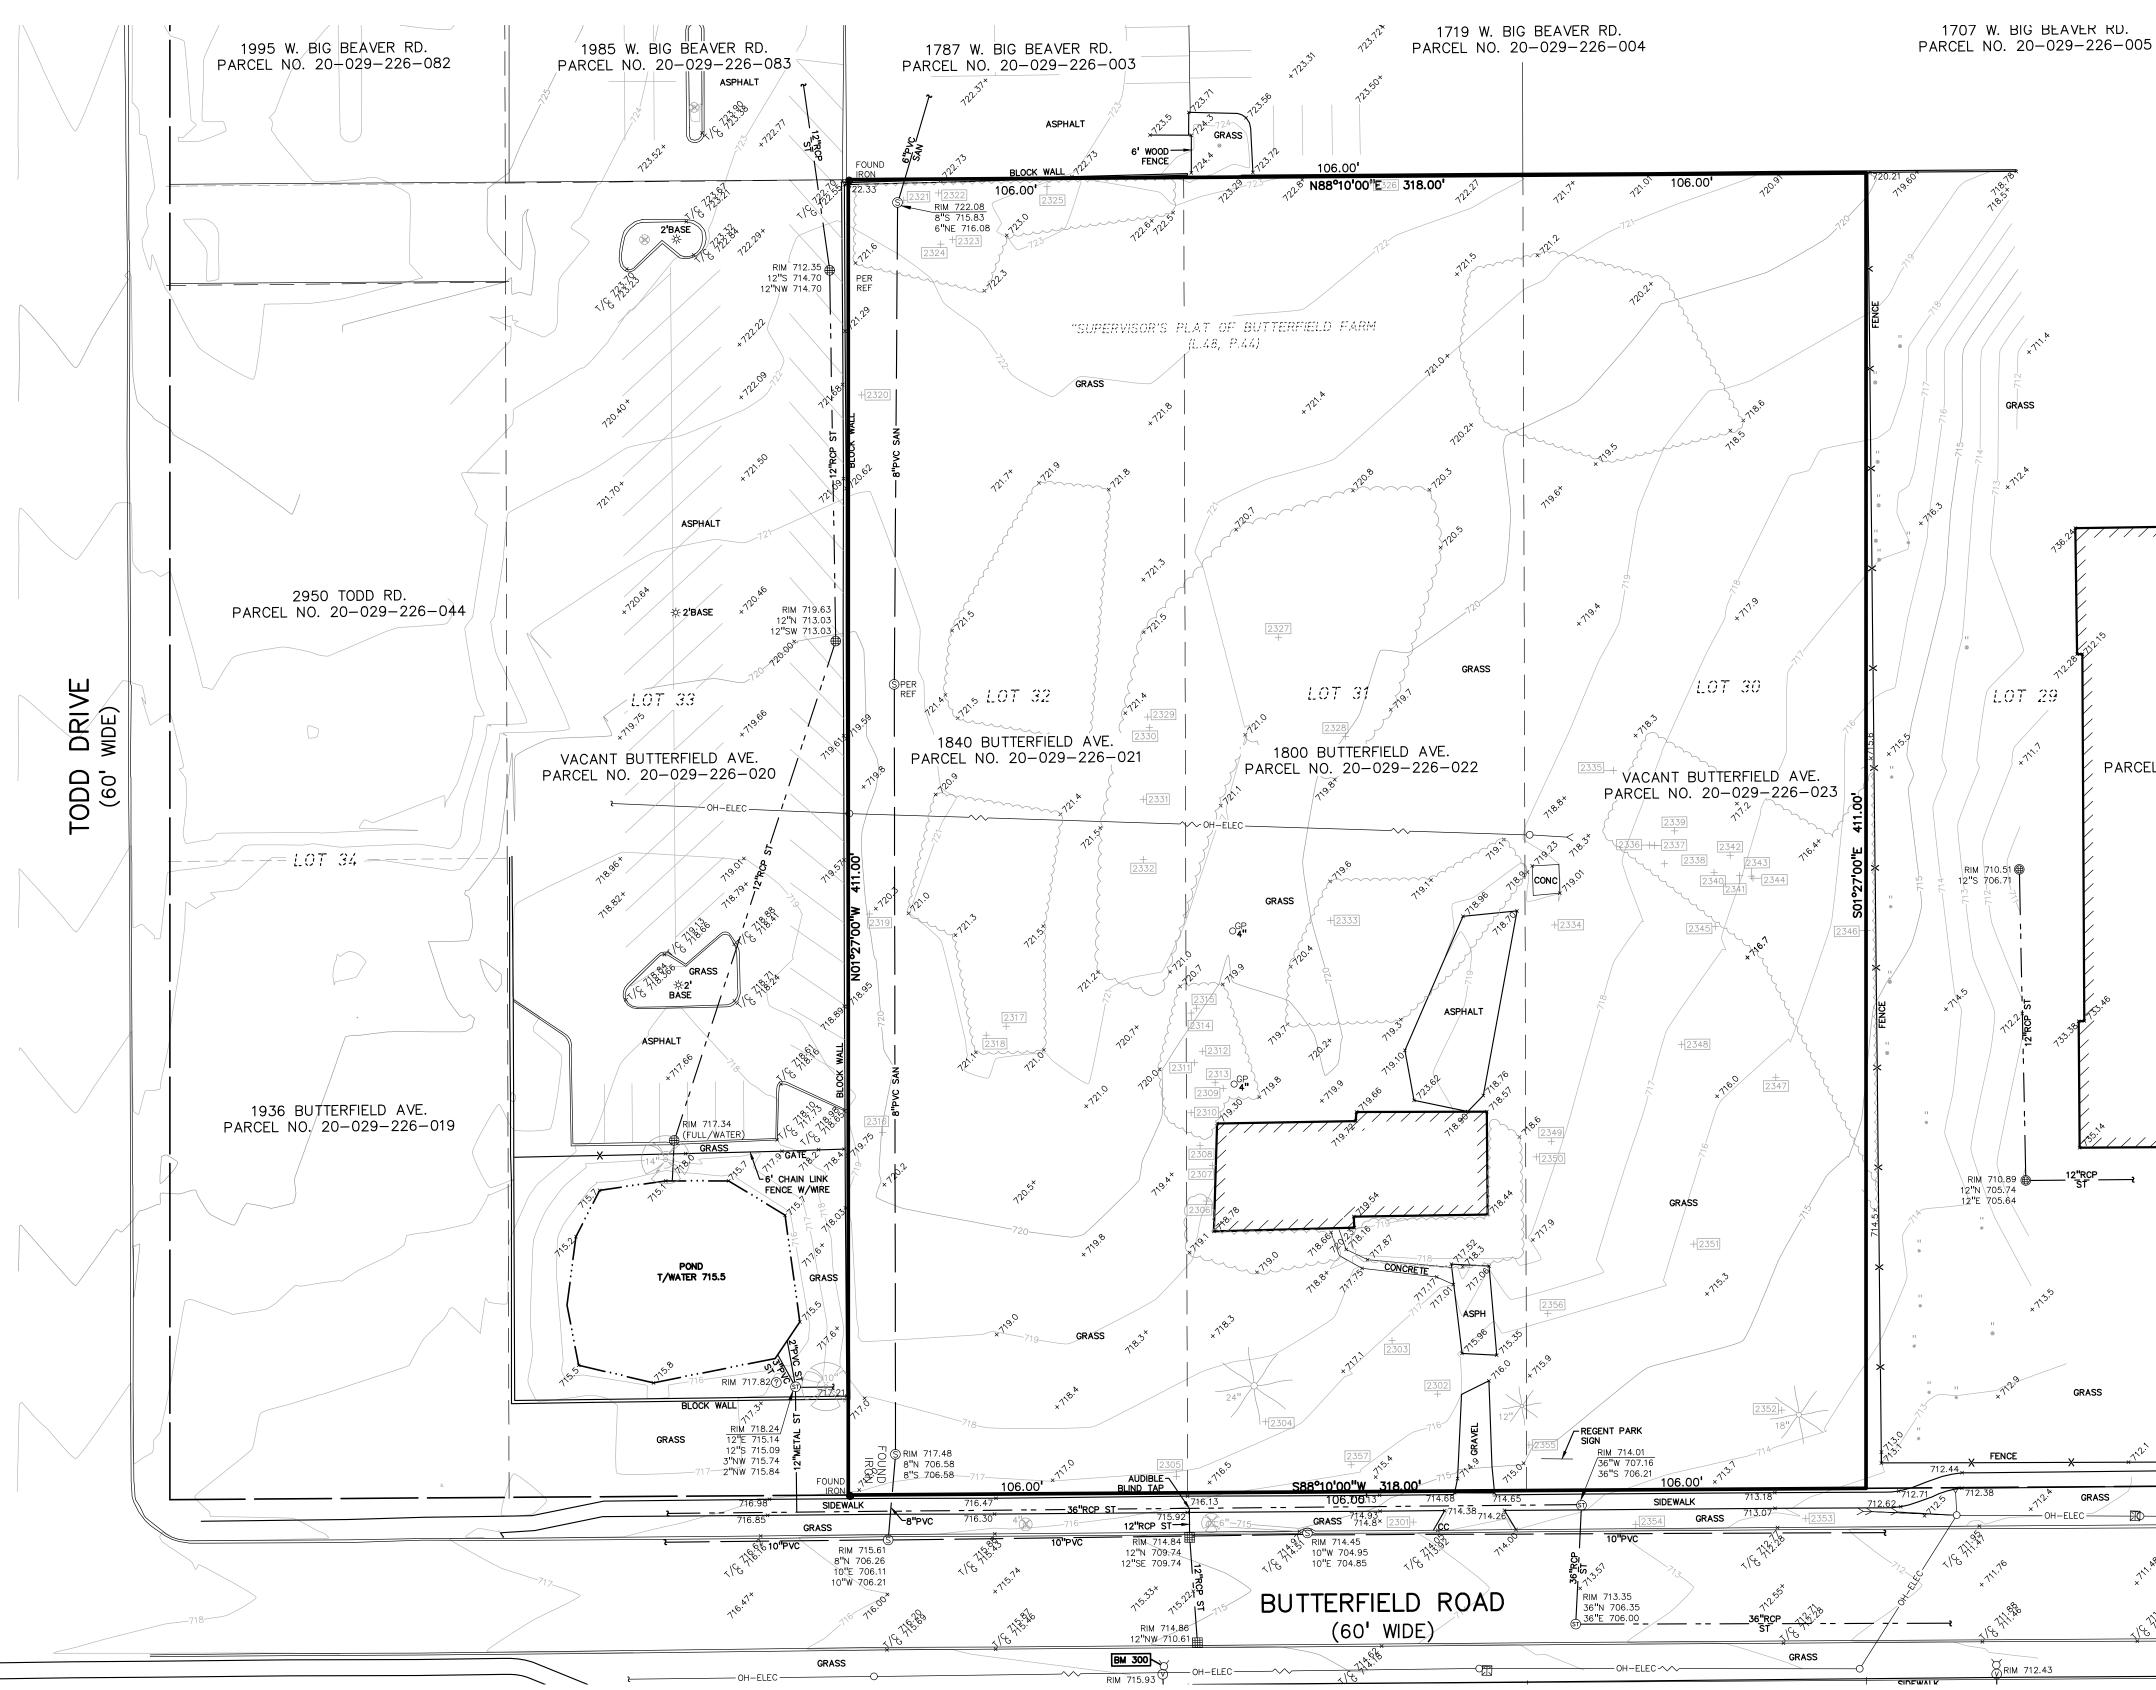

PEA JOB NO.	2021-0134
P.M.	JPB
DN.	KRD
DES.	GMB
DRAWING NUMBER	

C-1.0



SEPTEMBER 10, 2021

ORIGINAL ISSUE DATE:

CITY COMMENTS 10/06/21

REVISIONS

CENTER COURT DEVELOPMENT BUTTERFIELD RD EAST OF TODD DR TROY, MI

PROJECT TITLE

EUREKA BUILDING COMPANY 5960 LIVERNOIS TROY, MI

CLIENT

W. BIG BEAVER ROAD 75 BUTTERFIELD W. MAPLE ROAD

Call before you dig CAUTION!! THE LOCATIONS AND ELEVATIONS OF EXISTING UNDERGROUND UTILITIES AS SHOWN ON THIS DRAWING ARE ONLY APPROXIMATE. NO GUARANTEE IS EITHER EXPRESSED OR IMPLIED AS TO THE COMPLETENESS OR ACCURACY THEREOF. THE CONTRACTOR SHALL BE EXCLUSIVELY RESPONSIBLE FOR DETERMINING THE EXACT UTILITY LOCATIONS AND ELEVATIONS PRIOR TO THE START OF CONSTRUCTION.

EXISTING -OH-ELEC-W-O- ELEC., PHONE OR CABLE TV O.H. LINE, POLE & GUY WIRE SANITARY SEWER, CLEANOUT & MANHOLE COMBINED SEWER & MANHOLE SQUARE, ROUND & BEEHIVE CATCH BASIN, YARD DRAIN POST INDICATOR VALVE WATER VALVE BOX/HYDRANT VALVE BOX, SERVICE SHUTOFF M T I MAILBOX, TRANSFORMER, IRRIGATION CONTROL VALVE UNIDENTIFIED STRUCTURE ⊘ , SPOT ELEVATION ×° CONTOUR LINE -☆- STREET LIGHT ----SIGN CONCRETE

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BRASS PLUG SET MONUMENT FOUND 🔘 MONUMENT SET


LEGEND

SEC. CORNER FOUND R RECORDED M MEASURED C CALCULATED

 $P \equiv A$ GROUP t: 844.813.2949 www.peagroup.com





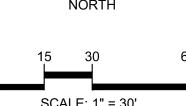







LEGAL DESCRIPTION (Per Access Oakland)

PARCEL 20-29-226-021

Land in the City of Troy, Oakland County, Michigan, described as follows: T2N, R11E, SEC 29 SUPERVISOR'S PLAT OF BUTTERFIELD FARM LOT 32

PARCEL 20-29-226-022 Land in the City of Troy, Oakland County, Michigan, described as follows:

T2N, R11E, SEC 29 SUPERVISOR'S PLAT OF BUTTERFIELD FARM LOT 31 PARCEL 20-29-226-023

Land in the City of Troy, Oakland County, Michigan, described as follows: T2N, R11E, SEC 29 SUPERVISOR'S PLAT OF BUTTERFIELD FARM LOT 30

BM #300 ARROW ON A HYDRANT LOCATED ON THE SOUTH SIDE OF BUTTERFIELD ROAD, APPROX. 340' EAST FROM THE CENTERLINE OF TODD ROAD.


FLOODPLAIN NOTE: BY GRAPHICAL PLOTTING, SITE IS WITHIN ZONE 'X', AREA DETERMINED TO BE OUTSIDE OF THE 0.2% ANNUAL CHANCE FLOODPLAIN PER FLOOD INSURANCE RATE MAP NUMBER 26125C0541F, EFFECTIVE SEPTEMBER 29, 2006.

ELEV. – 718.15

BENCHMARKS (GPS DERIVED - NAVD88)


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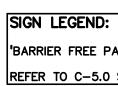


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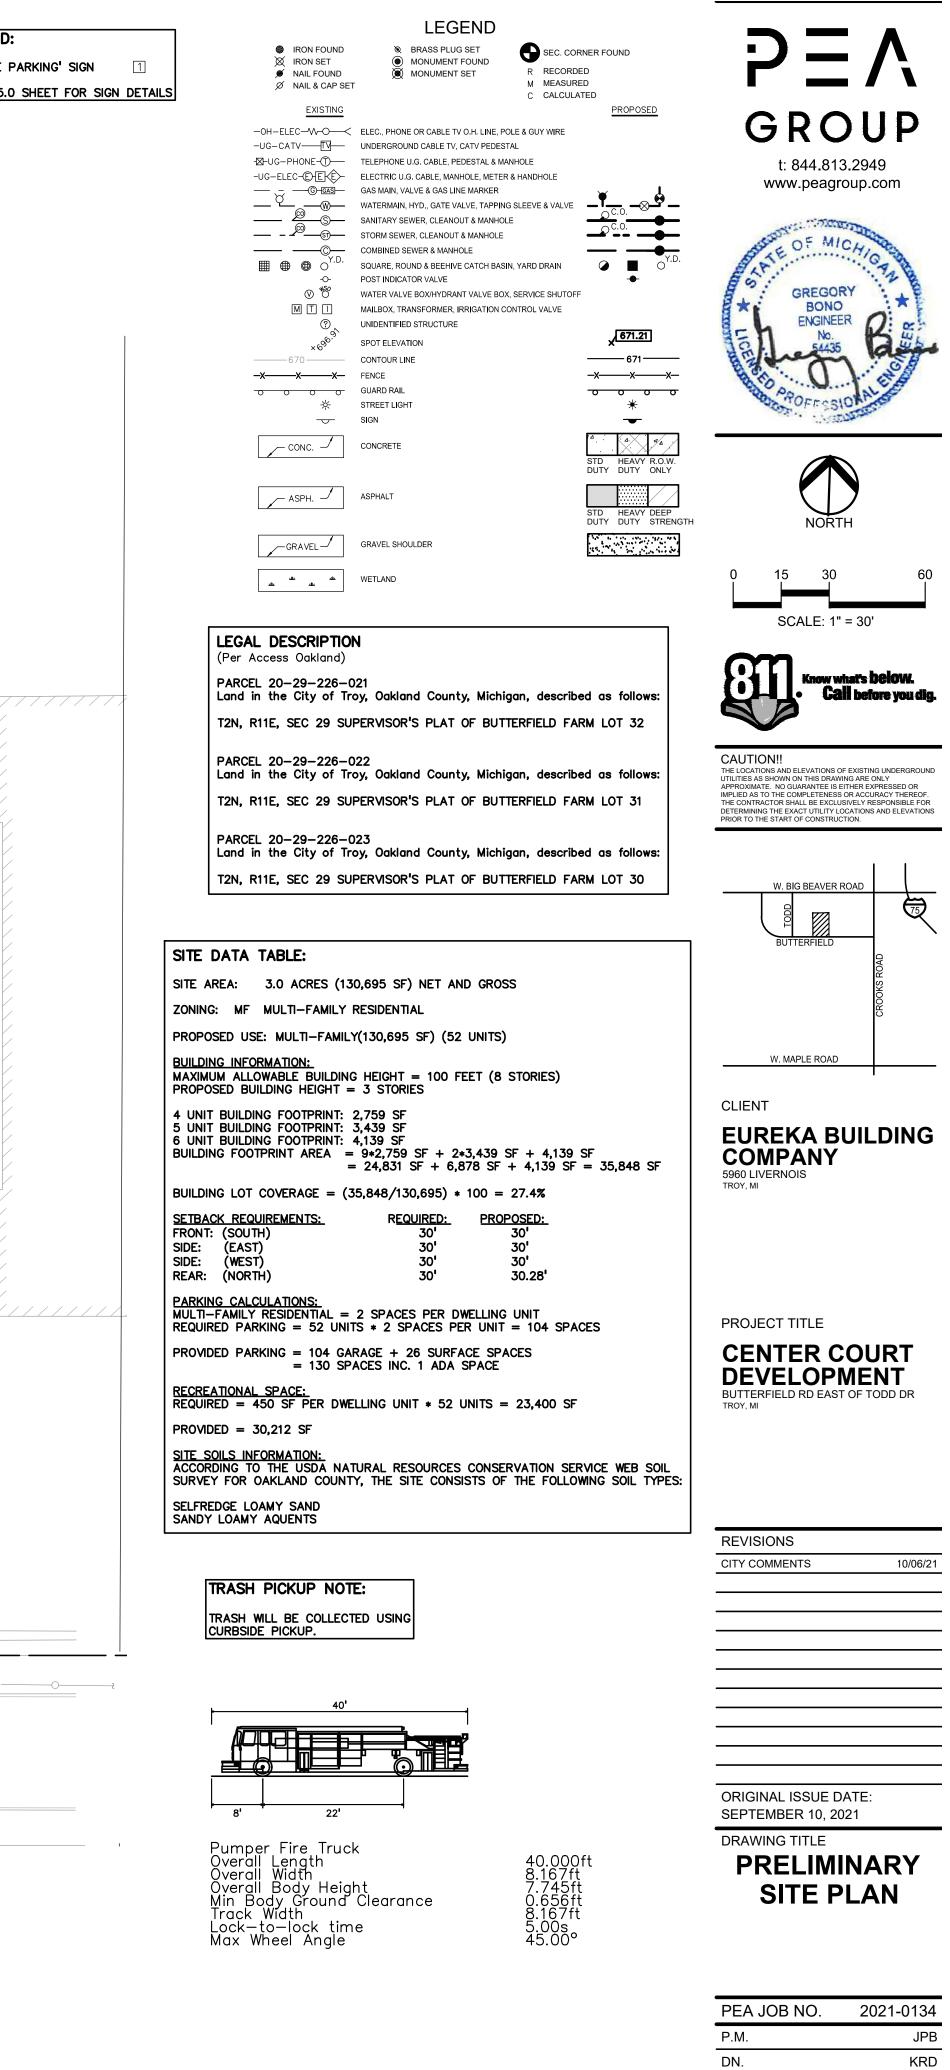
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BARRIER FREE PARKING' SIGN REFER TO C-5.0 SHEET FOR SIGN DETAILS

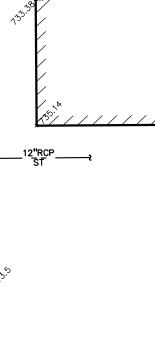


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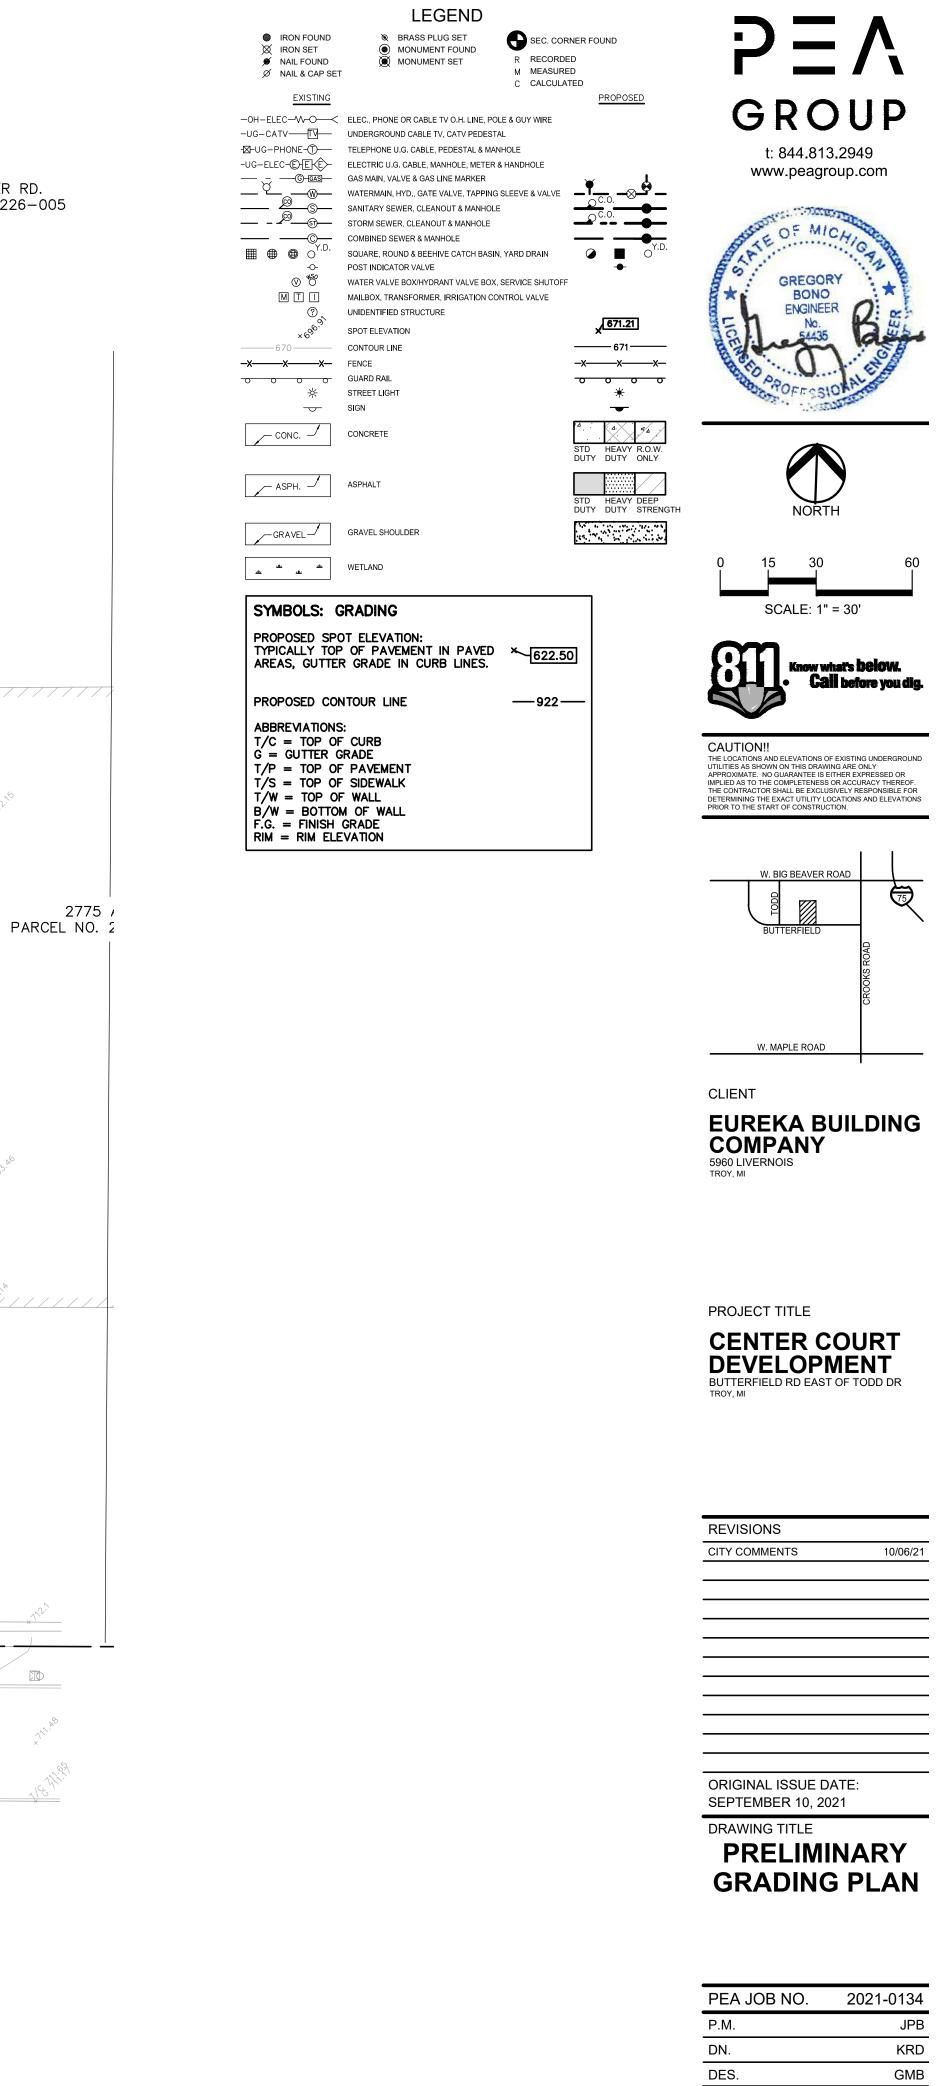
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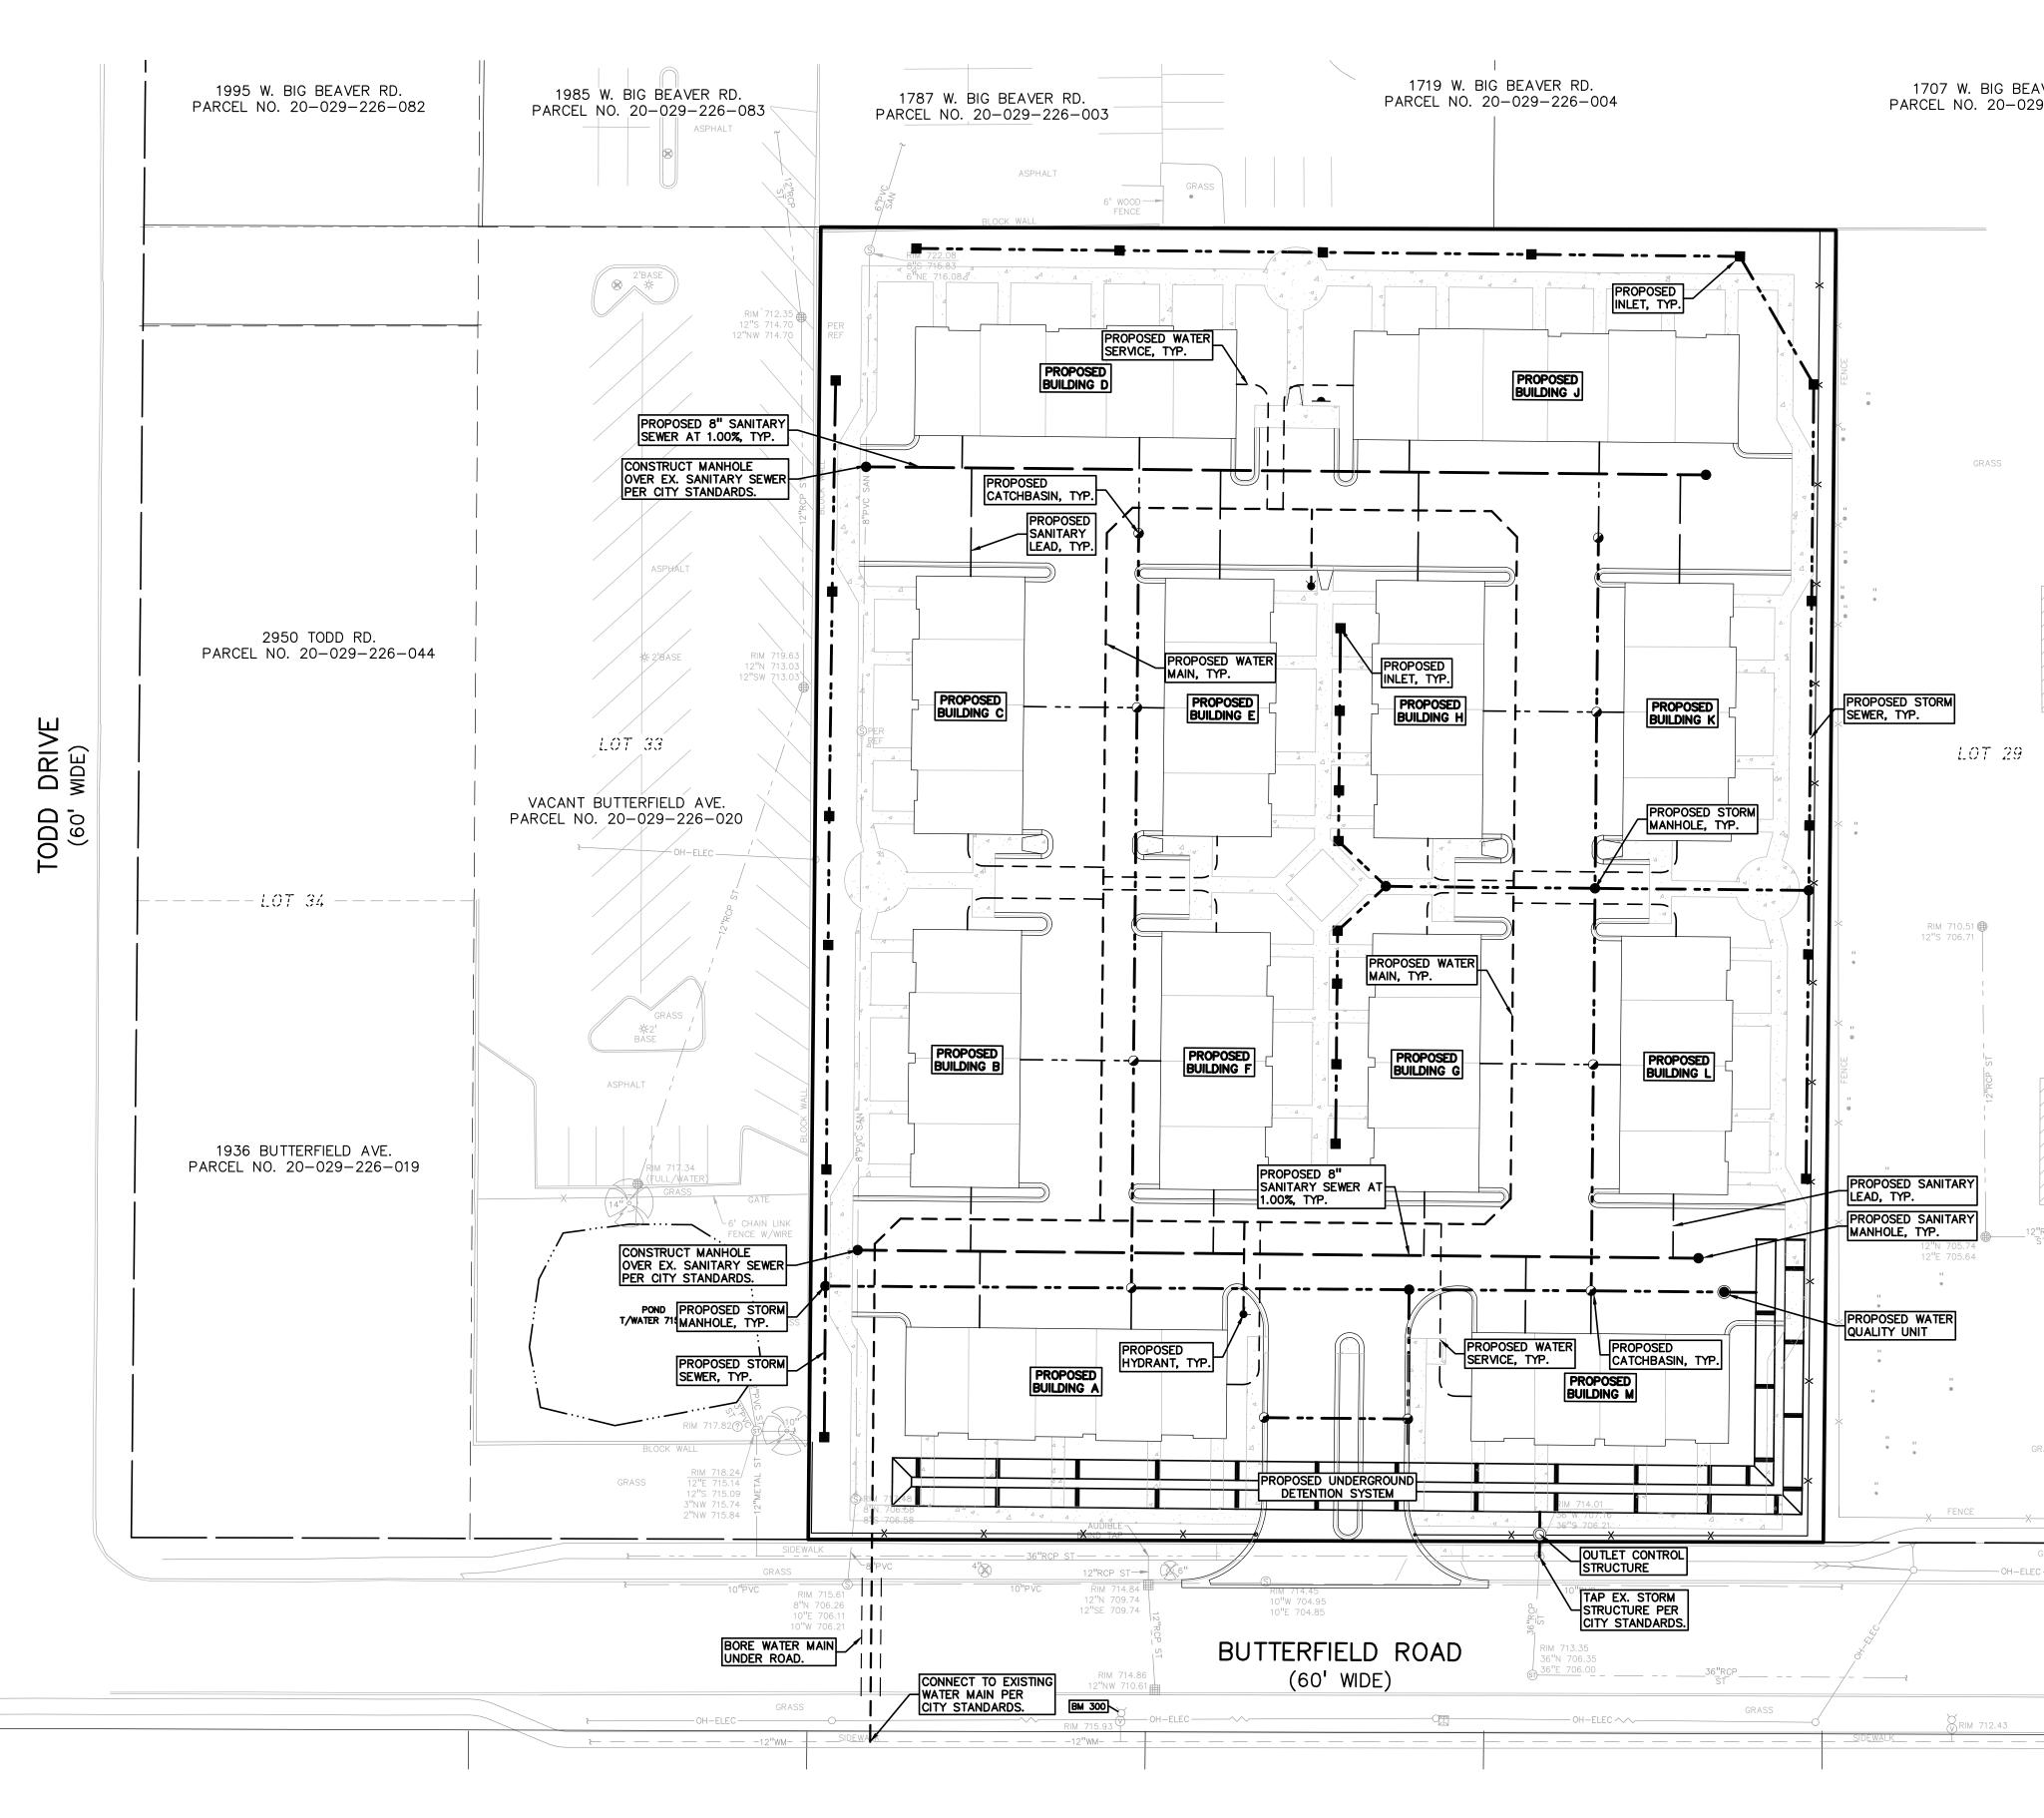
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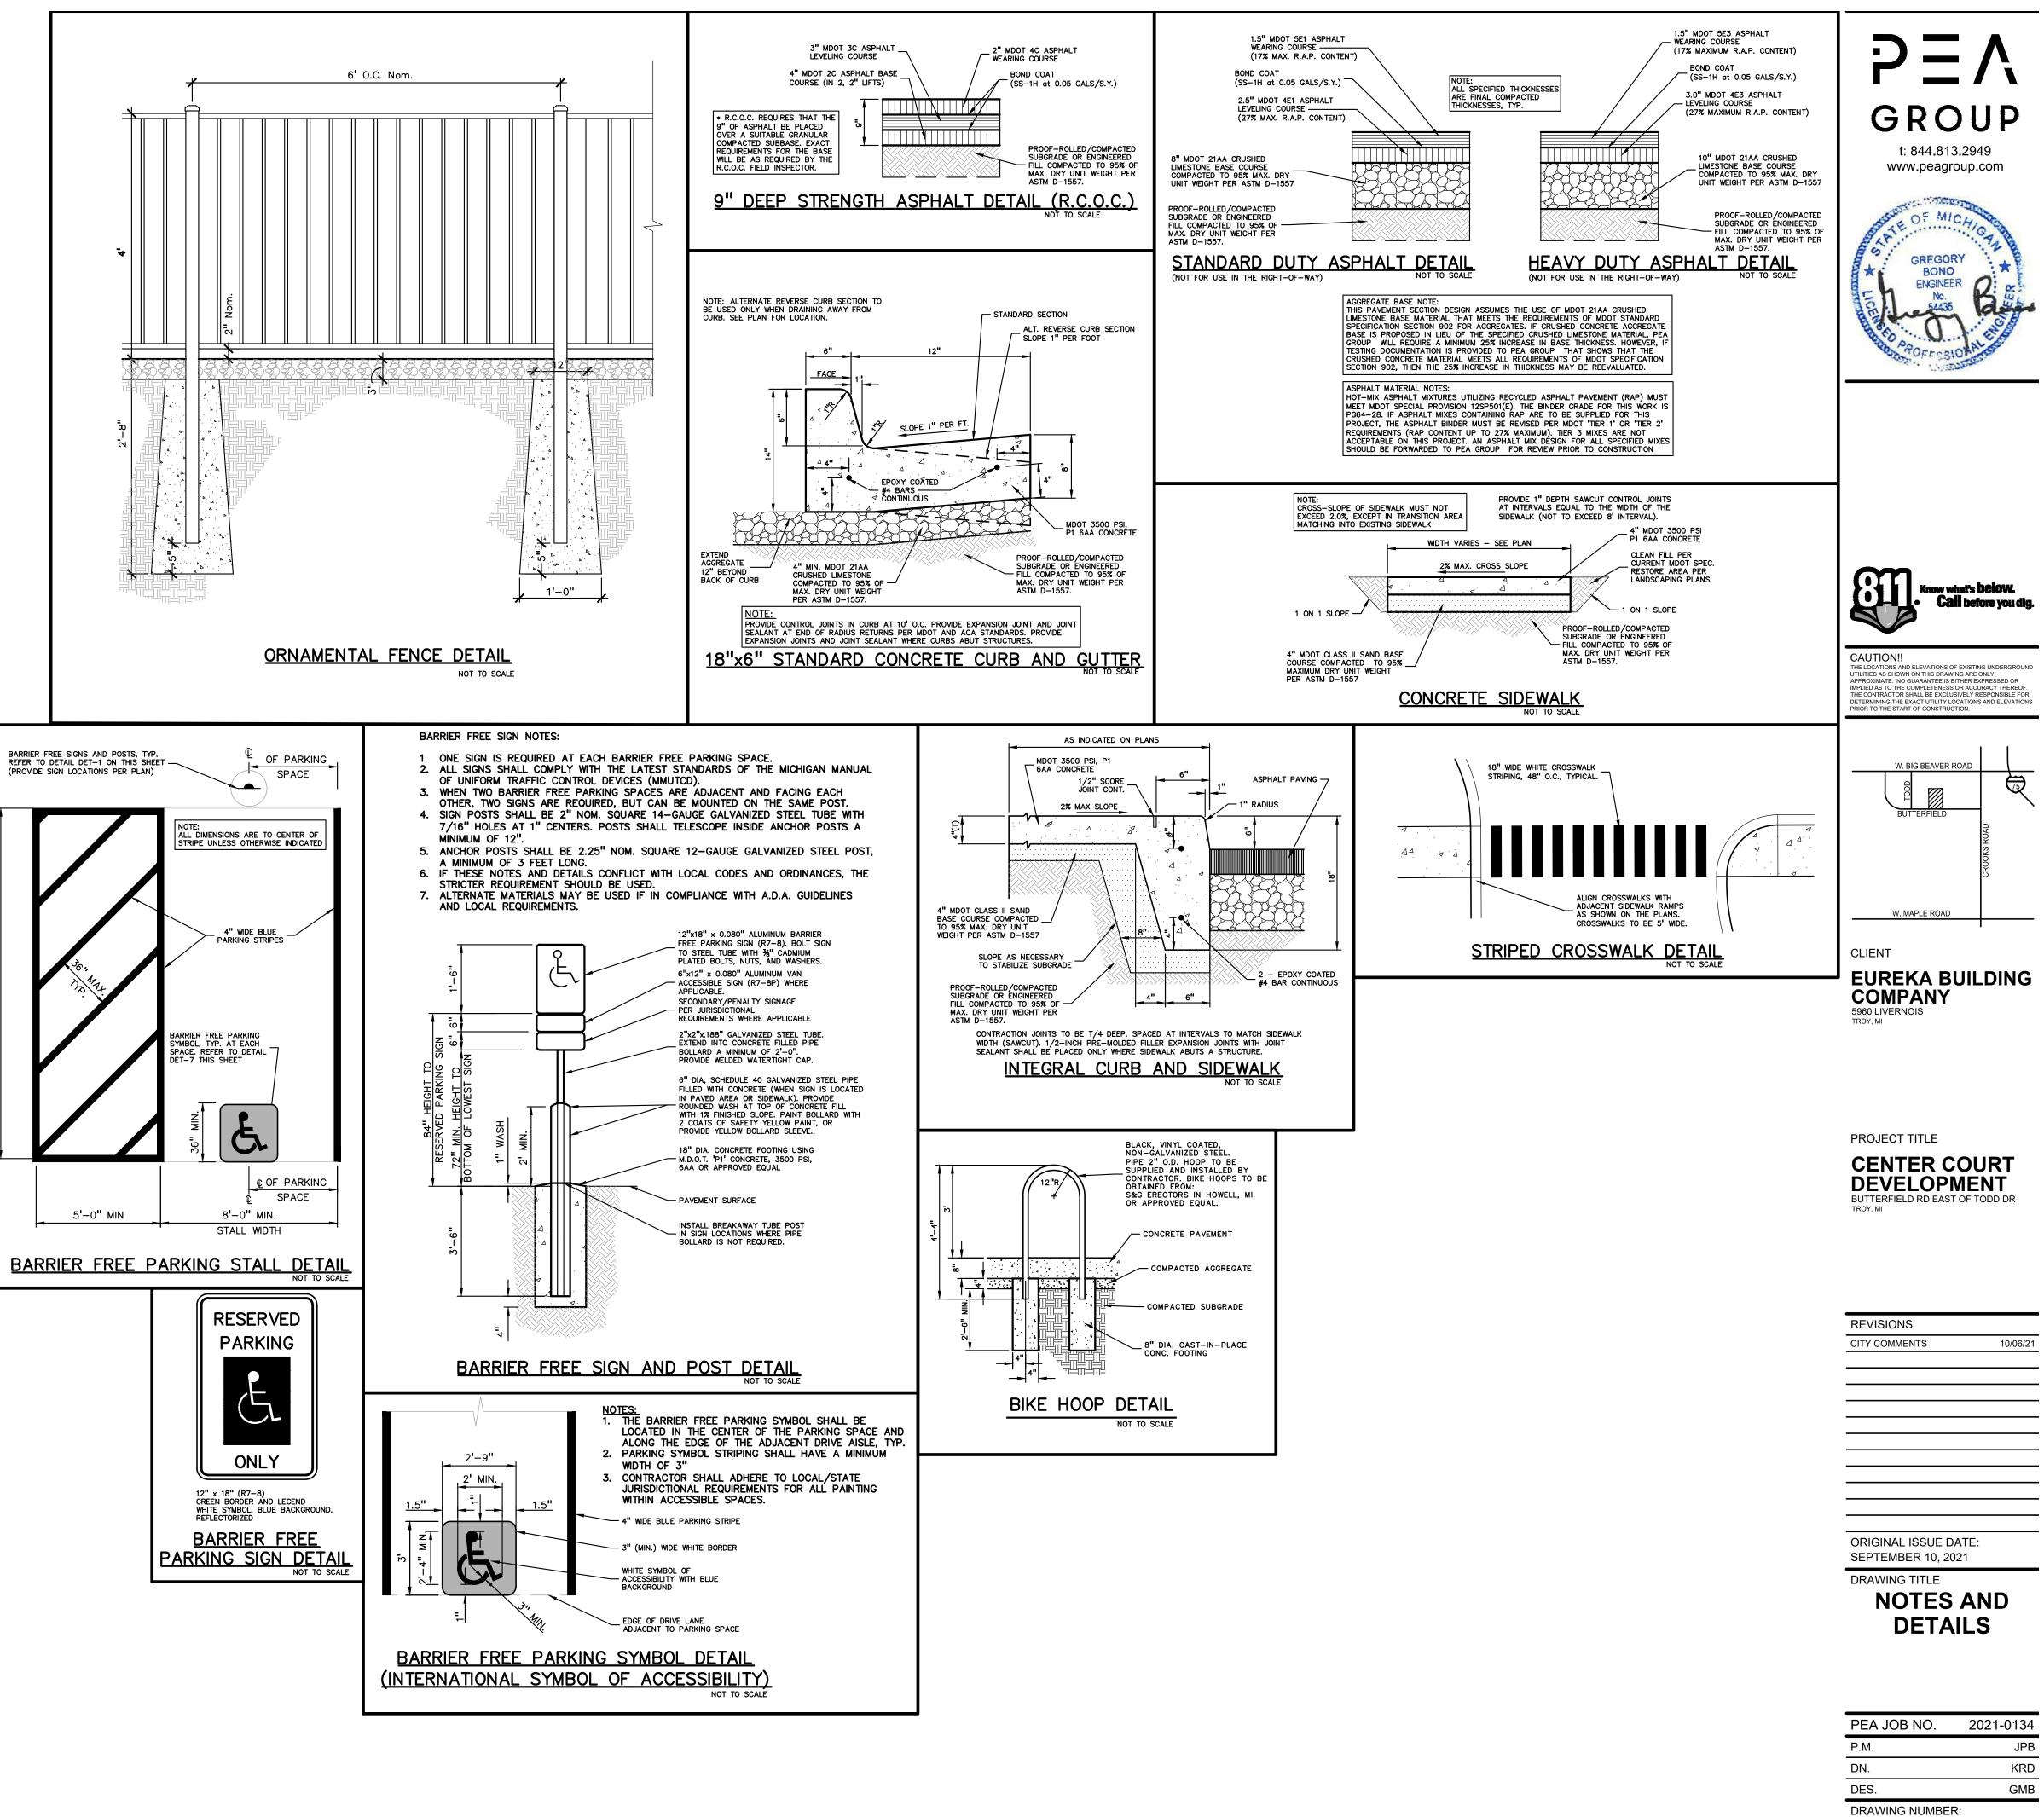
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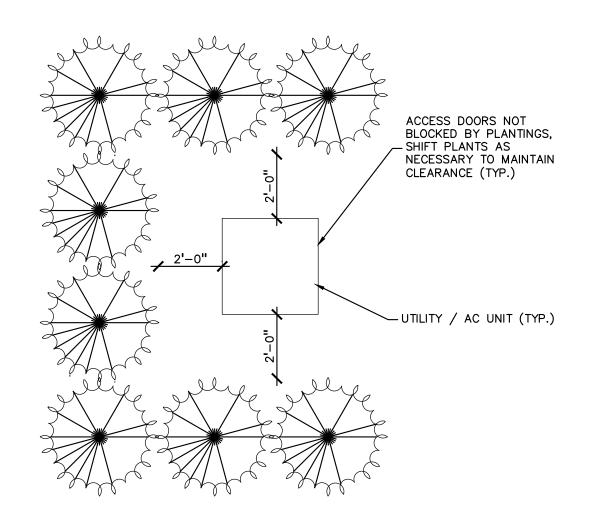



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AVER RD.	-UG-ELEC-©EKE> ELECTRIC U.G. CABLE, MANHOLE, METER & HANDHOLE 	www.peagroup.com
9-226-005	CO SANITARY SEWER, CLEANOUT & MANHOLE	
	COMBINED SEWER, CLEANOUT & MANHOLE	O'LD.
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	M T MAILBOX, TRANSFORMER, IRRIGATION CONTROL VALVE	BONO ENGINEER
	×∞ SPOT ELEVATION	[671.21] No. 54435
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	STD DUTY	HEAVY R.O.W. DUTY ONLY
	ASPHALT STD	
		DUTY STRENGTH NORTH
	WETLAND	0 15 30 60
	100 YEAR STORM DETENTION DESIGN (OAKLAND COUNTY DESIGN METHOD)	SCALE: 1" = 30'
	Site Drainage DataContributing Area (A):3.00 acre	Know what's below. Call before you dig.
	Allowable Discharge (Qa)0.60 cfs (0.2*Coefficient of Runoff (Cr):0.73	area)
	Storage Required (100-yr Storm)	CAUTION!! THE LOCATIONS AND ELEVATIONS OF EXISTING UNDERGROUND
	Qo = ((Qa)/(A)(Cr): 0.27 cfs/acre T = -25 + ((10312.5/Qo))^0.5: 170.43 minutes	IMPERIOUS UTILITIES AS SHOWN ON THIS DRAWING ARE ONLY APPROXIMATE. NO GUARANTEE IS EITHER EXPRESSED OR IMPLIED AS TO THE COMPLETENESS OR ACCURACY THEREOF.
	Vs = (16500(T)/(T+25)) - 40Qo(T): 12,549 cf/acre in Vt = (Vs)(A)(Cr): 27,543 cft	THE CONTRACTOR SHALL BE EXCLUSIVELY RESPONSIBLE FOR DETERMINING THE EXACT UTILITY LOCATIONS AND ELEVATIONS PRIOR TO THE START OF CONSTRUCTION.
	UNDERGROUND DETENTION SYSTEM: • STORAGE VOLUME REQUIRED = 27,543 cf.	W. BIG BEAVER ROAD
2775 A	 PIPE STORAGE VOLUME = 20,216 cf. BACKFILL STORAGE VOLUME = 7,626 cf. 	
PARCEL NO. 2(TOTAL STORAGE PROVIDED = 27,842 cf.	BUTTERFIELD
		CROOKS ROAL
		CK00
		W. MAPLE ROAD
		CLIENT
		EUREKA BUILDING
		COMPANY 5960 LIVERNOIS
		TROY, MI
		PROJECT TITLE
"RCP		CENTER COURT
		DEVELOPMENT BUTTERFIELD RD EAST OF TODD DR
		TROY, MI
		REVISIONS
RASS		CITY COMMENTS 10/06/21
GRASS		
C		
		ORIGINAL ISSUE DATE: SEPTEMBER 10, 2021
		DRAWING TITLE
t		PRELIMINARY
		UTILITY PLAN
		PEA JOB NO. 2021-0134
		P.M. JPB
		DN. KRD
		DES. GMB
		DRAWING NUMBER:

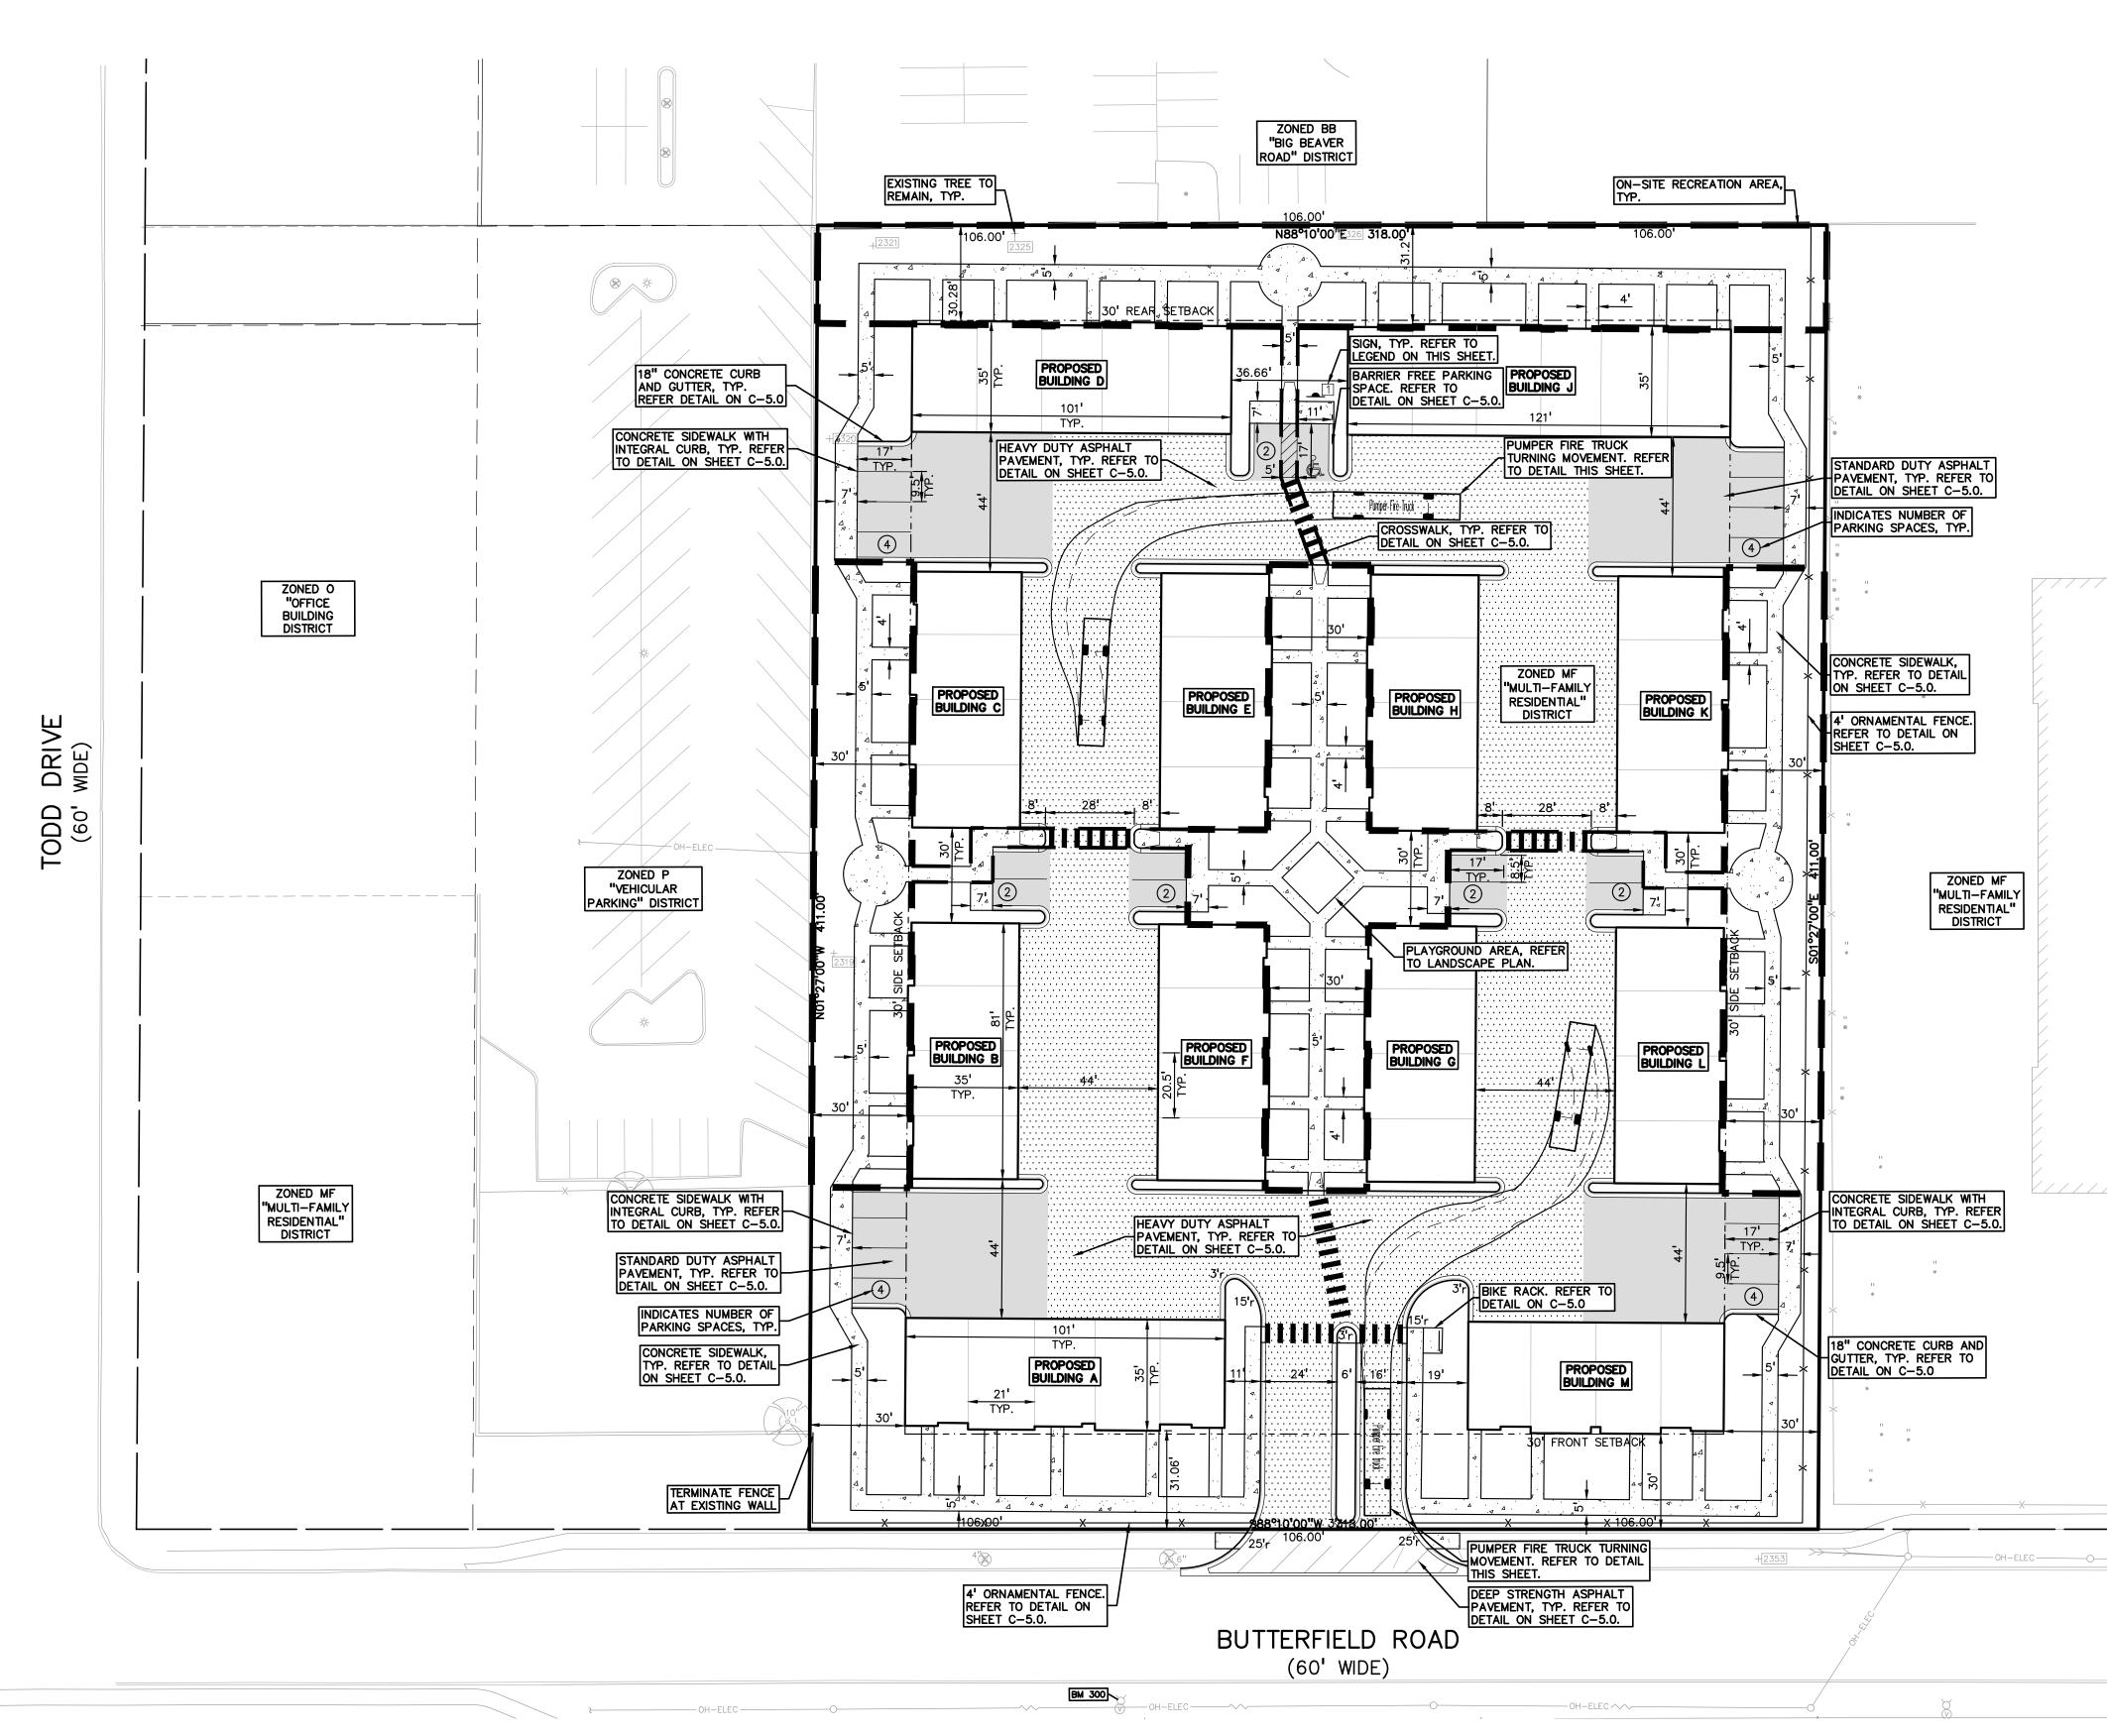
C-4.0



C-5.0

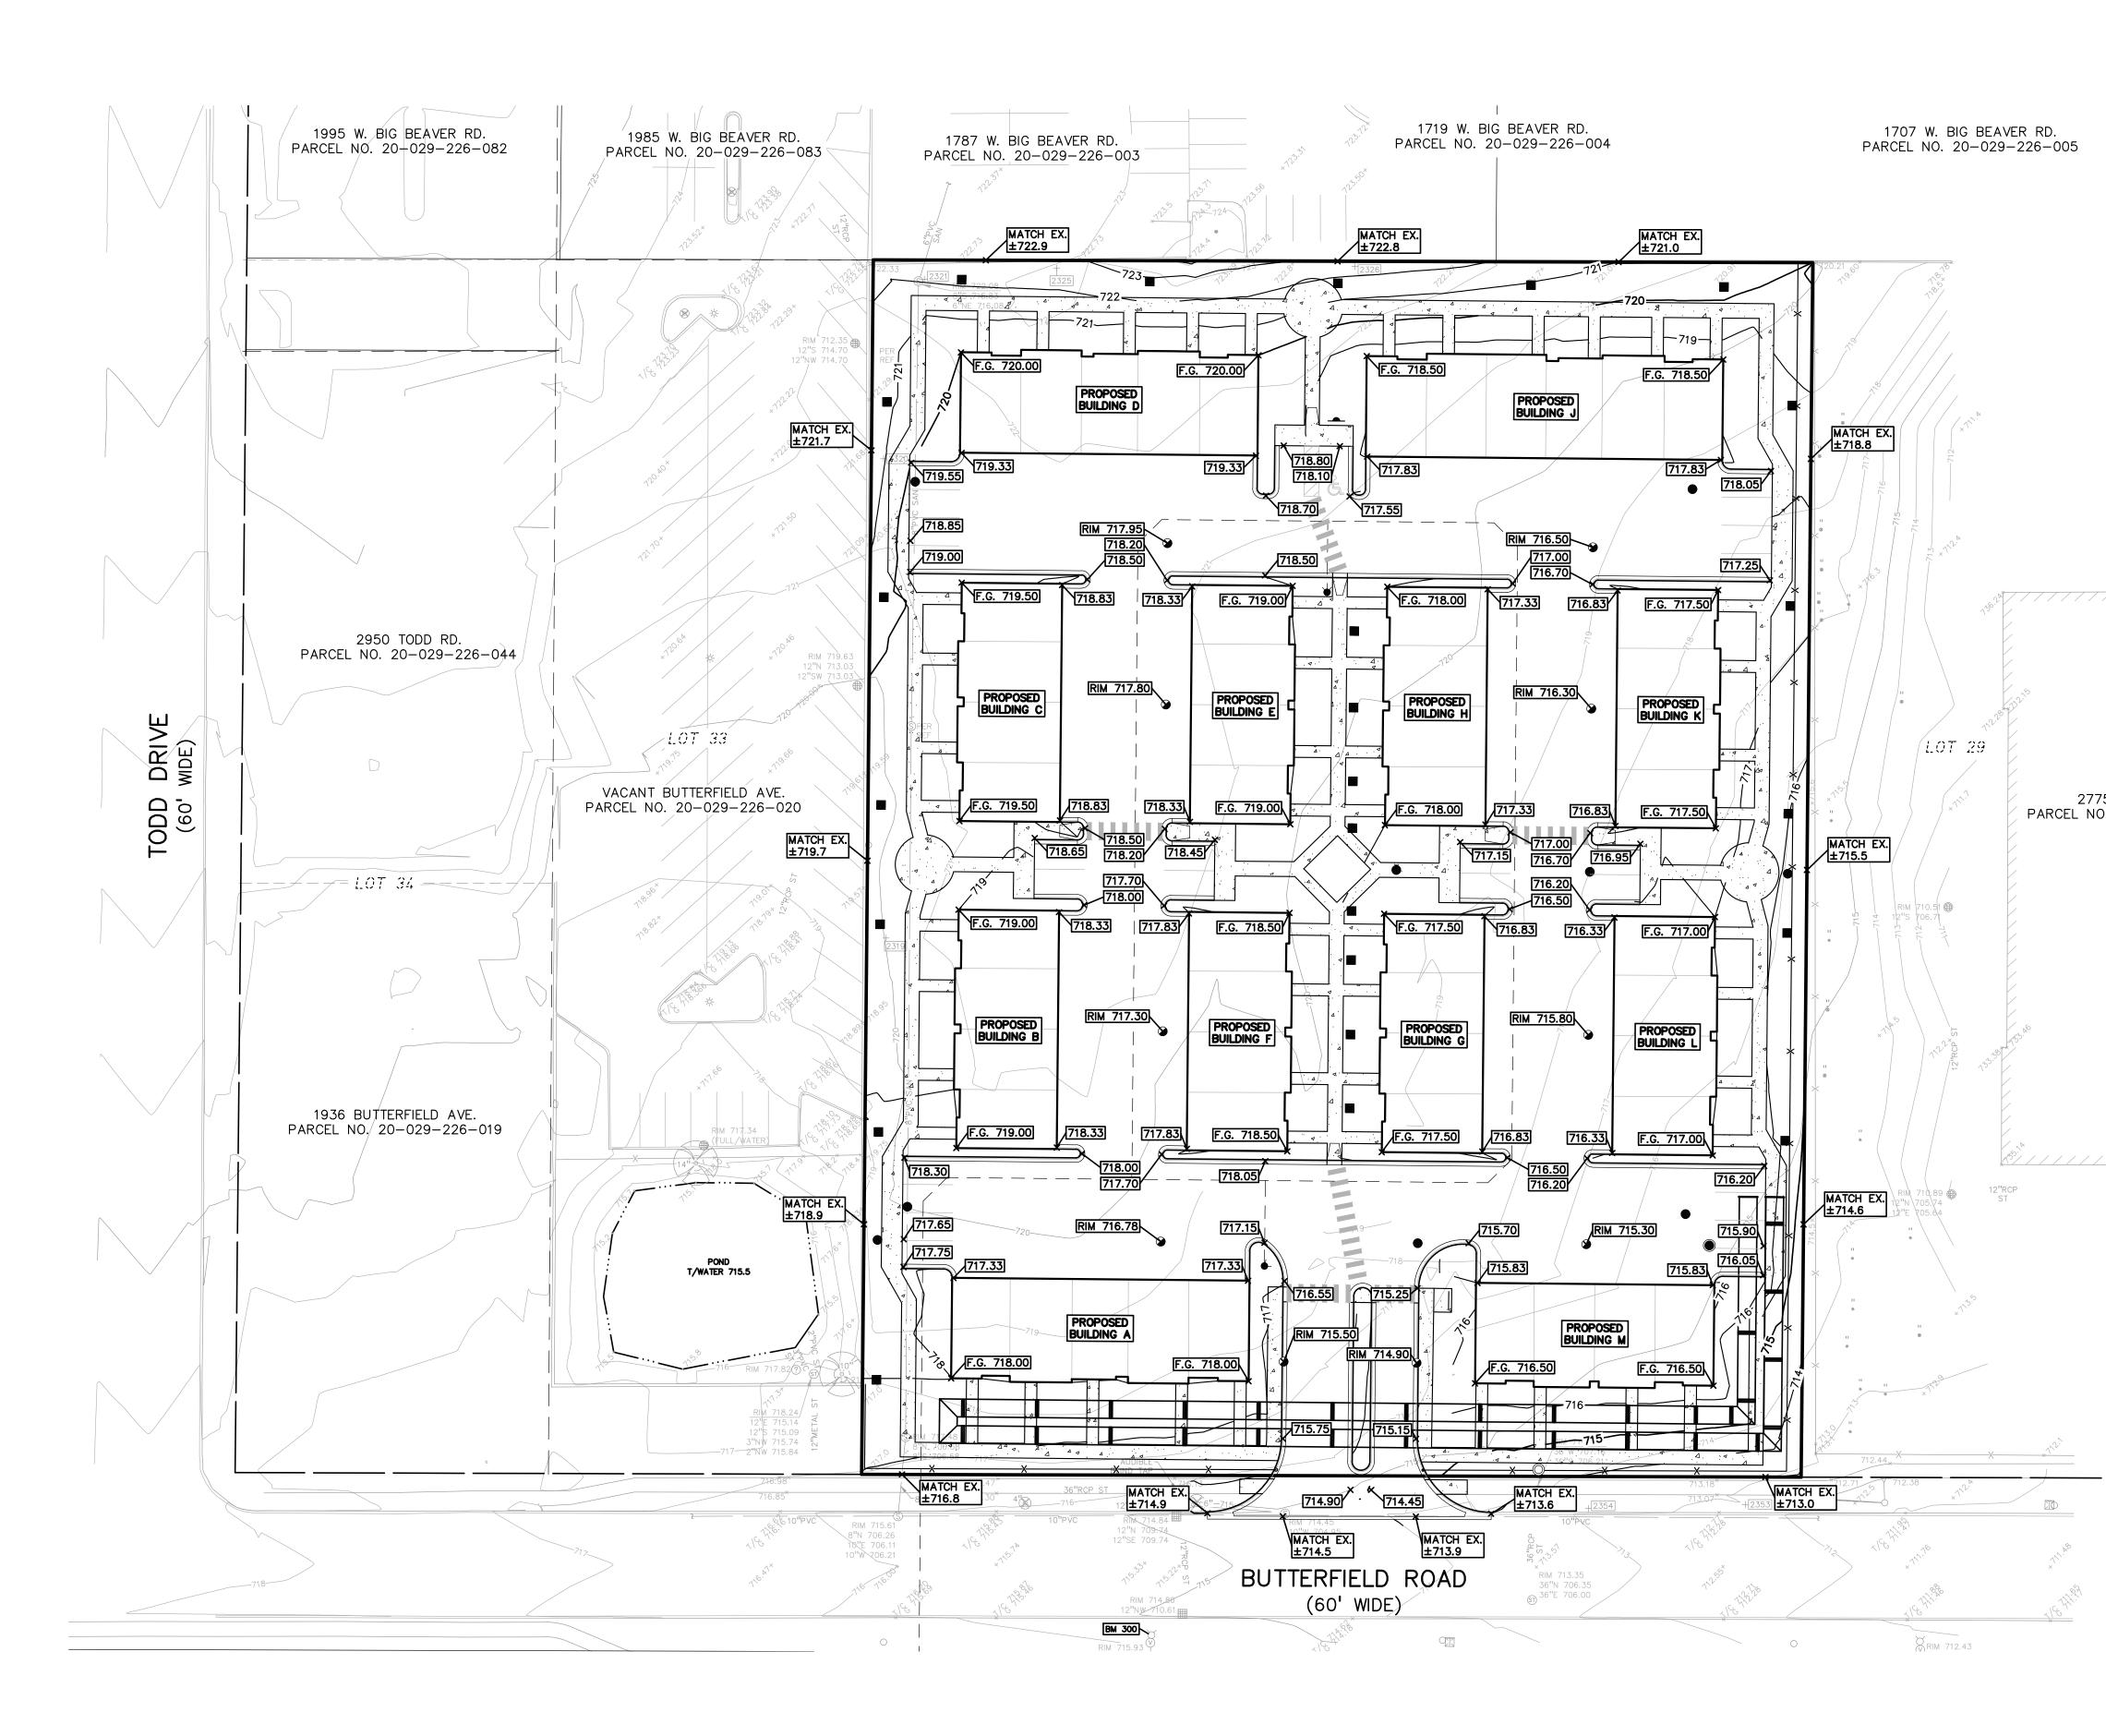


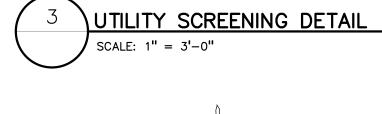

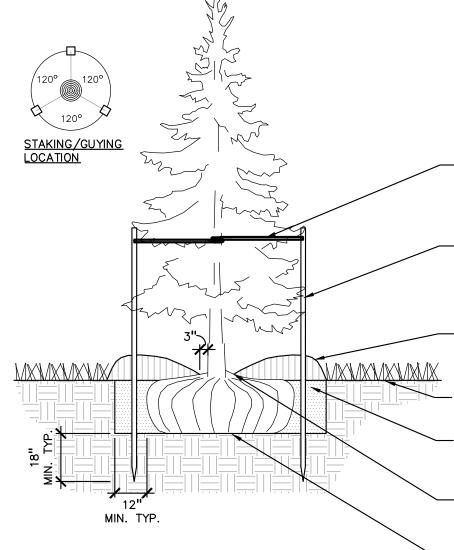

EVERGREEN TREE PLANTING DETAIL

SCALE: 1'' = 3' - 0''

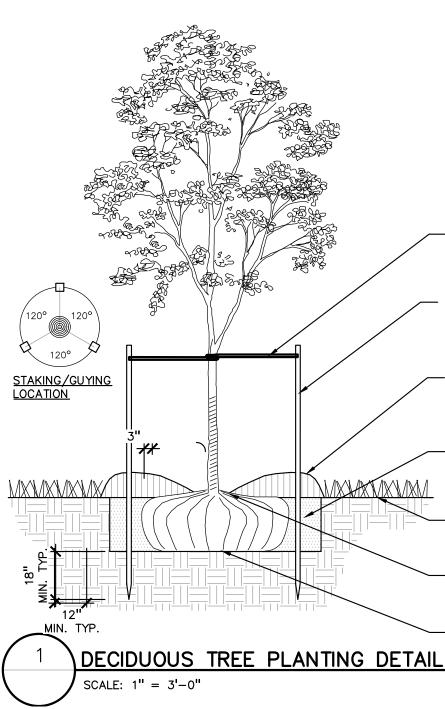

PLANT SO THAT TOP OF ROOT BALL IS FLUSH TO GRADE OR 1-2" HIGHER IF IN POORLY DRAINED SOILS


STAKE JUST BELOW BRANCHES WITH 2"-3" WIDE NYLON OR PLASTIC STRAPS. CONNECT - FROM TREE TO STAKE AND ALLOW FOR FLEXIBILITY. REMOVE AFTER (1) ONE YEAR. (DO NOT USE WIRE & HOSE)

THREE 2"X2" HARDWOOD STAKES OR STEEL T-POSTS DRIVEN A MIN. OF 18" DEEP FIRMLY INTO SUBGRADE PRIOR TO BACKFILLING

SHREDDED HARDWOOD BARK MULCH TO DRIPLINE. 3" DEEP AND LEAVE 3" CIRCLE OF BARE SOIL AROUND TREE TRUNK. DO NOT PLACE MULCH IN CONTACT WITH TREE TRUNK. FORM SAUCER WITH 4" HIGH CONTINUOUS RIM

- FINISH GRADE

SPECIFIED PLANTING MIX, WATER & TAMP TO - REMOVE AIR POCKETS, AMEND SOIL PER SITE CONDITIONS & TREE REQUIREMENTS EXPOSE ROOT FLARE OF TREE. CONTRACTOR MAY HAVE TO REMOVE EXCESS SOIL FROM - TOP OF ROOTBALL. REMOVE ALL BURLAP FROM TOP 1 OF ROOTBALL. DISCARD ALL NON-BIODEGRADABLE MATERIAL OFF SITE PLACE ROOTBALL ON UNEXCAVATED OR TAMPED SOIL

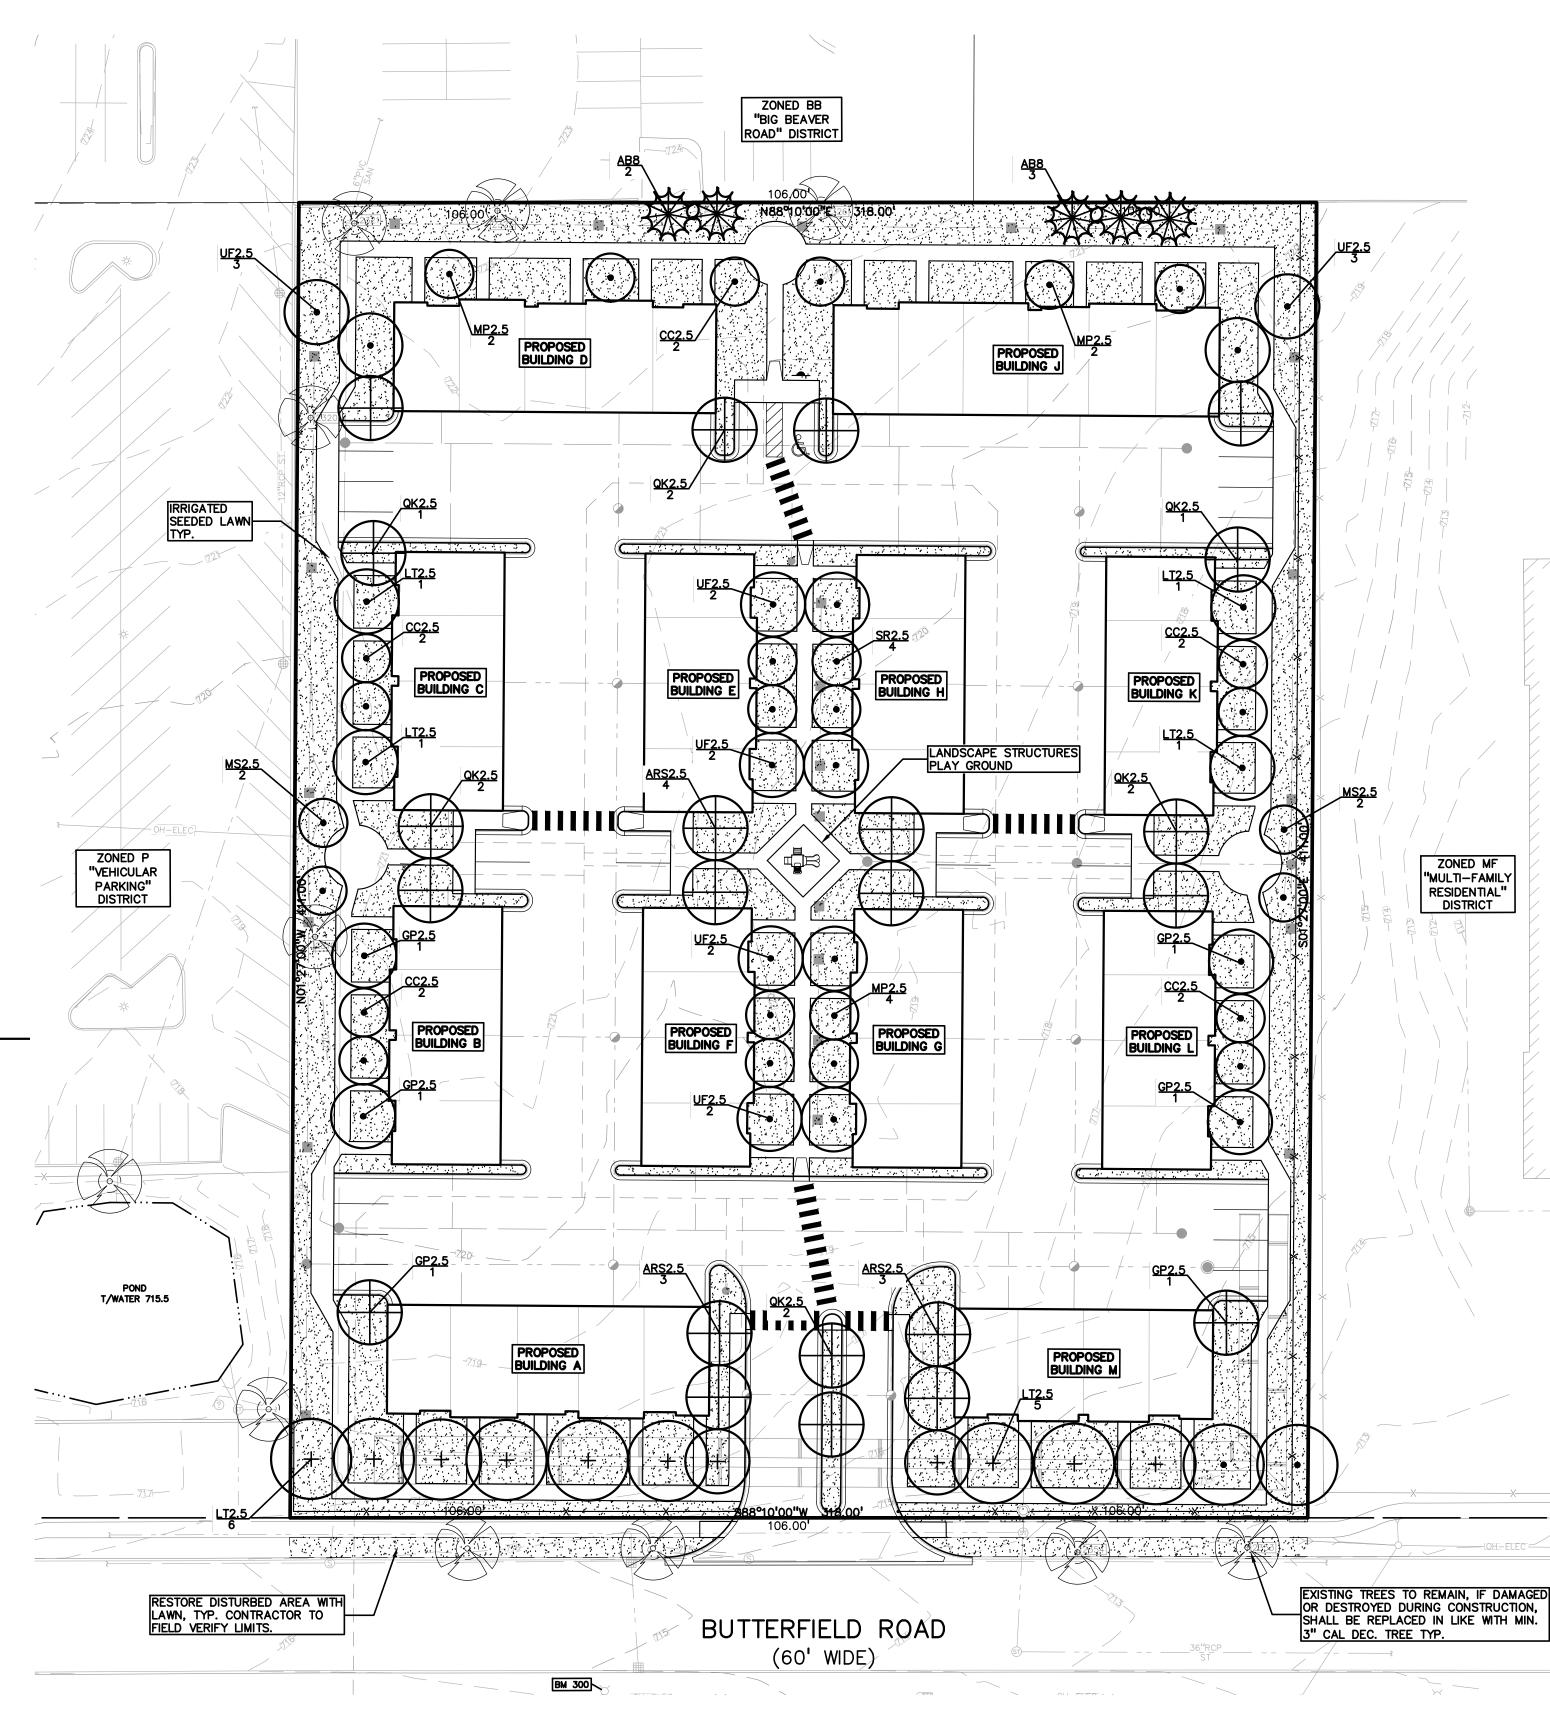

PLANT SO THAT TOP OF ROOT BALL IS FLUSH TO GRADE OR 1-2" HIGHER IF IN POORLY DRAINED SOILS

SECURE TREE WRAP WITH BIODEGRADABLE MATERIAL AT TOP & BOTTOM, REMOVE AFTER FIRST WINTER

DO NOT PRUNE TERMINAL LEADER PRUNE ONLY DEAD, BROKEN BRANCHES AS DIRECTED BY LANDSCAPE ARCHITECT

STAKE JUST BELOW BRANCHES WITH 2"-3" WIDE NYLON OR PLASTIC STRAPS. CONNECT - FROM TREE TO STAKE AND ALLOW FOR FLEXIBILITY. REMOVE AFTER (1) ONE YEAR. (DO NOT USE WIRE & HOSE)

(3) THREE 2"X2" HARDWOOD STAKES DRIVEN A MIN. OF 18" DEEP FIRMLY INTO SUBGRADE PRIOR TO BACKFILLING

SHREDDED HARDWOOD BARK MULCH TO DRIPLINE. 3" DEEP AND LEAVE 3" CIRCLE OF BARE SOIL AROUND TREE TRUNK. DO NOT PLACE MULCH IN CONTACT WITH TREE TRUNK. FORM SAUCER WITH 4" HIGH CONTINUOUS RIM

SPECIFIED PLANTING MIX, WATER & TAMP TO - REMOVE AIR POCKETS, AMEND SOIL PER SITE CONDITIONS & TREE REQUIREMENTS

- FINISH GRADE

EXPOSE ROOT FLARE OF TREE. CONTRACTOR MAY HAVE TO REMOVE EXCESS SOIL FROM - TOP OF ROOTBALL. REMOVE ALL BURLAP FROM TOP $\frac{1}{3}$ OF ROOTBALL. DISCARD ALL NON-BIODEGRADABLE MATERIAL OFF SITE PLACE ROOTBALL ON UNEXCAVATED OR TAMPED SOIL

QUANTITY	KEY SYM BOL	COM M ON NAM E	SCIENTIFIC NAME
10	ARS.5	Scarlet Sentinel Maple	Acer rubrum 'Scarsen' (upright vase shape)
10	CC2.5	Eastern Redbud	Cercis canadensis
8	M P2.5	Prairiefire Crab	Malus 'Prairiefire'
4	M \$2.5	Sugar Tym e Crab	Malus 'Sugar Tyme'
6	GP2.5	Princeton Sentry Ginkgo	Ginkgo biloba 'Princeton Sentry'
10	QK2.5	Kindred Spirit Oak	Quercus robur x bicolor 'Nadler' (columnar)
4	SR2.5	Japanese Tree Lilac	Syringa reticulata 'Ivory Silk'
15	LT2.5	Tulip Tree	Liriodendron tulipifera
14	UF2.5	Frontier 8m	Ulmus 'Frontier'
81	TOTAL DECIDUO	OUS TREES	

EVERGREE	N TREE PLANT	ILIST:		
QUANTITY	KEY SYM BOL	COM M ON NAM E	SCIENTIFIC NAME	
5	AB8 Balsam Fir		Abies balsamea	
5	TOTAL EVERGE	REEN TREES		

SIZE	SPEC
2.5" Cal.	B&B
2.5" Cal.	B&B
2.5" Cal.	B&B
2.5" Cal.	
2.5" Cal.	B&B
SIZE	SPEC
8' Ht.	B&B

///////


LANDSCAPE CALCULATIONS: PER CITY OF TROY ZONING ORDINANCE FORM BASE DISTRICT MF, MULTIFAMILY
5.03 C-1a. = GENERAL SITE LANDSCAPE REQUIRED: 20% OF SITE AREA SHALL BE LANDSCAPE MATERIAL 130,695 SQ.FT. SF * 20 % = 26,139 SF LANDSAPE AREA REQUIRED
PROVIDED: 11,333 SF LANDSCAPED AREA (30%)
13.02 F. SUBDIVISION AND SITE CONDOMINIUM STANDARDS REQUIRED: 13.02 F.= 1 TREE PER 50 LF OF INTERNAL ROADS 1075 LF / 50 = 21.5 = 22 TREES TREES REQUIRED
PROVIDED: 22 PROPOSED TREES
13.02 D2. = GREENBELT REQUIRED: 1 TREE / 30 LF OF FRONTAGE TO PUBLIC RD. E SQUARE LAKE ROAD = 318 LF FRONTAGE / 30 = 10.60 = 11 TREES PROVIDED: 11 PROPOSED TREES
TREE REPLACEMENT:
REQUIRED: WOODLAND: 30 CALIPER INCHES LANDMARK: 102 CALIPER INCHES
TOTAL: 132 CALIPER INCHES OR (53) 2.5" TREES
PROVIDED: 53 TREES


GENERAL PLANTING NOTES:


LANDSCAPE CONTRACTOR SHALL VISIT SITE, INSPECT EXISTING SITE CONDITIONS AND REVIEW PROPOSED PLANTING AND RELATED WORK. IN CASE OF DISCREPANCY BETWEEN PLAN AND PLANT LIST, PLAN SHALL GOVERN QUANTITIES. CONTACT LANDSCAPE ARCHITECT WITH ANY CONCERNS.

SEE TREE PRESERVATION PLAN, T-1.0, FOR TREE REMOVALS AND CALCULATIONS.

- 2. CONTRACTOR SHALL VERIFY LOCATIONS OF ALL ON SITE UTILITIES PRIOR TO BEGINNING CONSTRUCTION ON HIS/HER PHASE OF WORK. ELECTRIC, GAS, TELEPHONE, CABLE TELEVISION MAY BE LOCATED BY CALLING MISS DIG 1-800-482-7171. ANY DAMAGE OR INTERRUPTION OF SERVICES SHALL BE THE RESPONSIBILITY OF CONTRACTOR. CONTRACTOR SHALL COORDINATE ALL RELATED ACTIVITIES WITH OTHER TRADES ON THE JOB AND SHALL REPORT ANY UNACCEPTABLE JOB CONDITIONS TO OWNER'S REPRESENTATIVE PRIOR TO COMMENCING.
- 3. ALL PLANT MATERIAL TO BE PREMIUM GRADE NURSERY STOCK AND SHALL SATISFY AMERICAN ASSOCIATION OF NURSERYMEN STANDARD FOR NURSERY STOCK. ALL LANDSCAPE MATERIAL SHALL BE NORTHERN GROWN, NO. 1. GRADE.
- 4. CONTRACTOR IS RESPONSIBLE FOR VERIFYING ALL QUANTITIES SHOWN ON LANDSCAPE PLAN PRIOR TO PRICING THE WORK.
- 5. THE OWNER'S REPRESENTATIVE RESERVES THE RIGHT TO REJECT ANY PLANT MATERIAL NOT MEETING SPECIFICATIONS.
- 6. ALL SINGLE STEM SHADE TREES TO HAVE STRAIGHT TRUNKS AND SYMMETRICAL CROWNS.
- ALL SINGLE TRUNK SHADE TREES TO HAVE A CENTRAL LEADER; TREES WITH FORKED OR IRREGULAR TRUNKS WILL NOT BE ACCEPTED.
- 8. ALL MULTI STEM TREES SHALL BE HEAVILY BRANCHED AND HAVE SYMMETRICAL CROWNS. ONE SIDED TREES OR THOSE WITH THIN OR OPEN CROWNS SHALL NOT BE ACCEPTED.
- 9. ALL EVERGREEN TREES SHALL BE HEAVILY BRANCHED AND FULL TO THE GROUND, SYMMETRICAL IN SHAPE AND NOT SHEARED FOR THE LAST FIVE GROWING SEASONS.
- 10. ALL TREES TO HAVE CLAY OR CLAY LOAM BALLS, TREES WITH SAND BALLS WILL BE REJECTED.
- 11. NO MACHINERY IS TO BE USED WITHIN THE DRIP LINE OF EXISTING TREES; HAND GRADE ALL LAWN AREAS WITHIN THE DRIP LINE OF EXISTING TREES. 12. ALL TREE LOCATIONS SHALL BE STAKED BY LANDSCAPE CONTRACTOR AND ARE SUBJECT TO THE APPROVAL OF THE LANDSCAPE ARCHITECT PRIOR TO INSTALLATION OF THE PLANT MATERIAL.
- 13. IT IS MANDATORY THAT POSITIVE DRAINAGE IS PROVIDED AWAY FROM ALL BUILDINGS.
- 14. ALL PLANTING BEDS SHALL RECEIVE 3" SHREDDED HARDWOOD BARK MULCH WITH PRE EMERGENT, SEE SPECIFICATIONS. SHREDDED PALETTE AND DYED MULCH WILL NOT BE ACCEPTED.
- 15. ALL LANDSCAPED AREAS SHALL RECEIVE 3" COMPACTED TOPSOIL.
- 16. SEE SPECIFICATIONS FOR ADDITIONAL COMMENTS, REQUIREMENTS, PLANTING PROCEDURES AND WARRANTY STANDARDS. 17. CONTRACTOR SHALL NOT INSTALL PLANTS UNDER BUILDING OVERHANG AND SHALL NOTIFY LANDSCAPE ARCHITECT IF DRAWINGS CONFLICT WITH BUILDING OVERHANGS.

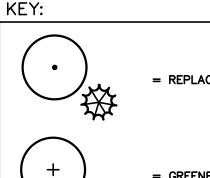

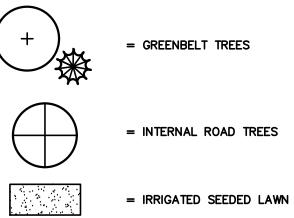

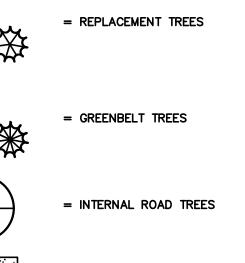



 $P \equiv V$

GROUP

t: 844.813.2949 www.peagroup.com

SCALE: 1" = 30'

THE LOCATIONS AND ELEVATIONS OF EXISTING UNDERGROUND UTILITIES AS SHOWN ON THIS DRAWING ARE ONLY APPROXIMATE. NO GUARANTEE IS EITHER EXPRESSED OR IMPLIED AS TO THE COMPLETENESS OR ACCURACY THEREOF. THE CONTRACTOR SHALL BE EXCLUSIVELY RESPONSIBLE FOR DETERMINING THE EXACT UTILITY LOCATIONS AND ELEVATIONS PRIOR TO THE START OF CONSTRUCTION.

W. BIG BEAVER ROAD

 $\overline{}$

BUTTERFIEL

W. MAPLE ROAD

CAUTION!!

Know what's DelOV

Call before you dig


75

REVISIONS
ORIGINAL ISSUE DATE: SEPTEMBER 10, 2021
DRAWING TITLE
PRELIMINARY
LANDSCAPE
PLAN

PEA JOB NO.	2021-0134
P.M.	JPB
DN.	KRD
DES.	GMB
DRAWING NUMBER	<u>.</u>

L-1.0

NOT FOR CONSTRUCTION

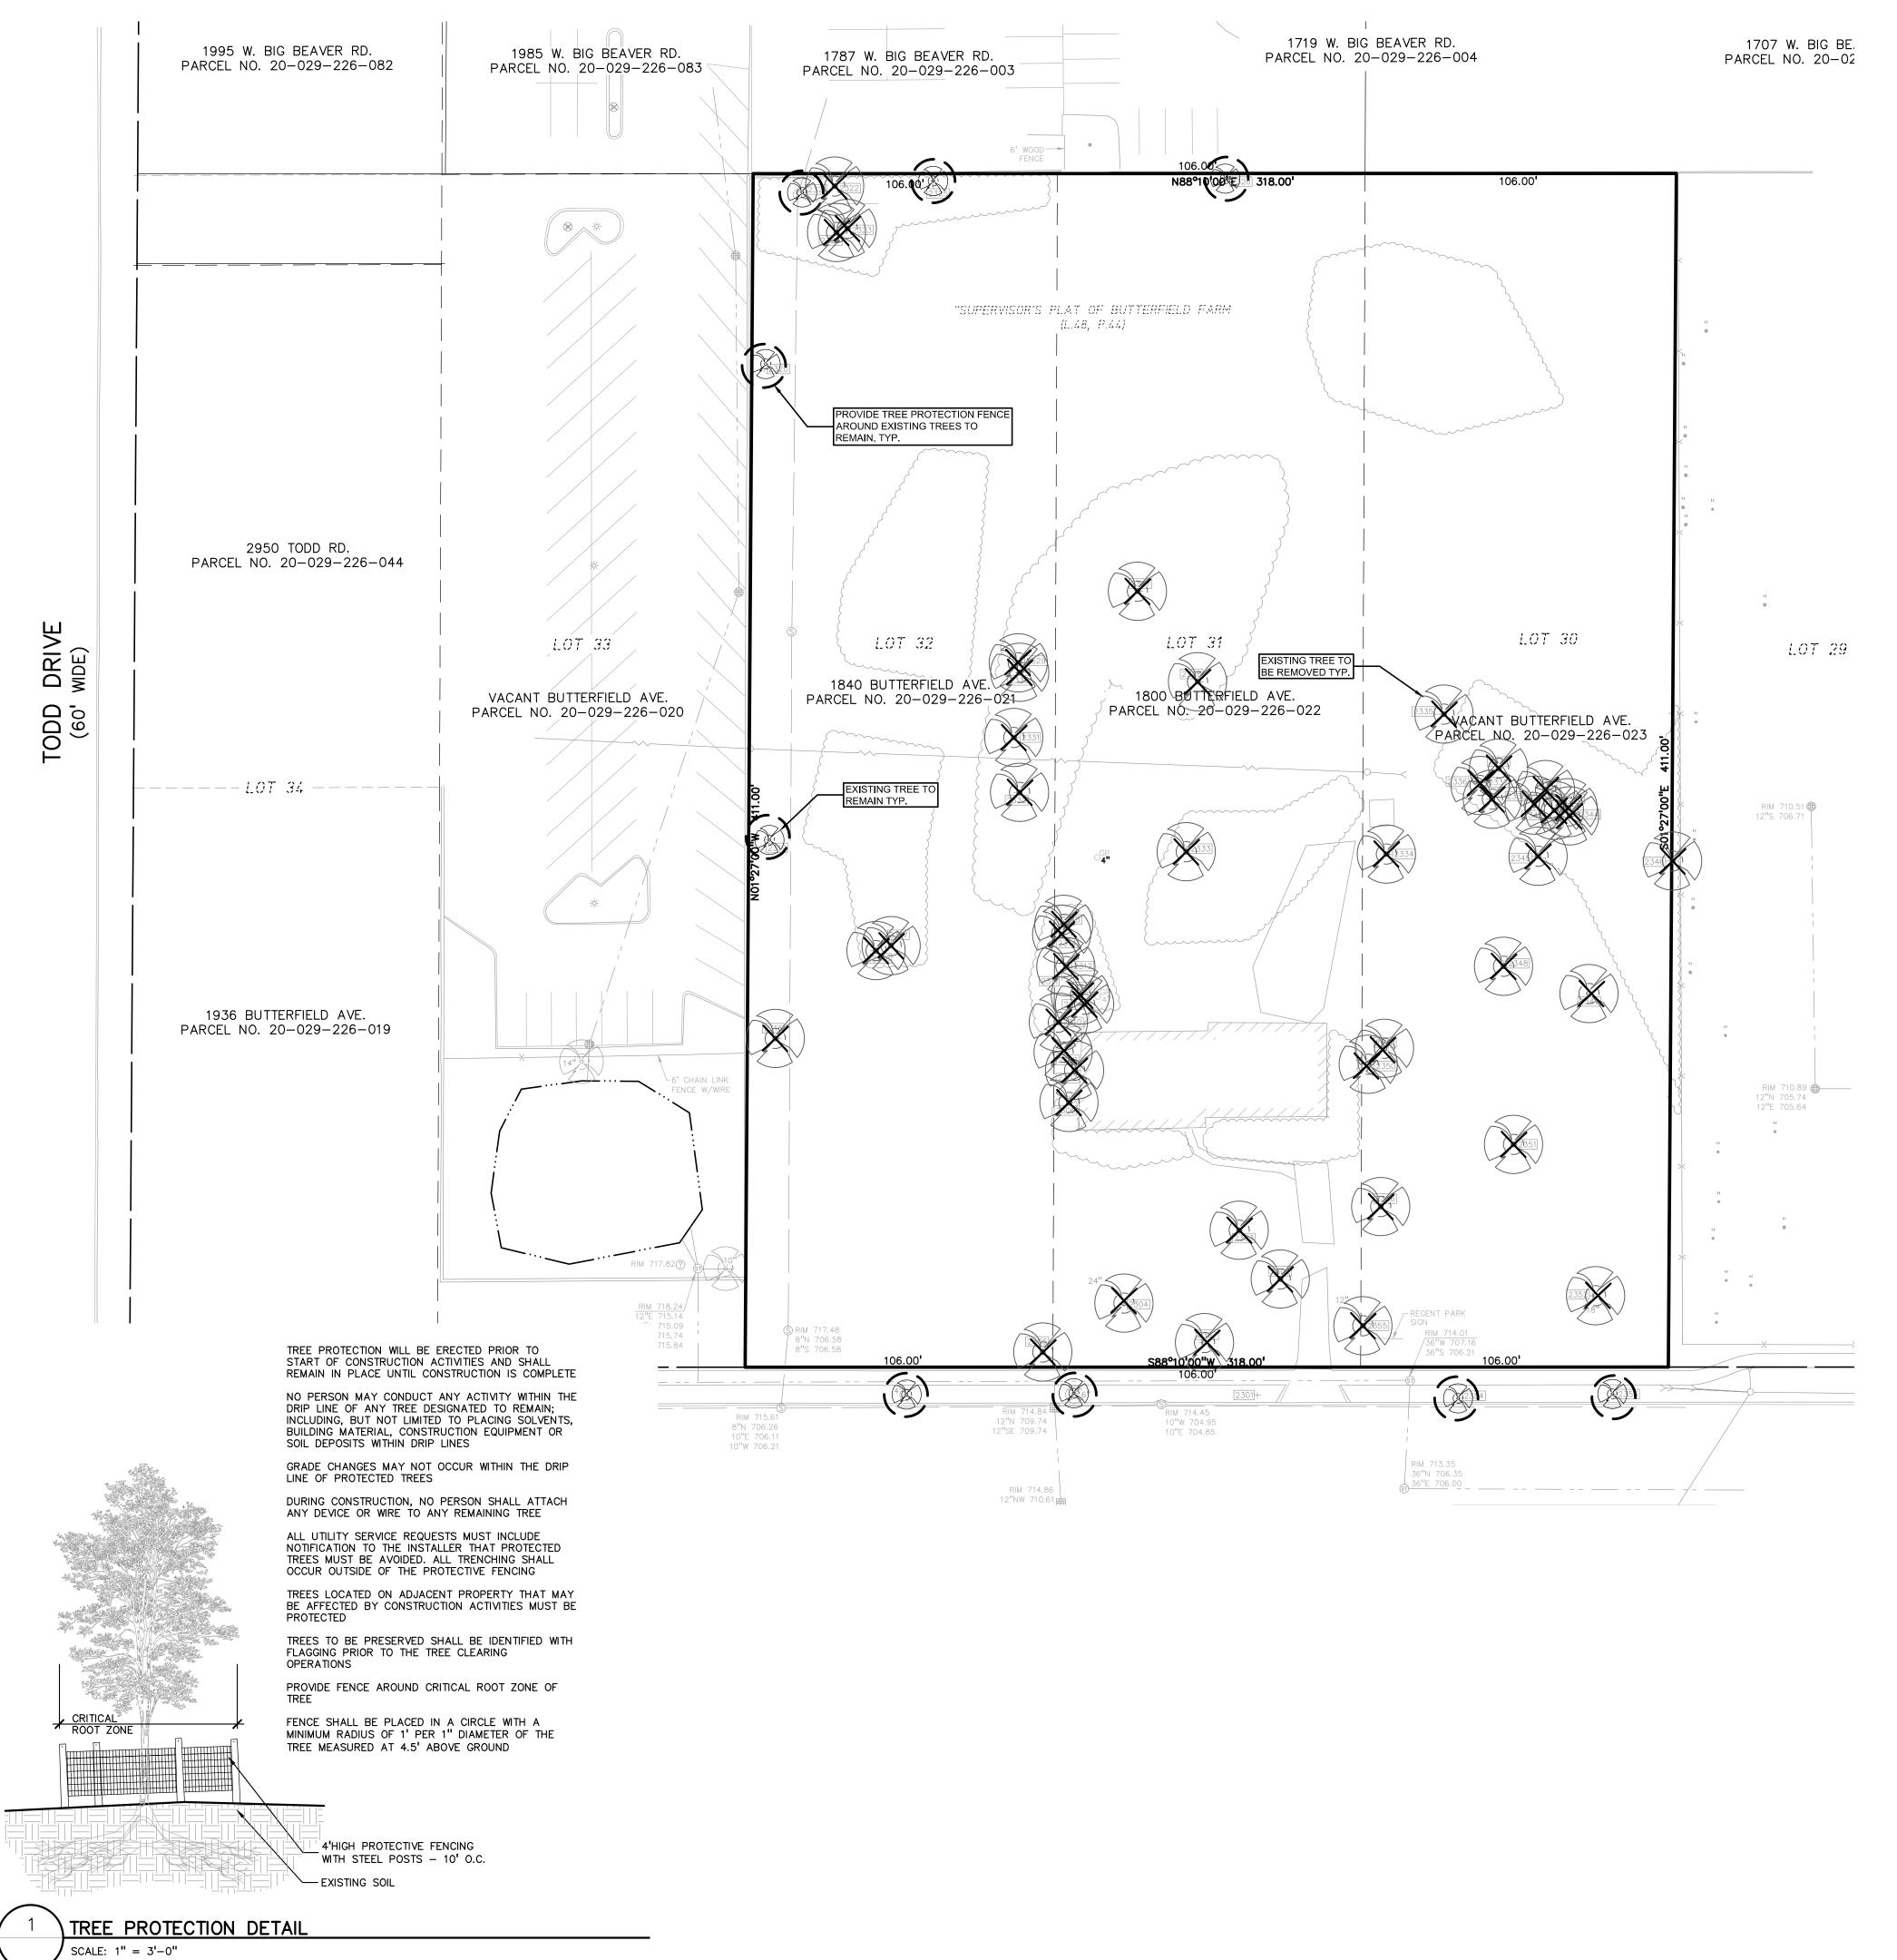

TAG CODE DBI 2301 AM 2302SU2303NM2304VNS2305SM2306GA2307GA2308GA2309VNC2310VNC2311BX2312VNC2313VNC2314SM2315VNC2316SM2317GA2318GA2319BX2320SM2313VAC2314SM2315SM2320SM2321BX2323BX2323BX2324BX2325BX2326EE2327CY2388SM2329CT2330CT2331CT2332GT2333CT2334VNS2335CT2336CT2337CT2338CT2339CT2340CT2341CT2342CT2343CT2344CT2345CT2346MNV2347SM2348RP2349SM2354AU2354AU2354AU2354AU2354AU2354AU2354AU2354AU2354AU 2355 BS 2356 SM 2357 SM

WOODLAN WOODLAN WOODLAN

30'' <u>''</u> ____ LANDMARK LANDMAR


LANDMAR


KEY: \sim = EXISTING TREES TO REMAIN WITH TREE PROTECTION FENCE = EXISTING TREES TO BE REMOVED

REPLACEMENT TREE SUMMARY: NOT INCLUDED FOR REPLACEMENT ARE DEAD, DAMAGED, DISEASED, INVASIVE SPECIES AND OFF SITE TREES. TREE REPLACEMENT: NONE REQUIRED, SINCE THE 21 TREES TO BE REMOVED ARE EXEMPT DUE TO SPECIES.

E	DBH	COMMON NAME	LATIN NAME	COND	COMMENTS	CLASS	SAVE / REMOVE	ON-SITE	REPLACE
	6	Amur Maple	Acer Ginnala	Fair		INVASIVE	R	N	-
	13	Sugar Maple	Acer saccharum	Fair		WOODLAND	R	¥	REPLACE
	21	Norw ay Maple	Acer platanoides	Good		INVASIVE	R	¥	-
	20	White Spruce	Picea glauca	Good		LANDMARK	R	¥	REPLACE
	19	Silver Maple	Acer saccharinum	Fair	x2	INVASIVE	R	¥	-
	7	Green Ash	Fraxinus pennsylvanica	Fair		INVASIVE	R	¥	-
	7	Green Ash	Fraxinus pennsylvanica	Fair		INVASIVE	R	¥	-
	6	Green Ash	Fraxinus pennsylvanica	Fair		INVASIVE	R	¥	_
	7	White Cedar	Thuja occidentalis	Fair		WOODLAND	R	¥	REPLACE
	7	White Cedar	Thuja occidentalis	Good		WOODLAND	R	¥	REPLACE
	6	Box elder	Acer negundo	Fair		INVASIVE	R	¥	-
	6	White Cedar	Thuja occidentalis	Fair		WOODLAND	R	¥	REPLACE
	6	White Cedar	Thuja occidentalis	Poor		WOODLAND	R	¥	-
	6	White Cedar	Thuja occidentalis	Poor		WOODLAND	R	¥	_
	6	White Cedar	Thuja occidentalis	Poor		WOODLAND	R	¥	-
	24	Silver Maple	Acer saccharinum	Good		INVASIVE	R	¥	-
	7	Green Ash	Fraxinus pennsylvanica	Fair	жЗ	INVASIVE	R	¥	-
	6	Green Ash	Fraxinus pennsylvanica	Poor	x2	INVASIVE	R	¥	-
	6	Box elder	Acer negundo	Fair		INVASIVE	S	Y	-
	11	Silver Maple	Acer saccharinum	Good	x5	INVASIVE	S	Y	_
	6	Box elder	Acer negundo	Poor	x1	INVASIVE	S	Y	_
	7	Box elder	Acer negundo	Fair		INVASIVE	R	¥	_
	8	Box elder	Acer negundo	Fair		INVASIVE	R	¥	_
	9	Box elder	Acer negundo	Fair		INVASIVE	R	Ý	_
	7	Box elder	Acer negundo	Fair	x2	INVASIVE	S	Y	_
┥	, 12	Siberian Em	Ulmus pumila	Good		INVASIVE	S	Y	_
	44	Bald Cypress	Taxodium distichum	Fair				¥	REPLACE
	20	Silver Maple	Acer saccharinum	Fair		INVASIVE	R	¥	
	7	Cottonwood	Populus deltoides	Good		INVASIVE	R	¥	_
+	7	Cottonw ood	Populus deltoides	Good		INVASIVE	R	¥	
	, 7	Cottonw ood	Populus deltoides	Fair		INVASIVE	R	Ý Ý	
+	+ 13	Cottonw ood	Populus deltoides	Good		INVASIVE	R	¥	
-	+0 13	Cottonw ood	Populus deltoides	Good	x1	INVASIVE	R	¥	
+	+5 15	White Spruce	Picea glauca	Fair	*1	WOODLAND	R	+ ¥	REPLACE
+	40 10	Cottonw ood	Populus deltoides	Good		INVASIVE	R	÷ ¥	
+	8	Cottonw ood	Populus deltoides	Good		INVASIVE	R	+ ¥	-
-	• 12	Cottonw ood	Populus deltoides	Good		INVASIVE	R	¥	-
+	+ 2 9	Cottonw ood	Populus deltoides	Good		INVASIVE	R	÷ ¥	-
-	9 6	Cottonw ood	Populus deltoides	Fair		INVASIVE	R	÷ ¥	-
-	9 7	Cottonw ood	Populus deltoides	Fair		INVASIVE	R	¥	-
+		-	•						-
+	9 9	Cottonw ood Cottonw ood	Populus deltoides Populus deltoides	Good Good	x2	INVASIVE	R	¥ ¥	-
	8	Cottonw ood	Populus deltoides	Good		INVASIVE INVASIVE	R	¥ ¥	-
-	9 7	Cottonw ood	Populus deltoides	Good		INVASIVE	R	¥	-
+	+ 9	Cottonw ood	Populus deltoides	Fair		INVASIVE	R	÷ ¥	
-	9 6	White Mulberry	Morus alba	Fair			R	¥	-
+	47	Silver Maple	Acer saccharinum	Fair		INVASIVE	R	÷ ¥	-
+	++ -18	Red Pine				LANDMARK	R	¥	- REPLACE
			Pinus resinosa	Fair Fair		INVASIVE	R	¥ ¥	
+	20 6	Silver Maple	Acer saccharinum	Fair Fair					-
+	6		Morus alba	Fair			R	¥	-
-	21 20	Silver Maple	Acer saccharinum	Poor Foir			R	¥	
+	20 6	Austrian Pine	Pinus nigra	Fair Fair			R	¥	REPLACE
	6	Amur Maple	Acer Ginnala	Fair			S	N	-
-	6	Amur Maple	Acer Ginnala	Poor			S	N	
	11	Blue Spruce	Picea pungens	Fair			R	¥	REPLACE
	23	Silver Maple	Acer saccharinum	Fair			R	¥	-
	19	Silver Maple	Acer saccharinum	Poor		INVASIVE	R	¥	-



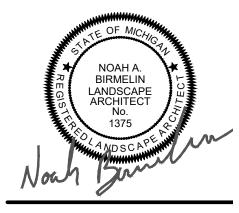


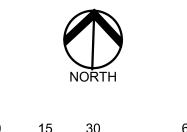







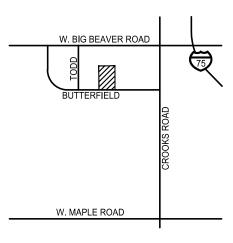

CLIENT **EUREKA BUILDING** COMPANY 5960 LIVERNOIS

TREE INVENTORY/PRESERVATION CALCULATIONS

6	(REPLA	CE AT 50% OF	REMOVED DBH)			
	30''	REPLACEME	NT			
0	(CREDI	T OF 2X DBH)				
		CREDIT				
0	=	29.5				
WOOD	DLAND RE	PLACEMENT				
4	(REPLA	CE AT 100% OF	FREMOVED DBH)			
	102''	REPLACEME	NT			
0	(CREDI	T OF 2X DBH)				
		CREDIT				
0	=	102				
131.5 <u>TOTAL DBH REQUIRED FOR REPLACEMENT</u>						
	0 0 WOOL 4 0 0	30'' 0 (CREDI " 0 = WOODLAND RE 4 (REPLA 102'' 0 (CREDI " 0 =	30" REPLACEMENT 0 (CREDIT OF 2X DBH) "CREDIT CREDIT 0 = 29.5 WOODLAND REPLACEMENT 4 4 (REPLACE AT 100% OF 102" REPLACEMENT 0 (CREDIT OF 2X DBH) "CREDIT 0 102" REPLACEMENT 0 (CREDIT OF 2X DBH) "CREDIT 0 0 = 0 = 102 102			

CENTER COURT

REVISIONS

PROJECT TITLE

TROY, MI

DEVELOPMENT BUTTERFIELD RD EAST OF TODD DR TROY, MI

ORIGINAL ISSUE DATE: SEPTEMBER 10, 2021

TREE

2021-0134

JPB

KRD

GMB

PEA JOB NO.

DRAWING NUMBER:

T-1.0

P.M.

DN.

NOT FOR CONSTRUCTION

DES.









PRESERVATION PLAN






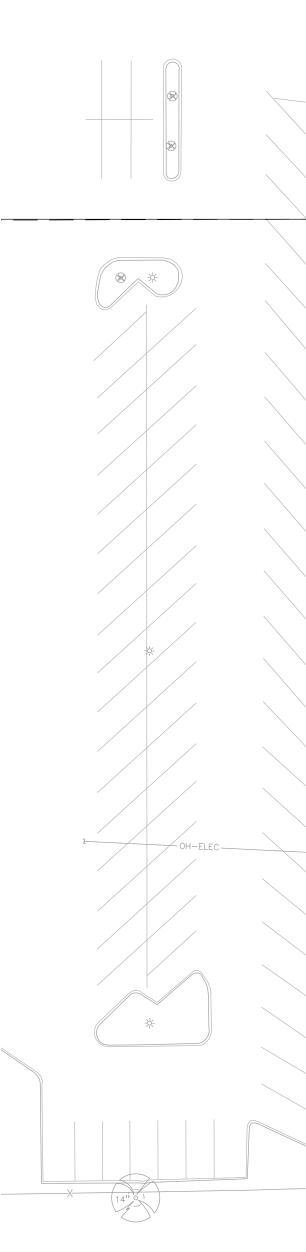

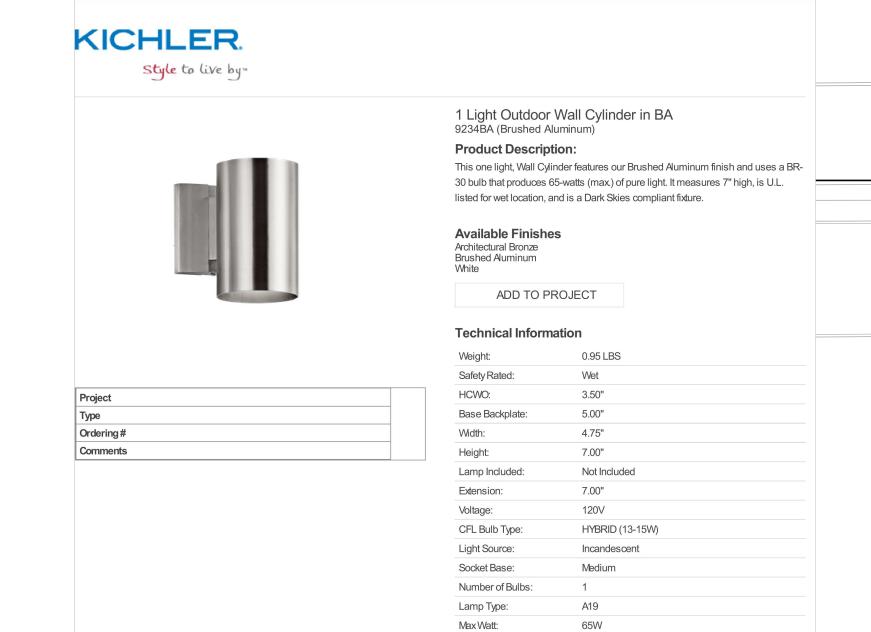

Finish:

Brushed Auminum

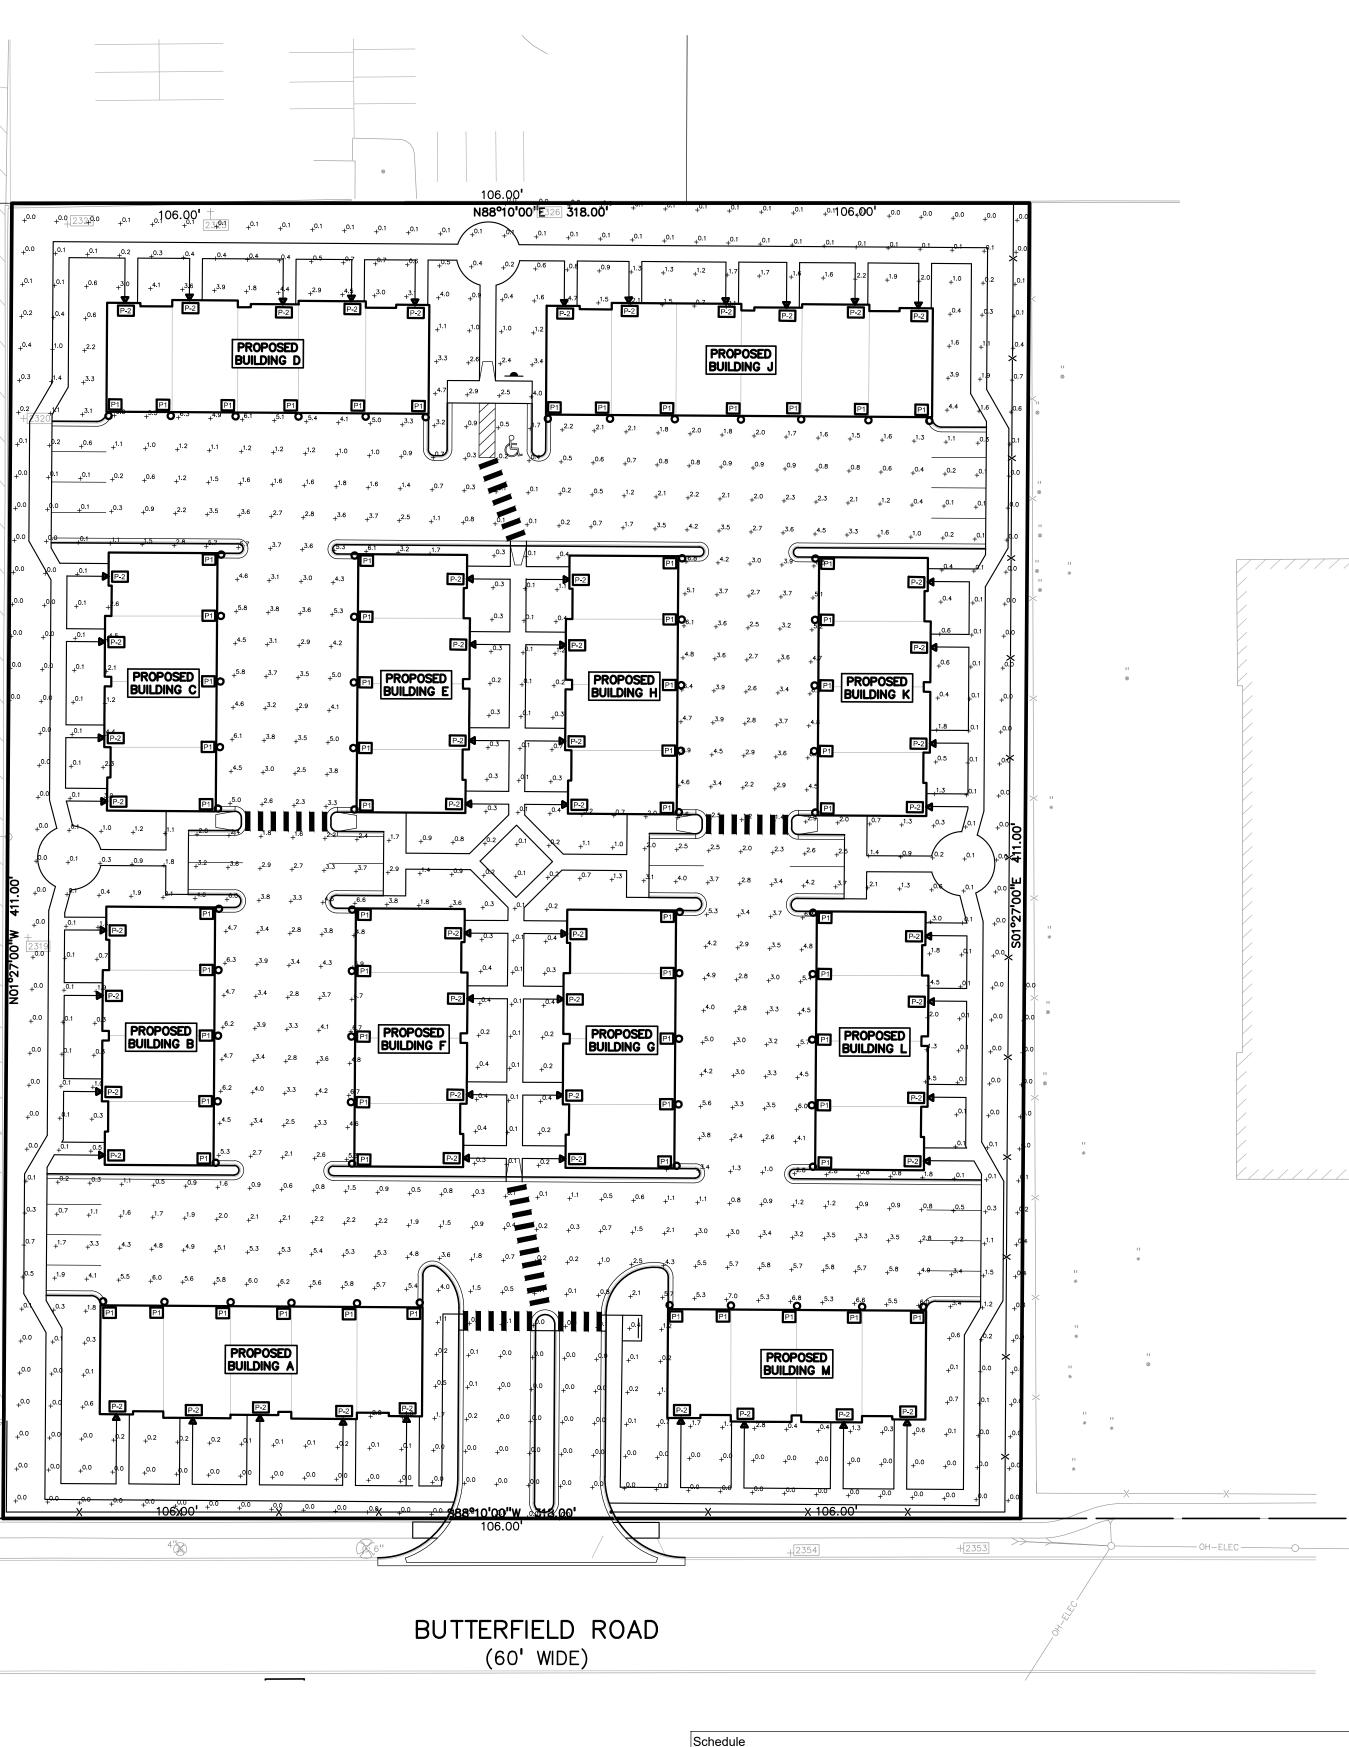

Schedule					
Symbol	Label	Quantity	Manufacturer	Catalog Number	Descriptior
0	P1 * (10' HEIGHT)	64	Lithonia Lighting	DSXW1 LED 20C 1000 AMBPC TFTM MVOLT HS	DSXW1 LE 10 LED LIC ENGINES, OPTIC, AM 1000mA W HOUSE-SI SHIELDS.
\triangle	P2 * (6' HEIGHT)	52	Lithonia Lighting	DSXW1 LED 10C 350 AMBPC T2S MVOLT HS	DSXW1 LE 10 LED LIC ENGINES, OPTIC, AN 700mA WI SIDE SHIE

*BECAUSE AN IES FILE IS NOT AVAILABLE FOR THE FIXTURE TO BE INSTALLED, THE IES FILE FROM A COMPARABLE FIXTURE WAS USED.




- THE LIGHTING PATTERN REPRESENTS ILLUMINATION LEVELS CALCULATED FROM LABORATORY DATA TAKEN UNDER CONTROLLED CONDITIONS IN ACCORDANCE WITH ILLUMINATING ENGINEERING SOCIETY APPROVED METHODS. ACTUAL PERFORMANCE OF ANY MANUFACTURER'S LUMINAIRE MAY VARY DUE TO VARIATION IN ELECTRICAL VOLTAGE, TOLERANCE IN LAMPS, AND OTHER VARIABLE FIELD CONDITIONS.
- 2. ALL POLES ARE TO BE MOUNTED ON CONCRETE PEDESTALS 2 FEET ABOVE GRADE AS SHOWN IN DETAIL.
- 3. ALL POLES LOCATED OUTSIDE OF THE PARKING LOT AREA SHALL BE LOCATED 3 FEET FROM BACK OF CURB OR EDGE OF SIDEWALKS.
- 4. SHOP DRAWINGS FOR THE ELECTRICAL WIRING OF THE FIXTURES NEED TO BE SUPPLIED BY THE CONTRACTOR AND SUBMITTED TO THE ENGINEER FOR COORDINATION OF UNDERGROUND CONDUIT AND APPROVAL OF LAYOUT.
- 5. ALL AREA LIGHT FIXTURES ARE TO BE DOWNWARD DIRECTED.
- 6. CONTRACTOR SHALL FURNISH, INSTALL AND CONNECT ALL MATERIALS AND EQUIPMENT FOR THIS WORK UNLESS OTHERWISE NOTED.
- 7. COORDINATE LIGHT FIXTURE PLACEMENT AND INSTALLATION WITH LANDSCAPE.
- 8. ALL CONDUCTORS SHALL BE IN CONDUIT.

SITE PHOTOMETRIC DATA:

- ALLOWED 1. FIXTURE HEIGHT SITE: 25 FT. (MAX) 2. FOOTCANDLE AT PROP LINE: 1.0 Fc. (MAX)
- 3. FOOTCANDLE AT ROW LINE: 1.0 Fc. (MAX)
- 4. SITE FOOTCANDLE MAX.:

10 FT. (MAX.) 0.4 Fc. (MAX.) 0.4 Fc. (MAX.) 10.0 Fc. (MAX) 7.0 Fc. (MAX.)

PROPOSED

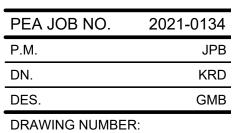

	Lamp	Number Lamps	Filename	Lumens Per Lamp	Light Loss Factor	Wattage
D WITH (1) HT TYPE T4M BER PC, @ ITH DE	LED	1	DSXW1_LED_20C_10 00_AMBPC_TFTM_MVO LT_HS.ies	3558	0.95	73.2
D WITH (1) HT TYPE T4M BPC, @ 'H HOUSE- LDS.	LED	1	DSXW1_LED_10C_35 0_AMBPC_T2S_MVOL T_HS.ies	788	0.95	13.3

311 E	LIG	пі	ING
PEA JOB I	NO.	202	21-013

DRAWING TITLE PRELIMINARY SITE LIGHTING

 $P \equiv V$

GROUP

t: 844.813.2949

www.peagroup.com

OF MIC

GREGORY

BONO ENGINEER

SCALE: 1" = 30'

THE LOCATIONS AND ELEVATIONS OF EXISTING UNDERGROUND UTILITIES AS SHOWN ON THIS DRAWING ARE ONLY APPROXIMATE. NO GUARANTEE IS EITHER EXPRESSED OR IMPLIED AS TO THE COMPLETENESS OR ACCURACY THEREOF. THE CONTRACTOR SHALL BE EXCLUSIVELY RESPONSIBLE FOR DETERMINING THE EXACT UTILITY LOCATIONS AND ELEVATIONS PRIOR TO THE START OF CONSTRUCTION.

W. BIG BEAVER ROAD

EUREKA BUILDING COMPANY 5960 LIVERNOIS

BUTTERFIELD

W. MAPLE ROAD

CLIENT

TROY, MI

PROJECT TITLE

TROY, MI

REVISIONS CITY COMMENTS

CENTER COURT DEVELOPMENT BUTTERFIELD RD EAST OF TODD DR

Call before you d

T

10/06/21

CAUTION!!

SEPTEMBER 10, 2021

ORIGINAL ISSUE DATE:

NOT FOR CONSTRUCTION SL-1.0

CENTER COURT DEVELOPMENT TROY, MICHIGAN

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T-1 A0.1 A1.0 A1.1 A1.2 A1.3	INDEX OF TITLE SHEET 4-UNIT BUILDING FOUNDATION PLAN LOWER LEVEL FLOOR PLAN MAIN LEVEL FLOOR PLAN UPPER LEVEL FLOOR PLAN FRONT ELEVATION		PROJECT CENTER COURT DEVELOPMENT - TROY, MI
A14 A14 A0.2 A2.0 A2.1 A2.2 A2.3 A2.4	SIDE ELEVATION SIDE ELEVATION 5-UNIT BUILDING FOUNDATION PLAN LOWER LEVEL FLOOR PLAN MAIN LEVEL FLOOR PLAN UPPER LEVEL FLOOR PLAN FRONT ELEVATION SIDE ELEVATION SIDE ELEVATION		SUBJECT TITLE SHEET
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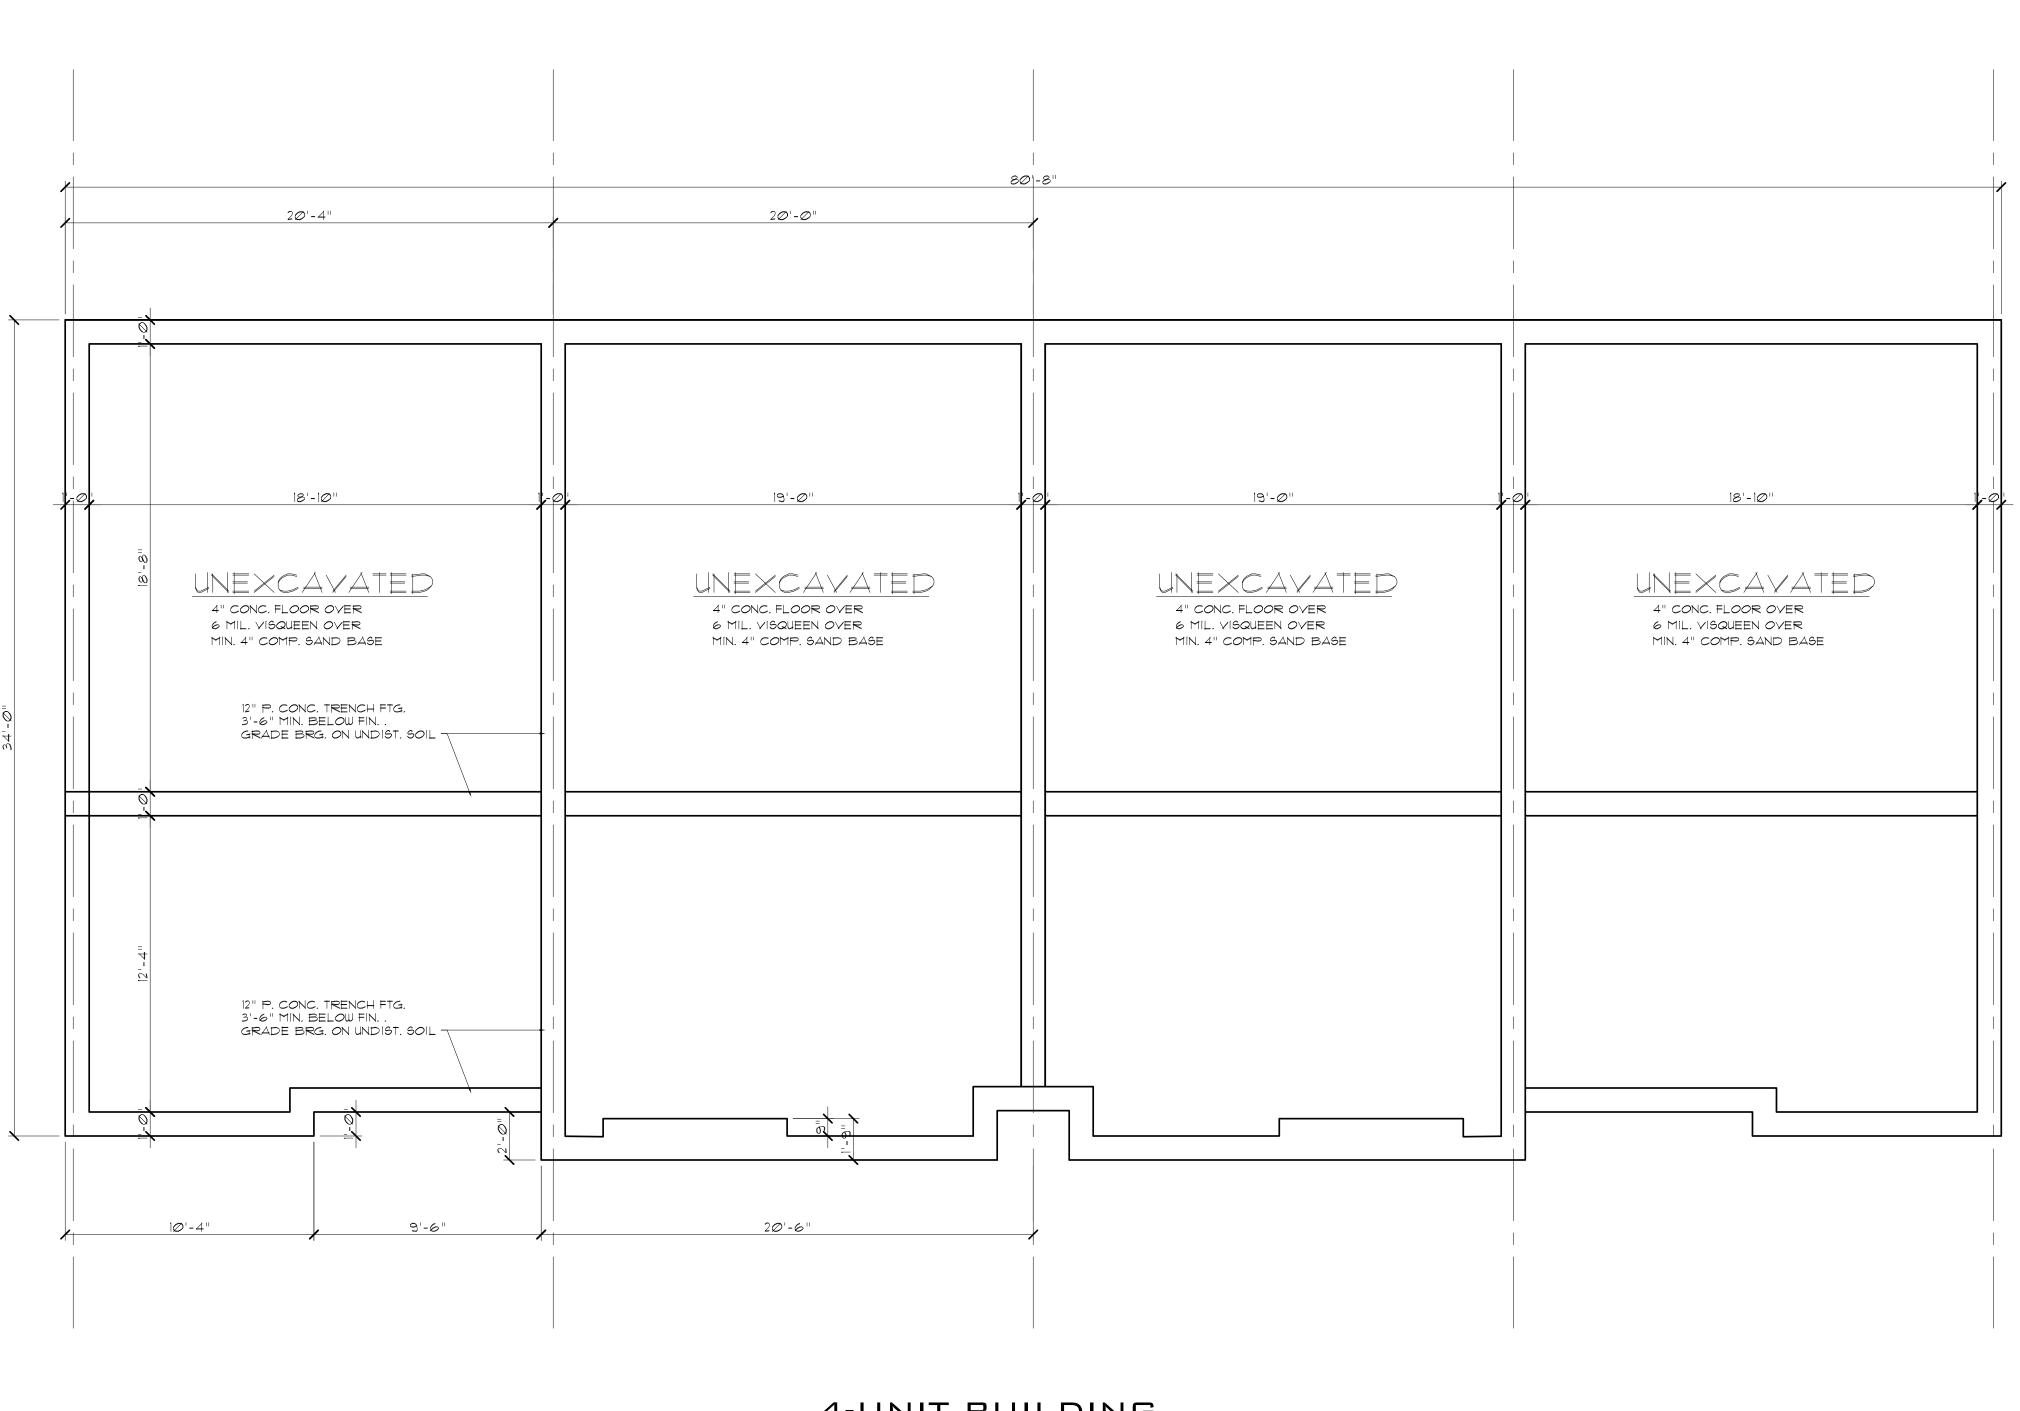
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CONDO DEVELOP.





4-UNIT BUILDING FOUNDATION PLAN

SCALE: 1/4'' = 1'-0''

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4-UNIT BUILDING Lower level plan



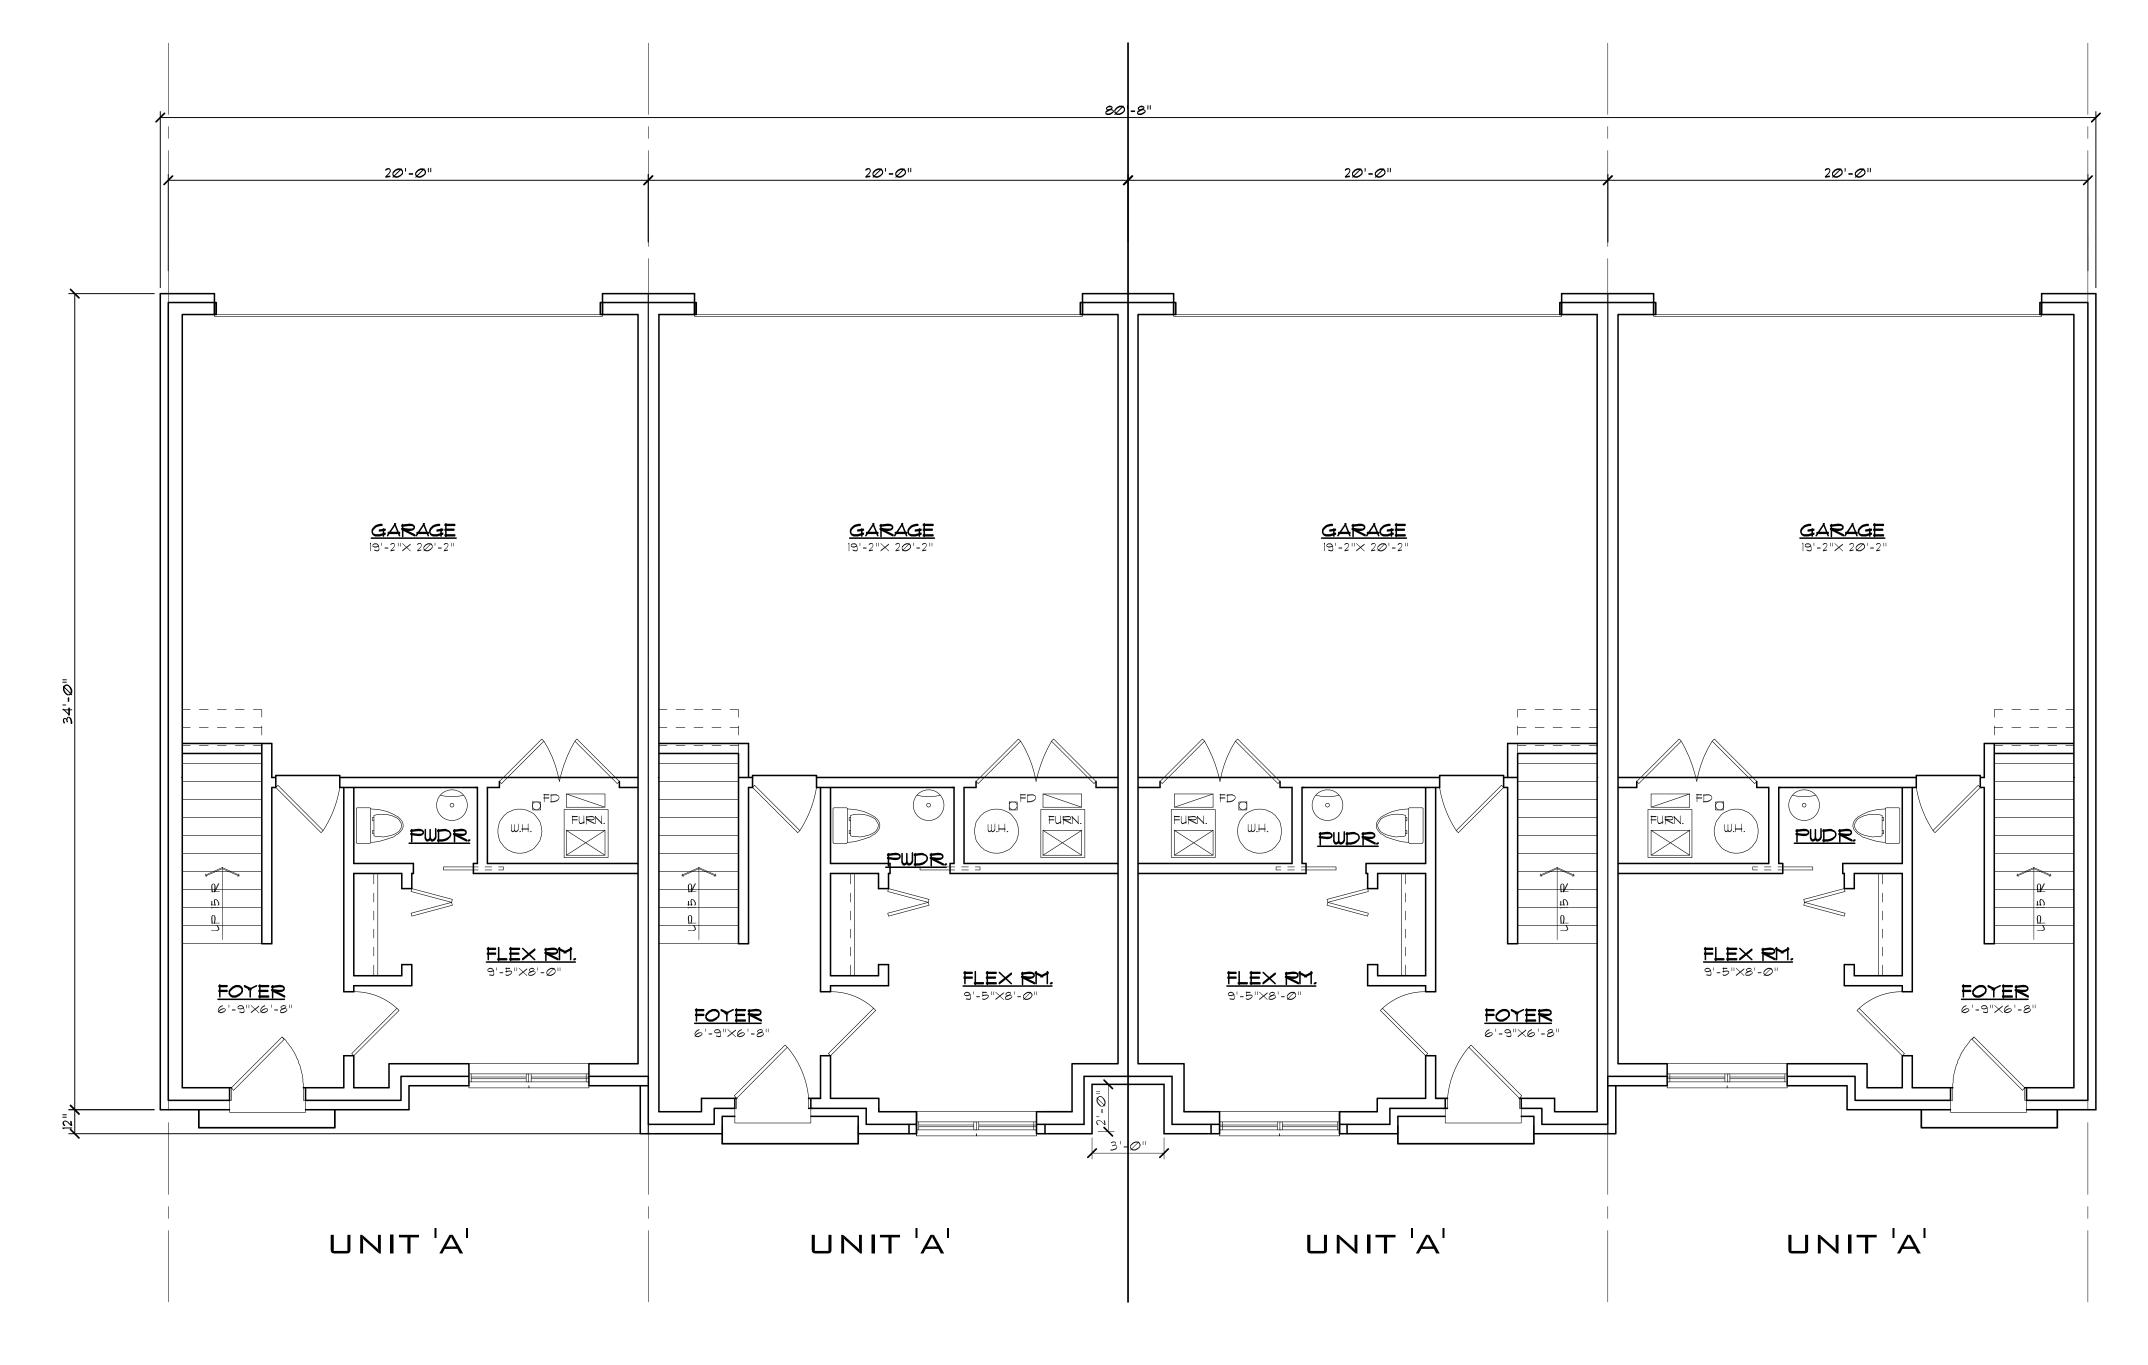

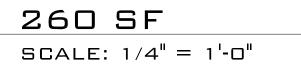
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PROJECT	CENTER COURT DEVELOPMENT - TROY, M	
SUBJECT	LOWER LEVEL PLAN	
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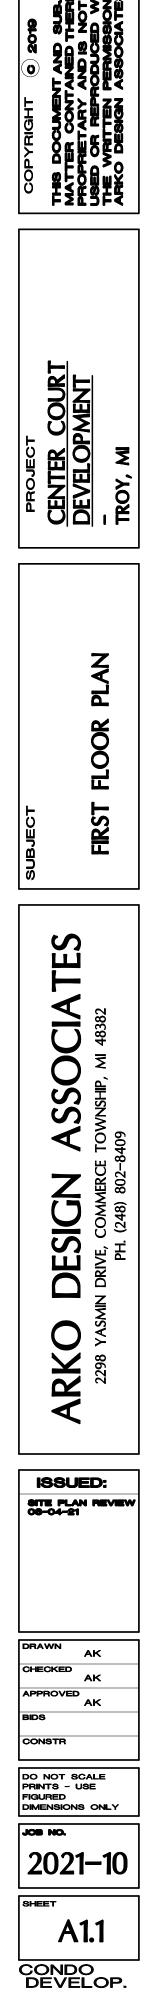



4-UNIT BUILDING MAIN LEVEL FLOOR PLAN




667 SF SCALE: 1/4'' = 1'-0''




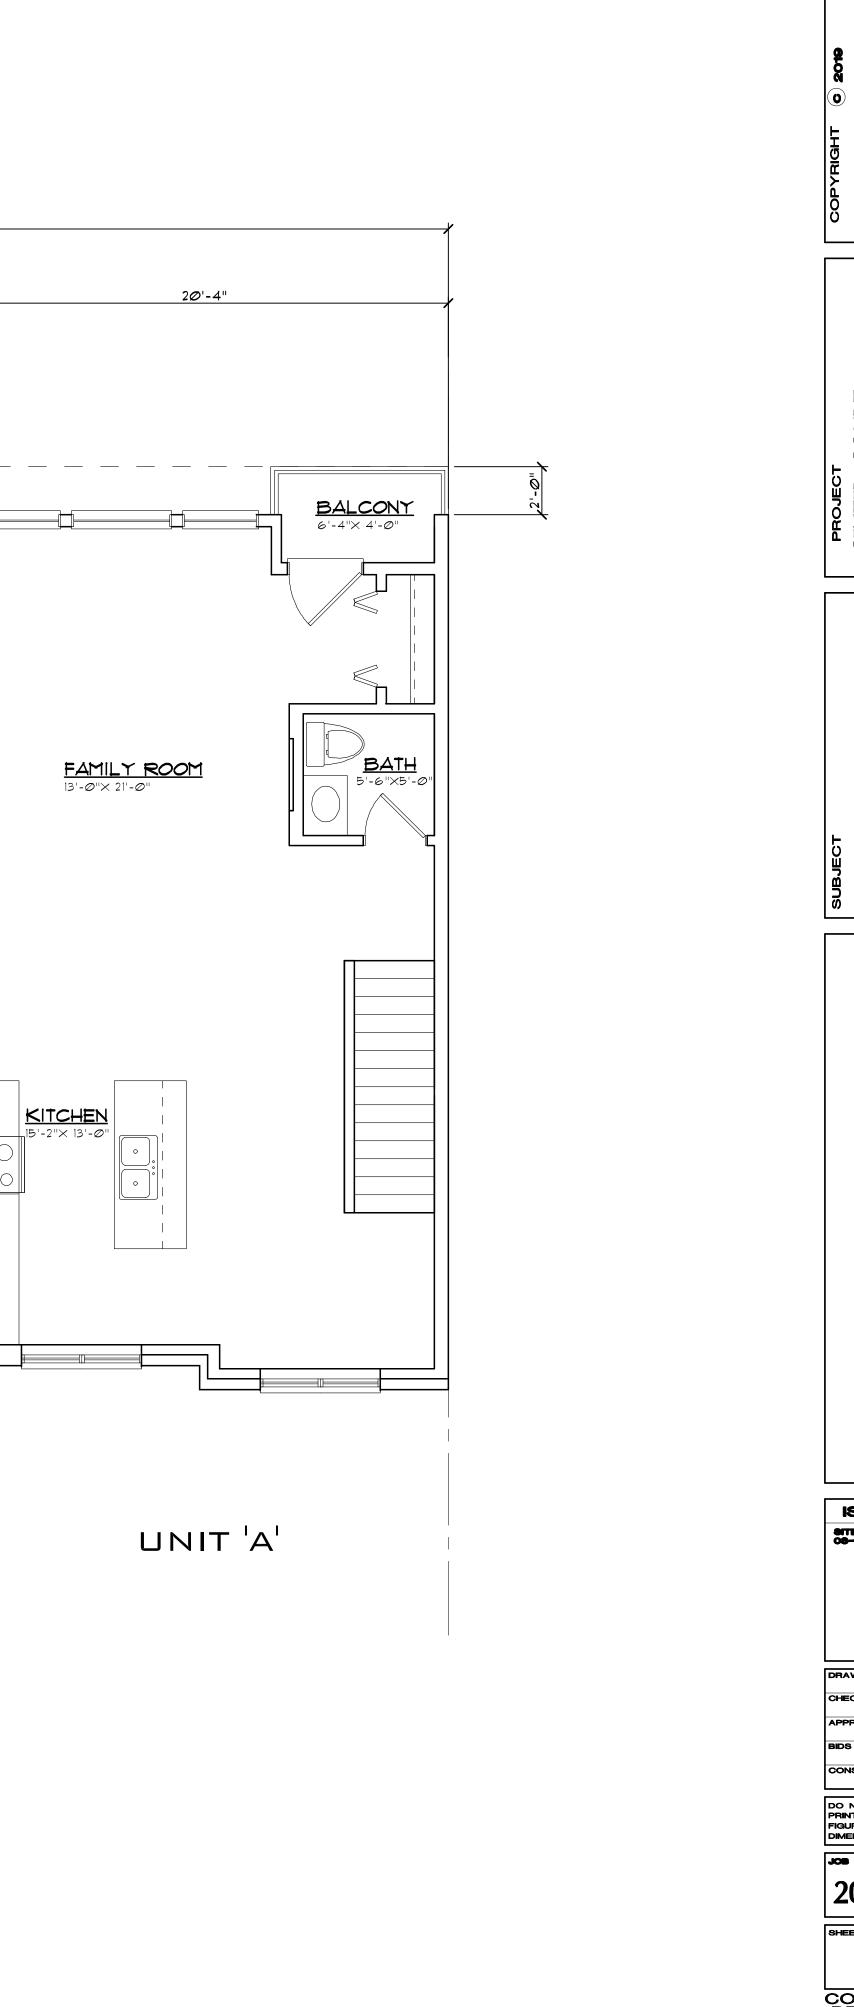

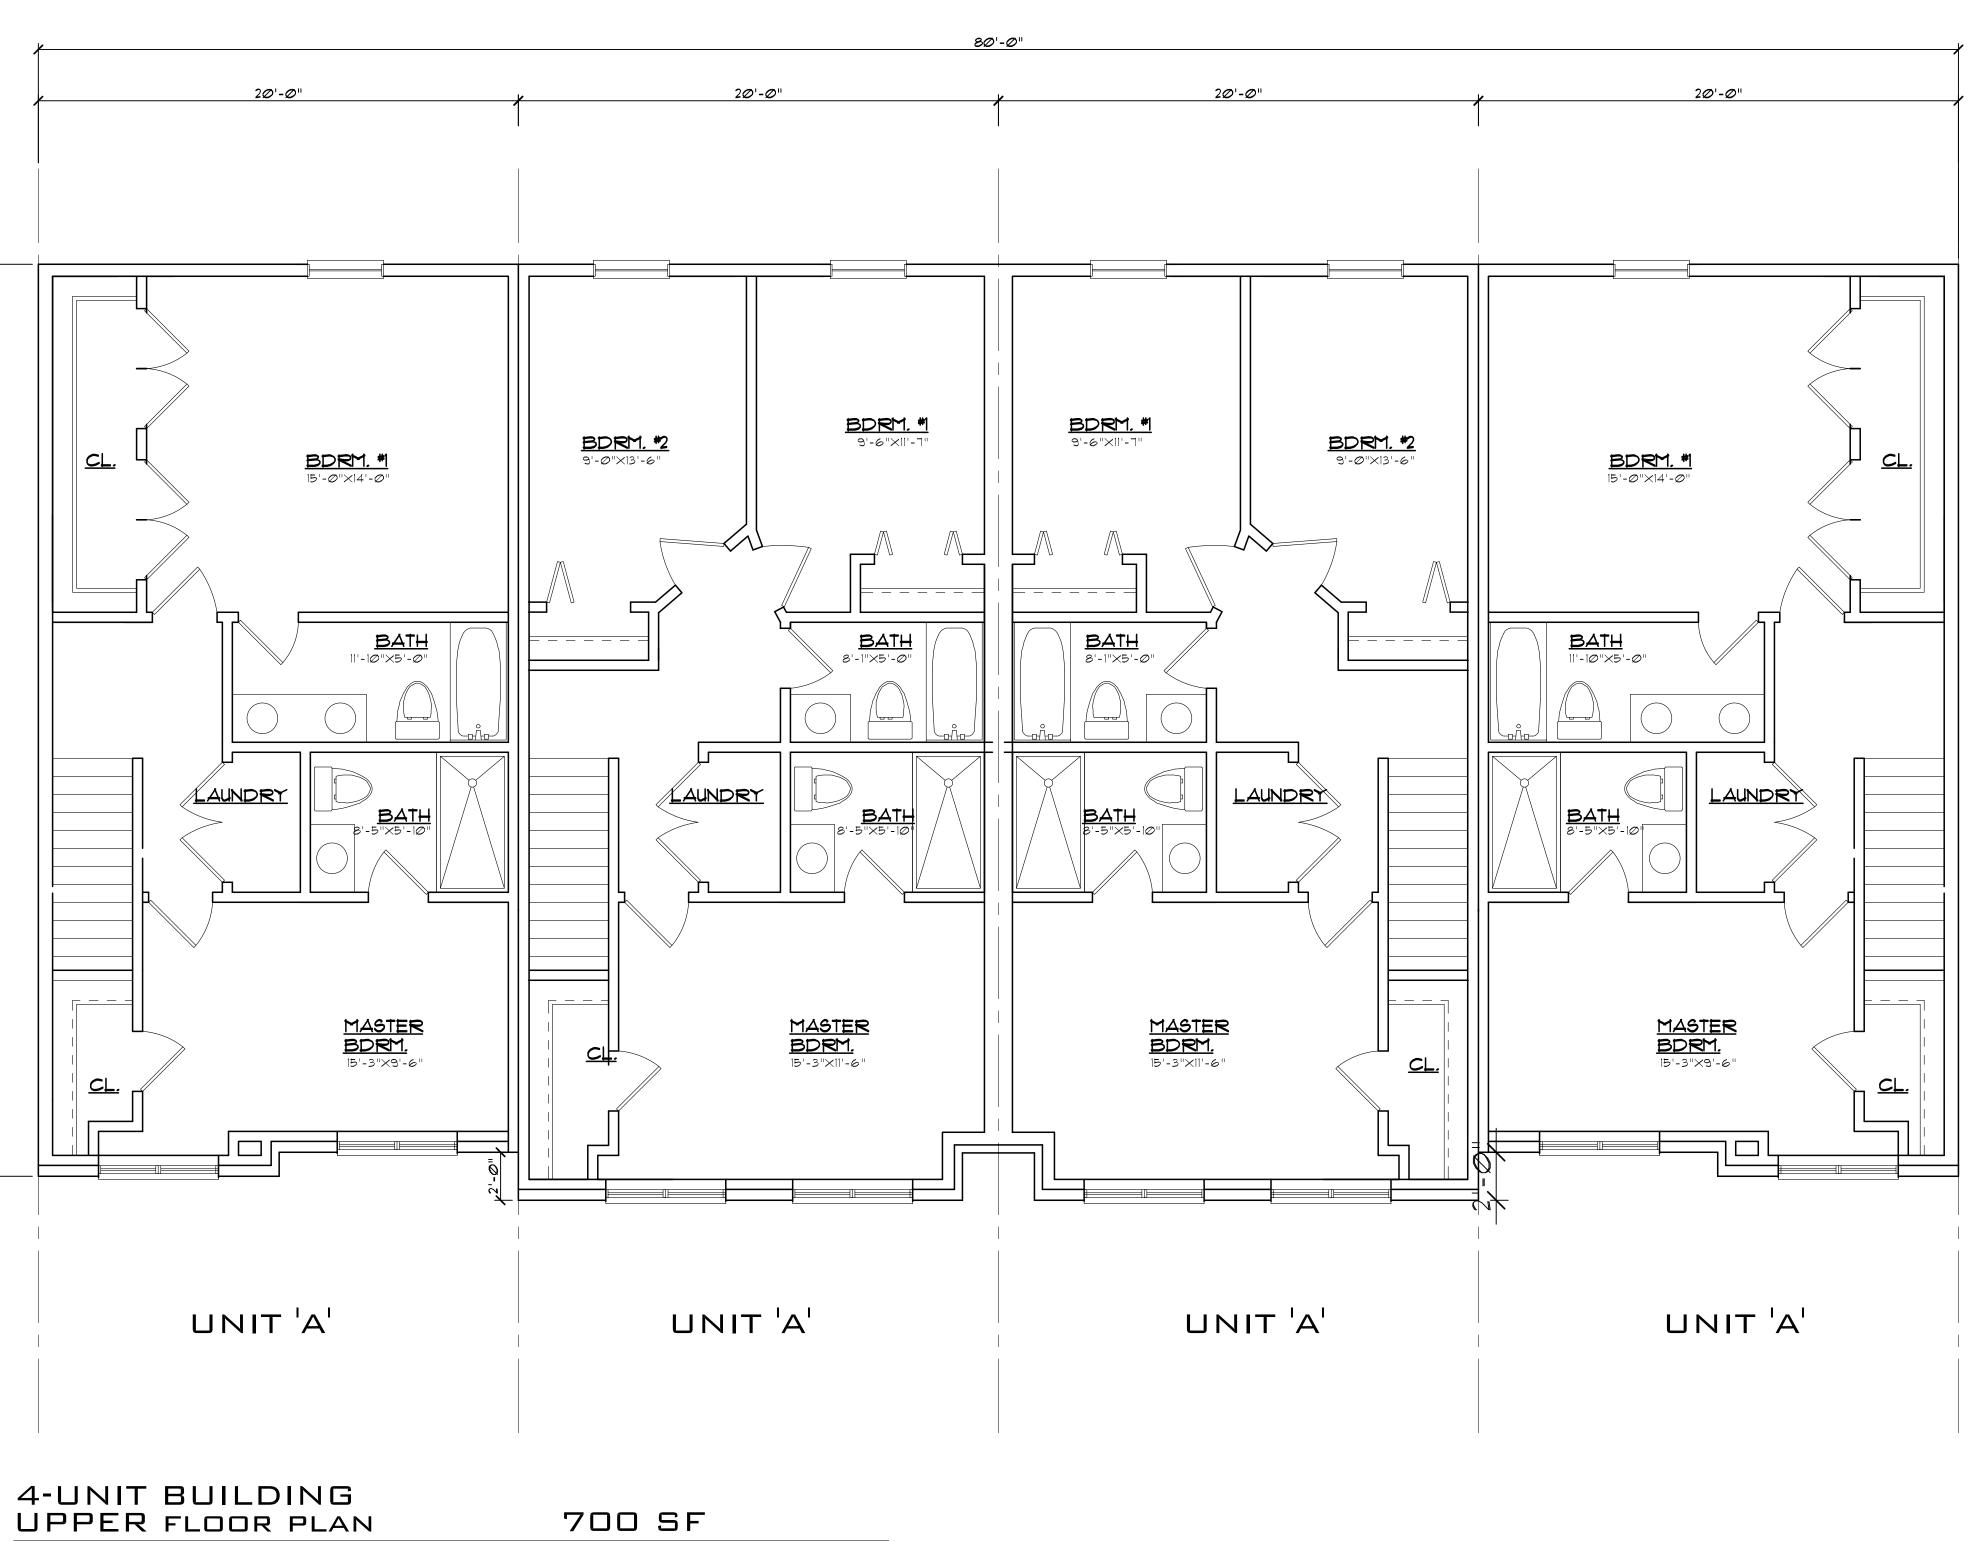

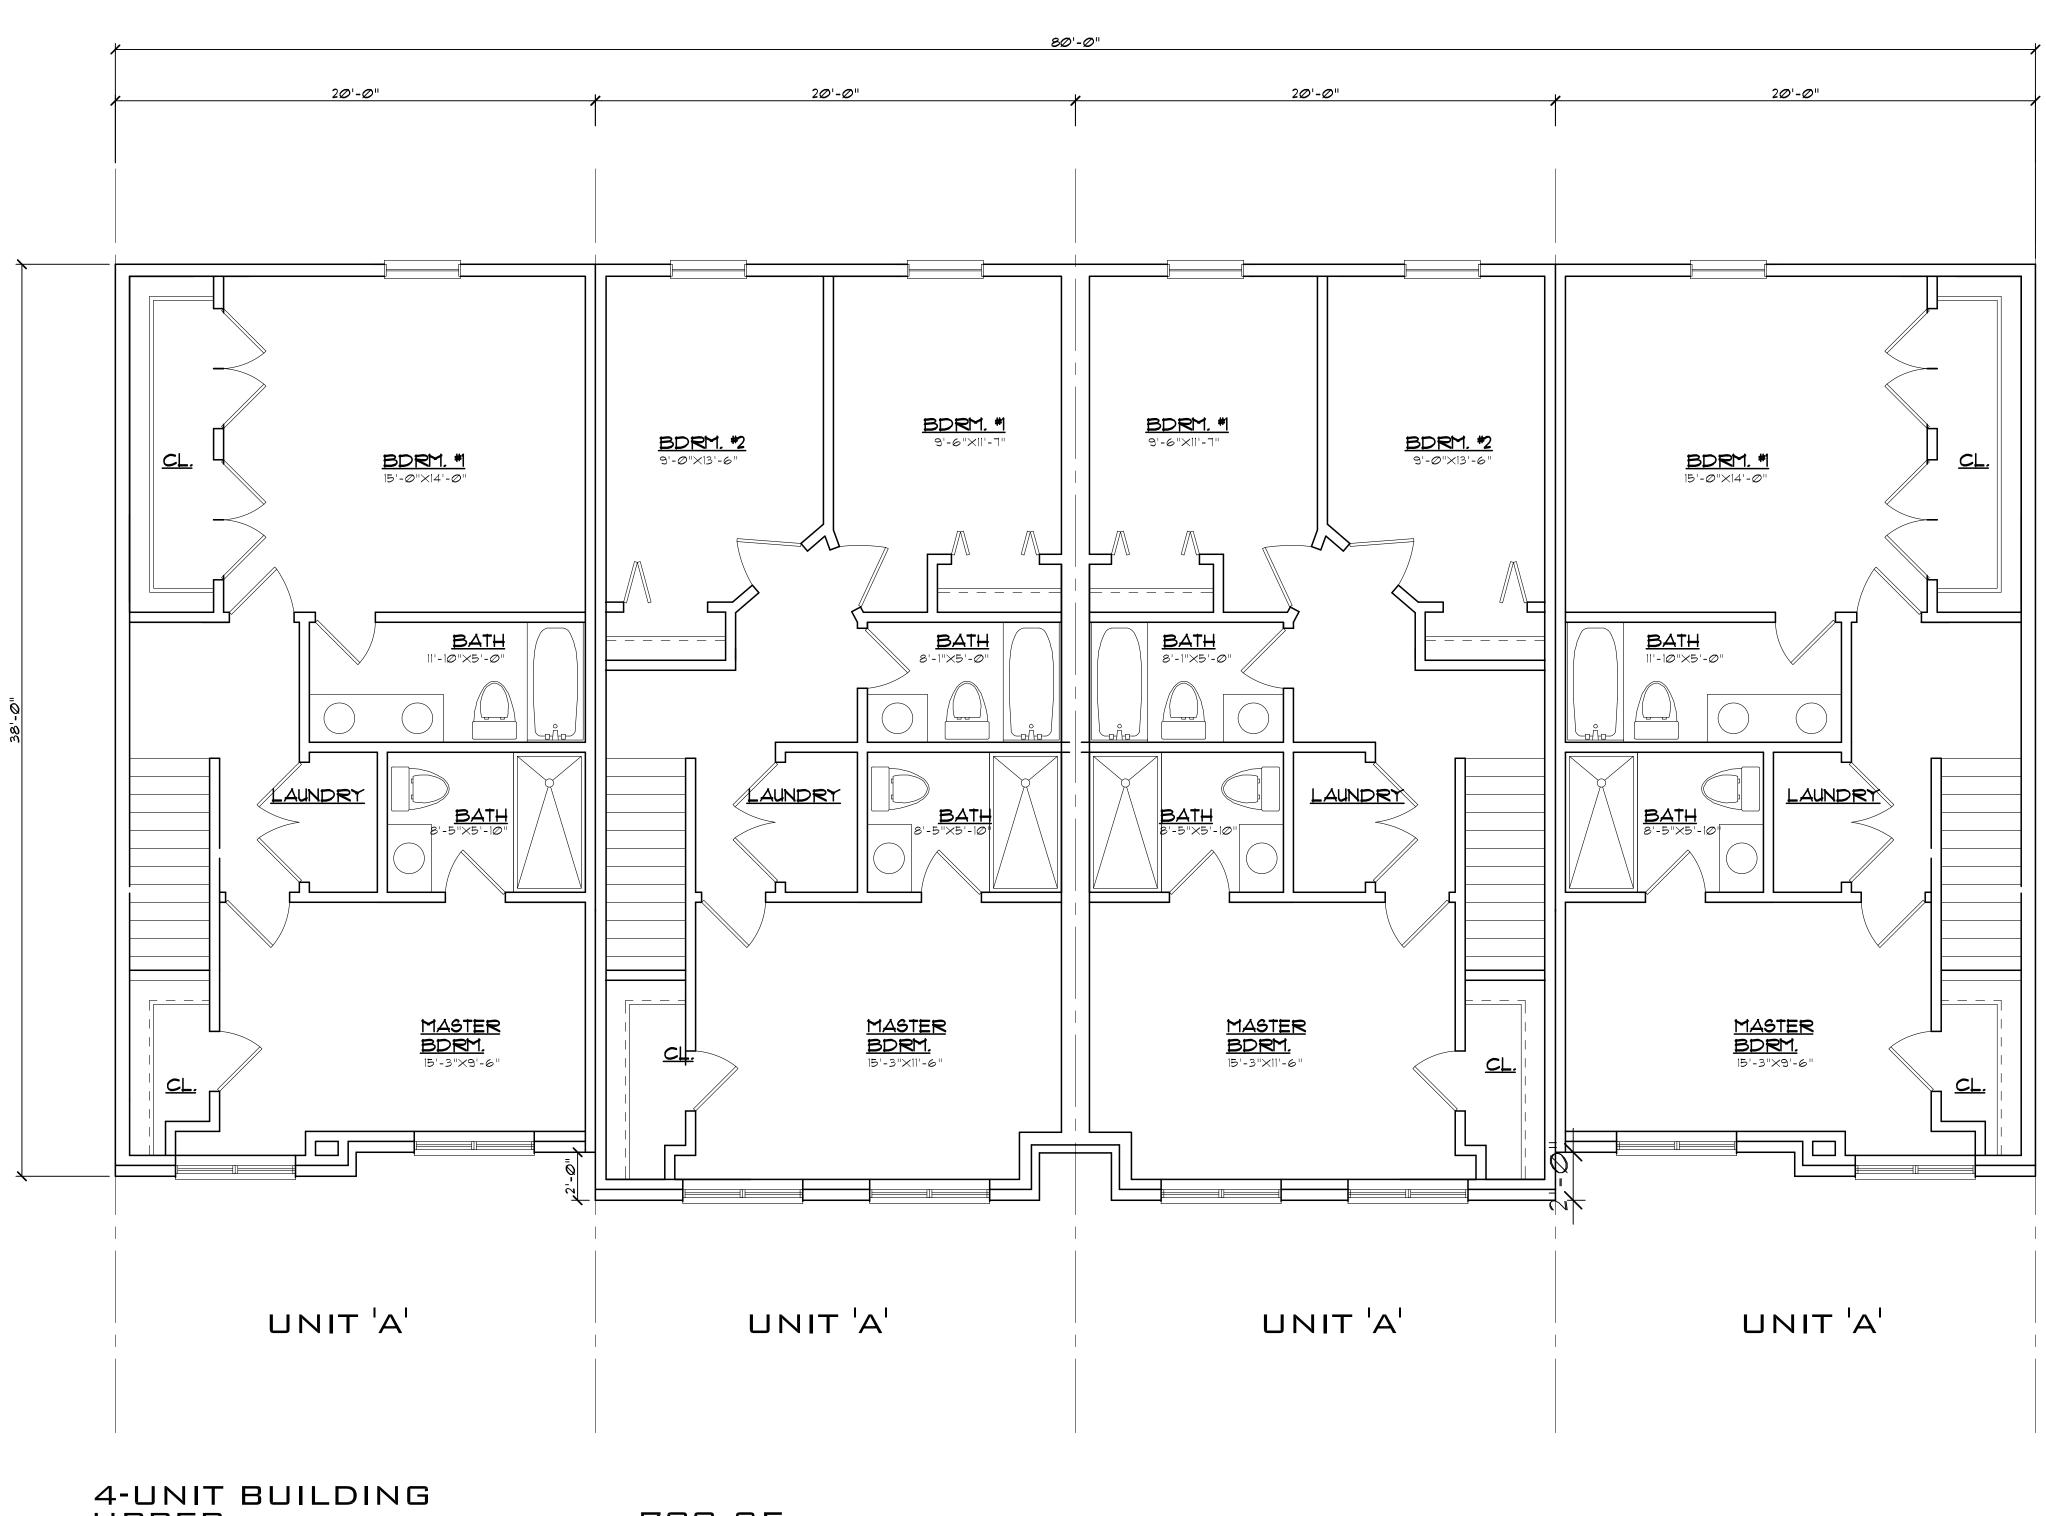

SCALE: 1/4'' = 1'-0''

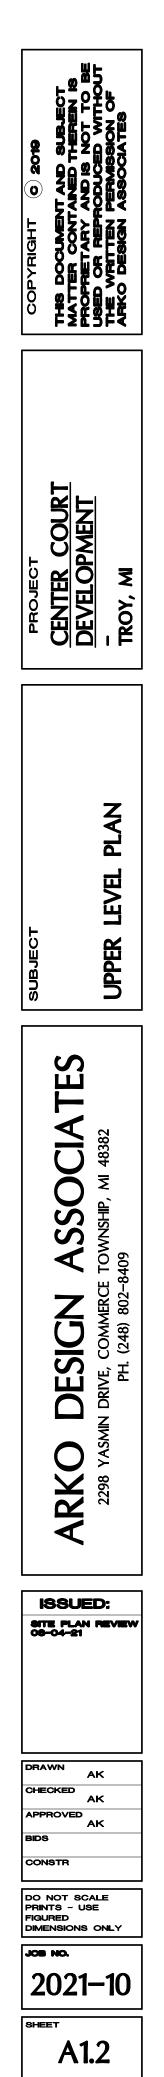

CONDO DEVELOP.



FRONT ELEVATION - 4 UNIT BLDG.

SCALE: 1/4" = 1'-0"

CONSTR

DO NOT SCALE PRINTS - USE FIGURED DIMENSIONS ONLY JOB NO.

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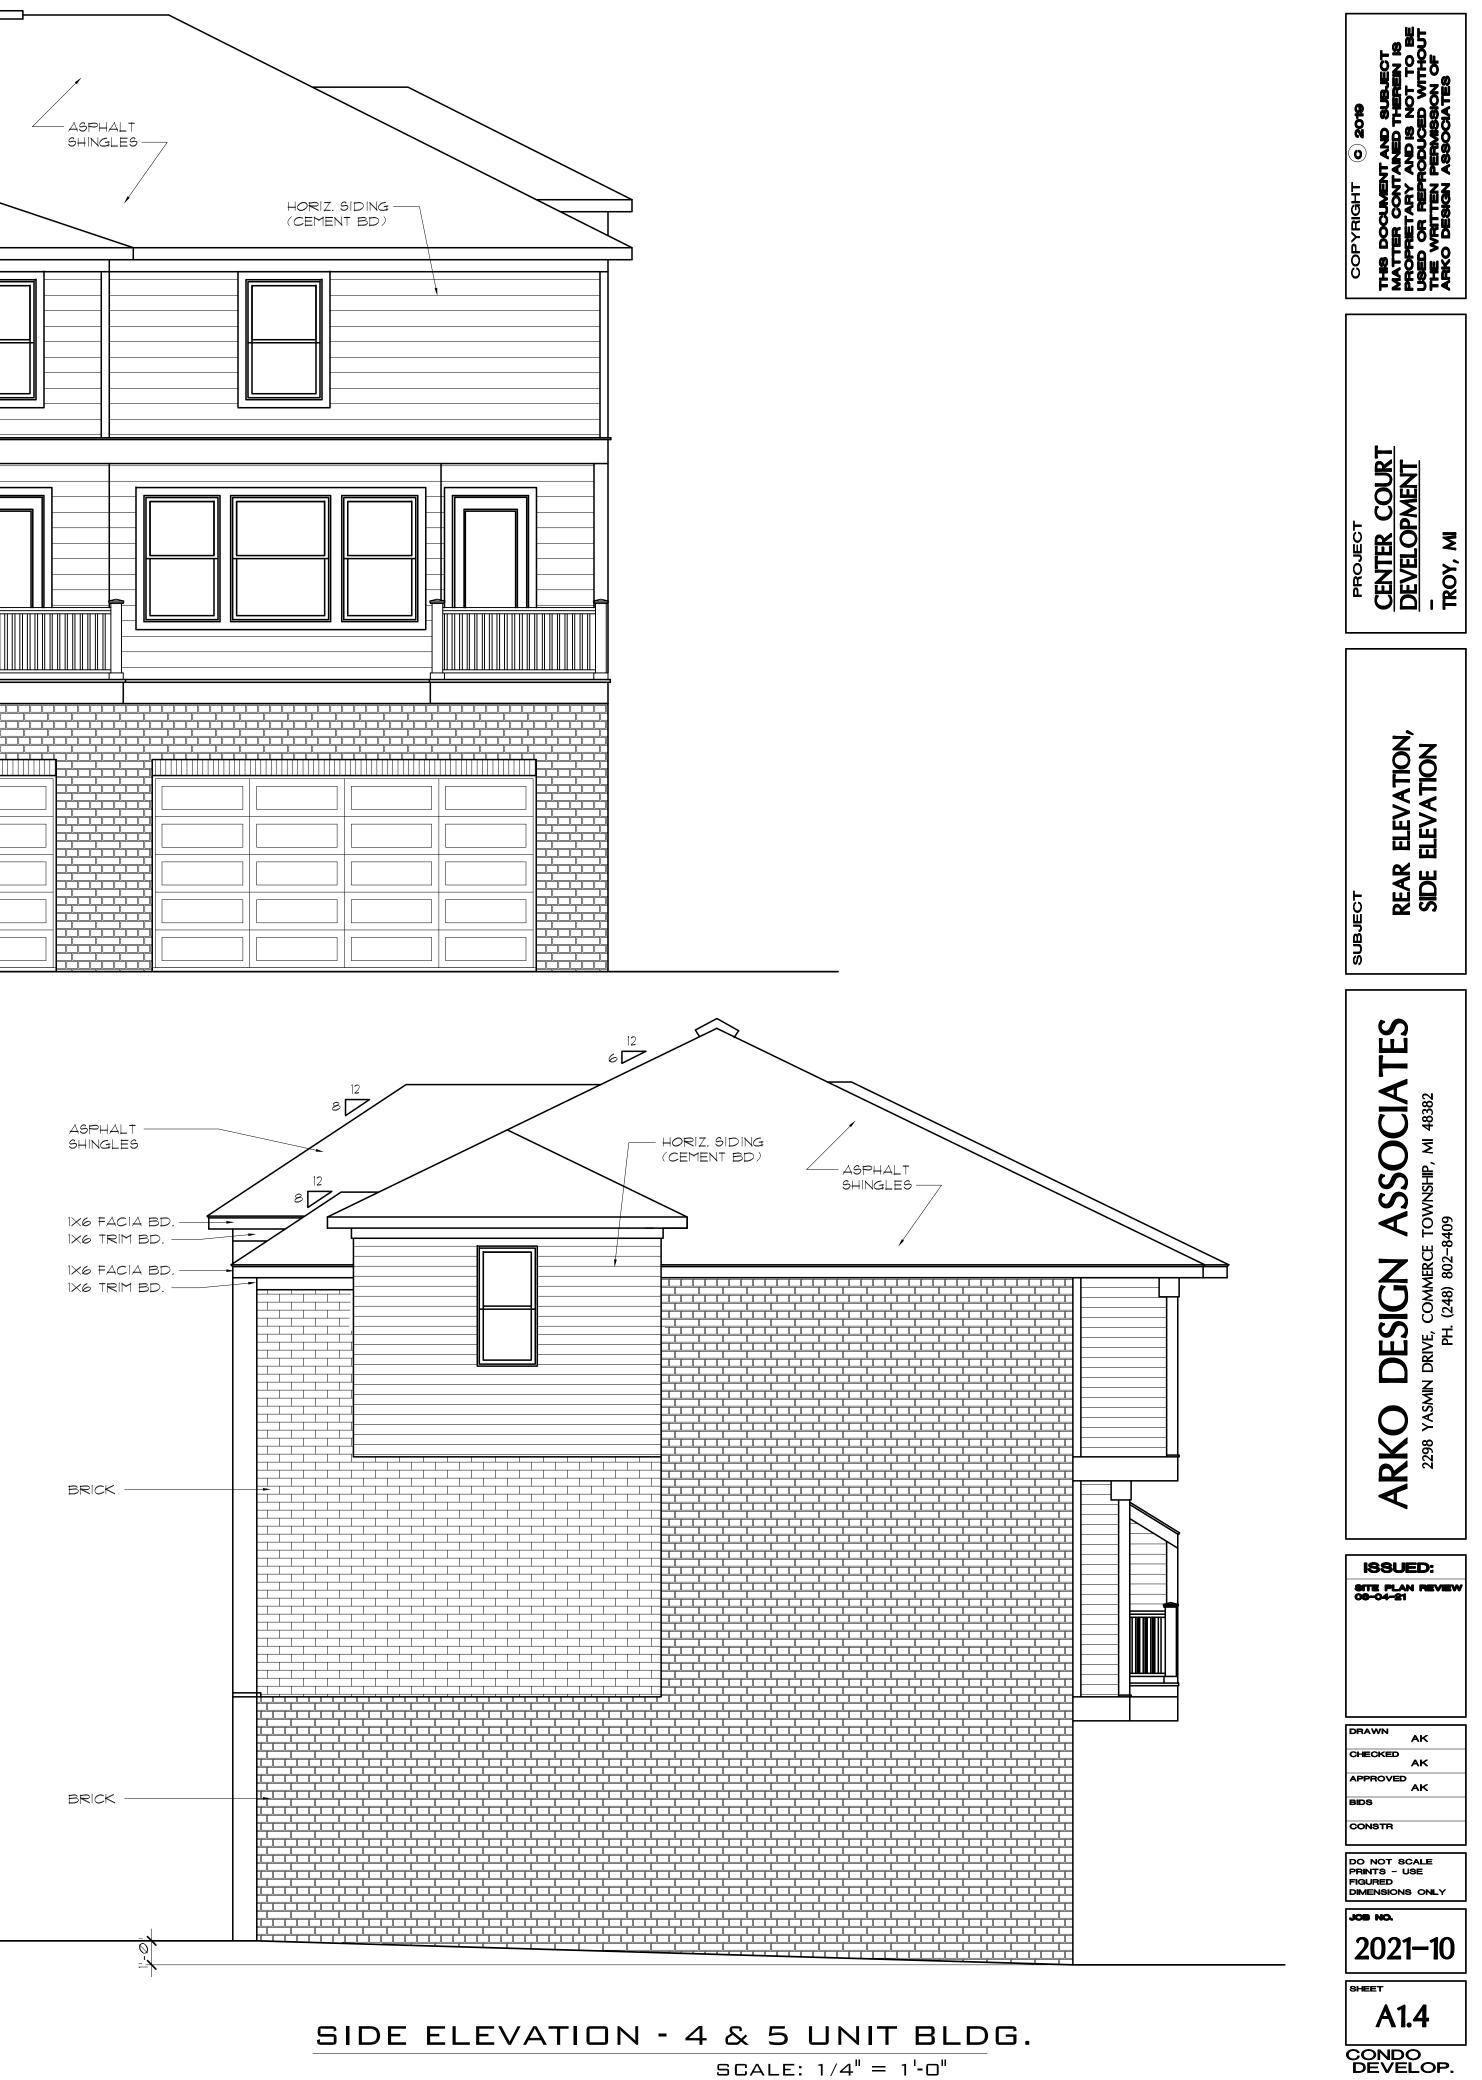
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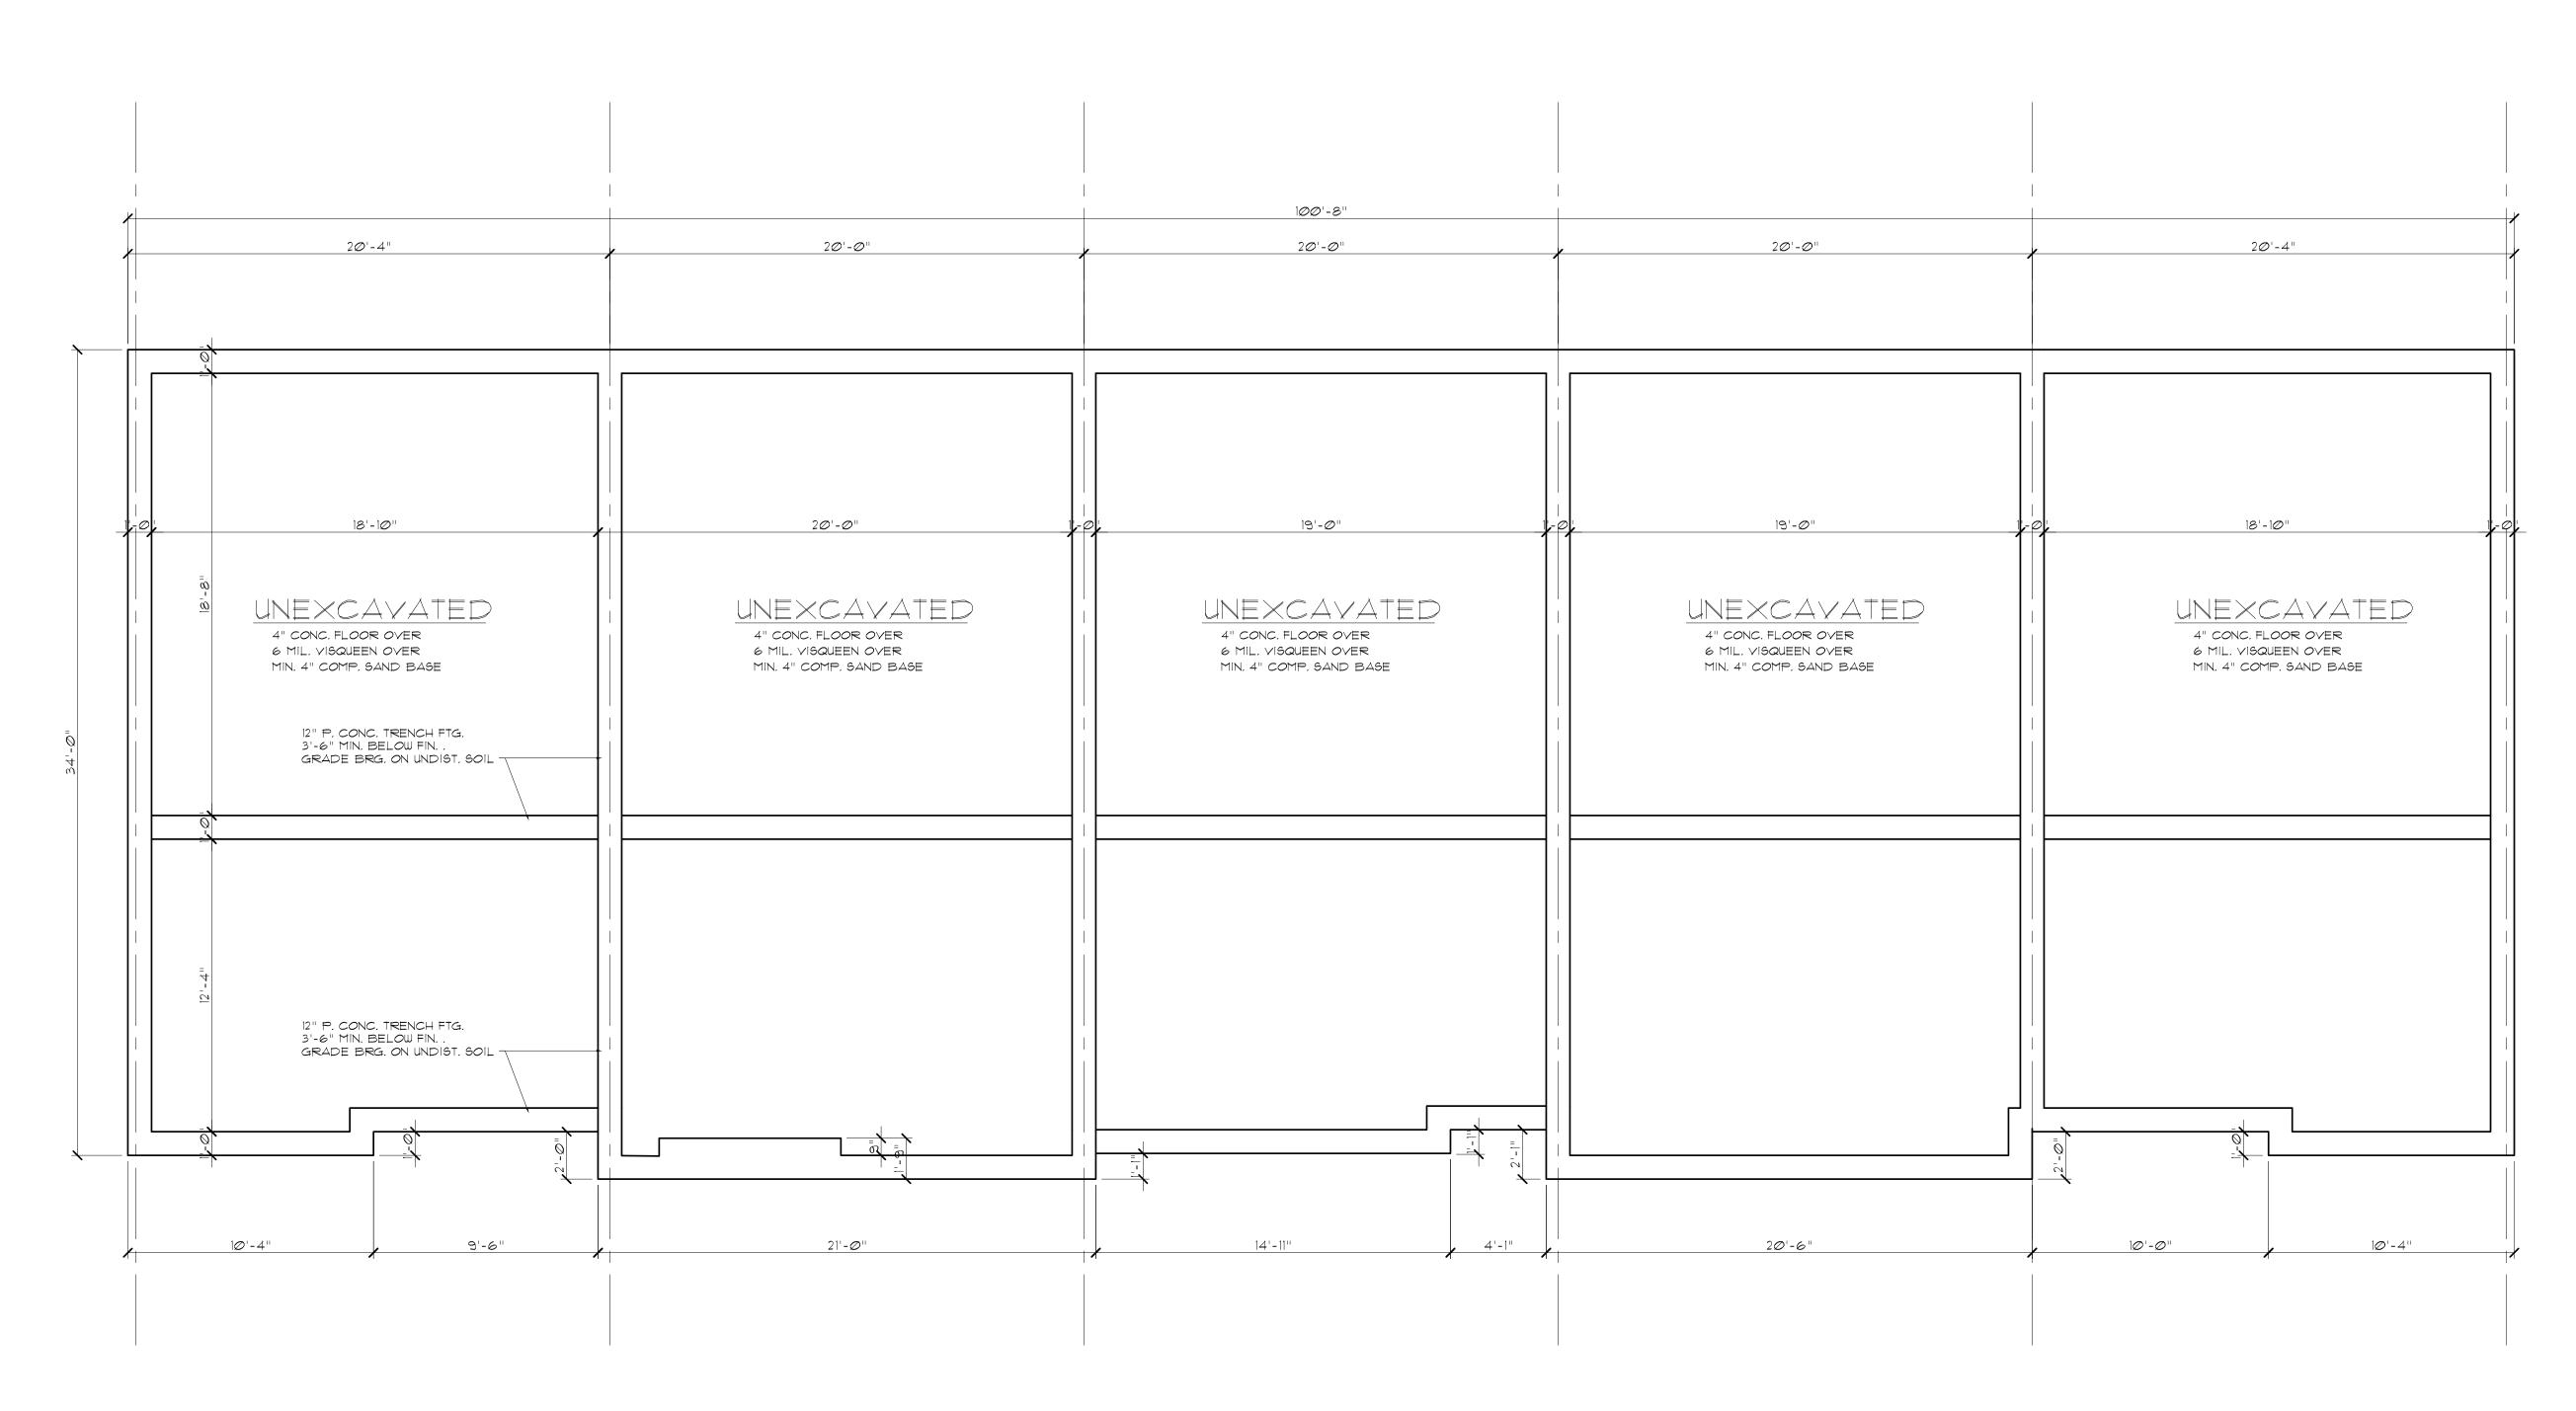


REAR ELEVATION - 4 UNIT BLDG.

SCALE: 1/4'' = 1'-0''




SCALE: 1/4" = 1'-0"



5-UNIT BUILDING FOUNDATION PLAN

SCALE: 1/4'' = 1'-0''


BEARDER CENTER COURT DEVELOPMENT -TROY, MI PLAN FOUNDATION ES ASSOCIATE TOWNSHIP, MI 48382 **DESIGN** IN DRIVE, COMMERCE PH. (248) 802-ARKO 2298 YASN ISSUED: SITE PLAN REVIEW DRAWN AK CHECKED AK PPROVED ак ONSTR DO NOT SCALE PRINTS - USE FIGURED DIMENSIONS ONLY JOB NO. 2021-10 SHEET A0.2 CONDO DEVELOP.

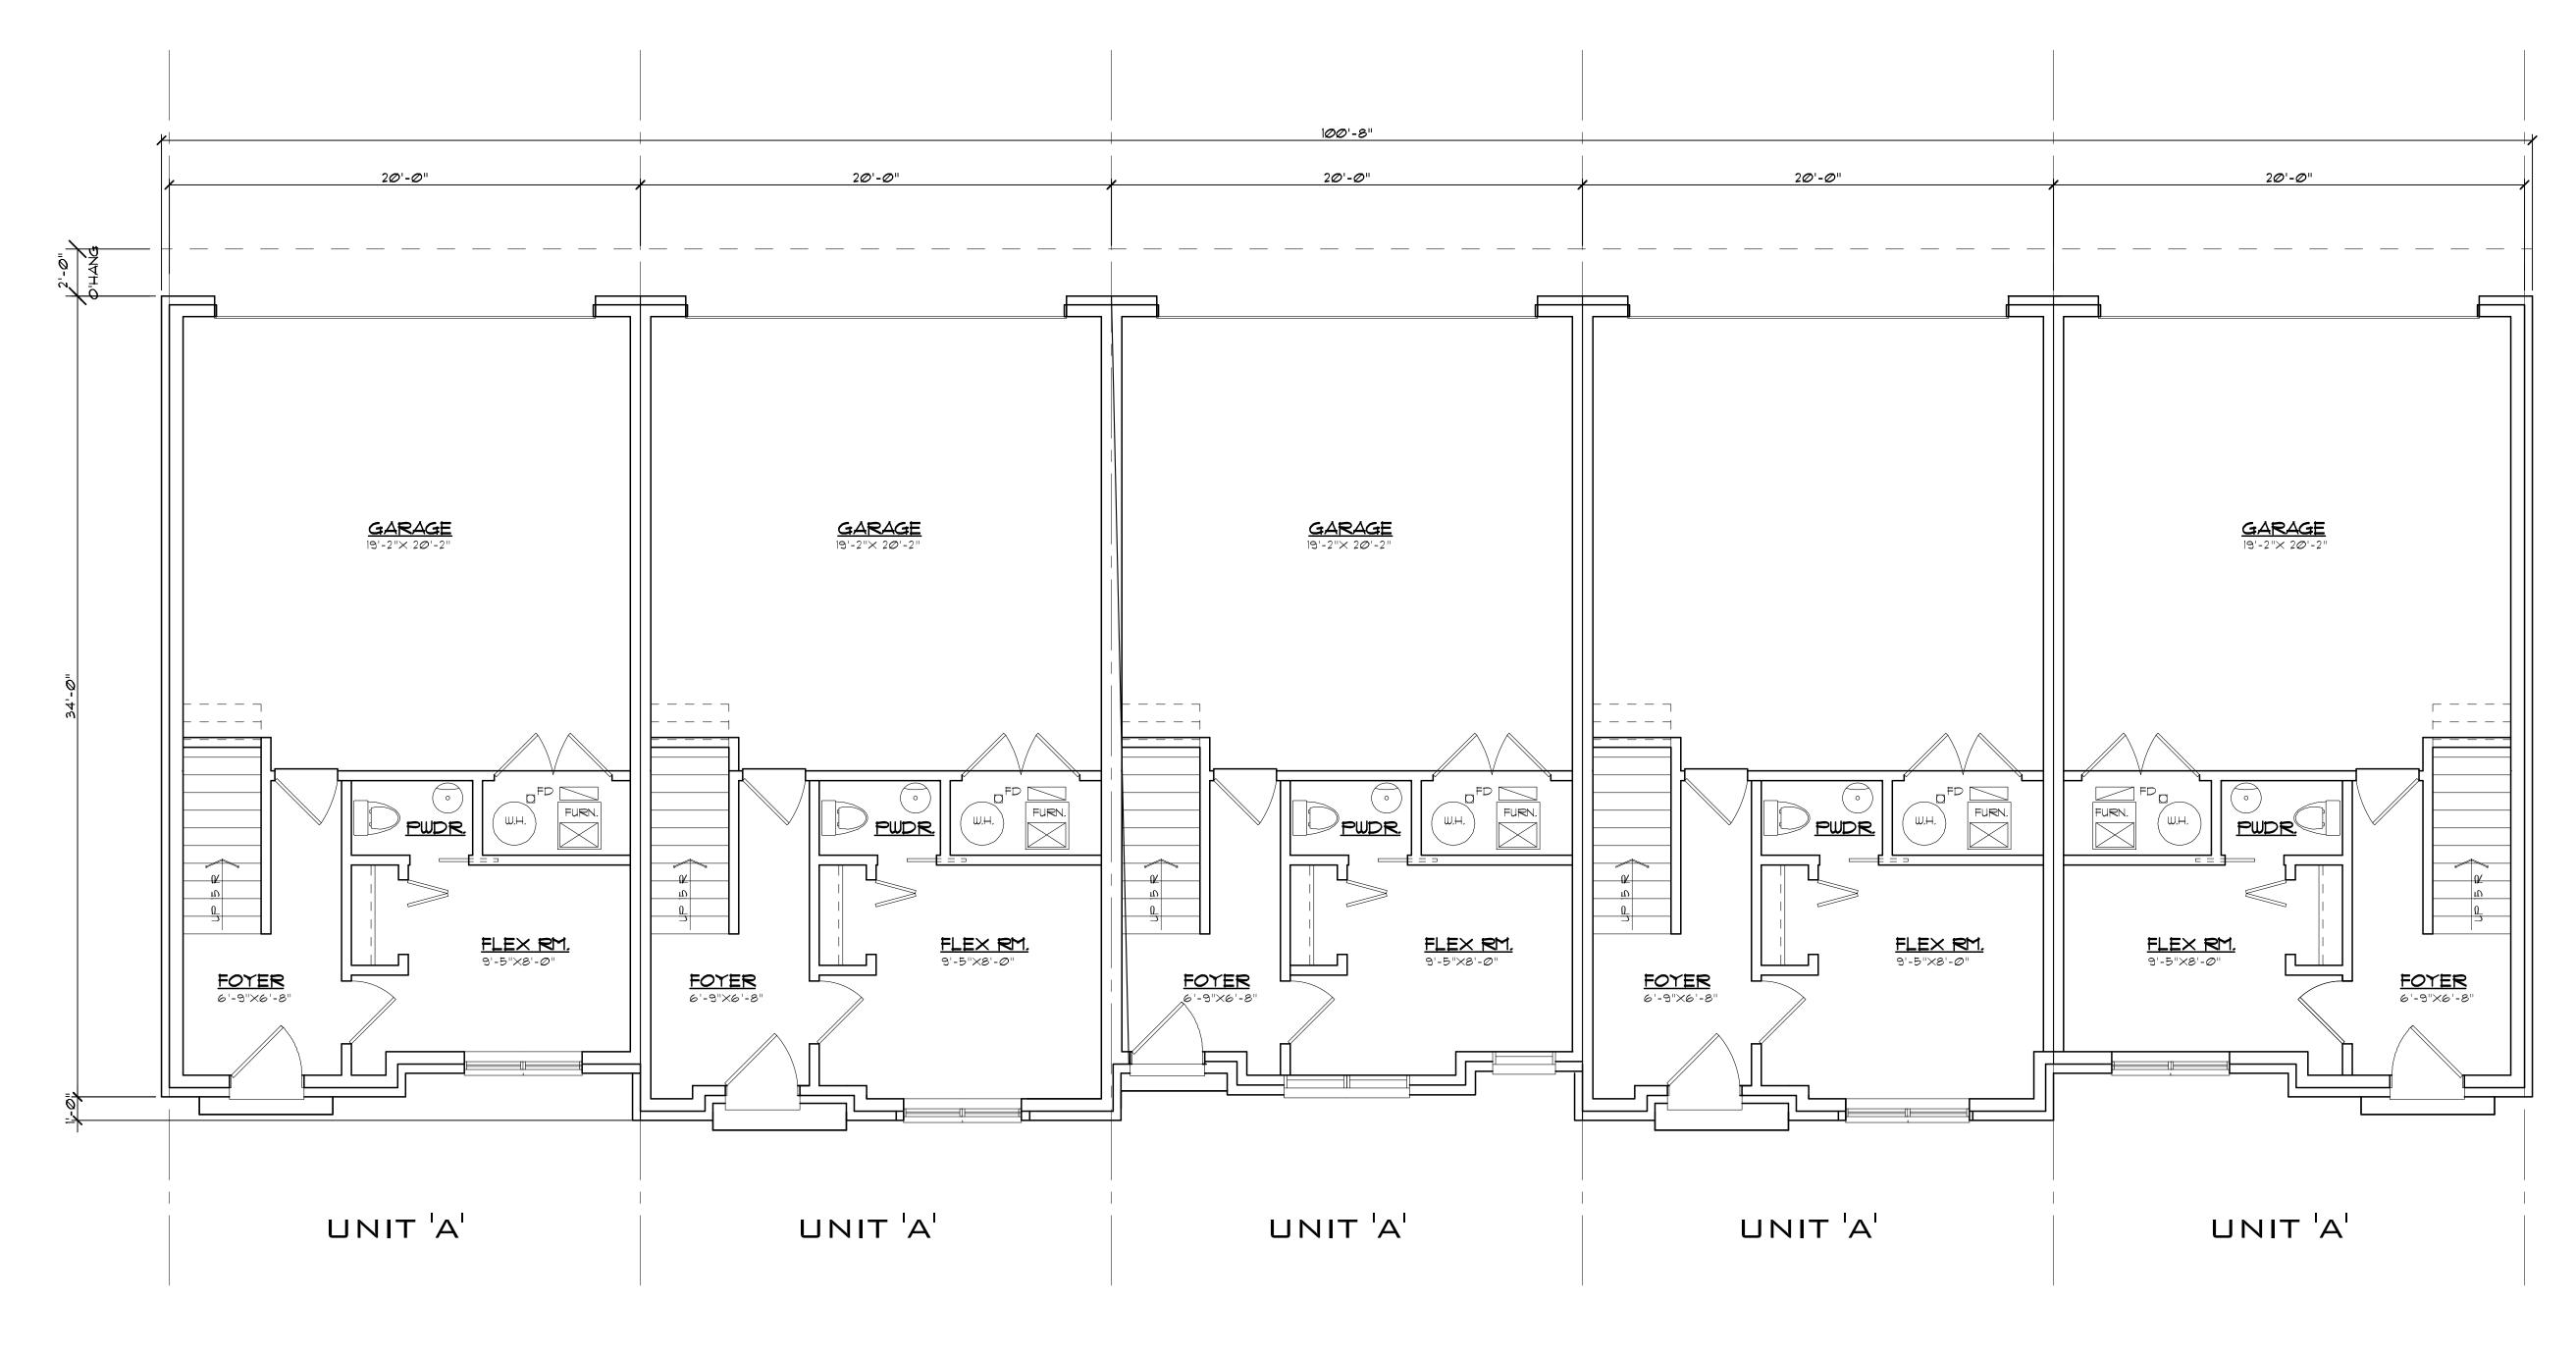




260 SF




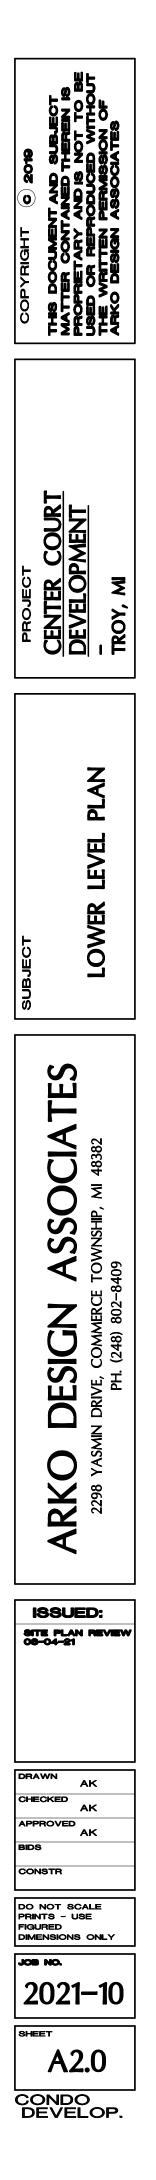



SCALE: 1/4'' = 1'-0''

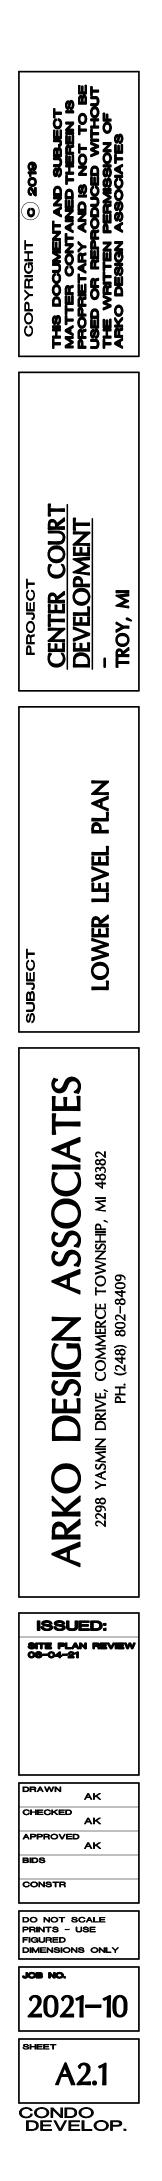


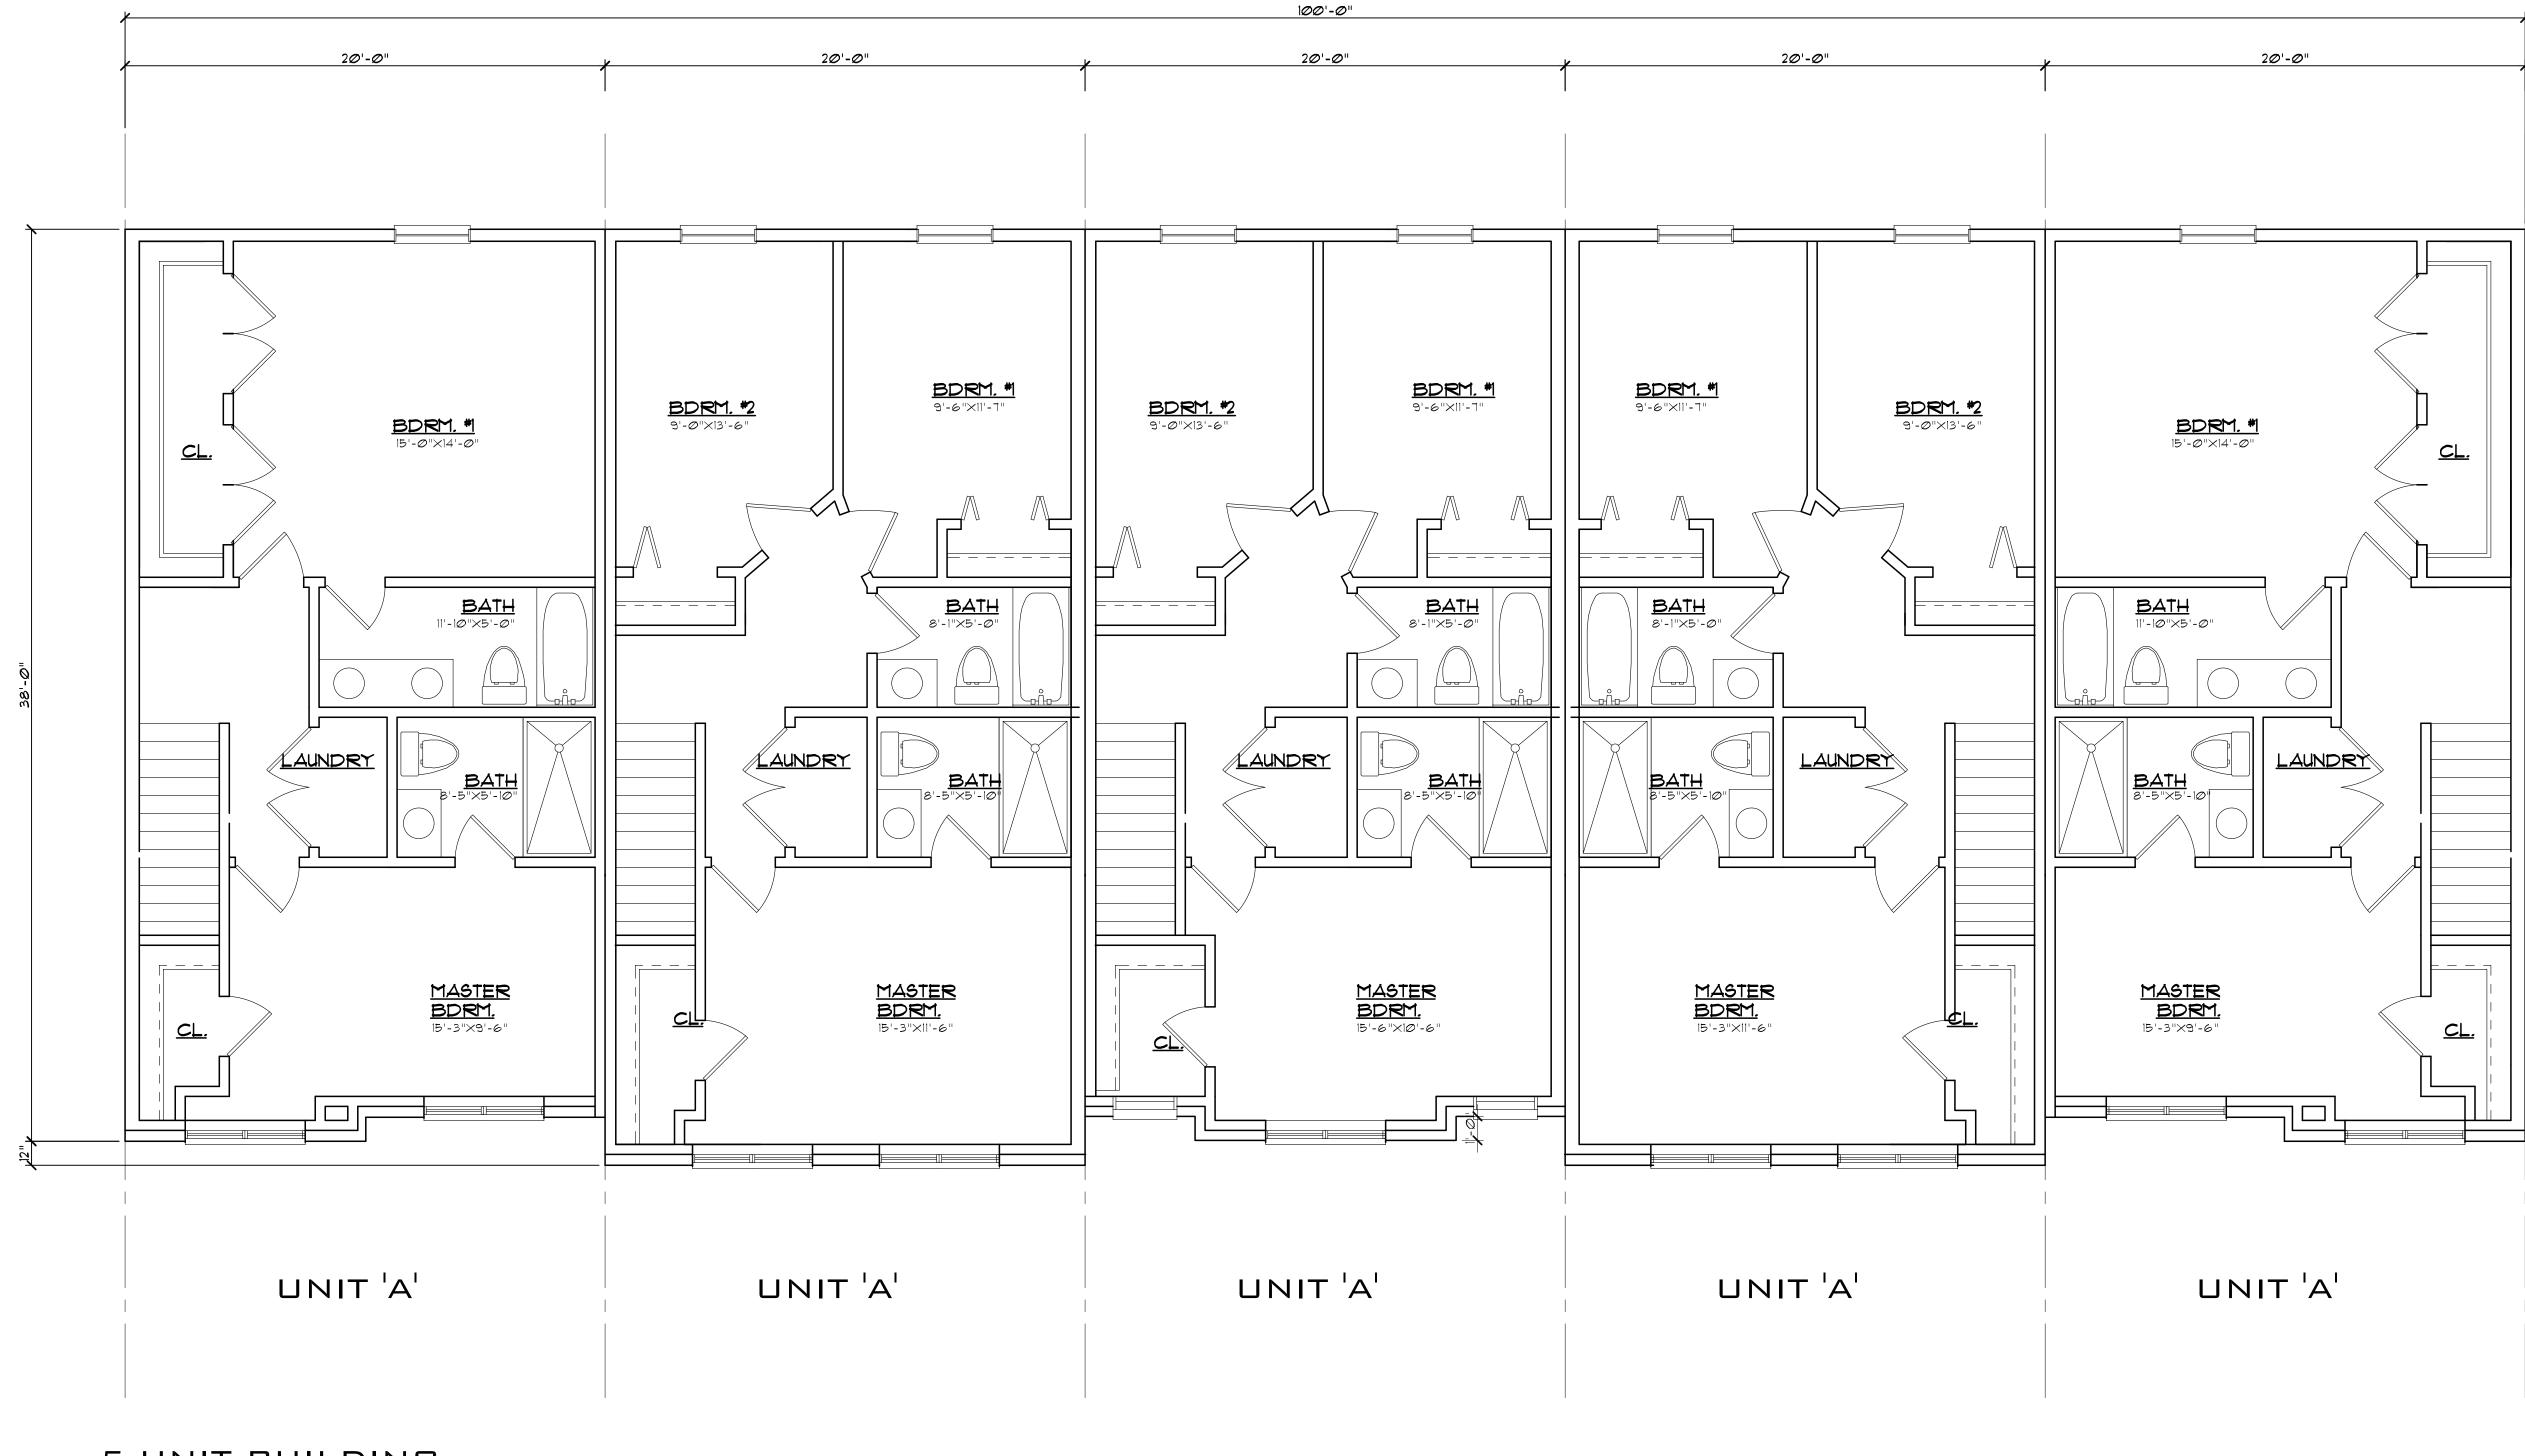

5-UNIT BUILDING UPPER FLOOR PLAN

700 SF

SCALE: 1/4" = 1'-0"

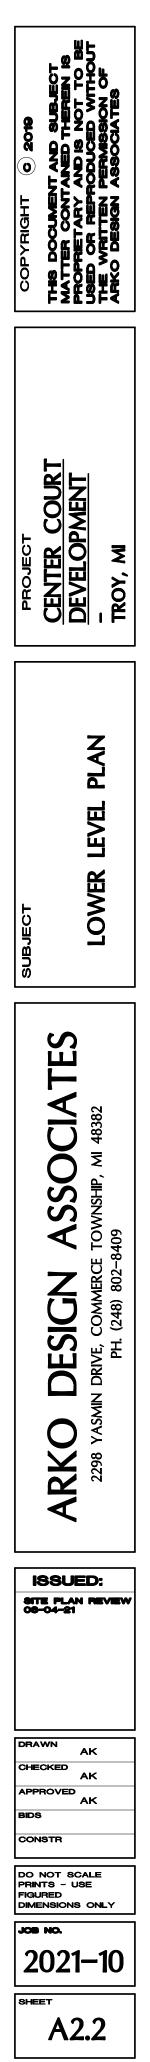



CONDO DEVELOP.





REAR ELEVATION - 5 UNIT BLDG. SCALE: 1/4" = 1'-0"

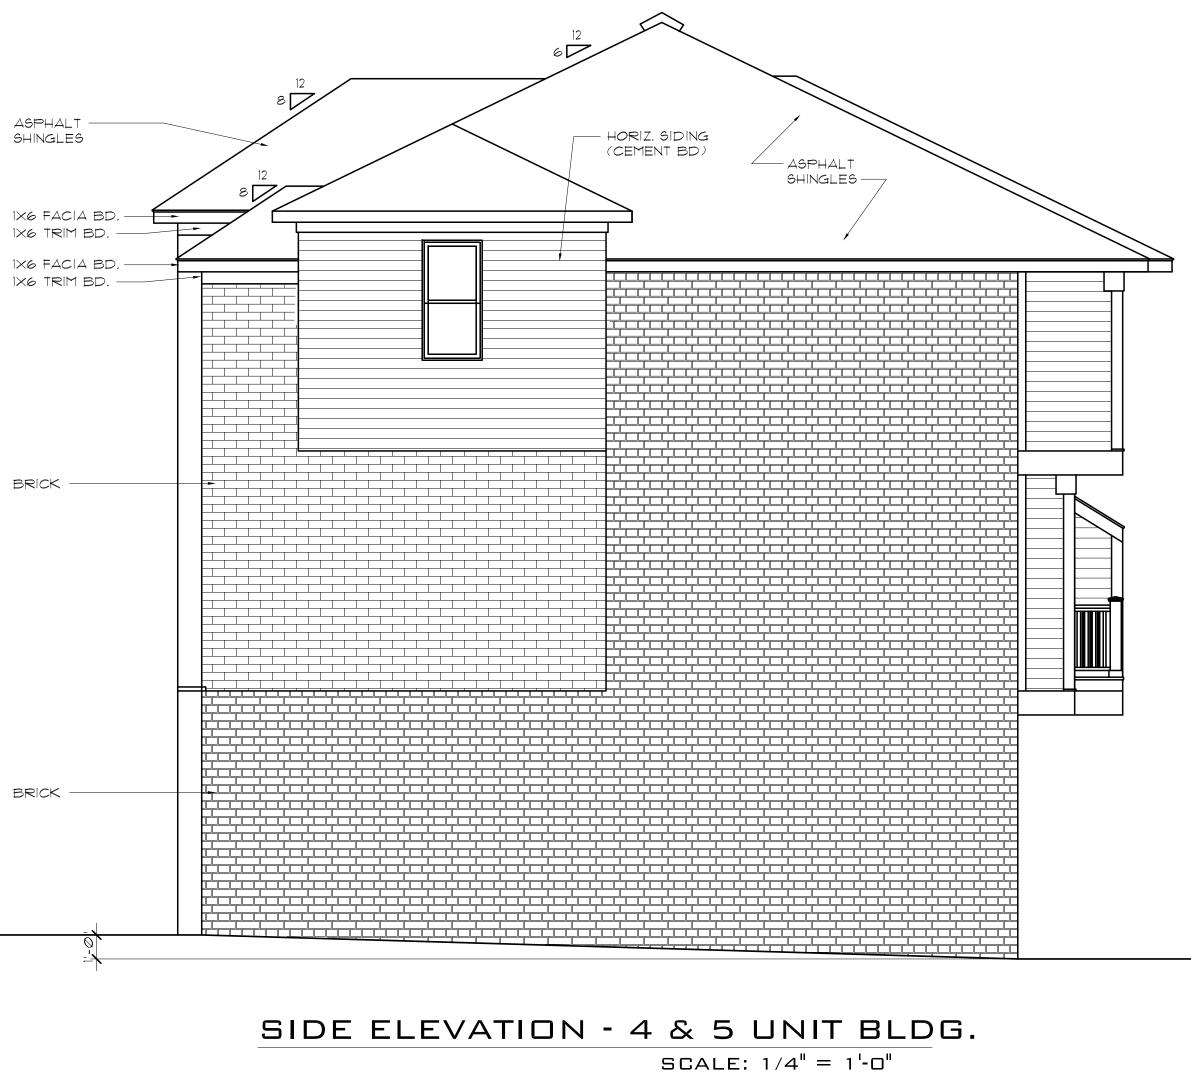

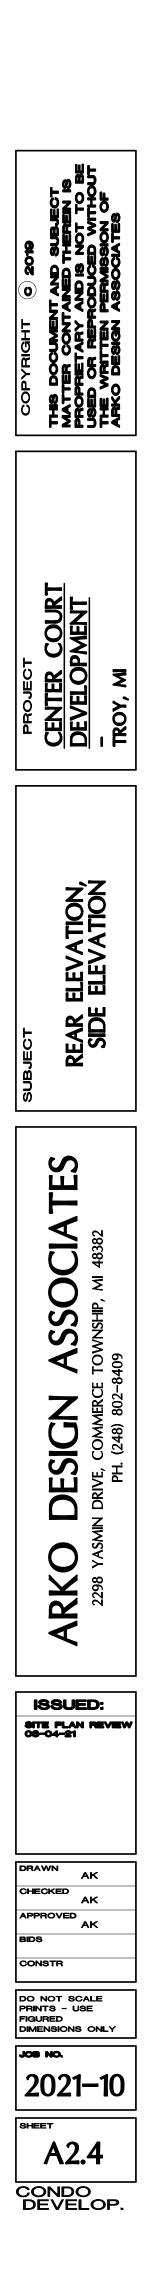



Center Court Town Homes At Butterfield





DEVELOPMENT HIGHLIGHTS

- New Construction / Maintenance Free Lifestyle
- 52 Unit Development: 2 or 3 bedroom Town Homes
- ✤ SQFT Range: approx 1,700 (+/-).
- ✤ Featuring:
 - Private Ground Floor Suite / Office
 - Private Balcony / Veranda
 - In-Wall Fireplace Napoleon Series
 - Attached 2 Car Garage
 - Pella[®] Windows & Doors
 - Designed for Energy Efficiency
 - ◆ ~ +30% Better Energy Efficiency than Code Required
 - Wireless / Ethernet Ready
 - Green Space Center Court with Extensive Landscaping & Common Areas
 - Units with modern features and open floor plans

Eureka Building Co.





Community Site Plan



BUILDING FEATURES

Exterior features High Quality **Pella**[®] Windows & Doors with Charming Elevations highlighted by premium **Brick and Stone** veneer. Dimensional asphalt roof shingles, and Two Car Attached Garages with steel panel sectional doors, wired with a garage door opener and transmitters. Charming balcony off of main level with privacy wall between neighbors.

Interior features Open Space Concept with LED recess ceiling lights throughout, Hardwood Floors, Quality crafted 42" Cabinets, Granite Counter tops with **GE**[®] Stainless Steel kitchen appliances etc.,

Eureka Building Co.





Community Building Elevations





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Community Floor Plans





Floor 1

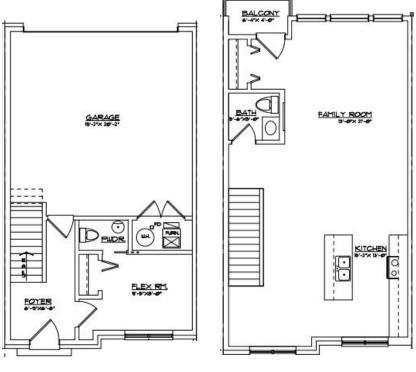Floor 2

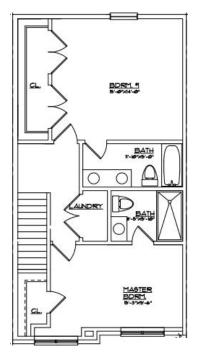Floor 3

Exterior Lighting



Exterior Lighting packages features very attractive wall luminaire for outdoor lighting. **Matte Black Dark Sky Outdoor Wall Mount LED.** Black finish outdoor wall light helps to keep the night skies dark while providing light where needed.

Eureka Building Co.





Exterior Building Materials

Roofing




IKO Cambridge Dual Black or equal

Stone



Ivory White Opel or equal

Siding

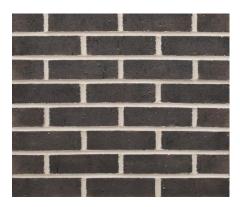

Midnight Mist or equal

Brick



Morning Snow or equal



Hardie James Lap or equal

Eureka Building Co.





All information herein was accurate at the time of publication. We reserve the right to make updates and changes to specifications, material and price without notice and obligations.

Brick

Eureka Building Homes are engineered for energy efficiency. Our energy savings construction package includes:



Furnace: 95%+ AFUE

A/C: 13 SEER

DR Nelson Energy Seal

	1990's-2008 Energy Code Predicted performance of identical plan built to "Prescriptive" values of the 1997-2008 Michigan Energy Code.		Current Energy Code Predicted performance of identical plan built to "Prescriptive" values of our new Michigan Energy Code effective February 2016.		Eureka Building The dimensionally identical home built with the Eureka Building Company Energy package	
Plan/Model	Annual Energy Costs*	Home Energy Rating Score**	Annual Energy Costs*	Home Energy Rating Score**	Annual Energy Costs*	Home Energy Rating Score**
End Unit	\$ 1,284	123	\$ 928	96	\$ 750	69
Interior Unit	\$ 1,093	119	\$ 792	94	\$ 633	69

*Predicted Annual Heating, Cooling & Water Heating costs based on average climate data for SE MI and Electricity @ 12¢ /kWh, Natural Gas @ \$1.00/CCF

**HERS is a registered trademark of RESNET (Residential Energy Specialists Network). For more information about HERS ask your salesperson or visit: <u>www.RESNET.us</u>

This information does not constitute any warranty of energy costs or savings. This analysis was conducted using REM/Rate v15.3, the computer software program developed for the Energy Star® for homes program by the United States Environmental Protection Agency and the Department of Energy. D.R. Nelson & Associates, Inc. is a licensed, certified HERS Rater/Provider for RESNET and the Energy Star® Program. The energy costs above were calculated by comparing dimensionally identical homes with the values expressed – typical of the energy code at the time. Your heating, cooling and water heating energy costs may fluctuate depending upon such factors as, number of occupants, occupant behavior, temperature settings, window coverings and more.

Eureka Building Co.















<u>Center Court Development</u> <u>Preliminary site plan application section 6</u>

6-A. The proposed development on north side of Butterfield road between Todd drive and Crooks road meets Multiple-Family role to serve as "go to" places that take on a social role, serving as a place to meet basic needs of the community including integrated residential development. Located in an area that already includes within walking distance existing and new restaurants, shops, office buildings, the proposed attached family single residence townhouse development offers an urban character while serving as transitional zone between areas of higher and lower intensity of development as identified in the Master Plan.

6-B. The proposed single family attached townhouse concept is based on an contemporary / urban architectural design. The unique urban architectural features visually distinguish it from the surrounding area because of the design and intensity. The urban design complements the traditional building design at Regency of Troy (nearby developments) by providing architectural design diversification in a key transitional area of Troy. Urban design developments are lacking in the nearby area and this development will provide with a unique different product while complementing adjacent surrounding developments.

6-C. The project achieves the design concept by incorporating variation of building elevations with urban architectural features such as hip low slope roof, extended overhangs, panoramic windows and high quality materials.

6-D The project achieves the design goal of a modern urban Multiple-Family development while diversifying the design and technique consistency with the latest urban character and trends. The single residential attached units will be intended for sale.

6-E The front building elevations emphasize contemporary design by utilizing high quality stone and brick veneer combinations while incorporating hip roof designs and color combinations. The side building elevation follow the urban design with simple - not too overwhelming details by incorporating high quality brick veneer throughout the elevation.

6-G

Building Orientation and Entrance:

Primary Entrance: The primary unit building entrance is identifiable and usable from Butterfield Road. Unit entrances utilize unique architectural features to identify each unit entrance.

<u>Trash:</u>

Units will utilize individual bins located near garage door.

At grade mechanical equipment:

Mechanical A/C units will be screened with wintergreen boxwood shrubs.

Parking:

Each unit will have an attached 2-car garage and there will be 26 total guest parking spots throughout the development

Parking Total = 130

Recreation Space and Landscaping

Multiple common outdoor seating, a children playground area are <u>interconnected through</u> <u>continues walking</u> areas to create a common recreation area of approximately 28,000 sq/ft.

Landscaping include a variety of deciduous trees such as red oaks, frontier elm and evergreen trees such as Hetz Columnar Juniper, Balsam Fir, Eastern White Pine. In addition the proposed development utilizes an ornamental fence through the Butterfield road entrance and east property line in consistency with adjacent development.