

PLANNING COMMISSION MEETING AGENDA REGULAR MEETING

David Lambert, Chairman, Marianna Perakis, Vice Chairman Toby Buechner, Carlton Faison, Tyler Fox, Michael W. Hutson, Tom Krent, Lakshmi Malalahalli and John J. Tagle

September 26, 2023

7:00 P.M.

Council Chambers

- 1. ROLL CALL
- 2. APPROVAL OF AGENDA
- 3. <u>APPROVAL OF MINUTES</u> September 12, 2023
- 4. PUBLIC COMMENT For Items Not on the Agenda

SPECIAL USE APPROVAL

PUBLIC HEARING - SPECIAL USE APPROVAL AND PRELIMINARY SITE PLAN
 REVIEW (SU JPLN2023-0019) - Proposed Clean Express Car Wash, West side of John
 R, North of Fourteen Mile (PIN 88-20-35-401-001), Section 35, Zoned GB (General
 Business) District

PRELIMINARY SITE PLAN APPROVAL

 PRELIMINARY SITE PLAN APPROVAL (SP JPLN2023-0028) – Proposed John R Gardens Townhome Development, East side of John R, north of Big Beaver (PIN 88-20-23-476-017), Section 23, Zoned MF (Multi-Family Residential) Zoning District.

OTHER ITEMS

- 7. PUBLIC COMMENT- For Items on the Agenda
- 8. PLANNING COMMISSION COMMENT
- 9. ADJOURN

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Chair Lambert called the Regular meeting of the Troy City Planning Commission to order at 7:00 p.m. on September 12, 2023, in the Council Chamber of the Troy City Hall. Chair Lambert and Vice Chair Perakis presented opening remarks relative to the role of the Planning Commission and procedure of tonight's meeting.

1. ROLL CALL

Present:

Toby Buechner
Carlton M. Faison
Tyler Fox
Michael W. Hutson
Tom Krent
David Lambert
Lakshmi Malalahalli
Marianna Perakis
John J. Tagle

Also Present:

Ben Carlisle, Carlisle Wortman & Associates R. Brent Savidant, Community Development Director Julie Quinlan Dufrane, Assistant City Attorney Kathy L. Czarnecki, Recording Secretary

2. <u>APPROVAL OF AGENDA</u>

Resolution # PC-2023-09-051

Moved by: Tagle Support by: Faison

RESOLVED, To approve the Agenda as prepared.

Yes: All present (9)

MOTION CARRIED

3. <u>APPROVAL OF MINUTES</u> – August 22, 2023

Resolution # PC-2023-09-052

Moved by: Fox
Support by: Buechner

RESOLVED, To approve the minutes of the August 22, 2023 Regular meeting as submitted.

Yes: All present (9)

MOTION CARRIED

4. PUBLIC COMMENT – For Items Not on the Agenda

There was no one present who wished to speak.

REZONING REQUEST

5. <u>PUBLIC HEARING – REZONING REQUEST (File Number Z JPLN2023-0016)</u> – Proposed Encore Development Rezoning, East side of Todd, South of Big Beaver (PIN 88-20-29-226-019 and -020), Section 29, From R-1C (One Family Residential) and P (Vehicular Parking) Districts to BB (Big Beaver) Zoning District

Mr. Carlisle reviewed the Encore Development Rezoning Request. He provided a background of the location, surrounding zoning and ownership of each parcel. Mr. Carlisle reported the application is a straight rezoning request with no conditions, is consistent with the Master Plan and would allow all permitted uses in the Big Beaver zoning district.

In summary, Mr. Carlisle said the Planning Commission should consider public testimony during the public hearing, whether the request meets the Rezoning Standards set forth in Section 16.03 C and make a recommendation to the City Council.

There was a brief discussion on the definition, use and intent of the P (Vehicular Parking) zoning district designation.

Jim Butler of PEA Group and Jason Hamama of Encore Development were present.

Mr. Butler offered specific responses to the five (5) Rezoning Standards set forth in the Zoning Ordinance. He said the applicant intends to construct a mixed-use development. Mr. Butler addressed the future uses of the three parcels to the north that are under the same ownership.

Chair Lambert referenced a previous concept plan presented to the Board for a conditional rezoning of the parcels to include the parcel zoned Office (O) that is under different ownership. He said at that time the Board expressed concerns with a straight rezoning because of its potential impact on adjacent properties.

Mr. Hamama said the parcel under different ownership might come into play in the future as a third phase of the development. He said they are back in front of the Board with a straight rezoning application after a delay resulting from working with a potential free-standing tenant.

PUBLIC HEARING OPENED

There was no one present who wished to speak.

PUBLIC HEARING CLOSED

Ms. Perakis shared her views on a conditional rezoning application versus a straight rezoning application as relates to compatibility with adjacent parcels.

There was discussion, some comments related to:

- Range of permitted uses and building forms in the Big Beaver zoning district.
- Compatibility with adjacent uses; no assurance with straight rezoning.
- Application of Site Plan Review Standards during site plan review and approval process.

Resolution # PC-2023-09-053

Moved by: Faison Seconded by: Krent

RESOLVED, That the Planning Commission hereby recommends to the City Council that the R-1C (One Family Residential) and P (Vehicular Parking) to BB (Big Beaver) Rezoning Request, as per Section 16.03 of the City of Troy Zoning Ordinance, located on the East side of Todd, South of Big Beaver (PIN 88-20-29-226-019 and -020), within Section 29, being approximately 1.49 acres in size, be **GRANTED**, for the following reasons:

- 1. The proposed rezoning is consistent with the Master Plan.
- 2. The proposed rezoning does not appear to cause or increase any nonconformity.
- 3. If rezoned the property will be capable of accommodating service and facility loads caused by the use of the development.
- 4. The rezoning does not appear to impact public health, safety, or welfare.
- 5. The rezoning will ensure compatibility with adjacent uses of land.

Discussion on the motion on the floor.

Mr. Faison said the Resolution does not discount the viewpoint of Ms. Perakis and he respects the comments of Mr. Savidant that site plan review standards would be applied to the site plan application in the approval process.

Mr. Buechner said he values Ms. Perakis' viewpoint also and that he is interested to see what type of development is proposed.

Ms. Perakis said that with a conditional rezoning the Planning Commission has more control of the type of development and its compatibility with adjacent parcels.

Chair Lambert referenced previous dialogue on the parcels wherein the Board shared that a conditional rezoning would be preferable.

Vote on the motion on the floor.

Yes: Buehner, Faison, Fox, Hutson, Krent, Tagle

No: Lambert, Malalahalli, Perakis

MOTION CARRIED

OTHER ITEMS

 PUBLIC HEARING – REVISED PRELIMINARY SITE PLAN AND AMENDMENT TO <u>CONDITIONAL REZONING AGREEMENT (JPLN2023-0018)</u> – Proposed Homestead Site Condominiums, East side of Livernois, North of Big Beaver (PIN 88-20-22-301-007, -008 and -009), Section 22, Zoned RT (One Family Attached Residential) Zoning District

Mr. Carlisle reviewed the revised Preliminary Site Plan and Amendment to Conditional Rezoning Agreement for Homestead Site Condominiums. He stated the applicant is seeking to amend the Conditional Rezoning to construct 14 detached homes. Mr. Carlisle presented a comparison of the 2022 plan to 2023 plan, specifically noting the change in unit type, the reduction in the number of units, and a reshaped detention pond. He reported it is a major amendment to the Agreement that is required to come back to the Planning Commission for a recommendation to the City Council.

In summary, Mr. Carlisle asked the Planning Commission to consider public testimony during the public hearing. He asked as part of their deliberations to consider if the plan meets the Rezoning Standards and the Site Plan Review Design Standards and to address site plan items identified in his report dated September 5, 2023.

Jim Eppink of J Eppink Partners Inc. was present to represent Joe Maniaci of Mondrian Properties. Mr. Eppink said key missing items were discovered in the process of marketing homes as proposed in the original plan. He said home buyers are looking for two-car garages, basements for storage and maintenance-free homes with four walls of their own and not an-apartment-style living. Mr. Eppink said the applicant is coming back to the Board with a similar plan as relates to land balance and engineering of the existing floodplain. He noted the homes would be for sale, not rent, there would be public access to the trails and the material of the trails is a combination of asphalt and concrete.

There was discussion, some comments related to:

- Definition of "missing middle" homes.
- Connection and access to the trails; whether public or private, potential to connect to the south.
- Options to accommodate guest parking.
- Alternative locations for overflow parking.
- On-street parking per Fire Department regulations.
- Demographics used in marketing homes.
- Reforestation of trails.
- Maintenance of trails; easement dedicated to City to maintain.
- Material of the trails; asphalt in the rear, concrete in front.

PUBLIC HEARING OPENED

John Phillips, 3302 Frankton; addressed concerns with flooding, loss of wetlands, and connection of the trails to neighboring properties. He said he requested a copy of the site plan from the Planning Department but did not receive it.

PUBLIC HEARING CLOSED

Mr. Savidant apologized to Mr. Phillips that the Planning Department did not respond to his request. He asked Mr. Phillips to meet him at the Planning Department counter after the meeting to give him a copy of the site plan.

Mr. Savidant addressed the concerns expressed by Mr. Phillips with respect to flooding. He stated the proposed development is an opportunity to make improvements to the stormwater flow and flooding issues in the area.

Mr. Savidant cited the Master Plan definition of middle housing.

There was discussion:

- How the original Conditional Rezoning Agreement relates to the proposed amendment.
- Intent of the Resolution templates prepared by the administration.
- How the site plan issues identified in the Planning Consultant report relates to the proposed amendment.
- Applicant's affirmation to research options for guest parking.
- Conditions offered by applicant in relation to the proposed application amendment.

Mr. Carlisle confirmed the plan meets the parking requirements of the Zoning Ordinance.

Mr. Fox said he does not support the application because of the demographics used in marketing the homes. He would like to see the demographics include a younger and/or a hybrid of generations.

Resolution # PC-2023-09-054

Moved by: Perakis
Seconded by: Buechner

RESOLVED, That the Planning Commission hereby recommends to the City Council that the proposed request to amend the Conditional Rezoning Agreement and Site Plan, located on the East side of Livernois, North of Big Beaver, within Section 22, being approximately 9.5 acres in size, be **GRANTED**, for the following reasons:

- 1. The request complies with the Master Plan.
- 2. The conditions offered by the applicant reasonably protect the adjacent properties.
- 3. The rezoning would be compatible with surrounding zoning and land use.
- 4. The site can be adequately served with municipal water and sewer.

BE IT FURTHER RESOLVED, That the Planning Commission recommends the following site plan design considerations:

- 1. Provide Conditional Rezoning Agreement prior to the City Council consideration.
- 2. Explore additional guest parking after determining with the Fire Department whether parking is permitted on both sides of the road.

Discussion on the motion on the floor.

Chair Lambert said his concerns with the original plan was that it was not entirely compatible with the neighbors to the south and that he would vote in favor of the amendment before the Board this evening.

Vote on the motion on the floor.

Yes: Buechner, Faison, Hutson, Krent, Lambert, Malalahalli, Perakis, Tagle

No: Fox

MOTION CARRIED

7. PUBLIC COMMENT – For Items on the Agenda

There was no one present who wished to speak.

8. PLANNING COMMISSION COMMENT

There were general Planning Commission comments, some related to:

- Update on Downtown Development Authority (DDA) district landscape project.
- Format of resolution(s) prepared by administration.
- Distribution of informational articles among Planning Commission.
- Presentation by Mr. Savidant at the Oakland County Planners Gathering.

ADJOURN

Respectfully submitted.

The Regular meeting of the Planning Commission adjourned at 8:40 p.m.

,	
David Lambert, Chair	
Kathy L. Czarnecki, Recording Secretary	

ITEM #5

DATE: September 21, 2023

TO: Planning Commission

FROM: R. Brent Savidant, Community Development Director

SUBJECT: PUBLIC HEARING - SPECIAL USE APPROVAL AND PRELIMINARY SITE PLAN

<u>REVIEW (SU JPLN2023-0019)</u> - Proposed Clean Express Car Wash, West side of John R, North of Fourteen Mile (PIN 88-20-35-401-001), Section 35, Zoned GB

(General Business) District

The petitioner Mannik and Smith Group submitted the above referenced Special Use Approval and Preliminary Site Plan Approval application for a new full-service car wash within an underutilized parking lot at Oakland Mall.

Vehicle auto washes are permitted in the GB district, subject to special use approval.

The attached report prepared by Carlisle/Wortman Associates, Inc. (CWA), the City's Planning Consultant, summarizes the application. CWA prepared the report with input from various City departments including Planning, Engineering, Public Works and Fire. City Management supports the findings of fact contained in the report and recommends approval of the project, as noted.

Attachments:

- 1. Maps
- 2. Report prepared by Carlisle/Wortman Associates, Inc.
- 3. Special use application

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PROPOSED RESOLUTION

<u>PUBLIC HEARING - SPECIAL USE APPROVAL AND PRELIMINARY SITE PLAN</u>
<u>REVIEW (SU JPLN2023-0002)</u> - Proposed Clean Express Car Wash, West side of John R, North of Fourteen Mile (PIN 88-20-35-401-001), Section 35, Zoned GB (General Business) District

Resolution # PC-2023-09-

Moved by: Seconded by:

RESOLVED, That Special Use Approval and Preliminary Site Plan Approval for the proposed Clean Express Car Wash, West side of John R, North of Fourteen Mile (PIN 88-20-35-401-001), Section 35, Currently Zoned GB (General Business) District, be (granted, subject to the following conditions):

- 1. Provide bicycle parking.
- 2. Provide 8-foot sidewalk required along John R Road.
- 3. Relocate dumpster.
- 4. Provide sidewalk across the north side of lot, to and from John R Road.
- 5. Add two (2) parking lot trees internal to the parking lot along the western parking area, and one (1) tree along the eastern parking lot area.
- 6. Stamp plan by licensed landscape architect.


) or
(denied, for the following reasons:) or
(postponed, for the following reasons:)
Yes: No:	
Absent:	

MOTION CARRIED / FAILED

G:\SPECIAL USE\SU JPLN2023-0002 KROGER D-463 FUEL STATION\Proposed Resolution 2023 05 09.doc

TROY

GIS Online

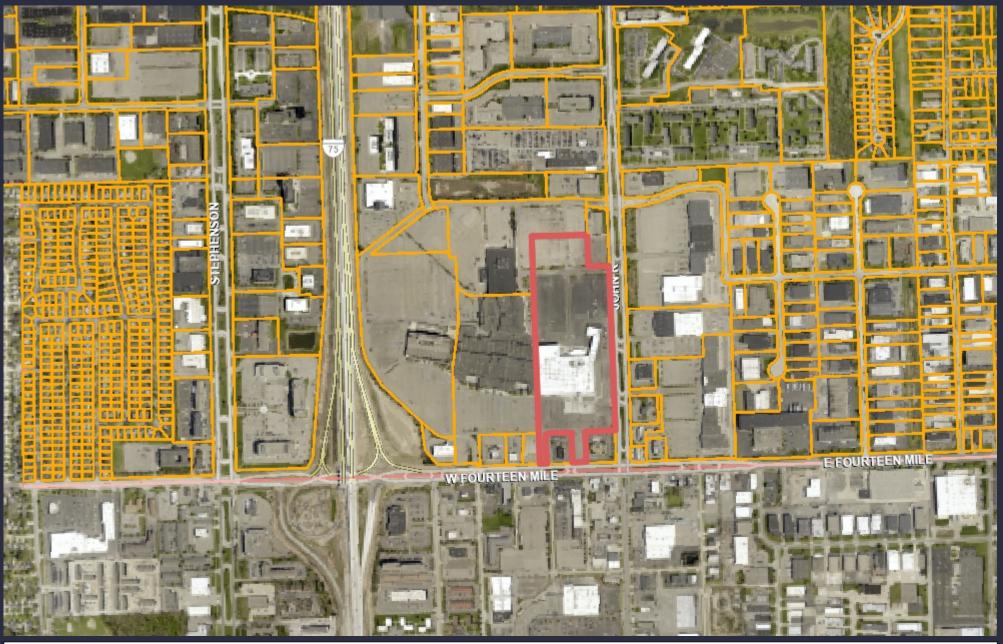

2,306 Feet

Note: The information provided by this application has been compiled from recorded deeds, plats, tax maps, surveys, and other public records and data. It is not a legally recorded map survey. Users of this data are hereby notified that the source information represented should be consulted for verification.

TROY

GIS Online



2,306 0 1,153 2,306Feet



Note: The information provided by this application has been compiled from recorded deeds, plats, tax maps, surveys, and other public records and data. It is not a legally recorded map survey. Users of this data are hereby notified that the source information represented should be consulted for verification.



117 NORTH FIRST STREET SUITE 70 ANN ARBOR, MI 48104 734.662.2200 734.662.1935 FAX

Date: September 20, 2023

Preliminary Site Plan For City of Troy, Michigan

Applicant: Mannik and Smith Group

Project Name: Clean Express Car Wash

Location: Oakland Mall (outlot adjacent to John R)

Zoning: GB, General Business

Action Requested: Preliminary Site Plan Review

SITE/PROJECT DESCRIPTION/CURRENT USE

The applicant has submitted an application for a new car wash to be located in an outlot of Oakland Mall. The proposed outlot is adjacent to John R and in front of the At Home store in the mall. The proposed carwash is 3,600 sq/ft and includes 28 vacuum stations. The parking and vacuum stations are located between the building and the At Home store. The area proposed for development is currently parking.

The site is zoned GB, General Business. A carwash is a special use in the GB district.



NATURAL FEATURES

The site has been graded and developed for use as a parking lot. There are no natural features in the area proposed for development.

Items to be addressed: None.

SITE ARRANGEMENT

The proposed outlot is adjacent to John R and in front of the At Home store in the mall. The proposed carwash is 3,600 sq/ft and includes 28 vacuum stations. The parking and vacuum stations are located between the building and parking for the At Home store. The area proposed for development is currently parking.

Items to be addressed: None.

AREA, WIDTH, HEIGHT, SETBACKS

Section 4.14 establishes the dimensional requirements for GB, General Business District. The requirements of GB Zoning District and the proposed dimensions are shown in the following table.

	Required	Provided	Compliance
Front (John R)	10-feet	10.55-feet	Complies
Side	20-feet /40-feet combined	Over 20-feet and 40- feet combined	Complies
Rear	30-foot minimum setback	Over 30-feet	Complies
Building Height	uilding Height 3-stories, 40 feet in height.		Complies
Parking Location	NO more than 50% can be in front yard	No more than 50% of parking is located in front yard	Complies

Items to be addressed: None

PARKING

Section 13.06.G of the Zoning Ordinance requires:

	Required	Provided	Compliance
Car Wash	2 spaces, plus 12 stacking spaces per bay for a semi- or fully- automatic wash, 1 stacking space per bay for a self-serve wash, plus 1 space per 1 employee on the largest typical shift	26 vacuum spaces and 3 non-vacuum spaces. Over 12 stacking spaces.	Complies
Barrier Free	1	1	Complies
Bicycle Parking	2	0	Does not comply
Loading	0	0	

The applicant is not providing any bicycle parking.

Items to be Addressed: Provide bicycle parking.


SITE ACCESS AND CIRCULATION

Internally, the site is curbed to separate the use from general mall parking and circulation.

There are multiple points of access to the carwash area of the site via the exiting Oakland Mall parking lot. Direct access is from John R Road. There is a significant amount of traffic and circulation movement in the area of the direct entrance to the carwash and the access off John R Road. The Planning Commission should discuss with the applicant site circulation, especially around location of car wash entrance.

The City Engineer has reviewed the plan and notes the following:

- 8 -foot sidewalk required along John R Road
- Relocate dumpster, access from drive aisle not allowed.
- Provide sidewalk across the north side of lot, to and from John R

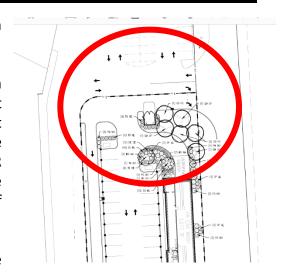

There is a significant amount of traffic and circulation movement in the area of the direct entrance to the carwash and the access of John R

Items to be addressed: 1). The Planning Commission should discuss with the applicant site circulation, especially around location of parking lot entrance; 2). Provide 8-foot sidewalk required along John R Road; 3). Relocate dumpster, access from drive aisle not allowed; and 4). Provide sidewalk across the north side of lot, to and from John R Road.

LANDSCAPING

A landscaping plan has been provided on Sheet L101. The following table discusses the development's compliance with the landscape requirements set forth in Section 13.02.

	Required:		Compliance:	
Greenbelt Planting				
John R: 1 tree every 30 feet	328 / 30 = 11	18 trees	Complies	
Parking Lot Landscaping:				
1 tree per 8 parking spaces	29 / 10 = 4 trees	4 trees in perimeter of parking area.	Complies with Planning Commission consideration	
Overall				
Site landscaping: A minimum of twenty percent (20%) of the site area shall be comprised of landscape	20% = 8,540 sq/ft	Over 20% = 10,332 sq/ft	Complies	

material. Up to twenty-five percent (25%) of the required landscape area may be	
brink, stone, pavers, or other public plaza	
elements, but shall not include any parking	
area or required sidewalks.	

We note that there is a long stretch of parking (with vacuums) that does not have any parking lot landscaping. We recommend that the applicant provide two (2) parking lot trees internal to the parking lot along the western parking area, and one (1) tree along the eastern parking lot area. Parking lot trees in the western parking area will also breakup and help distinguish and define the property and use boundaries of the carwash.

It will require the loss of at least three (3) parking/vacuum space area. Landscape Plan was not stamped by a licensed landscape architect.

Items to be Addressed: 1). Add two (2) parking lot trees internal to the parking lot along the western parking area, and one (1) tree along the eastern parking lot area; and 2). Stamp plan by licensed landscape architect.

PHOTOMETRICS

The applicant proposes three (3) parking lot pole lights and six (6) building lights. Photometric and fixtures comply with ordinance requirements.

Items to be Addressed: None

FLOOR PLAN AND ELEVATIONS

Floor plans and elevations have been provided. The primary material is brick. A rendering shows a color scheme of white brick, natural brick, and green vacuums. The proposed canopy over the pay area is red. The applicant should describe how the color scheme of the canopy matches the color scheme of the building.

The applicant has provided a rendering of a Clean Express carwash, but we note it's not site specific. The applicant should confirm if they propose the general material use and color scheme as shown in the rendering. To better understand architectural details and site context, the applicant should provide a 3-D model of the site in context of the malls buildings and John R.

Items to be Addressed: 1). Applicant should confirm if they propose the general material use and color scheme as shown in the rendering; and 2). Provide site specific 3-D model.

SPECIAL USE STANDARDS

For any special use, according to Section 9.02.D, the Planning Commission shall "...review the request, supplementary materials either in support or opposition thereto, as well as the Planning Department's report, at a Public Hearing established for that purpose, and shall either grant or deny the request, table action on the request, or grant the request subject to specific conditions."

Section 9.03 states that before approving any requests for Special Use Approval, the Planning Commission shall consider:

- 1. Compatibility with Adjacent Uses.
- 2. Compatibility with the Master Plan.
- 3. Traffic Impact.
- 4. Impact on Public Services.
- 5. Compliance with Zoning Ordinance Standards.
- 6. Impact on the Overall Environment.
- 7. Special Use Approval Specific Requirements.

SITE PLAN REVIEW STANDARDS

The Site Plan review standards provide the Planning Commission with direction when reviewing the proposed site plan and design features of this development.

Section 8.06 outlines Site Plan Review Design Standards.

<u>Section 8.06 outlines Site Plan Review Design Standards.</u>

- 1. Development shall ensure compatibility to existing commercial districts and provide a transition between land uses.
 - a. Building design shall enhance the character of the surrounding area in relation to building and parking placement, landscape and streetscape features, and architectural design.
 - b. Street fronts shall provide a variety of architectural expression that is appropriate in its context and prevents monotony.
 - c. Building design shall achieve a compatible transition between areas with different height, massing, scale, and architectural style.
- 2. Development shall incorporate the recognized best architectural building design practices.
 - a. Foster a lasting impact on the community through the provision of high quality design, construction, and detailing.
 - b. Provide high quality, durable materials, such as but not limited to stone, brick, glass, and metal. E.I.F.S. or material equivalent shall only be used as an accent material.
 - c. Develop buildings with creativity that includes balanced compositions and forms.

- d. Design roofs that are appropriate to the architectural style of the building and create an appropriate visual exterior mass of the building given the context of the site.
- e. For commercial buildings, incorporate clearly defined, highly visible customer entrances using features such as canopies, porticos, arcades, arches, wing walls, ground plane elements, and/or landscape planters.
- f. Include community amenities that add value to the development such as patio/ seating areas, water features, art work or sculpture, clock towers, pedestrian plazas with park benches or other features located in areas accessible to the public.
- 3. Enhance the character, environment and safety for pedestrians and motorists.
 - a. Provide elements that define the street and the pedestrian realm.
 - b. Create a connection between the public right of way and ground floor activities.
 - c. Create a safe environment by employing design features to reduce vehicular and pedestrian conflict, while not sacrificing design excellence.
 - d. Enhance the pedestrian realm by framing the sidewalk area with trees, awnings, and other features.
 - e. Improve safety for pedestrians through site design measures.

SUMMARY

The Planning Commission is asked to hold a public hearing and consider public testimony. As part of the deliberations, the Planning Commission should discuss the following:

- Site circulation, especially around location of parking lot entrance and consider
- Architecture, material use, and color scheme
- If the plan meets the special use and site plan design standards


If the Planning Commission approves the special use and site plan, the following site plan items should be addressed by the applicant:

- 1. Provide bicycle parking.
- 2. Provide 8-foot sidewalk required along John R Road.
- 3. Relocate dumpster, access from drive aisle not allowed.
- 4. Provide sidewalk across the north side of lot, to and from John R Road.
- 5. Add two (2) parking lot trees internal to the parking lot along the western parking area, and one (1) tree along the eastern parking lot area.
- 6. Stamp plan by licensed landscape architect.
- 7. Provide site specific 3-D model.

Clean Express Car Wash September 20, 2023

Sincerely,

CARLISLE/WORTMAN ASSOC., INC. Benjamin R. Carlisle, LEED AP, AICP

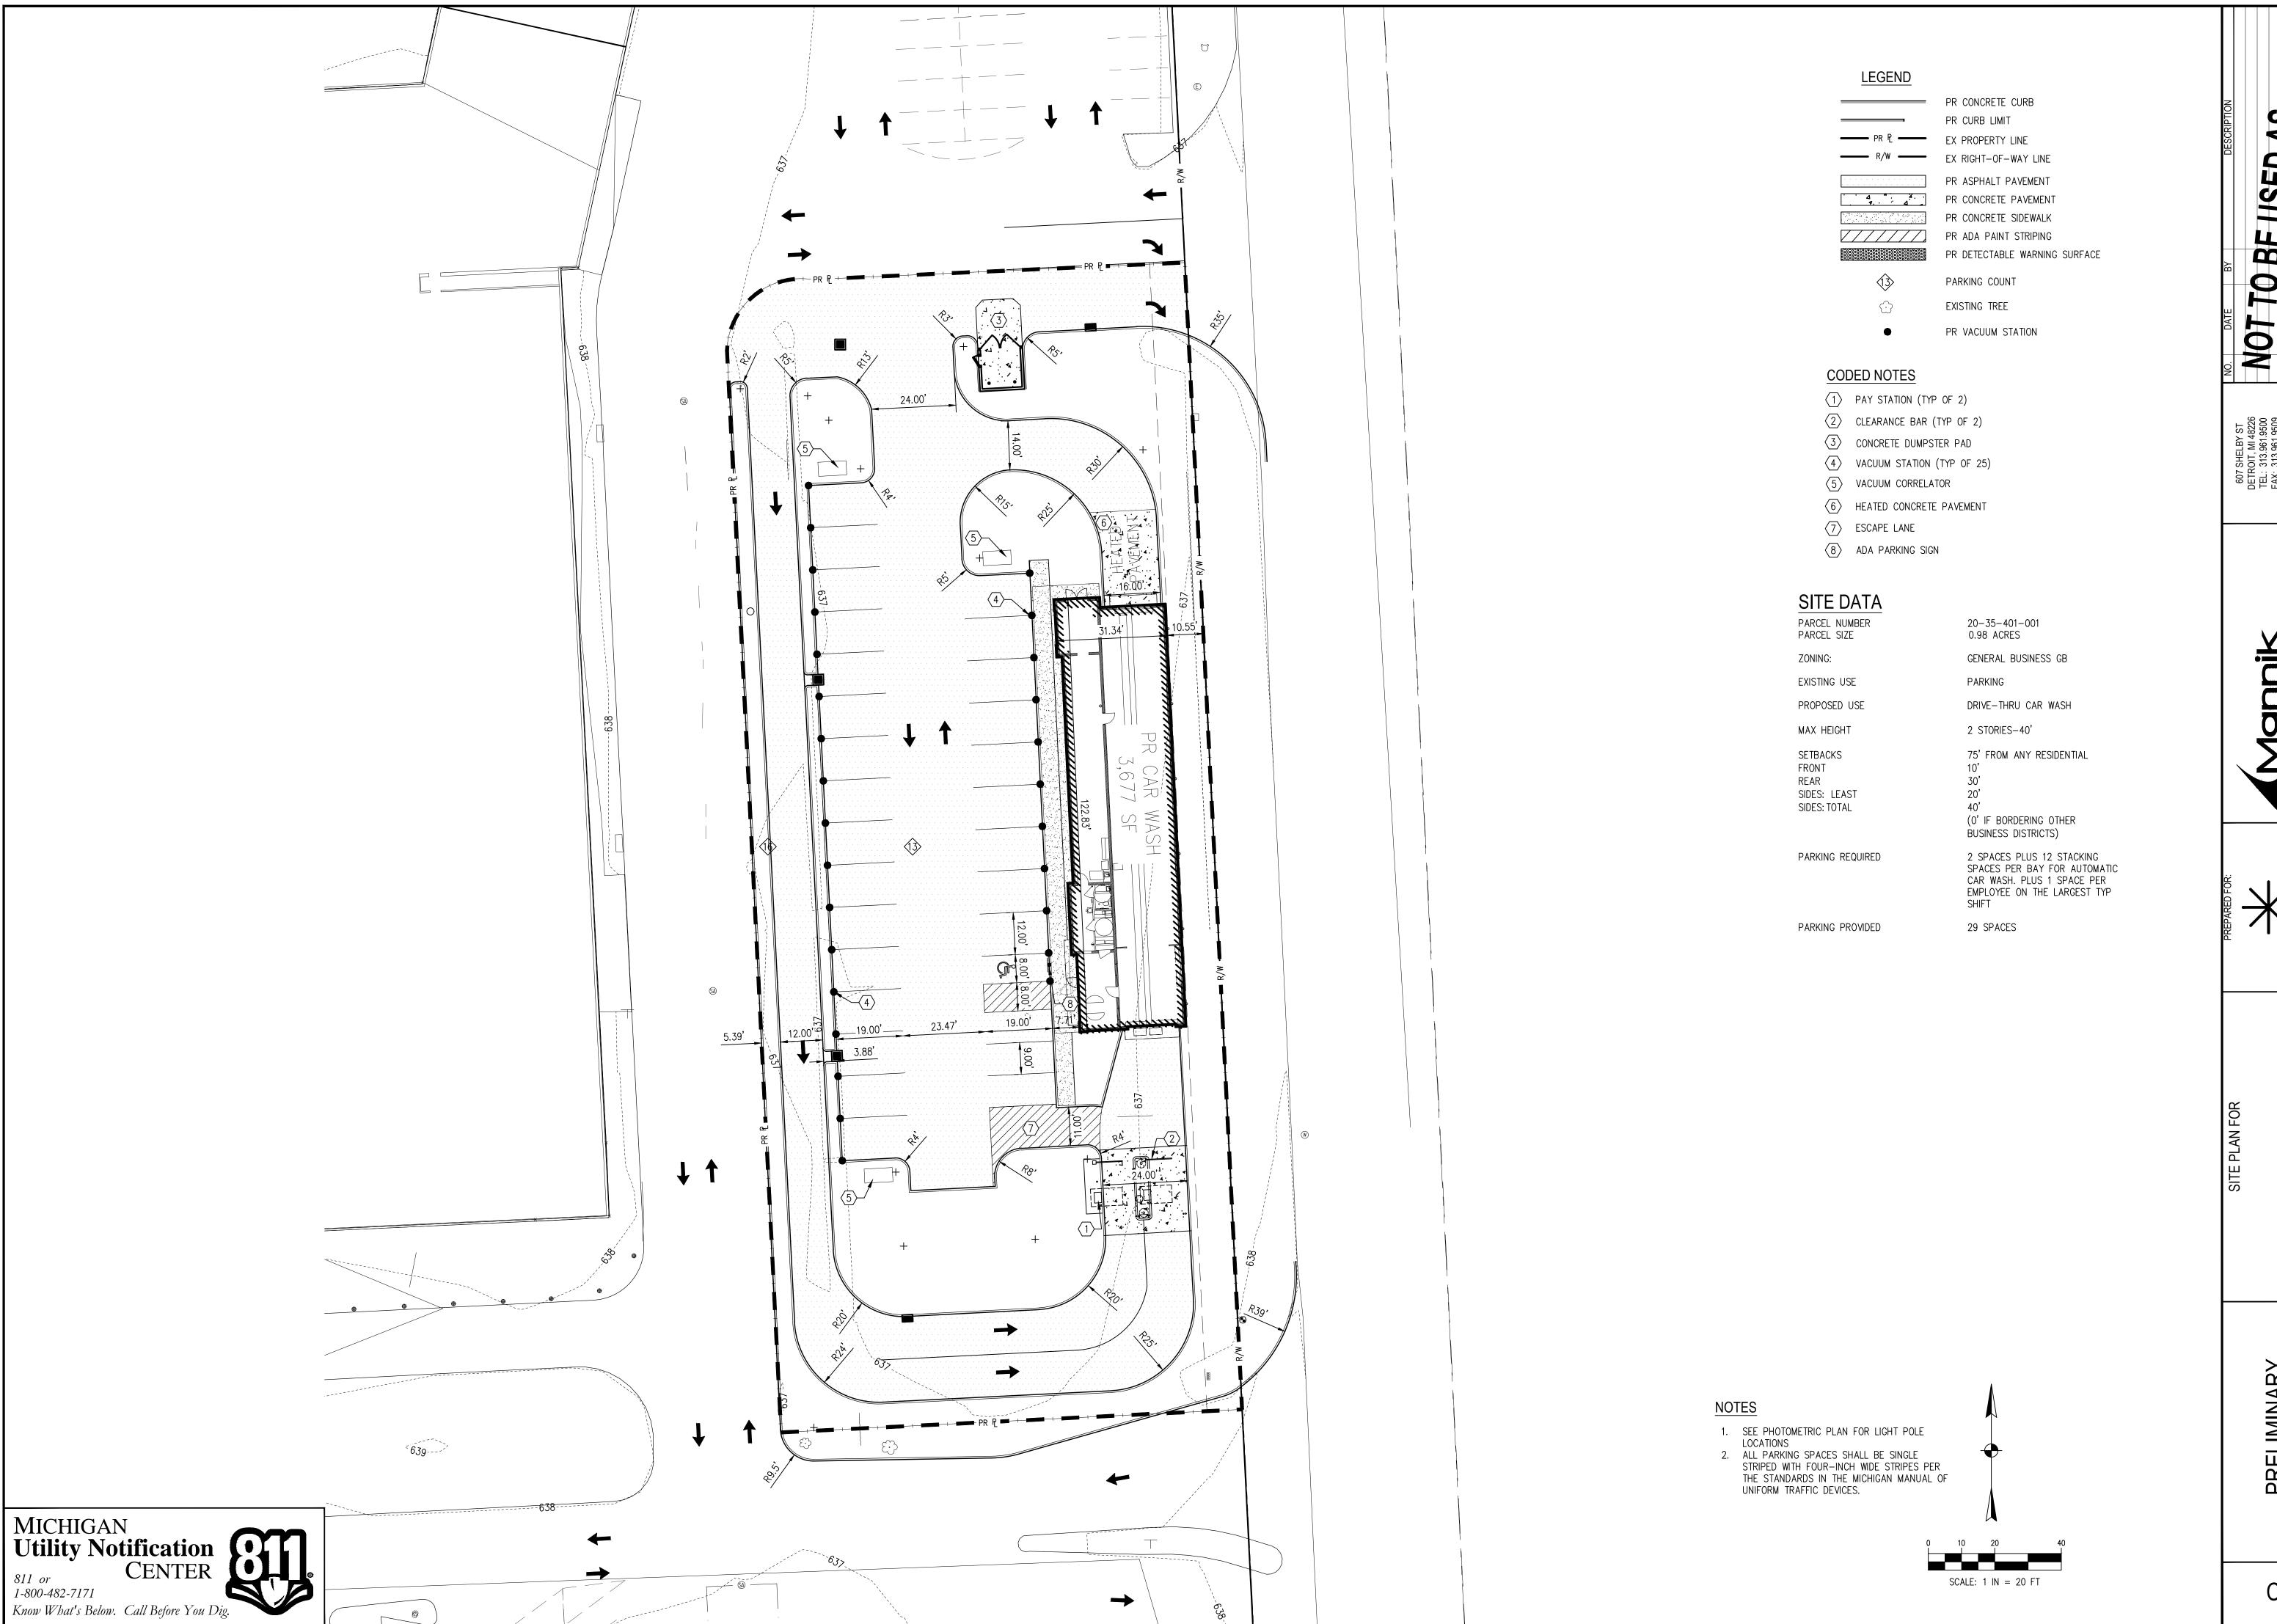



TO BE USED AS

CONSTRUCTION DRAWINGS

PRELIMINARY SITE PLAN

C200

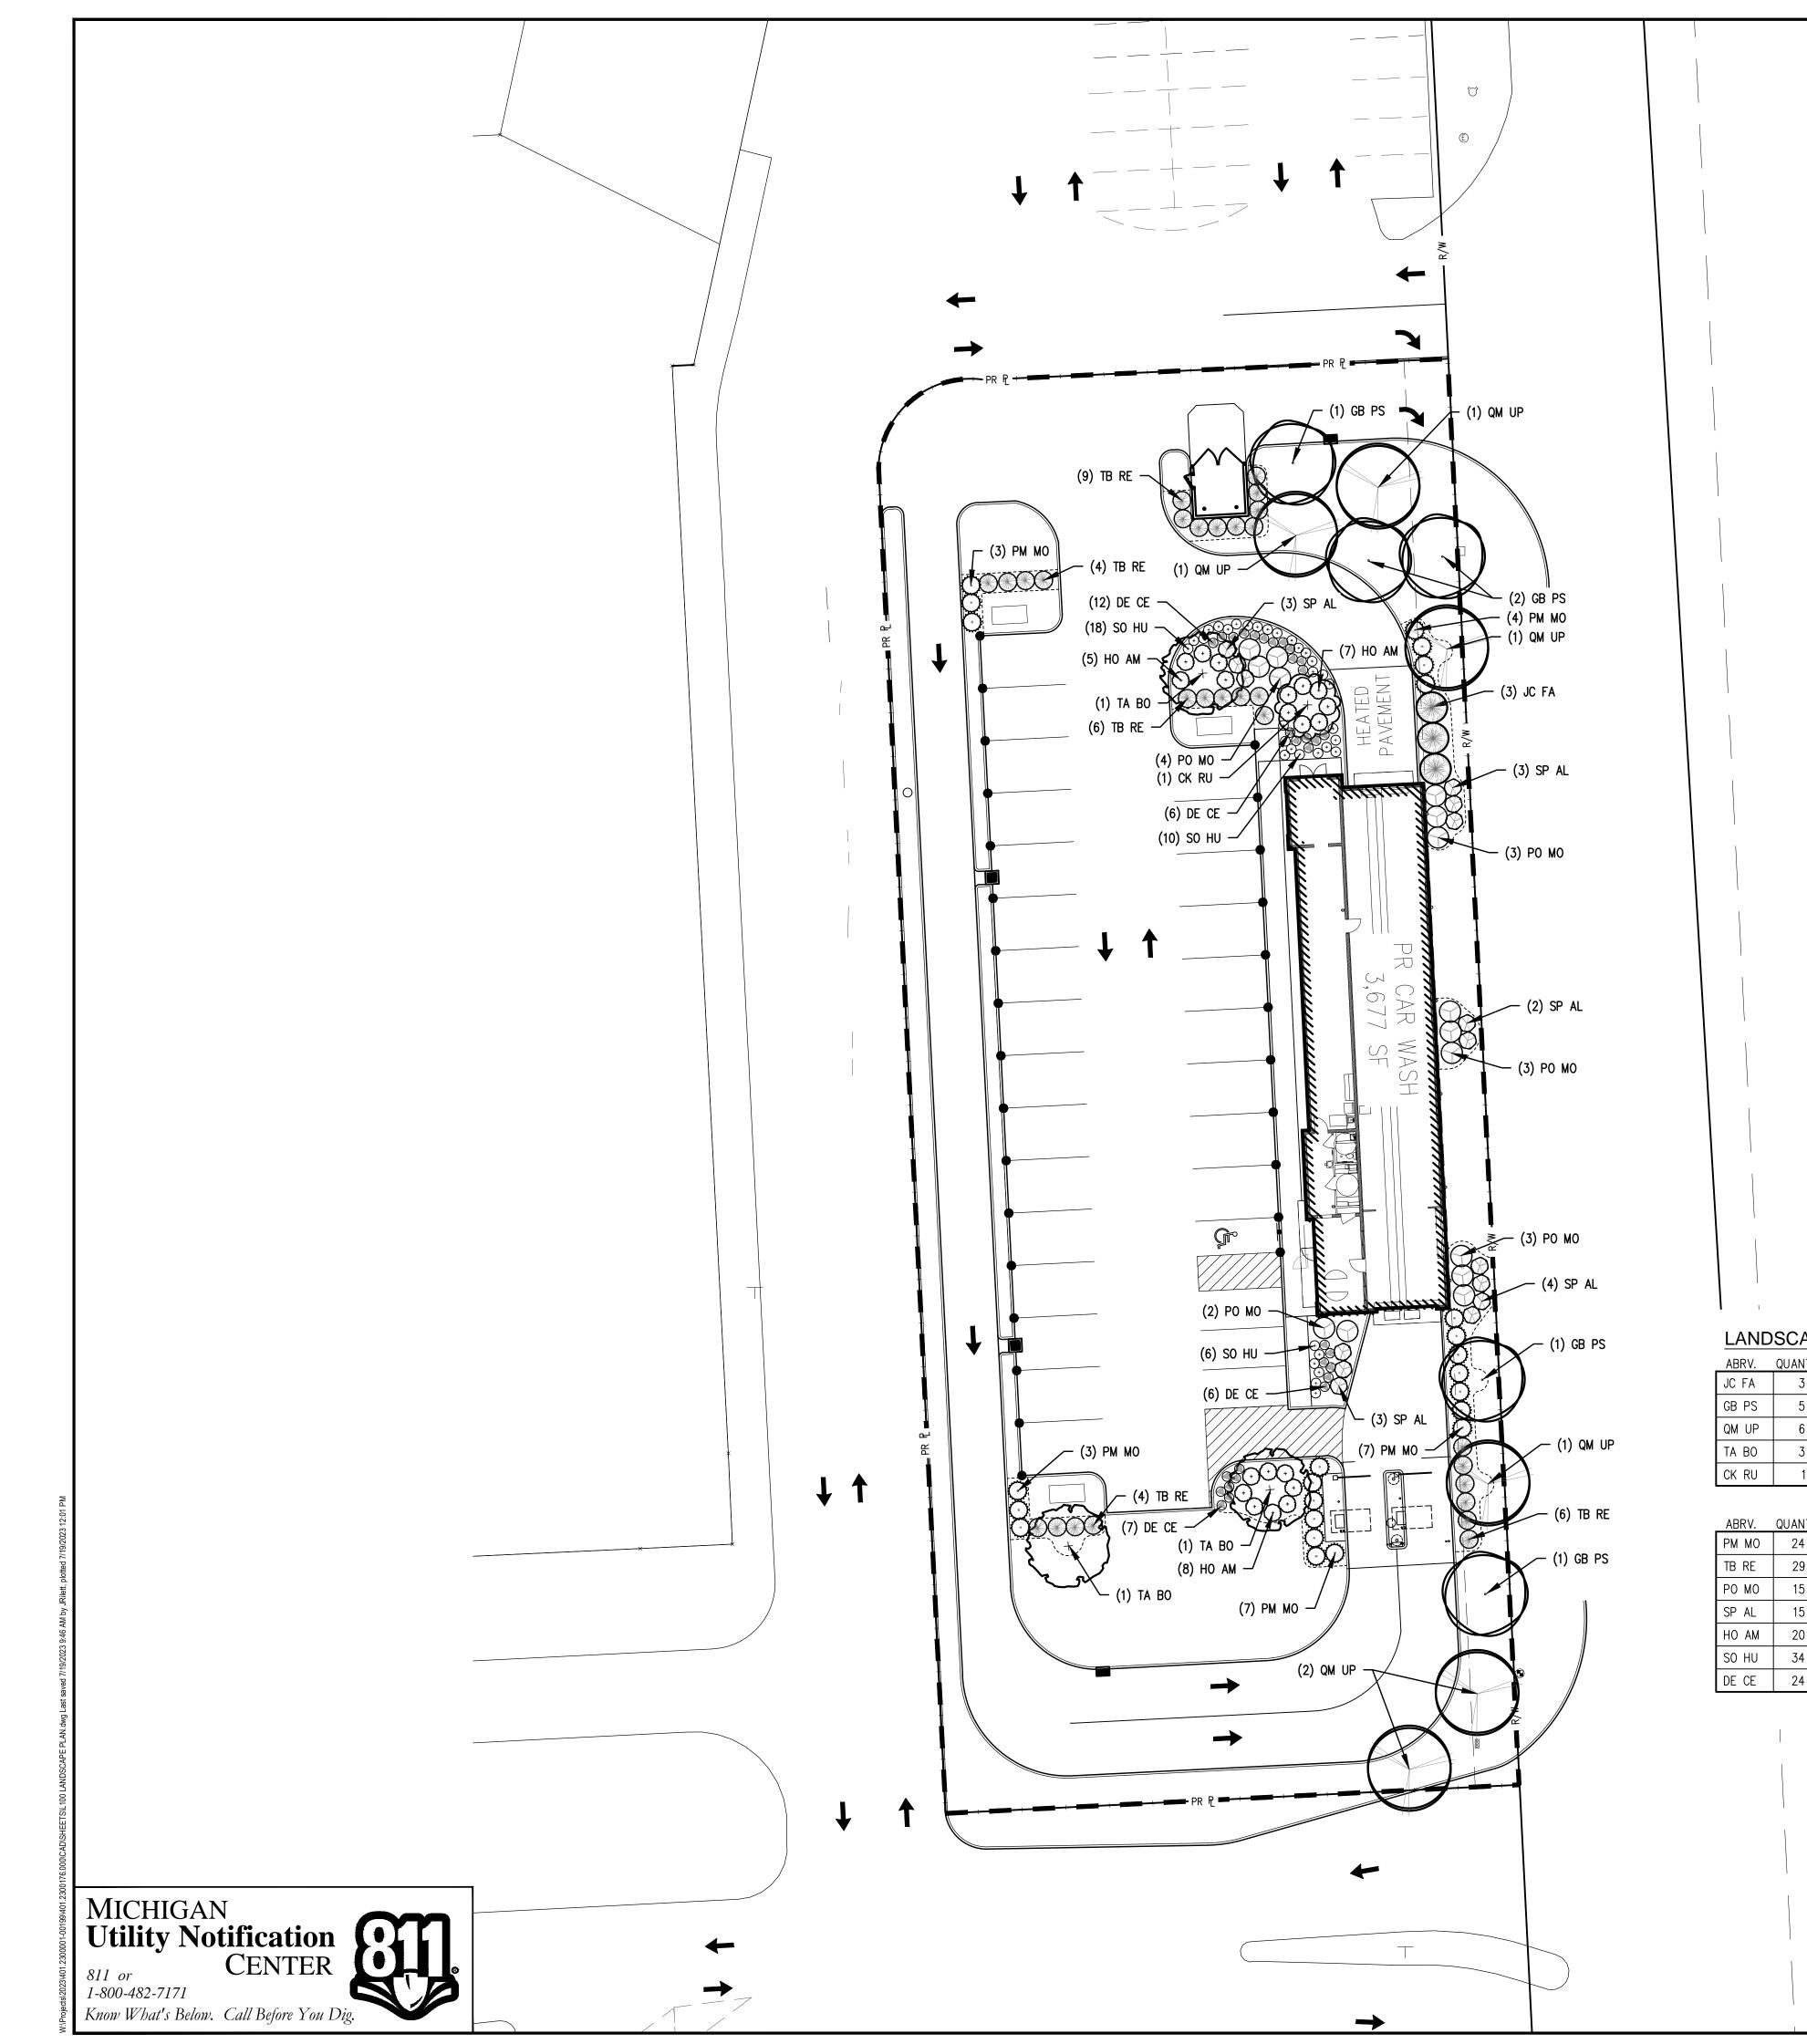

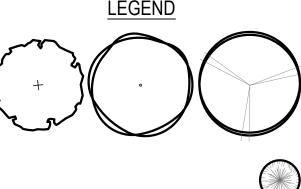

PR DECIDUOUS TREE

PR EVERGREEN TREE

PR EVERGREEN SHRUB

PR DECIDUOUS FLOWERING SHRUB

RUCTION DRAWINGS

PR FLOWERING PERENNIAL

PR ORNAMENTAL GRASS

PR MULCH PLANTING BED LINE

LANDSCAPE CODE REQUIREMENTS


REQ	UIRED:	PROVIDED:
CITY	OF TROY, MI ZONING ORDINANCE, ARTICLE 13:	
1.	THERE SHALL BE A MINIMUM OF ONE (1) TREE FOR EVERY EIGHT (8) PARKING SPACES. 29 PARKING SPACES / 8 = 3 TREES REQUIRED.	3 TREES PROVIDED.
2.	PARKING LOTS THAT FRONT ON A PUBLIC ROADWAY SHALL BE SCREENED BY A LANDSCAPED BERM AT LEAST THREE (3) FEET IN HEIGHT ALONG THE PERIMETER OF THE ROAD RIGHT OF WAY. ALTERNATIVE LANDSCAPE PLANTINGS OR A SOLID WALL THAT DOES NOT EXCEED THREE (3) FEET IN HEIGHT MAY BE APPROVED, WHERE IT IS FOUND THAT SPACE LIMITATIONS OR VISIBILITY FOR VEHICULAR CIRCULATION PREVENT CONSTRUCTION OF A LANDSCAPE BERM.	EVERGREEN SHRUBS PROVIDED TO SCREEN BETWEEN PARKING LOT AND JOHN R RD.
3.	A GREENBELT SHALL BE PROVIDED ALONG ALL PUBLIC STREETS UPON WHICH A SITE HAS FRONTAGE. THE GREENBELT SHALL BE LANDSCAPED WITH A MINIMUM OF ONE (1) DECIDUOUS TREE FOR EVERY THIRTY (30) LINEAL FEET, OR FRACTION THEREOF, OF FRONTAGE ABUTTING A PUBLIC ROAD RIGHT—OF—WAY. 326 LINEAL FEET OF STREET FRONTAGE / 30 = 11 TREES REQUIRED.	11 TREES PROVIDED.
4.	A MINIMUM OF TWENTY PERCENT (20%) OF THE SITE AREA SHALL BE COMPRISED OF LANDSCAPE MATERIAL. 42,697 SF OF SITE AREA X 20% = 8,540 SF OF LANDSCAPED AREA REQUIRED.	10,332 SF OF LANDSCAPED AREA.
5.	SITE AREA LANDSCAPING SHALL BE PROVIDED TO SCREEN POTENTIALLY OBJECTIONABLE SITE FEATURES SUCH AS, BUT NOT LIMITED TO, RETENTION/DETENTION BASINS, LOADING AREAS, AND TRASH AREAS.	EVERGREEN SHRUBS PROVIDED TO SCREEN DUMPSTER AND PAY MACHINES.


LANDSCAPE PLANT LIST

ABRV.	QUANTITY	SCIENTIFIC NAME	COMMON NAME	SIZE	REMARKS	TYPE
IC FA	3	JUNIPERUS CHINENSIS 'FAIRVIEW'	FAIRVIEW JUNIPER	5' HEIGHT	B&B	EVERGREEN TREE
B PS	5	GINKGO BILOBA 'PRINCETON SENTRY'	PRINCETON SENTRY GINKGO	2.5" CALIPER	B&B	DECIDUOUS TREE
QM UP	6	QUERCUS MACROCARPA 'JFS-KW3'	URBAN PINNACLE BUR OAK	2.5" CALIPER	B&B	DECIDUOUS TREE
ГА ВО	3	TILIA AMERICANA 'BOULEVARD'	BOULEVARD AMERICAN LINDEN	2.5" CALIPER	B&B	DECIDUOUS TREE
CK RU	1	CORNUS KOUSA 'RUTPINK'	SCARLET FIRE CHINESE DOGWOOD	2" CALIPER	B&B	ORNAMENTAL TREE

ABRV.	QUANTITY	SCIENTIFIC NAME	COMMON NAME	SIZE	REMARKS	TYPE
PM MO	24	PINUS MUGO 'MOPS'	DWARF MUGO PINE	2' SPREAD	CONTAINER	EVERGREEN SHRUB
TB RE	29	TAXUS BACCATA 'REPANDENS'	REPANDENS YEW	2' SPREAD	CONTAINER	EVERGREEN SHRUB
РО МО	15	PHYSOCARPUS OPULIFOLIUS 'MONLO'	DIABOLO NINEBARK	3' HEIGHT	CONTAINER	DECIDUOUS SHRUB
SP AL	15	SPIRAEA ALBA	WHITE MEADOWSWEET	2' SPREAD	CONTAINER	DECIDUOUS SHRUB
но ам	20	HOSTA 'AUGUST MOON'	AUGUST MOON HOSTA	2 GALLON	CONTAINER	FLOWERING PERENNIAL
SO HU	34	STACHYS OFFICINALIS 'HUMMELO'	BETONY	2 GALLON	CONTAINER	FLOWERING PERENNIAL
DE CE	24	DESCHAMPSIA CESPITOSA	TUFTED FOUNTAIN GRASS	2 GALLON	CONTAINER	ORNAMENTAL GRASS


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FLOOR PLAN

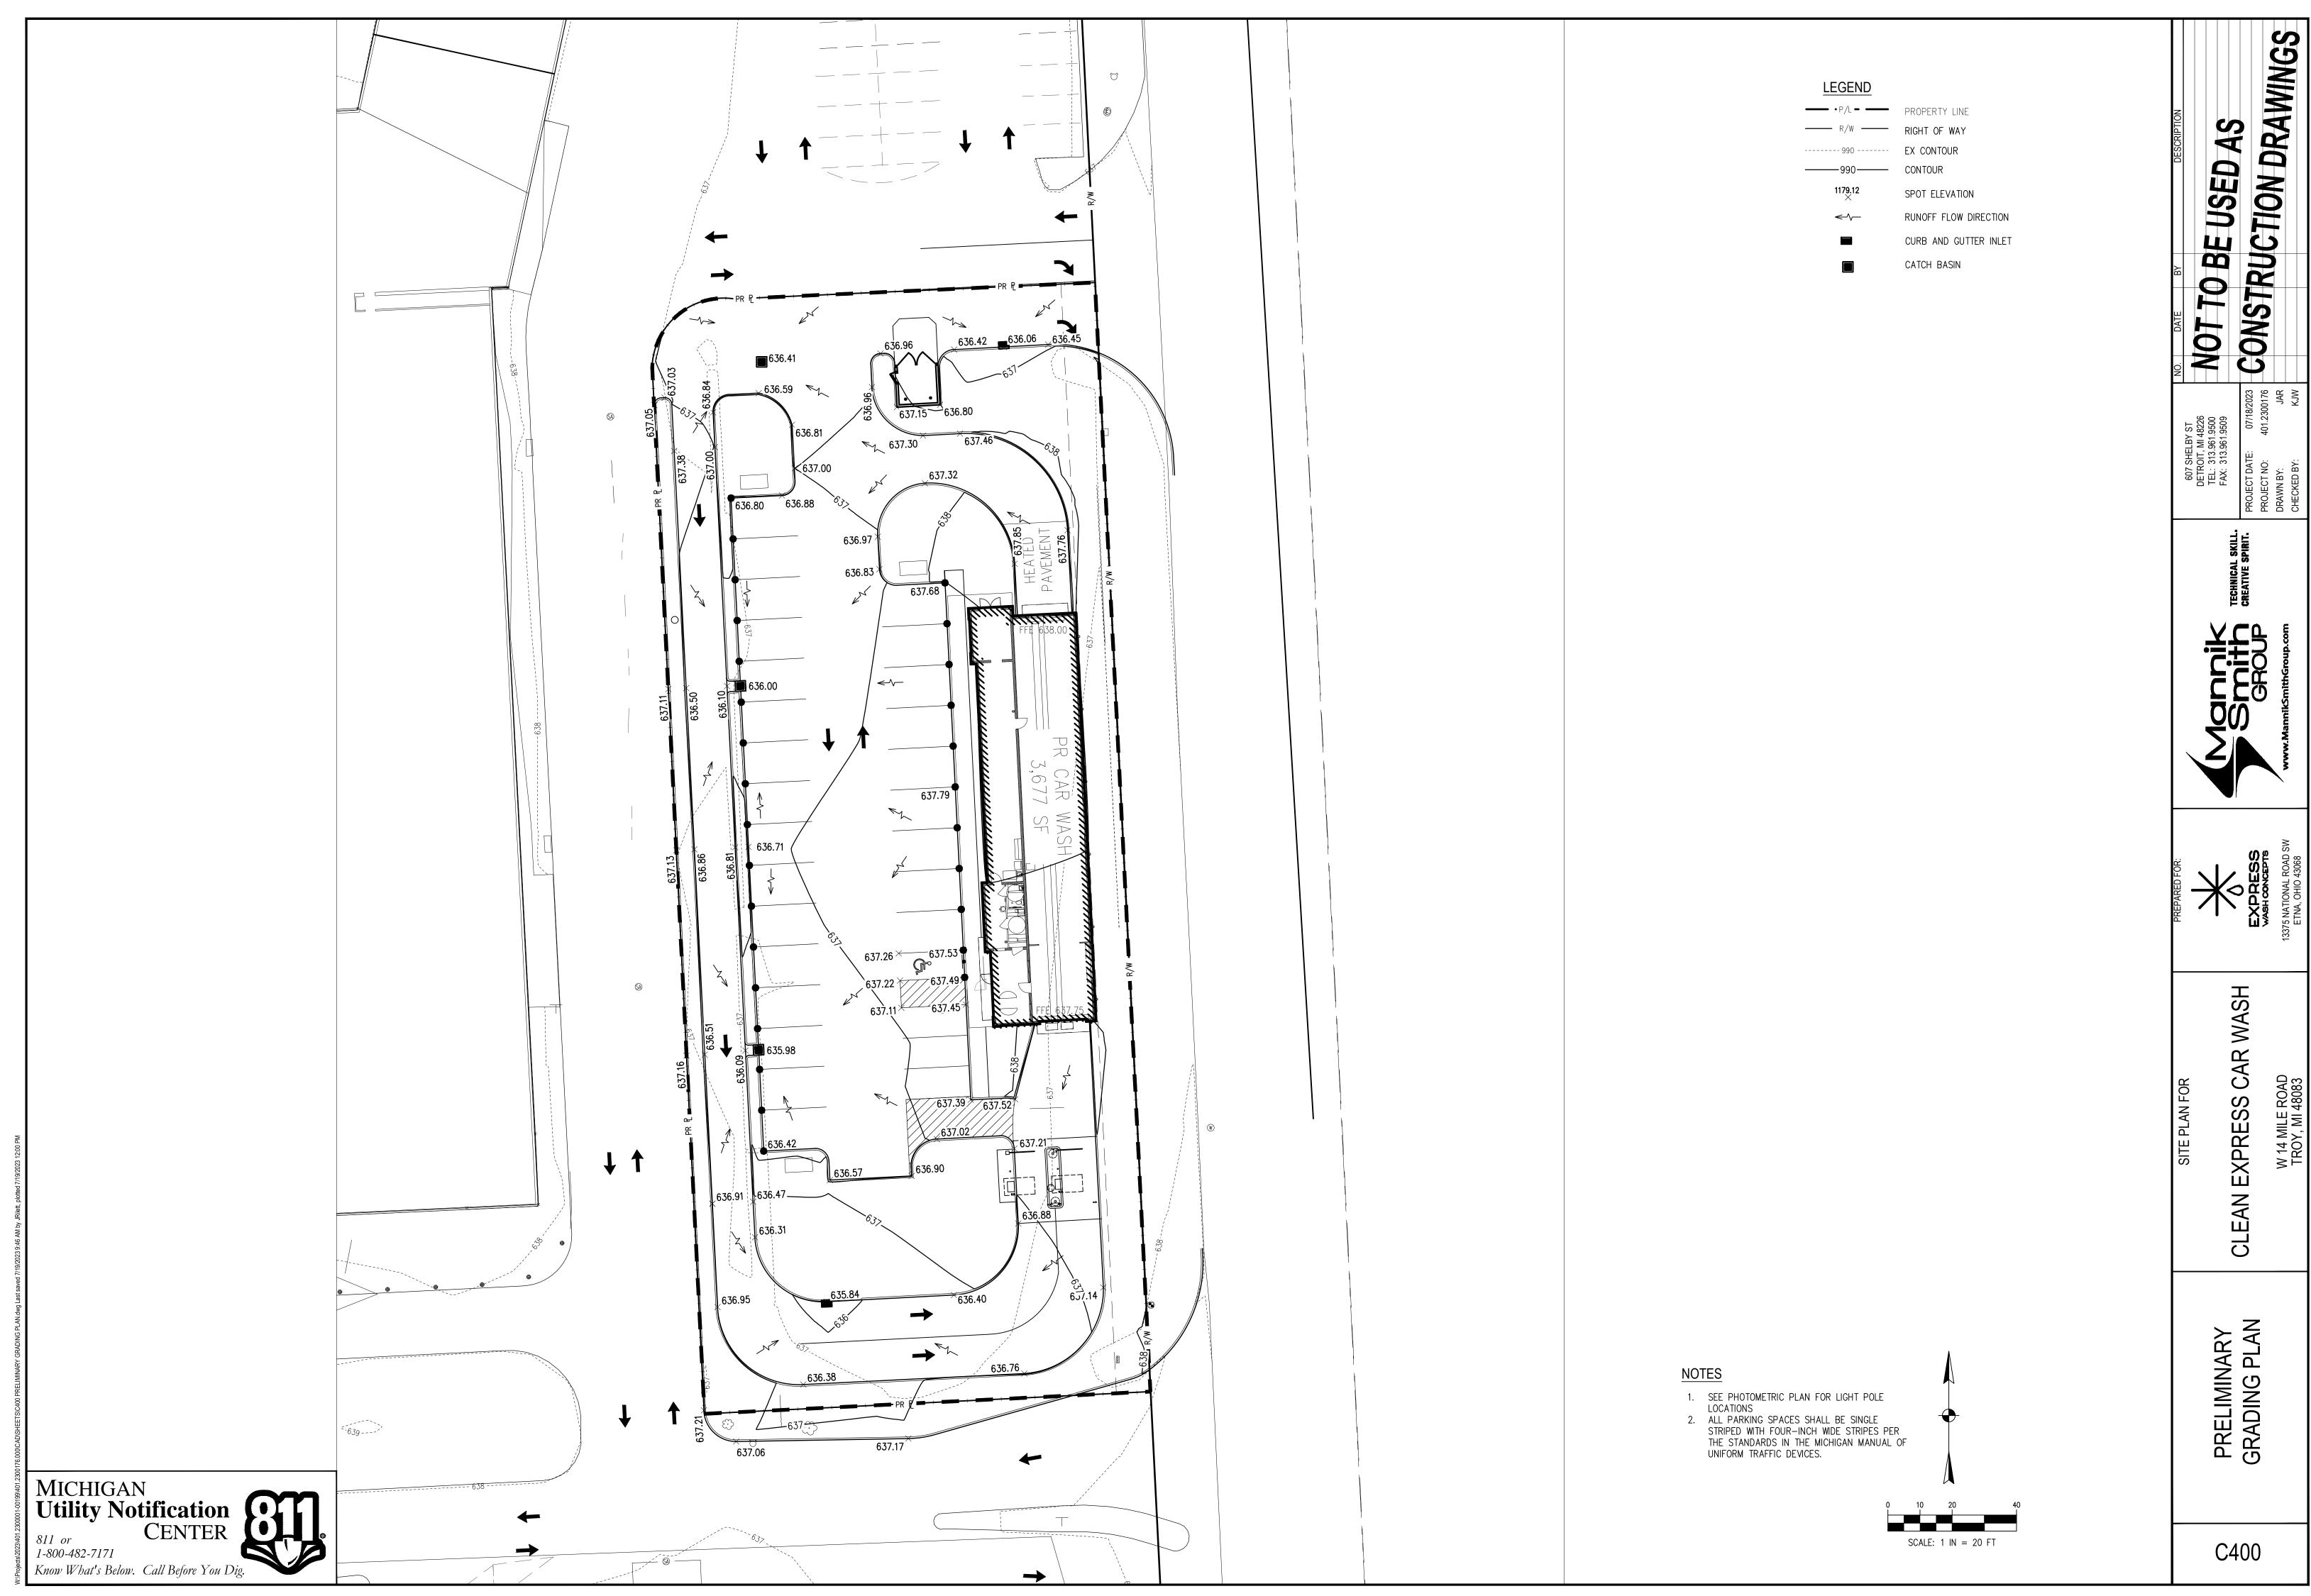ENLARGED FLOOR PLAN

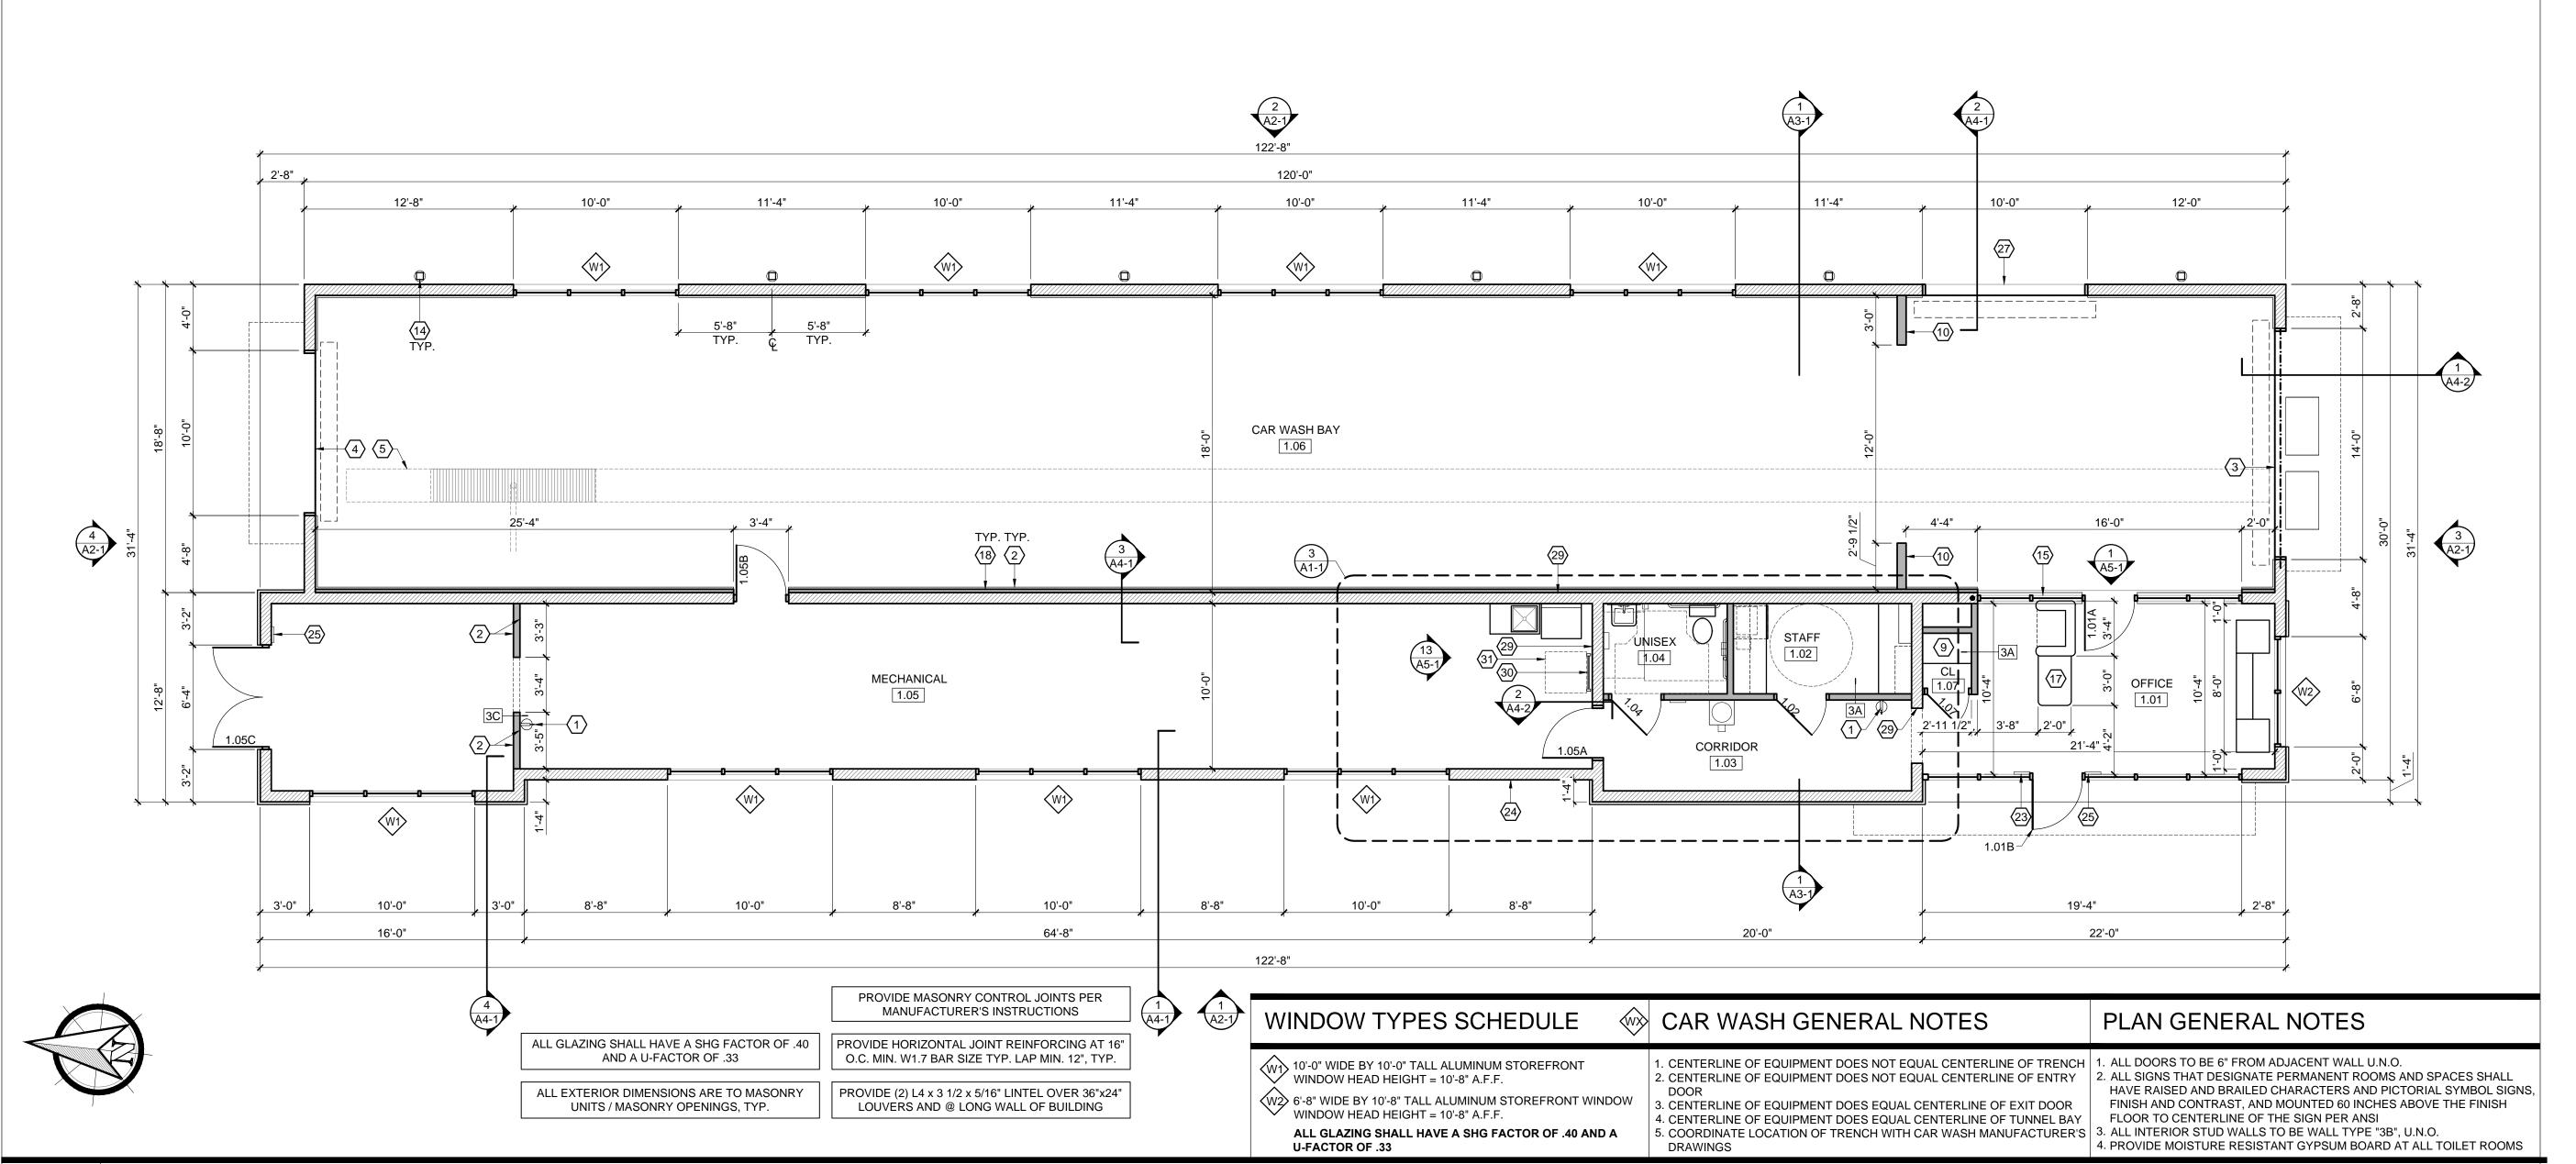

FLOOR PLAN CODED NOTES

1. WALL MOUNTED FIRE EXTINGUISHER. EXTINGUISHER TO BE: RED ENEMELED FINISH HEAVY DUTY STEEL CYLINDER. UL AND FM APPROVED. ABC MULTI PURPOSE DRY CHEMICAL, 10 LB CAPACITY UL RATED 4A 60B: C, HOSE TYPE, UPRIGHT, SQUEEZE

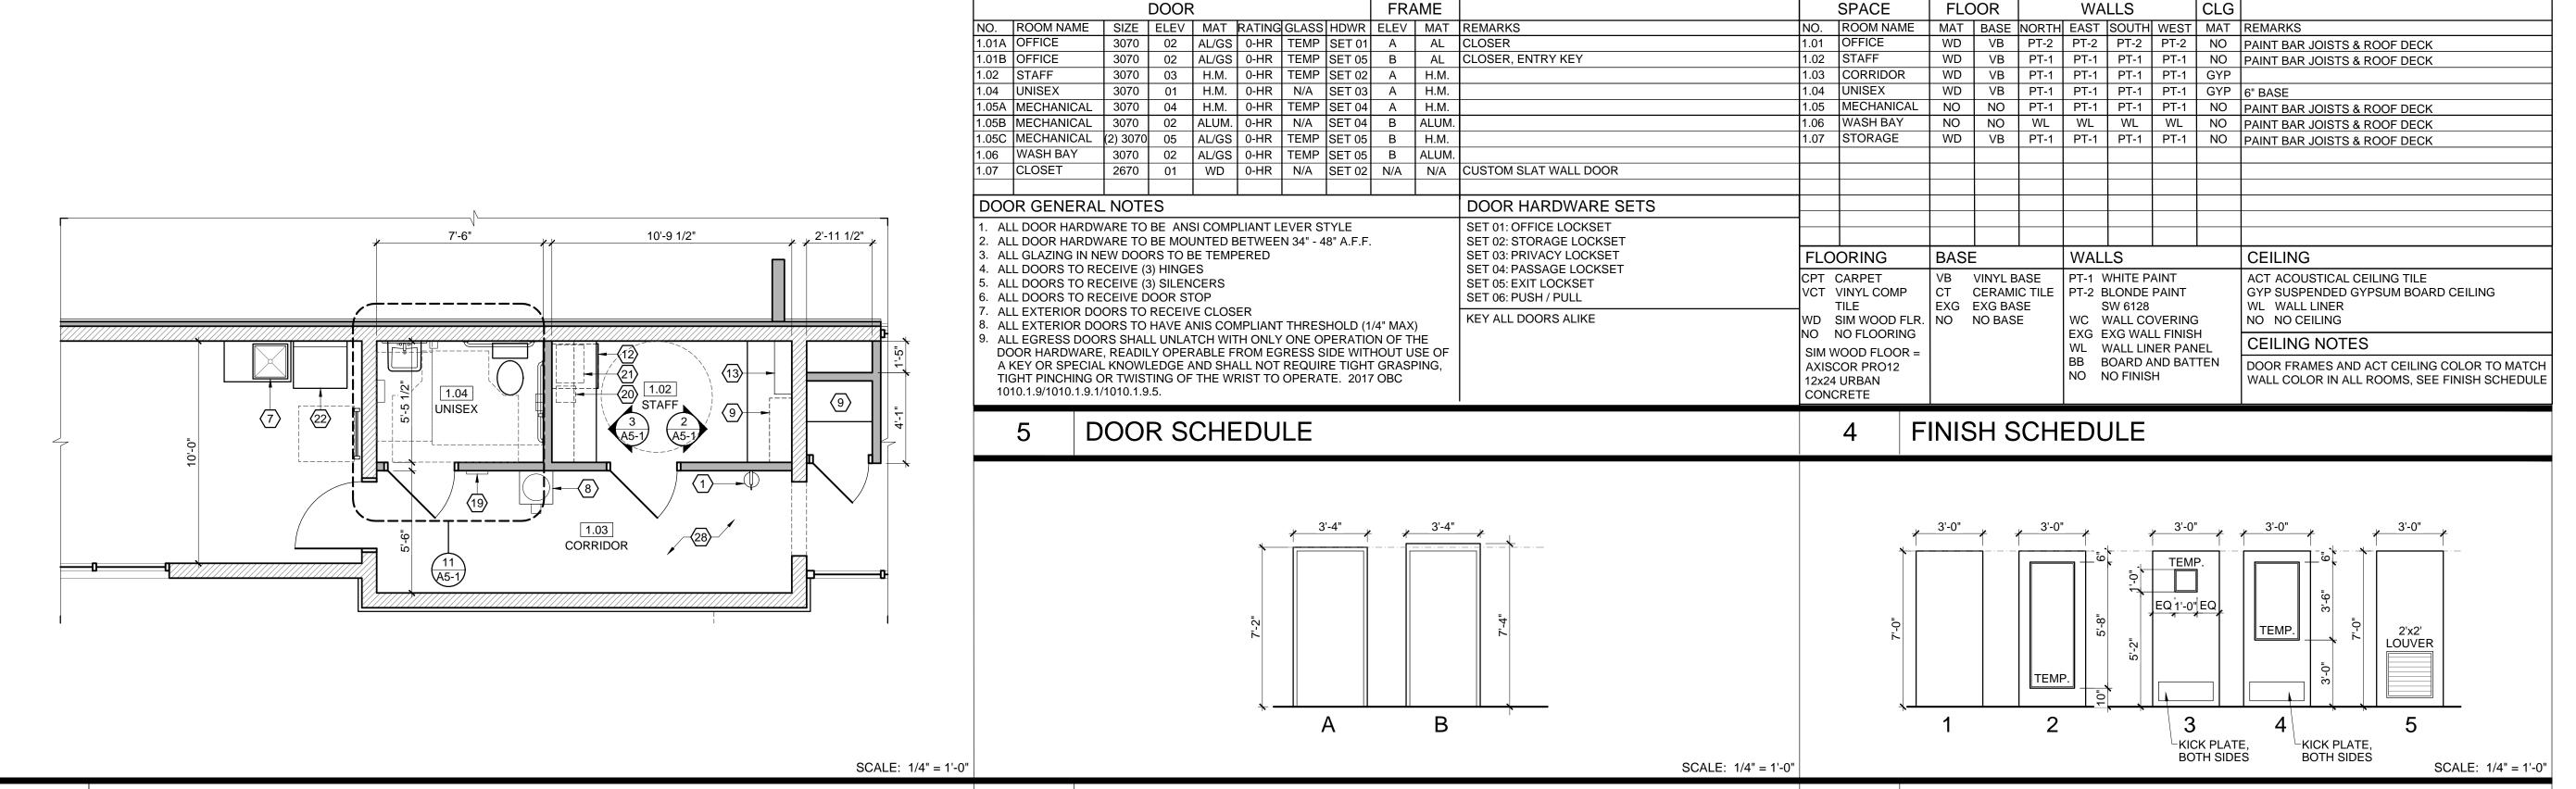- GRIP OPERATION 2. INTERIOR WALL LINER PANEL
- 3. 14'-0" x 8'-0" OVERHEAD DOOR 4. 10'-0" x 8'-0" OVERHEAD DOOR
- 5. CAR WASH TRENCH, SEE MANUFACTURER'S DRAWINGS 6. DECORATIVE AWNING W/ BRACKETS, CENTER OVER WINDOWS /
- '. DEDICATED COMMERCIAL GRADE SINK FOR UTILITY SINK
- 8. ANSI COMPLIANT BOTTLED WATER COOLER WITH CUP
- DISPENSER 9. 12" DEEP SHELVING W/ STANDARDS AND BRACKETS
- 10. WIND WALL, P.T. 2x6 WALL W/ 7/16" OSB SHEATHING & LINER
- 11. NOT USED 12. UNDER COUNTER REFRIGERATOR

PANEL BOTH SIDES

- 13. SERVER RACK, SEE SHEET A5-1
- 14. DOWNSPOUT 15. ALUMINUM STOREFRONT SYSTEM, WINDOW HEAD HEIGHT = 8'-0",
- SEE ELEVATION 1/A5-1, PROVIDE 1" INSULATED GLASS
- 17. RECEPTIONIST DESK BY OTHERS. ANSI COMPLIANCE IS THE
- RESPONSIBILITY OF THE DESK DESIGNER
- 18. PROVIDE 2 1/2" METAL Z-FURRING STRIPS @ 24" HORIZONTAL
- W/ MIN R-13 RIGID INSULATION IN FURRING CAVITIES W/ 5 MIL VAPOR BARRIER
- 19. ANSI COMPLIANT SIGNAGE DESIGNATING UNISEX TOILET ROOM 20. COFFEE MAKER, SEE INTERIOR ELEVATION
- 22. STACKABLE WASHER / DRYER 23. ANSI COMPLIANT SIGNAGE DESIGNATING MAXIMUM OCCUPANCY
- OF 15 PERSONS 24. QUIK-BRIK MASONRY CONSTRUCTION

21. MICROWAVE, SEE INTERIOR ELEVATION

- 25. ANSI COMPLIANT EXIT SIGNAGE, SEE 9/A5-1
- 26. STORAGE CABINETRY, SEE INTERIOR ELEVATION ON SHEET A5-1 27. 10'-0" x 8'-0" OVERHEAD DOOR
- 28. HVAC PLATFORM ABOVE, SEE DETAILS ON SHEET A1-3 29. 8" CMU WALL
- 30. ROOF ACCESS LADDER, CENTER BELOW ROOF HATCH ABOVE, SEE DETAIL 13/A5-1
- 31. 30"x30" CLEAR LANDING SPACE, CENTERED ON LADDER

WALL TYPES SCHEDULE

	v	WALL THE ESSE		
	#	ASSEMBLY DESCRIPTION	HR	NOTES
	—3A	2x4 WOOD STUDS @ 16" O.C.	G: 0 HR E # N/A	FULL HEIGHT PARTITION, TERMINATE GYPSUM BOARD @ UNDERSIDE OF JOISTS.
		ASSEMBLY THICKNESS = 4 3/4"		
	3B	2x4 WOOD STUDS @ 16" O.C. 	RATING: 0 HR UL FILE # N/A	FULL HEIGHT PARTITION, TERMINATE GYPSUM BOARD @ UNDERSIDE OF JOISTS. ASSEMBLY THICKNESS = 4 3/4"
I	3C	2x4 WOOD STUDS @ 16" O.C. -5/8" GYP BD -3" SOUND BATT	RATING: 0 HR UL FILE # N/A	FULL HEIGHT PARTITION, TERMINATE GYPSUM BOARD @ BOTTOM OF DECK. ASSEMBLY THICKNESS = 4 3/4"

#	DATE	ISSUED WITH: CHANGE DESCRIPTION





SCALE: 3/16" = 1'-0" (U.N.O.)


SHEET # / DESCRIPTION


FLOOR PLAN

DATE: 05.17.2023 PRELIMINARY DESIGN




FRAME ELEVATIONS DOOR ELEVATIONS

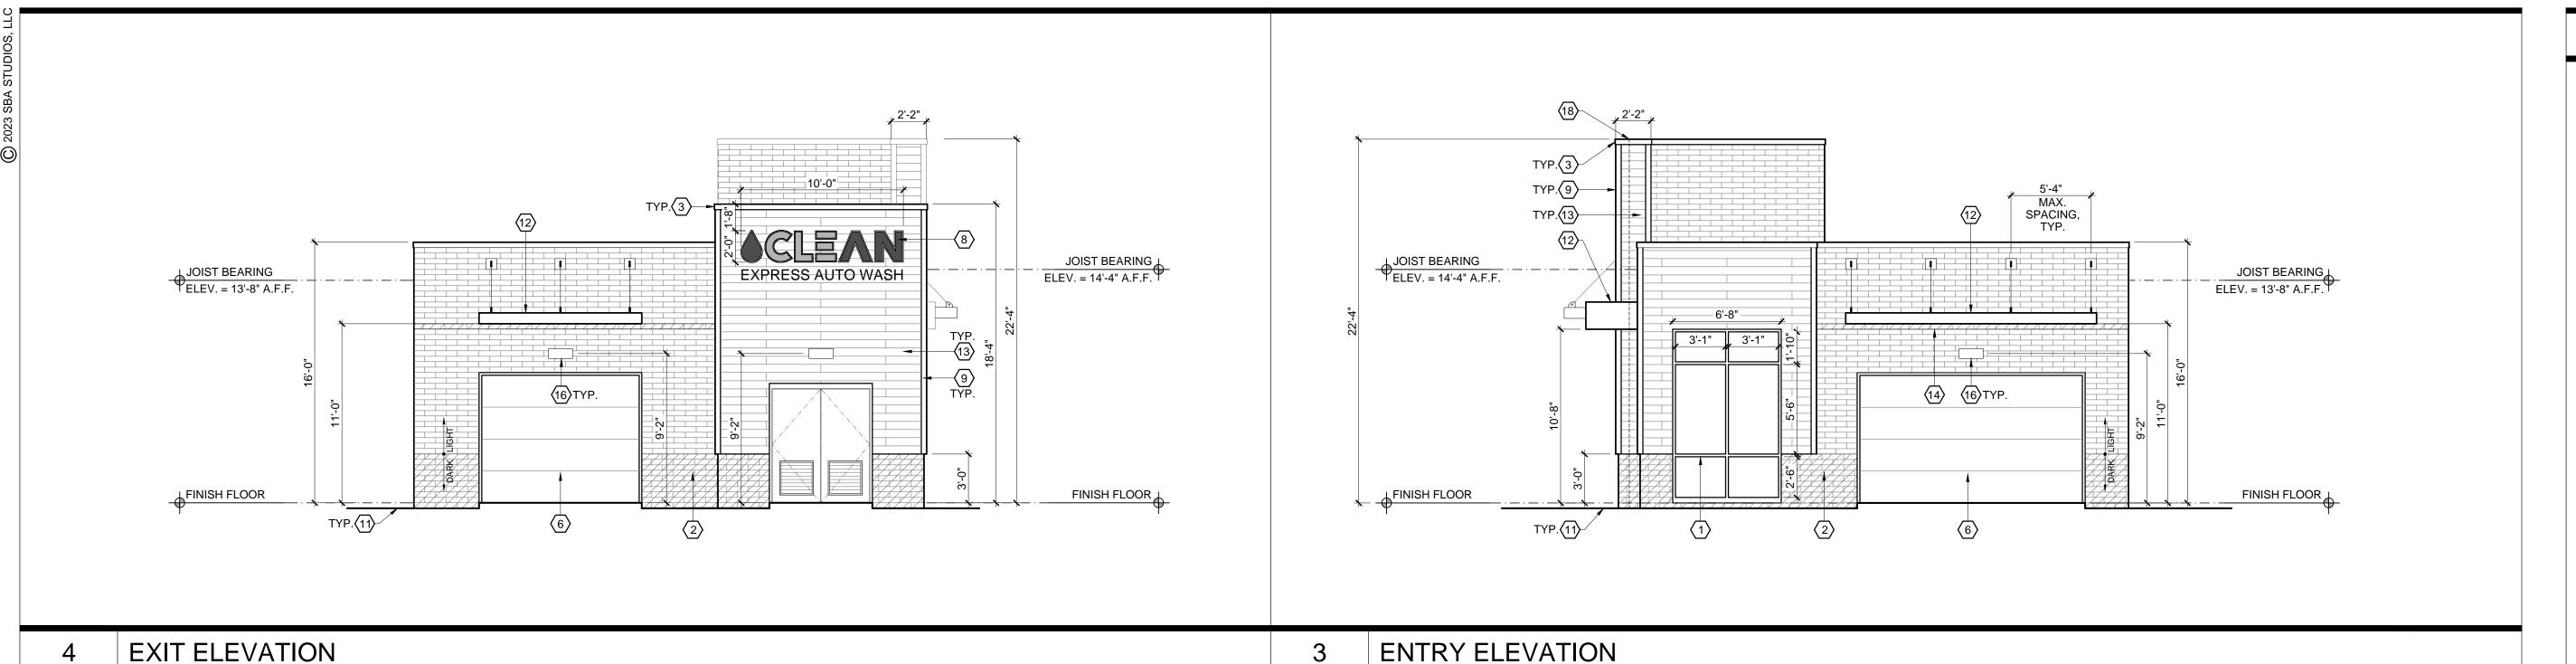

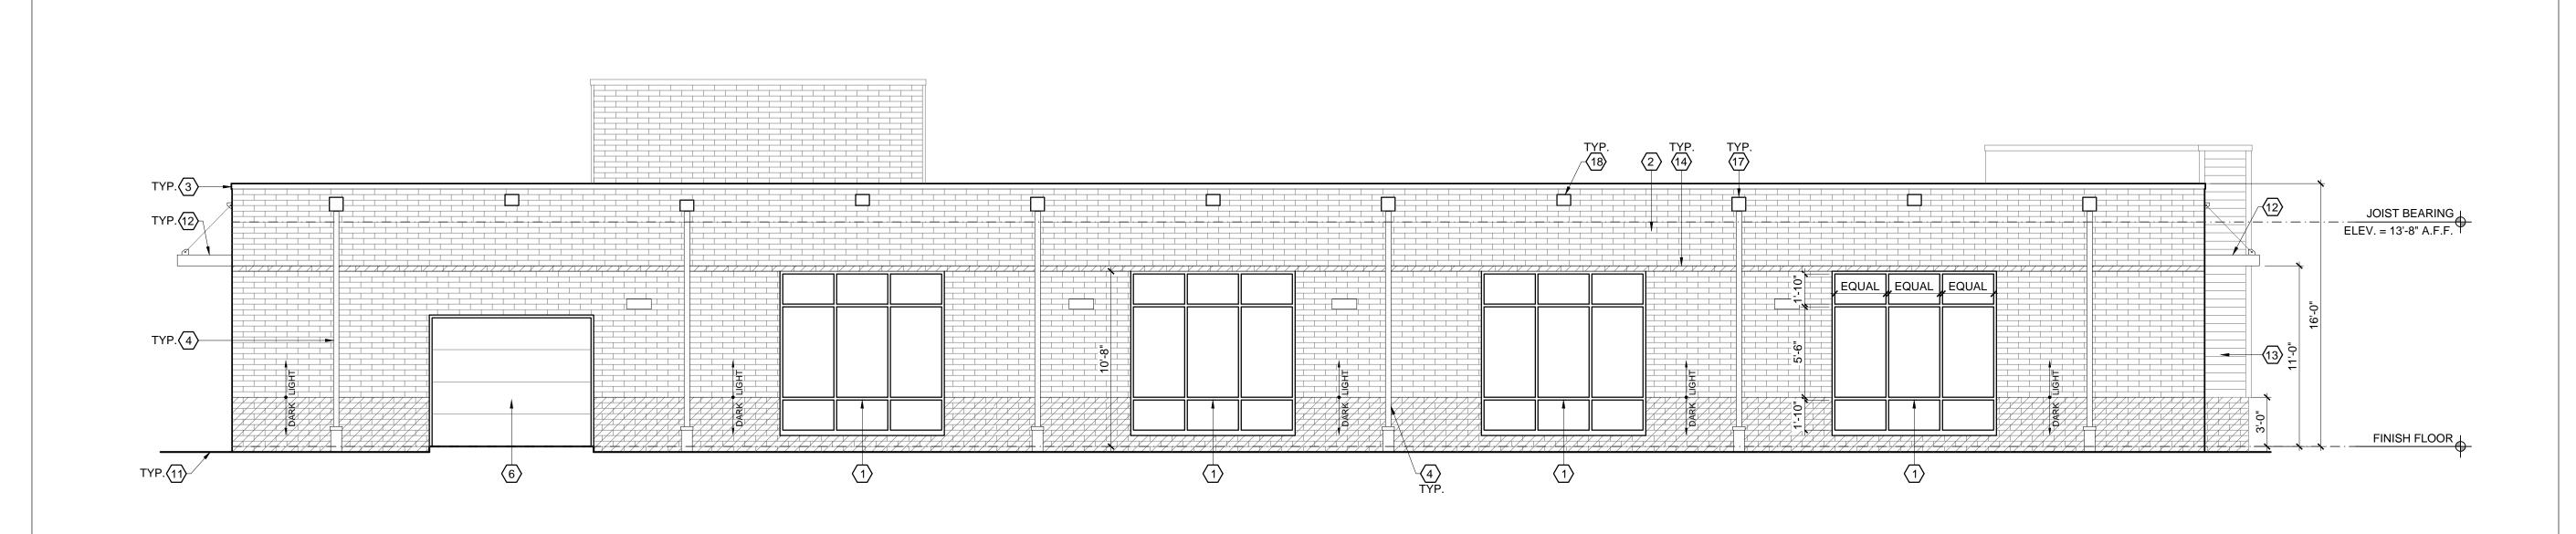


SIDE ELEVATION

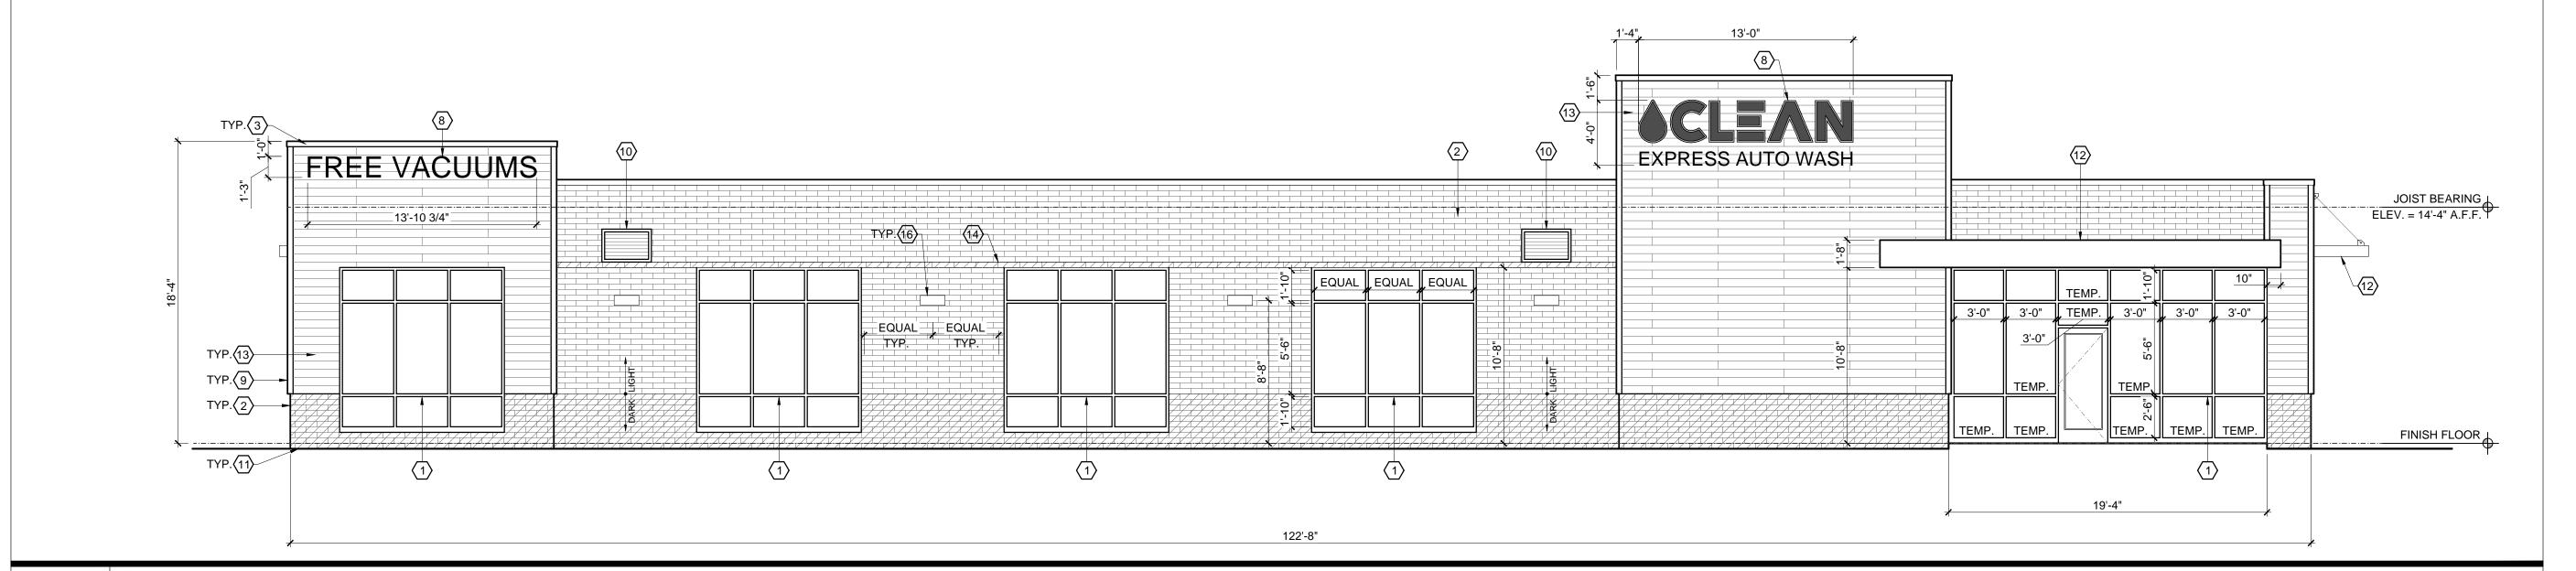

ELEVATION CODED NOTES

- I. ALUMINUM STOREFRONT GLAZING SYSTEM. MANUFACTURER TO DESIGN FOR WIND LOAD REQUIREMENTS PER CODE
- 2. QUIK-BRIK CMU CONSTRUCTION, SEE MATERIALS LEGEND. INSTALL CONTROL JOINTS PER MANUFACTURER'S WRITTEN
- INSTALLATION INSTRUCTIONS
- 3. CONTINUOUS METAL COPING, TYP.
- 4. 4" METAL DOWNSPOUT 5. NOT USED
- 6. OVERHEAD DOOR 7. NOT USED
- 8. SIGNAGE PROVIDED BY OWNER.
- 9. 1x4 COMPOSITE CORNER TRIM, TYP. 10.36"x24" METAL WALL LOUVER W/2" FRAME, SEE HVAC DRAWINGS. LOCATE SUCH THAT OPENING IS NOT DIRECTLY BENEATH A
- **ROOF JOIST** 11. GRADE, COORDINATE W/ CIVIL DRAWINGS.
- 12. PRE-MANUFACTURED ALUMINUM AWNING. INSTALL PER MANUFACTURER'S INSTRUCTIONS.
- 13. NICHIHA FIBER CEMENT AWP181 HORIZONTAL SIDING.
- 14. MASONRY BAND IN DARK FINISH TO MATCH BASE OF WALL 15. NOT USED
- 16. DECORATIVE LIGHT FIXTURE
- 17. SCUPPER & DOWNSPOUT COLLECTION BOX
- 18. EMERGENCY OVERFLOW SCUPPER

ELEVATION MATERIAL LEGEND

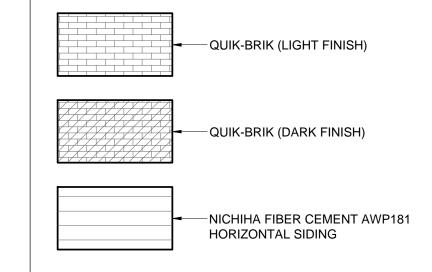

EXTERIOR MATERIAL NOTES:

1. COLOR OF METAL COPING TO MATCH STOREFRONT SYSTEM

#	DATE	ISSUED WITH: CHANGE DESCRIPTION







SIDE ELEVATION

PUBLIC ROAD 75 FEET WIDE



SANITARY MANHOLE W WATER MANHOLE STORM CATCH BASIN BEE HIVE CATCH BASIN TELEPHONE MANHOLE ELECTRIC MANHOLE LIGHT MANHOLE UNKNOWN MANHOLE CLEAN OUT FIRE HYDRANT

* ₩ATER SHUT OFF VALVE GAS BOX GAS METER ♦ LIGHT BASE

☆ LIGHT POLE GUY POLE POWER POLE

GUY WIRE ANCHOR ELECTRIC BREAKER PANEL ELECTRIC TRANSFORMER AS GAS UTILITY MARKER CABLE TV PADESTAL POST MOUNT SIGN

FIBER OPTIC UTILITY MARKER → TWO POST MOUNT SIGN □ TREE STUMP PICNIC TABLE & HANDICAPPED PARKING SPACE SECTION CORNER

IRON PIPE IRON PIN DS DOWN SPOUT EX FF EXISTING FINISHED FLOOR SHRUB TREE COLUMN **BUILDING LINE** $- \times - \times - \times - \times - \times - \times - \times -$ FENCE LINE STORM LINI

> OVERHEAD UTILITY LINE ELECTRIC LINE RIGHT OF WAY LINE BOUNDARY LINE

WATER LINE

THE BASIS OF BEARING IS GRID NORTH, BASED ON THE NAD83 MICHIGAN STATE PLANE COORDINATES, SOUTH ZONE 2113 AS DETERMINED BY USING THE MICHIGAN DEPARTMENT OF TRANSPORTATION MSRN/RTCM SYSTEM. ELEVATIONS ARE RELATIVE TO THE NORTH AMERICAN VERTICAL DATUM OF 1988 (NAVD88) ESTABLISHED BY USING THE MICHIGAN DEPARTMENT OF TRANSPORTATION MSRN/RTCM SYSTEM AND GEOID12B.

CONTROL POINTS

PN NORTHING EASTING ELEV. DESC. CP-MAG 100 379528.57'13462727.30' 636.47' 101 379981.50'13462662.18' 636.82' CP-MAG CP-MAG 102 380682.85'13462700.35' 637.09' 103 380071.55'13462081.35' 638.09' CP-MAG1 CP MAG 150 380589.04'13462369.08' 636.47' **CP MAG** 152 380531.38'13462257.36' 637.54' 153 380442.72'13462363.79' 637.75' **CP MAG** CP MAG 154 380518.15'13462061.45' 638.08' CP MAG FD 151 380460.20'13462488.15' 637.54'

BENCHMARKS

PN NORTHING EASTING ELEV. DESC.

200 379495.16'13462739.39' 637.86' **BM-TOP NE**

SURVEYOR'S CERTIFICATE

I, BETH AILEEN BRAUN, PROFESSIONAL SURVEYOR OF THE STATE OF MICHIGAN, HEREBY CERTIFY: THAT THE SUBDIVISION PLAN KNOWN AS SAWYER/7303 WEST MCNICHOLS, WAYNE COUNTY CONDOMINIUM PLAN NO. AS SHOWN ON THE ACCOMPANYING DRAWINGS, REPRESENTS A SURVEY ON THE GROUND MADE UNDER MY DIRECTION THAT THERE ARE NO EXISTING ENCROACHMENTS UPON THE LANDS AND PROPERTY HEREIN DESCRIBED AS

THAT THE REQUIRED MONUMENTS AND IRON MARKERS HAVE BEEN LOCATED IN THE GROUND AS REQUIRED BY RULES PROMULGATED UNDER SECTION 142 OF ACT NO. 59 OF THE PUBLIC ACTS OF 1978. THAT THE ACCURACY OF THIS SURVEY IS WITHIN THE LIMITS REQUIRED BY

THE RULES PROMULGATED UNDER SECTION 142 OF ACT NO. 59 OF THE PUBLIC ACTS OF 1978.

THAT THE BEARINGS, AS SHOWN ARE NOTED ON SURVEY PLAN AS REQUIRED BY THE RULES PROMULGATED UNDER SECTION 142 OF ACT NO. 59 OF THE PUBLIC ACTS OF 1978.

(DATE)

BETH AILEEN BRAUN, PS PROFESSIONAL SURVEYOR REGISTRATION NO.4001052461 MANNIK AND SMITH GROUP 2365 HAGGERTY ROAD SOUTH **CANTON**, MI 48188

STRUCTURE INVENTORY

TMH 61021151 CB 61521125 RIM ELEV.: 636.53' RIM ELEV.: 635.62' HAS SOLID MINERAL GROWTH TMH 61021124 24" RCP W 629.62' RIM ELEV.: 636.97' 24" RCP E 629.27' WMH 61121388 4" PVC E 633.12' RIM ELEV.: 638.29'

FULL OF WATER

STMH 61121450

RIM ELEV.: 637.28'

60" N/A E 621.28'

54' N/A N 621.68'

STMH 200004

36" RCP W 627.63'

RIM ELEV.: 637.87'

STMH 61121451

RIM ELEV.: 637.95'

60" RCP W 621.15'

CB 200002

CB 200001

CB 200000

RIM ELEV.: 635.38

12" VCP E 631.02'

6" VCP NNW 631.68'

4" CPP WNW 633.38'

4" CPP SSW 633.38'

4" CPP SE 633.38'

CBB 61121014

RIM ELEV.: 635.35'

4" PVC W 632.97' STMH 61121771 631.49' TOP OF VALVE RIM ELEV.: 636.96" MINERAL FORMATIONS

12" N/A E 630.96" TOP OF RIM ELEV.: 637.94' **SEDIMENT** SMH 61521127 36" RCP SSW 626.73 RIM ELEV .: 636.88' LINED WITH MINERAL MATERIAL 10" PVC E 624.88'

12" N/A NW 630.46"

8' VCP NW 645.18' ACCESS HATCH MANHOLE 10" PVC W 624.98' LID TO EXTRA LARGE VAULT STMH 61521127 10" PVC S 649.37' RIM ELEV.: 636.88' 4" VCP S 631.98' RIM ELEV.: 642.54' 4" VCP ENE 631.98

60" RCP E 621.05' SMH 61621382 RIM ELEV .: 637.30' LINED WITH MINERAL MATERIAL RIM ELEV .: 635.18' 10" N/A N 623.60' 15" RCP SSW 659.53' 18" RCP NW 359.23' 10" N/A S 623.70' 4" CPP N 360.98'

4" CPP SE 360.98' SMH 61621371 RIM ELEV.: 637.14' LINED WITH MINERAL MATERIAL RIM ELEV.: 635.23' 10" N/A S 622.79' 4" CPP NNW 632.23' 10" N/A N 622.69' 12" VCP W 361.08' 15" VCP NE 630.58' STMH 61621370 6" PVC NNW 631.23'

12" RCP NW 629.53' RIM ELEV.: 637.23' 15" RCP S 630.88' 12" RCP E 630.23' 12" RCP N 631.13' CB 62621493 4" VCP WNW 631.23' RIM ELEV.: 640.81' 4" VCP WNW 631.23' 12" RCP N 630.11' 12" RCP E 630.11' CB 61621195

RIM ELEV.: 636.09'

PACKED WITH MINERAL

MATERIAL AND FILLED WITH WATER RIM ELEV.: 636.05' 6" PVC NNW 632.35' STMH 61621202 6" PVC SSE 632.35' RIM ELEV.: 635.98' 6" MP NNE 632.38

CB 61121310 STMH 21162137 RIM ELEV.: 634.92 RIM ELEV.: 637.19' HAS MINERAL 12" RCP W 632.29' STALAGTIGHT 18" RCP NW 631.99' 36" RCP NE 627.02' 12" RCP NNE 632.19 36" RCP W 627.67 4" PVC E 633.42' CB 21162138 4" PVC W 633.52' RIM ELEV.: 636.34' WALLS CAVED IN SMH 61121301 18" RCP SE 633.34'

18" RCP NW 633.34" 10" PVC N 625.55' 10" PVC SSW 625.75' SMH 21162112 10" PVC SSW 630.25' RIM ELEV. 636.64' CB 61521062 10" PVC N 630.24' RIM ELEV.: 634.62' 4" VCP SSW 630.54' FULL OF SEDIMENT AND 4" VCP SSE 630.54'

DEBRIS 36" RCP E 627.57' STMH 21162228 4" PVC E 632.27' RIM ELEV.: 637.21' 4" PVC W 632.27' 12" RCP E 632.41 4" CPP SE 632.57' 6" VCP NNE 632.31 SMH 61121535 STMH 21166027

RIM ELEV.: 637.20' RIM ELEV .: 635.91' 10" VCP N 625.41' 18" RCP NE 630.95 10" VCP W 625.46' 12" RCP W 631.00' 10" VCP S 6225.46'

CB 62621509 RIM ELEV.: 635.03 12" RCP N 630.33' 12" RCP E 630.23'

SMH 21166028

MATERIAL

RIM ELEV.: 637.20'

10" PVC W 623.60'

STMH 21122026

RIM ELEV.: 637.36'

6" HDP W 636.16'

8" VCP SSW 632.21

10" PVC N 624.24'

10" PVC E 624.14'

6" PVC S 636.34'

SMH 21166560

RIM ELEV.: 636.97'

STMH 62621523

48" RCP SSE 622.54'

48" RCP N 622.54'

RIM ELEV .: 641.44"

RIM ELEV .: 641.23'

12" RCP S 629.53'

CB 62621453

SEDIMENT

12" RCP E 630.42'

RIM ELEV.: 635.02'

12" RCP N 629.52'

12" RCP S 629.42'

12" RCP E 629.52'

CB 62621507

RIM ELEV.: 635.11'

CB 62621444

CB 62621489

48" RCP W

12" RCP E 632.16'

SMH 21166025

10" PVC ENE 623.50'

COATED IN MINERAL

CB 211771134 CB 61621722 RIM ELEV.: 637.50 RIM ELEV.:635.36' 12" RCP SW 631.80' **BLOCKED BY MINERAL** FORMATIONS CB 21166567 STMH 61621732 RIM ELEV.: 635.85' RIM ELEV.: 635.44' **OUTLET BLOCKED BY**

MINERAL FORMATION

4" PVC E

14 MILE ROAD

SMH 62621008

RIM ELEV.: 637.29'

10" PVC ESE 622.29'

10" PVC S/W 622.29'

12" RCP SSE 627.64'

6" VCP ESE 630.34'

10" PVC S 622.54'

4" PVC W STMH 61621595 RIM ELEV.: 637.81' STMH 21166568 MINERAL FORMATION RIM ELEV.: 636.23 **BLOCKED OUTLET GIANT MINERAL** FRIMATION BLOCKS PIPES 12" RCP ESE 633.21'

SMH 61621681 TMH 21166537 RIM ELEV.: 637.26' RIM ELEV.: 636.43' 15" PVC N 619.66' FILLED WITH WATER 15" PVC S 619.71' FELT CABLES STMH 6162148 48" RCP ESE 622.54'

TMH 21166538 RIM ELEV.:636.79' RIM ELEV.: 636.34' MINERAL BUILD UP FILLED WITH WATER 48" RCP S 623.09' FELT CABLES 48" RCP NW 621.99' CB 21166532

SMH 61621549 RIM ELEV.: 635.99' 12" RCP W 634.49' RIM ELEV.: 636.90' MINERALS BLOCKS PIPES 10" PVC SSW 620.70 CB 62621460 48"? RCP ENE 625.34' 12" PVC WNW 621.55' RIM ELEV .: 642.07' 48"? RCP WSW 625.69' 15" PVC ESE 619.80' 12" RCP W 635.57' 6" VCP E 633.33' 6" VCP W 633.33' CB 62621456

STMH 61621550 RIM ELEV .: 637.20' WMH 21166153 12" RCP SSW 632.30 RIM ELEV.: 636.55 12" RCP WNW 632.35' **FULL OF WATER** TOP OF VALVE 630.70 CB 61621557 WMH 21166154

RIM ELEV.: 635.90' RIM ELEV.: 636.55' MINERAL BUILD UP **FULL OF WATER** 12" RCP E 631.40' TOP OF VALVE 631.55' 4" VCP N 633.25 4" VCP S 633.25 CB 21166720 RIM ELEV.: 635.49'

RIM ELEV.: 636.91' CB 61521157 **BLOCKED BY MINERAL** FILLED WITH WATER AND FORMATIONS RIM ELEV.: 636.92 PACKED SOLID WITH CB 62621500 SEDIMENT CB 62621096 RIM ELEV.: 637.22 RIM ELEV.: 636.75' STMH 61121394 12" RCP W 630.62'

PACKED WITH SEDIMENT RIM ELEV.: 637.24 12" RCP N 629.44' CB 62621277 12" RCP W 629.44 RIM ELEV.: 635.90 24" RCP S 629.24' 48" RCP ESE 622.35' PIPE BLOCKED BY MINERAL STMH 61121394 **FORMATIOIN** RIM ELEV.: 637.24 48" N/A SW 625.80'

18" RCP S 638.10 CB 62621443 RIM ELEV.: 634.99 CB 62621278 12" RCP W 628.49' RIM ELEV.:635.67' 12" RCP E 628.59' 12" RCP N 628.32' 4" PVC E 633.02' CB 62621442 8" CPP W 634.12' RIM ELEV.: 634.63' 12" PVC W 629.78' CB 21166155

RIM ELEV.: 636.16'

MINERAL FORMATIONS

12" RCP W 630.61' CB 62621508 RIM ELEV.: 635.03' 12" RCP E 630.43' 12" RCP W 630.58' 8" CPP S N/A

UNKNOWN OUTLET HOLE

628.63'

24" RCP E 627.94' 18"? N/A N 631.11' 24" RCP N 628.84' 18" RCP ESE 631.01' 24" RCP W 628.84' 18" RCP SSW 630.26 4" PVC W 632.64' 4" PVC N 633.66' 4" PVC E 632.64' 4" PVC S 633.86'

10" N/A S 622.44'

10" N/A N 622.34'

SMH 61121393

RIM ELEV .: 636.93'


10" PVC S 624.28'

10" PVC W 624.28'

10" N/A N 624.18'

RIM ELEV.:635.54'

CB 61121395

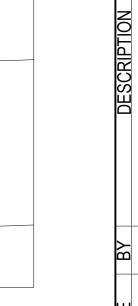

STMH 61121772

RIM ELEV.: 637.66

12" RCP SE 360.71'

12" RCP W 364.76'

RIM ELEV.: 636.42'

MINERAL DEPOSIT

10" VCP E 625.87'

RIM ELEV.: 635.98'

12" RCP SSW 631.18'

4" CPP NNE 633.18'

4" CPP S 633.18'

CB 61525416

RIM ELEV .: 635.63'

4" PVC W 633.23'

4' PVC E 632.93'

24" RCP E 629.23'

STMH 61521370

RIM ELEV.: 637.40'

12" RCP NW 631.90'

12" RCP E 631.40'

SMH 61521369

RIM ELEV.: 637.33

10" PVC W 626.38'

10" PVC E 626.28'

10" VCP S 625.87'

CB 61521096

SMH 61521071



STMH 61521572 RIM ELEV .: 637.78' 4" PVC S 634.57'

STMH 61521574 RIM ELEV.: 937.82' 4" PVC N 634.82' 6' PVC S 634.72'

STMH 61521579 RIM ELEV.: 637.81' 6" PVC N 634.06' 8" PVC S 633.86'

STMH 61521359 RIM ELEV.: 638.12' 8" PVC N 632.67' 12" RCP SSW 632.12' 6" PVC NE 632.67'

WMH 61521366 RIM ELEV.: 637.10' **FULL OF WATER AND SEDIMENT** FEELS LIKE TOP OF VALVE

MH 61621529 RIM ELEV.: 637.02' 15" RCP W 619.77' 15" RCP N 619.67'

SMH 61621631 RIM ELEV .: 636.86' 15" PVC S 619.36' 15" PVC N 619.26'

SMH 200003 RIM ELEV .: 637.09' 4" VCP NE 632.39' 12" RCP S 632.39'

> STMH 21162145 RIM ELEV.: 637.76' 4" VCP NE 633.06' 12" RCP S 633.06'

OOR

MICHIGAN

ROY

NO

Schedul	e								
Symbol	Label	QTY	Manufacturer	Catalog	Description	Number Lamps	Lamp Output	LLF	Input Power
	PL5	2	Lithonia Lighting	RSX2 LED P4 40K R5	RSX Area Fixture Size 2 P4 Lumen Package 4000K CCT Type R5 Distribution	1	25667	0.94	189.54
	PL3-HS	1	Lithonia Lighting	RSX2 LED P4 40K R3 HS	RSX Area Fixture Size 2 P4 Lumen Package 4000K CCT Type R3 Distribution with HS Shield	1	18440	0.94	189.5392
	WP1	6	Lithonia Lighting	ARC2 LED P3 40K	ARC2 LED WITH P3 - PERFORMANCE PACKAGE, 4000K	1	3388	0.94	23.7345

Statistics	

Description	Symbol	Avg	Max	Min	Max/Min	Avg/Min
PARKING & VACUUM SPACES	+	2.5 fc	7.6 fc	1.4 fc	5.4:1	1.8:1
DRIVING LANES	+	1.7 fc	6.6 fc	0.5 fc	13.2:1	3.4:1

Note

- 1. AREA LIGHTS MOUNTED AT 22' AFG
- 2. 20' POLE ON A 2' POLE BASE
- 3. WALL FIXTURES MOUNTED AT 10' AFG

+0.7 +0.8 +1.0 +1.1 +1.2 +1.1 +1.1 ⁺0.8 ⁺1.0 ⁺1.2 ⁺1.5 ⁺1.8 ⁺1.9 ⁺2.3 ⁺2.4 ⁺2.4 ⁺2.1 ⁺2.5 | ⁺2.4 ⁺2.0 ⁺2.2 ⁺2.5 +2.2 +2.5 +2.6 +2.6 +2.4 +1.6 +2.0 +2.3 +2.5 +2.6 +2.3 ⁺2.8 ⁺1.7 \⁺1.6 ⁺3.5 +61 +4.1 +3.0 +1.7 +1.4 1.8 +1.7 +1.4 +2.0 2.7 1.7 +1.9 +2.6 +4.3 ⁺1.7 ⁺1.9 2.2 2.4 ⁺2.0 ⁺2.3 ⁺2.4 ⁺2.4 ⁺1.0 ⁺1.3 ⁺2.3 ⁺2.5 ⁺2.6 ⁺2.5 ⁺1.0 ⁺1.4 ⁺1.0 + 1.4

LIGHTING SYSTEMS OF COLUMBUS SHALL NOT BE HELD RESPONSIBLE FOR ANY ISSUES THAT MAY ARISE DURING THE INSTALLATION PROCESS DUE TO SPECIFIC FIELD COMPLICATIONS OR APPLICATIONS. OUR CALCULATIONS ARE PROVIDED AS A PROFESSIONAL COURTESY AND ARE BASED ON THE ILLUMINATING ENGINEERING SOCIETY RECOMMENDED PRACTICES AND ARE NOT NECESSARILY FULLY VETTED FOR CODE COMPLIANCE. IT IS THE RESPONSIBILITY OF THE ASSIGNED ENGINEER OF RECORD TO REVIEW AND APPROVE THE DRAWINGS, PRODUCTS AND INSTALLATION METHODS INCLUDING CONTROLS PRIOR TO THE COMMENCEMENT OF CONSTRUCTION. THE ENGINEER IS ULTIMATELY RESPONSIBLE FOR THE CODE COMPLIANT DESIGN THAT GETS BUILT, AND LIGHTING SYSTEMS OF COLUMBUS SHALL NOT BE HELD LIABLE FOR ANY ISSUES THAT MAY OCCUR DURING OR AFTER THE INSTALLATION.

Summary

Scale - 1" = 20ft

Scott Fenton 07/13/2023

EXPRESS CAR WASH (TROY, SITE LIGHTING LAYOUT

CLEAN

1 of 1









607 Shelby Street, Suite 300, Detroit, MI 48226 Tel: 614.441.4222 Fax: 888.488.7340 www.MannikSmithGroup.com



STATEMENT OF COMPATIBILITY

The site of the project is located in the out-lot of Oakland Mall located on W 14 mile Road. The site is currently zoned GB (general business). The project has been designed with the intent to comply with section 9.03 of the Troy zoning ordinance.

Compatibility with Adjacent uses. The intended special use will not have a greater detrimental impact when compared to impact of permitted uses.

Traffic Impact: The special use has been designed in a manner which will minimize the impact of traffic. Changes to trip generation will not create a major access issue for the surrounding parking lot or 14 mile road. Parking lot circulation is maintained by the drive aisle alongside the site. Pedestrian access from neighboring lots and 14 Mile road will be accommodated.

Compliance with Zoning Ordinance Standards. The special use has been designed to meet stated intent of the zoning district's applicable ordinance standards.

Impact on the Overall environment. The proposed special use will not unreasonably impact the quality of natural features of the environment in comparison to the impacts associated with typical permitted uses. The existing site is paved parking lot and the car wash as a special use will not create any unusual environmental impacts.





Why is Clean Express the perfect addition to your community?

Sites:

- Our buildings are modern, beautiful, and custom designed to fit in with the neighborhood. They're also meticulously maintained by dedicated staff, raising the appearance of the area.
- Inside, our state-of-the-art equipment is energy efficient, recycles water, and uses environmentally friendly solutions.
- The noise is also contained inside, resulting in a sound footprint lower than normal traffic.



Location:

- We have dozens of sites next to residential areas and are a great neighbor.
- Our business is a spontaneous purchase, meaning its typically just local traffic.
- When it comes to vehicles, our conveyor system naturally spaces them to prevent issues.
- Our professional designs limit traffic output and congestion.



• Employment:

- Each site employs dozens of people in the community, creating careers and offering pathways for advancement.
- This includes other industries like landscaping, vending, construction, and local suppliers. Jobs that stay in your community!



• Fundraising:

- It's not enough to simply work in the area, we are a part of it.
- Each site partners with local charities for fundraising.
- We do quarterly drives that donate thousands of dollars to community organizations; all with the goal of being a positive force for our neighbors.



• Quality Business:

- Our number one priority is customer service.
- We have the highest rated, highest quality wash around.





RSX2 LED Area Luminaire













Introduction

Hit the Tab key or mouse over the page to see all interactive elements

Catalog

Notes

Туре

The new RSX LED Area family delivers maximum value by providing significant energy savings, long life and outstanding photometric performance at an affordable price. The RSX2 delivers 11,000 to 31,000 lumens allowing it to replace 250W to 1000W HID luminaires.

The RSX features an integral universal mounting mechanism that allows the luminaire to be mounted on most existing drill hole patterns. This "no-drill" solution provides significant labor savings. An easy-access door on the bottom of mounting arm allows for wiring without opening the electrical compartment. A mast arm adaptor, adjustable integral slipfitter and other mounting configurations are available.







Specifications

EPA 0.69 ft² (0.06 m²) (ft2@0°):

29.3" (74.4 cm) Length: (SPA mount)

Width: 13.4" (34.0 cm)

3.0" (7.6 cm) Main Body Height: 7.2" (18.3 cm) Arm

Weight: 30.0 lbs (13.6 kg) (SPA mount)





Ordering Information

EXAMPLE: RSX2 LED P6 40K R3 MVOLT SPA DDBXD

RSX2 LED					
Series	Performance Package	Color Temperature	Distribution	Voltage	Mounting
RSX2 LED	P1 P2 P3 P4 P5 P6	30K 3000K 40K 4000K 50K 5000K	R2 Type 2 Wide R3 Type 3 Wide R3S Type 3 Short R4 Type 4 Wide R4S Type 4 Short R5 Type 5 Wide R5S Type 5 Short AFR Automotive Front Row AFRR90 Automotive Front Row Right Rotated AFRL90 Automotive Front Row Left Rotated	MVOLT (120V-277V) ² HVOLT (347V-480V) ³ XVOLT (277V-480V) ⁴ (use specific voltage for options as noted) 120 ³ 277 ⁵ 208 ³ 347 ⁵ 240 ³ 480 ⁵	SPA Square pole mounting (3.0" min. SQ pole for 1 at 90°, 3.5" min. SQ pole for 2, 3, 4 at 90°) RPA Round pole mounting (3.2" min. dia. RND pole for 2, 3, 4 at 90°, 3.0" min. dia. RND pole for 1 at 90°, 2 at 180°, 3 at 120°) MA Mast arm adaptor (fits 2-3/8" 0D horizontal tenon) IS Adjustable slipfitter (fits 2-3/8" 0D tenon) 6 WBA Wall bracket 1 WBASC Wall bracket with surface conduit box AASP Adjustable tilt arm square pole mounting 6 AARP Adjustable tilt arm round pole mounting 6 AAWB Adjustable tilt arm with wall bracket 6 AAWSC Adjustable tilt arm wall bracket and surface conduit box 6

Options			Finish	
Shipped I HS PE PEX PER7 CE34 SF DF SPD20KV FAO DMG	House-side shield ⁷ Photocontrol, button style ^{8,9} Photocontrol external threaded, adjustable ^{9,10} Seven-wire twist-lock receptacle only (no controls) ^{9,11,12,13} Conduit entry 3/4" NPT (Oty 2) Single fuse (120, 277, 347) ⁵ Double fuse (208, 240, 480) ⁵ 20KV Surge pack (10KV standard) Field adjustable output ^{9,13} 0-10V dimming extend out back of housing for external control (control ordered separate) ^{9,13} Dual switching ^{9,14}	Shipped Installed *Standalone and Networked Sensors/Controls (factory default settings, see table page 9) NLTAIR2	DDBXD DBLXD DNAXD DWHXD DDBTXD DBLBXD DNATXD DWHGXD	Dark Bronze Black Natural Aluminum White Textured Dark Bronze Textured Black Textured Natural Aluminum Textured White



Ordering Information

Accessories

RSX2HS RSX2 House side shield (includes 2 shields) RSX2EGS (FINISH) U External glare shield (specify finish)

RSX2HSAFRR (FINISH) U RSX2 House side shields for AFR rotated optics (includes 2 shields)

RSX2EGEV (FINISH) U External glare full visor (specify finish)

RSXRPA (FINISH) U RSX Universal round pole adaptor plate (specify finish)

RSXWBA (FINISH) U RSX WBA wall bracket (specify finish) 1

RSX Surface conduit box (specify finish, for use with WBA, WBA not included) RSXSCB (FINISH) U Photocell -SSL twist-lock (120-277V) 11

DLL127F 1.5 JU DLL347F 1.5 CUL JU Photocell -SSL twist-lock (347V) 19 DLL480F 1.5 CUL JU Photocell -SSL twist-lock (480V) 19

DSHORT SBK U Shorting cap 19

NOTES

- TES

 Any Type 5 distribution, is not available with WBA.

 MVOLT driver operates on any line voltage from 120-277V (50/60 Hz).

 HVOLT driver operates on any line voltage from 347-480V (50/60 Hz).

 XVOLT driver not available with P1. XVOLT driver operates on any line voltage from 277V-480V (50/60 Hz).

 XVOLT driver not available with PE or PEX.

 Single fuse (SF) requires 120V, 277V or 347V. Double fuse (DF) requires 208V, 240V or 480V.

 Maximum tilt is 90° above horizontal.

 It may be ordered as an accessory.

- ne may be ordered as an accessory.
 Requires MVOLT or 347V.
 Not available in combination with other light sensing control options (following options cannot be combined: PE, PEX, PER7, FAO, DMG, DS, PIRHN).
- Requires 120V, 208V, 240V, or 277V.

- Twistlock photocell ordered and shipped as a separate line item from Acuity Brands Controls. See accessories. Shorting Cap included. Dimming leads capped for future use.
- For units with option PER7, the mounting must be restricted to +/- 45° from horizontal aim per ANSI C136.10-2010.

 Two or more of the following options cannot be combined including DMG, DS, PER7, FAO and PIRHN.
- DS only available on performance package P5 and P6. Must be ordered with PIRHN. Requires MVOLT or HVOLT.

- Must be ordered with NLTAIR2. For additional information on PIRHN
- vistn here.

 Must be ordered with fixture for factory pre-drilling.

 Requires luminaire to be specified with PER7 option. Ordered and shipped as a separate line item from Acuity Brands Controls.

External Shields



House Side Shield



External Glare Shield




External 360 Full Visor


Pole/Mounting Informatiion

Accessories including bullhorns, cross arms and other adpaters are available under the accessories tab at Lithonia's Outdoor Poles and Arms product page. Click here to visit Accessories.


HANDHOLE ORIENTATION

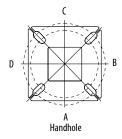

RSX POLE DRILLING

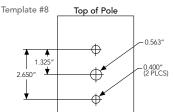

RSX STANDARD ARM & ADJUSTABLE ARM

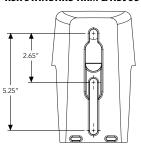

Round Tenon Mount - Pole Top Slipfitters

Tenon O.D.	RSX Mounting	Single	2 at 180°	2 at 90°	3 at 120°	3 at 90°	4 at 90°
2 - 3/8"	RPA, AARP	AS3-5 190	AS3-5 280	AS3-5 290	AS3-5 320	AS3-5 390	AS3-5 490
2 - 7/8"	RPA, AARP	AST25-190	AST25-280	AST25-290	AST25-320	AST25-390	AST25-490
4"	RPA, AARP	AST35-190	AST35-280	AST35-290	AST35-320	AST35-390	AST35-490

Drill/Side Location by Configuration Type

		-		-		_1_	-1-
Drilling Template	Mounting Option	Single	2 @ 180	2 @ 90	3 @ 120	3 @ 90	4 @ 90
	Head Location	Side B	Side B & D	Side B & C	Round Pole Only	Side B, C & D	Side A, B, C & D
#8	Drill Nomenclature	DM19AS	DM28AS	DM29AS	DM32AS	DM39AS	DM49AS

RSX2 - Luminaire EPA


*Includes luminaire and integral mounting arm. Other tenons, arms, brackets or other accessories are not included in this EPA data.


Fixture Quantity & Mo Configuration	unting	Single	2 @ 90	2 @ 180	3 @ 90	3 @ 120	4 @ 90	2 Side by Side	3 Side by Side	4 Side by Side
Mounting Type	Tilt	-	-1		<u>.</u>		+	-		•
SPA - Square Pole Adaptor	0°	0.69	1.22	1.27	1.8	1.61	2.39	1.37	2.06	2.74
RPA - Round Pole Adaptor		0.74	1.27	1.37	1.9	1.71	2.49	1.42	2.16	2.84
MA - Mast Arm Adaptor		0.61	1.14	1.11	1.64	1.45	2.23	1.29	1.9	2.58
	0°	0.69	1.22	1.27	1.8	1.61	2.39	1.37	2.06	2.74
	10°	0.53	1.06	1.05	1.58	1.37	2.08	1.06	1.59	2.12
	20°	0.52	1.02	1.03	1.52	1.33	2.02	1.03	1.55	2.07
	30°	0.64	1.11	1.18	1.63	1.45	2.21	1.27	1.91	2.54
IS - Integral Slipfitter	40°	0.81	1.21	1.35	1.74	1.65	2.39	1.62	2.43	3.23
AASP/AARP - Adjustable	45°	0.91	1.25	1.5	1.81	1.75	2.48	1.82	2.73	3.64
Arm Square/Round Pole	50°	1.34	1.83	2.17	2.61	2.56	3.62	2.68	4.02	5.36
	60°	2.2	2.97	3.57	4.24	4.17	5.89	4.41	6.61	8.82
	70°	2.86	4.13	4.7	5.89	5.71	8.21	5.71	8.57	11.42
	80°	3.4	5.13	5.67	7.34	7.09	10.21	6.79	10.19	13.59
	90°	3.85	5.96	6.55	8.58	8.31	11.88	7.70	11.56	15.41


Photometric Diagrams


To see complete photometric reports or download .ies files for this product, visit Lithonia Lighting's RSX Area homepage.


Isofootcandle plots for the RSX2 LED P6 40K. Distances are in units of mounting height (30').

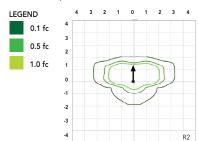


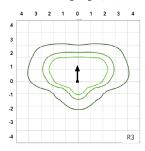


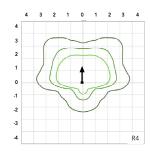

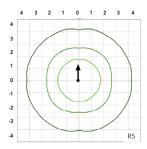

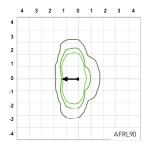

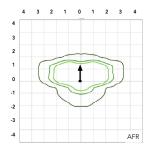

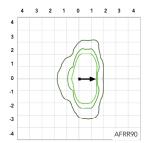

Performance Data

Lumen Ambient Temperature (LAT) Multipliers

Use these factors to determine relative lumen output for average ambient temperatures from 0-50°C (32-122°F).

Ambient	Ambient	Lumen Multiplier
0°C	32°F	1.05
5°C	41°F	1.04
10°C	50°F	1.03
15℃	59°F	1.02
20°C	68°F	1.01
25℃	77°F	1.00
30°C	86°F	0.99
35℃	95°F	0.98
40°C	104°F	0.97
45°C	113°F	0.96
50°C	122°F	0.95

Electrical Load

					nt (A)		
Performance Package	System Watts (W)	120V	208V	240V	277V	347V	480V
P1	71W	0.59	0.34	0.30	0.26	0.20	0.15
P2	111W	0.93	0.53	0.46	0.40	0.32	0.23
P3	147W	1.23	0.70	0.61	0.53	0.42	0.31
P4	187W	1.55	0.90	0.78	0.68	0.53	0.38
P5	210W	1.75	1.01	0.87	0.76	0.60	0.44
P6	244W	2.03	1.17	1.01	0.88	0.70	0.51

Projected LED Lumen Maintenance

Operating Hou	50,000	75,000	100,000
Lumen Maintenance	>0.97	>0.95	>0.92

Values calculated according to IESNA TM-21-11 methodology and valid up to $40^{\circ}\text{C}.$

Performance Data

Lumen Output

Lumen values are from photometric tests performed in accordance with IESNA LM-79-08. Data is considered to be representative of the configurations shown, within the tolerances allowed by Lighting Facts. Contact factory for performance data on any configurations not shown here.

Performance	System Watts	Distribution.			30K K, 70 CR	ll)				40K K, 70 CR	I)				50K K, 70 CR	l)	
Package		Type	Lumens	В	U	G	LPW	Lumens	В	U	G	LPW	Lumens	В	U	G	LPW
		R2	10,040	2	0	1	139	11,031	2	0	1	153	11,031	2	0	1	153
		R3	10,005	2	0	2	141	10,992	2	0	2	155	10,992	2	0	2	155
		R3S	10,271	2	0	2	143	11,285	2	0	2	157	11,285	2	0	2	157
		R4	10,136	2	0	2	143	11,136	2	0	2	157	11,136	2	0	2	157
P1	71W	R4S	9,779	2	0	2	138	10,744	2	0	2	151	10,744	2	0	2	151
		R5	10,271	4	0	2	145	11,285	4	0	2	159	11,285	4	0	2	159
		R5S AFR	10,544 10,026	3	0	1	149 141	11,585 11,016	3	0	1	163 155	11,585 11,016	2	0	1	163 155
		AFRR90	10,020	3	0	2	140	11,010	3	0	2	154	11,121	3	0	2	154
		AFRL90	10,164	3	0	2	141	11,167	3	0	2	155	11,167	3	0	2	155
		R2	15,712	2	0	2	138	17,263	2	0	2	151	17,263	2	0	2	151
		R3	15,657	2	0	3	141	17,202	3	0	3	155	17,202	3	0	3	155
		R3S	16,075	2	0	2	141	17,661	2	0	2	155	17,661	2	0	2	155
		R4	15,862	2	0	3	143	17,427	2	0	3	157	17,427	2	0	3	157
P2	111W	R4S	15,304	2	0	2	138	16,815	2	0	2	151	16,815	2	0	2	151
		R5 R5S	16,075	4	0	2	145	17,661	5	0	3	159	17,661	5	0	3	159
		AFR	16,502 15,691	2	0	2	149 141	18,130 17,240	2	0	2	163 155	18,130 17,240	2	0	2	163 155
		AFRR90	15,841	3	0	3	139	17,240	4	0	3	153	17,404	4	0	3	153
		AFRL90	15,907	3	0	3	139	17,477	4	0	3	153	17,477	4	0	3	153
		R2	19,855	3	0	2	132	21,814	3	0	2	145	21,814	3	0	2	145
		R3	19,785	3	0	3	135	21,737	3	0	4	148	21,737	3	0	4	148
		R3S	20,312	3	0	3	135	22,317	3	0	3	149	22,317	3	0	3	149
		R4	20,044	3	0	3	136	22,022	3	0	4	150	22,022	3	0	4	150
P3	147W	R4S	19,339	3	0	3	132	21,247	3	0	3	145	21,247	3	0	3	145
15	14/11	R5	20,313	5	0	3	138	22,317	5	0	3	152	22,317	5	0	3	152
		R5S	20,852	4	0	2	142	22,910	4	0	2	156	22,910	4	0	2	156
		AFR	19,828	3	0	2	135	21,785	3	0	2	148	21,785	3	0	2	148
		AFRR90	20,017	4	0	3	133	21,992	4	0	3	147	21,992	4	0	3	147
		AFRL90 R2	20,101 22,836	3	0	3	134 120	22,084 25,090	3	0	2	147 132	22,084 25,090	3	0	3	147 132
		R3	22,756	3	0	4	122	25,090	3	0	4	134	25,002	3	0	4	134
		R3S	23,363	3	0	3	123	25,668	3	0	3	135	25,668	3	0	3	135
		R4	23,054	3	0	4	123	25,329	3	0	4	135	25,329	3	0	4	135
D4	107\\	R4S	22,243	3	0	3	119	25,059	3	0	3	134	25,059	3	0	3	134
P4	187W	R5	23,363	5	0	3	125	25,669	5	0	4	137	25,669	5	0	4	137
		R5S	23,983	4	0	2	128	26,350	4	0	2	141	26,350	4	0	2	141
		AFR	22,806	3	0	2	122	25,056	3	0	2	134	25,056	3	0	2	134
		AFRR90	23,023	4	0	3	121	25,295	4	0	3	133	25,295	4	0	3	133
		AFRL90	23,120	4	0	3	122	25,401	4	0	3	134	25,401	4	0	3	134
		R2 R3	26,141 26,049	3	0	4	122 124	28,721 28,620	3	0	4	135 136	28,721 28,620	3	0	4	135 136
		R3S	26,744	3	0	3	124	29,383	3	0	4	138	29,383	3	0	4	138
		R4	26,390	3	0	4	126	28,994	3	0	4	138	28,994	3	0	4	138
		R4S	25,462	3	0	3	121	27,974	3	0	3	133	27,974	3	0	3	133
P5	210W	R5	26,744	5	0	4	127	29,383	5	0	4	140	29,383	5	0	4	140
		R5S	27,454	4	0	2	131	30,163	4	0	2	144	30,163	4	0	2	144
		AFR	26,106	3	0	2	124	28,682	3	0	2	137	28,682	3	0	2	137
		AFRR90	26,354	4	0	3	123	28,955	5	0	3	136	28,955	5	0	3	136
		AFRL90	26,465	4	0	3	124	29,077	5	0	3	136	29,077	5	0	3	136
		R2	27,646	3	0	2	112	30,374	3	0	2	123	30,374	3	0	2	123
		R3	27,549	3	0	4	113	30,267	3	0	4	124	30,267	3	0	4	124
		R3S	28,283	3	0	3	115	31,075	3	0	4	126	31,075	3	0	4	126
		R4 R4S	27,909 26,928	3	0	3	114 110	30,663 29,585	3	0	3	126 121	30,663 29,585	3	0	3	126 121
P6	244W	R5	28,284	5	0	4	116	31,075	5	0	4	127	31,075	5	0	4	127
		R5S	29,035	4	0	2	119	31,073	5	0	3	131	31,900	5	0	3	131
		AFR	27,608	3	0	2	112	30,332	3	0	2	123	30,332	3	0	2	123
		AFRR90	27,872	4	0	3	113	30,622	5	0	3	124	30,622	5	0	3	124
		AFRL90	27,989	4	0	3	113	30,751	5	0	3	125	30,751	5	0	3	125




Dimensions & Weights

Luminaire Weight by Mounting Type


Mounting Configuration	Total Luminaire Weight			
SPA	30 lbs			
RPA	32 lbs			
MA	30 lbs			
WBA	33 lbs			
WBASC	36 lbs			
IS	33 lbs			
AASP	33 lbs			
AARP	35 lbs			
AAWB	36 lbs			
AAWSC	39 lbs			

RSX2 with Round Pole Adapter (RPA)

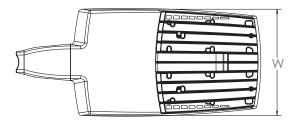


Length: 30.3" (77.0 cm) Width: 13.4" (34.0 cm)

Height: 3.0" (7.6 cm) Main Body 7.2" (18.3 cm) Arm

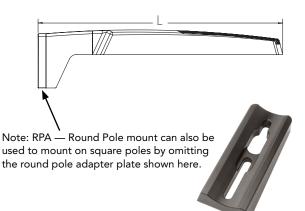





RSX2 with Mast Arm Adapter (MA)

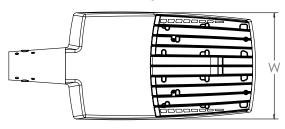


Length: 30.6" (77.7 cm) Width: 13.4" (34.0 cm) Height: 3.0" (7.6 cm) Main Body 3.5" (8.9 cm) Arm

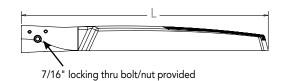


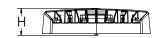


RSX2 with Adjustable Slipfitter (IS)

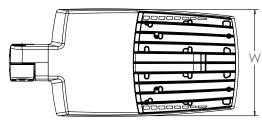



Length: 28.3" (71.9 cm) Width: 13.4" (34.0 cm) Height: 3.0" (7.6 cm) Main Body 7.6" (19.3 cm) Arm

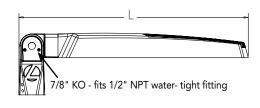


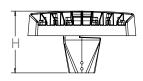


RSX2 with Wall Bracket (WBA)

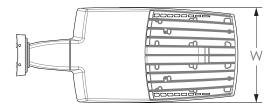


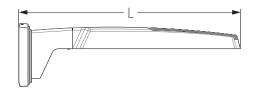


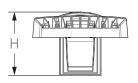

Wall Bracket (WBA) Mounting Detail

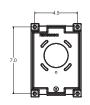

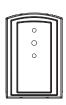


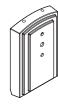



Length: 31.2" (79.2 cm) Width: 13.4" (41.7 cm)

Height: 3.0" (7.6 cm) Main Body 8.9" (22.6 cm) Arm


RSX2 with Wall Bracket with Surface Conduit Box (WBASC)

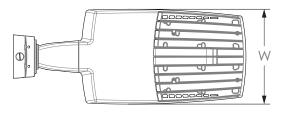


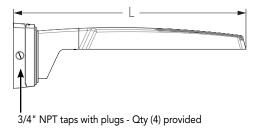

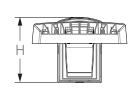

Surface Conduit Box (SCB) Mounting Detail

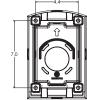

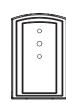





Length: 32.8" (83.3 cm) Width: 13.4" (41.7 cm) Height: 3.0" (7.6 cm) Main Body


9.2" (23.4 cm) Arm



RSX2 with Adjustable Tilt Arm - Square or Round Pole (AASP or AARP)

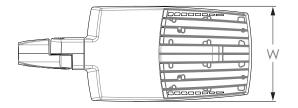

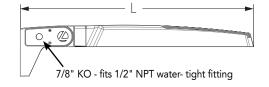

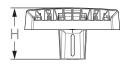

Length: 32.8" (83.3 cm) AASP 33.8" (85.9 cm) AARP Width: 13.4" (34.0 cm)

Height: 3.0" (7.6 cm) Main Body 7.2" (18.2 cm) Arm





Notes


AASP: Requires 3.0" min. square pole for 1 at 90°. Requires 3.5" min. square pole for mounting 2, 3, 4 at 90°.


AARP: Requires 3.2" min. dia. round pole for 2, 3, 4 at 90°. Requires 3.0" min. dia. round pole for mounting 1 at 90°, 2 at 180°, 3 at 120°.

RSX2 with Adjustable Tilt Arm with Wall Bracket (AAWB)

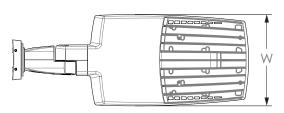

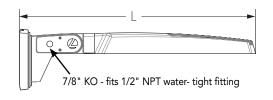

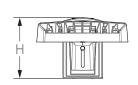

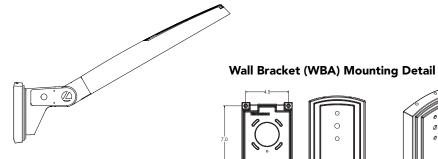


Length: 34.7" (88.0 cm) Width: 13.4" (34.0 cm)


Height: 3.0" (7.6 cm) Main Body 8.9" (22.6 cm) Arm



RSX2 with Adjustable Tilt Arm with Wall Bracket and Surface Conduit Box (AAWSC)

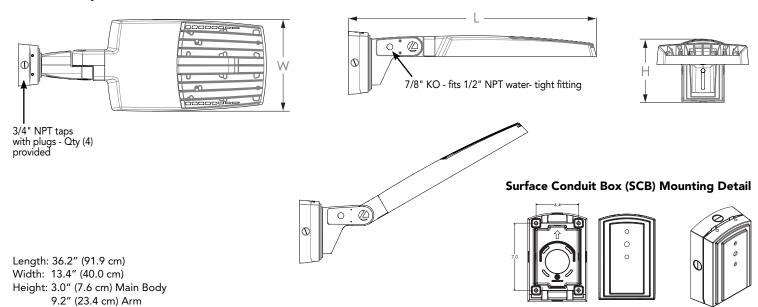

Additional Reference Drawings

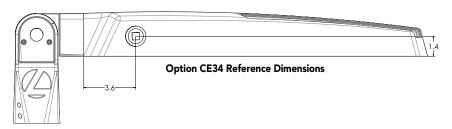


Automotive Front Row - Rotated Optics (AFRL90/R90) AFRR90 AFRR90


(Example: 2@180 - arrows indicate direction of light exiting the luminaire)


nLight Control - Sensor Coverage and Settings

NLTAIR2 PIRHN nLight Sensor Coverage Pattern

nLight PIRHN

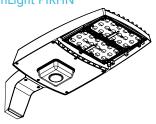

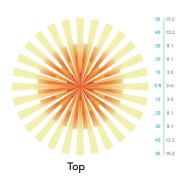

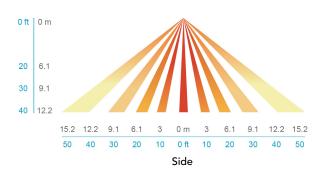

	Motion Sensor Default Settings - Option PIRHN							
Option	Dimmed State (unoccupied)	High Level (when occupied)	Photocell Operation	Dwell Time (occupancy time delay)	Ramp-up Time (from unoccupied to occupied)	Ramp-down Time (from occupied)		
NLTAIR2 PIR	HN Approx. 30% Output	100% Output	Enabled @ 1.5FC	7.5 minutes	3 seconds	5 minutes		

*Note: NLTAIR2 PIRHN default settings including photocell set-point, high/low dim rates, and occupancy sensor time delay are all configurable using the Clairity Pro App. Sensor coverage pattern shown with luminaire at 0°. Sensor coverage pattern is affected when luminaire is titled.

FEATURES & SPECIFICATIONS

INTENDED USE

The RSX LED area family is designed to provide a long-lasting, energy-efficient solution for the one-forone replacement of existing metal halide or high pressure sodium lighting. The RSX2 delivers 11,000 to 31,000 lumens and is ideal for replacing 250W to 1000W HID pole-mounted luminaires in parking lots and other area lighting applications.

CONSTRUCTION AND DESIGN

The RSX LED area luminaire features a rugged die-cast aluminum main body that uses heat-dissipating fins and flow-through venting to provide optimal thermal management that both enhances LED performance and extends component life. Integral "no drill" mounting arm allows the luminaire to be mounted on existing pole drillings, greatly reducing installation labor. The light engines and housing are sealed against moisture and environmental contaminants to IP66. The low-profile design results in a low EPA, allowing pole optimization. Vibration rated per ANSI C136.31: 3G Mountings: Include SPA, RPA, MA, IS, AASP, AARP rated for 3G vibration. 1.5G Mountings: Include WBA, WBASC, AAWB and AAWSC rated for 1.5G vibration.

FINISH

Exterior parts are protected by a zinc-infused Super Durable TGIC thermoset powder coat finish that provides superior resistance to corrosion and weathering. A tightly controlled multi-stage process ensures superior adhesion as well as a minimum finish thickness of 3 mils. The result is a high-quality finish that is warrantied not to crack or peel.

OPTICS

Precision acrylic refractive lenses are engineered for superior application efficiency, distributing the light to where it is needed most. Available in short and wide pattern distributions including Type 2, Type 3, Type 45, Type 45, Type 5, Type 55, AFR (Automotive Front Row) and AFR rotated AFRR90 and ARFL90.

ELECTRICA

Light engine(s) configurations consist of high-efficacy LEDs mounted on metal-core circuit boards and aluminum heat sinks to maximize heat dissipation. Light engines are IP66 rated. LED lumen maintenance is >192/100,000 hours. CCT's of 3000K, 4000K and 5000K (minimum 70 CRI) are available. Class 1 electronic drivers ensure system power factor >90% and THD <20%. Easily serviceable 10kV surge protection device meets a minimum Category C Low operation (per ANSI/IEEE C62.41.2).

STANDARD CONTROLS

The RSX LED area luminaire has a wide assortment of control options. Dusk to dawn controls include MVOLT and 347V button-type photocells and NEMA twist-lock photocell receptacles.

nLIGHT AIR CONTROLS

The RSX LED area luminaire is also available with nLight® AIR for the ultimate in wireless control. This powerful controls platform provides out-of-the-box basic motion sensing with photocontrol functionality and is suitable for mounting heights up to 40 feet. No commissioning is required when using factory default settings that provide basic stand-alone motion occupancy dimming that is switched on and off with a built-in photocell. See chart above for motion sensor default out-of-box settings. For more advanced wireless functionality, such as group dimming, nLight AIR can be commissioned using a smartphone and the easy-to-use CLAIRITY app. nLight AIR equipped luminaries can be grouped, resulting in motion sensor and photocell group response without the need for additional equipment. Scheduled dimming with motion sensor over-ride can be achieved when used with the nLight Eclypse. Additional information about nLight Air can be found here.

INSTALLATION

Integral "no-drill" mounting arm allows for fast, easy mounting using existing pole drillings. Select the "SPA" option for square poles and the "RPA" option to mount to round poles. Note, the RPA mount can also be used for mounting to square poles by omitting the RPA adapter plate. Select the "MA" option to attach the luminaire to a 2 3/8" horizontal mast arm or the "IS" option for an adjustable slipfitter that mounts on a 2 3/8" OD tenon. The adjustable slipfitter has an integral junction box and offers easy installation. Can be tilted up to 90° above horizontal. Additional mountings are available including a wall bracket, adjustable tilt arm for direct-to-pole and wall and a surface conduit box for wall mount applications.

LISTINGS

CSA Certified to meet U.S. and Canadian standards. Suitable for wet locations. Rated for -40°C minimum ambient. DesignLights Consortium® (DLC) Premium qualified product and DLC qualified product. Not all versions of this product may be DLC Premium qualified or DLC qualified. Please check the DLC Qualified Products List at www.designlights.org/QPL to confirm which versions are qualified.

International Dark-Sky Association (IDA) Fixture Seal of Approval (FSA) is available for all products on this page utilizing 3000K color temperature only. US Patent No. D882, 146S

BUY AMERICAN

Product with the BAA option is assembled in the USA and meets the Buy America(n) government procurement requirements under FAR, DFARS and DOT.

Please refer to www.acuitybrands.com/buy-american for additional information.

WARRANTY

5-year limited warranty. Complete warranty terms located at:

Note: Actual performance may differ as a result of end-user environment and application. All values are design or typical values, measured under laboratory conditions at 25 °C. Specifications subject to change without notice.





ARC2 LED Architectural Wall Luminaire














Specifications

Depth (D1): 9.25" Depth (D2): 7.5" Height: 5" Width: 14" Weight:

11 lbs (without options)



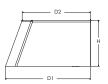

Catalog Notes Туре

Introduction

The Lithonia Lighting ARC LED wall-mounted luminaires provide both architectural styling and visually comfortable illumination while providing the high energy savings and low initial costs for quick financial payback.

ARC2 delivers up to 6,500 lumens with a soft, non-pixelated light source, creating a visually comfortable environment. It offers integrated emergency battery backup options, including an 8W cold temperature option, making it suitable for pedestrian scale applications in any environment.

ARC LED Family Overview

Luminaira	Standard EM 0°C	Cold EM, -20°C	Approximate Lumens (4000K)							
Luminaire	Luminaire Standard EM, 0°C		P1	P2	Р3	P4	P5			
ARC1 LED	4W		1,500	2,000	3,000					
ARC2 LED	4W	8W	1,500	2,000	3,000	4,000	6,500			

Ordering Information

EXAMPLE: ARC2 LED P2 40K MVOLT PE DDBXD

Series	Package	Color Temperature	Voltage	Options	Finish
ARC2 LED	P1 1,500 Lumens P2 2,000 Lumens P3 3,000 Lumens P4 4,000 Lumens P5 6,500 Lumens	30K 3000K 40K 4000K 50K 5000K	MVOLT 347 ¹	E4WH Emergency battery backup, CEC compliant (4W, 0°C min) ¹ E8WC Emergency battery backup, CEC compliant (8W, -20°C min) ² PE Button type photocell for dusk-to-dawn operation DMG 0-10V dimming wires pulled outside fixture (for use with an external control, ordered separately) ² SPD6KV 6kV surge protection ¹ FAO Field adjustable light output device. Allows for easy adjustment to the desired light levels, from 20% to 100% ²	DNAXD Natural aluminum DWHXD White DSSXD Sandstone DDBTXD Textured dark bronze DBLRXD Textured black

Accessories

COMMERCIAL OUTDOOR

WSBBW DDBXD U Surface - mounted back box (specify finish)

NOTES

- 347V not available with E4WH, E8WC and SPD6KV.
- 2 FAO not available with DMG.



Performance Data

Lumen Output

Lumen values are from photometric tests performed in accordance with IESNA LM-79-08. Data is considered to be representative of the configurations shown, within the tolerances allowed by Lighting Facts. Contact factory for performance data on any configurations not shown here.

Performance System Watte 30K (3000K, 80 CRI)				40K (4000K, 80 CRI)				50K (5000K, 80 CRI)								
Package	System Watts	Lumens	LPW	В	U	G	Lumens	LPW	В	U	G	Lumens	LPW	В	U	G
P1	11W	1,502	142	0	0	1	1,587	150	0	0	1	1,598	151	0	0	1
P2	16W	2,250	140	0	0	1	2,377	147	0	0	1	2,393	148	0	0	1
P3	24W	3,206	135	0	0	1	3,387	143	0	0	1	3,410	144	0	0	1
P4	30W	3,903	128	1	0	1	4,124	136	1	0	1	4,152	136	1	0	1
P5	51W	6,260	122	1	0	1	6,615	129	1	0	1	6,659	130	1	0	1

Electrical Load

Performance	Custom Watte	Current (A)								
Package	System Watts	120V	208V	240V	277V	347V				
P1	11W	0.090	0.055	0.049	0.046	0.045				
P2	16W	0.141	0.081	0.072	0.064	0.059				
P3	24W	0.202	0.117	0.103	0.091	0.079				
P4	30W	0.280	0.162	0.144	0.128	0.095				
P5	51W	0.471	0.272	0.239	0.212	0.158				

Lumen Output in Emergency Mode (4000K, 80 CRI)

Option	Lumens
E4WH	693
E8WC	1,413

Lumen Ambient Temperature (LAT) Multipliers

Use these factors to determine relative lumen output for average ambient temperatures from 0-40 $^{\circ}\text{C}$ (32-104 $^{\circ}\text{F}).$

Amb	Lumen Multiplier	
0°C	32°F	1.04
10°C	50°F	1.03
20°C	68°F	1.01
25°C	77°F	1.00
30°C	86°F	0.99
40°C	104°F	0.97


Projected LED Lumen Maintenance


Data references the extrapolated performance projections for the platforms noted in a 25°C ambient, based on 10,000 hours of LED testing (tested per IESNA LM-80-08 and projected per IESNA TM-21-11). To calculate LLF, use the lumen maintenance factor that corresponds to the desired number of operating hours below. For other lumen maintenance values, contact factory.

Operating Hours	0	25,000	50,000	100,000
Lumen Maintenance Factor	1.0	>0.96	>0.93	>0.88

Photometric Diagrams

To see complete photometric reports or download .ies files for this product, visit the Lithonia Lighting ARC LED homepage. Tested in accordance with IESNA LM-79 and LM-80 standards.

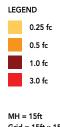

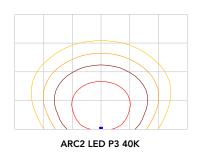

COMMERCIAL OUTDOOR

Grid = 15ft x 15ft

Emergency Egress Options


Emergency Battery Backup

The emergency battery backup is integral to the luminaire — no external housing required! This design provides reliable emergency operation while maintaining the aesthetics of the product. All emergency battery backup configurations include an independent secondary driver with an integral relay to immediately detect loss of normal power and automatically energize the luminaire. The emergency battery will power the luminaire for a minimum duration of 90 minutes (maximum duration of three hours) from the time normal power is lost and maintain a minimum of 60% of the light output at the end of 90minutes.


Applicable codes: NFPA 70/NEC - section 700.16, NFPA 101 Life Safety Code Section 7.9

The example below shows illuminance of 1 fc average and 0.1 fc minimum in emergency mode.


 $Grid = 10ft \times 10ft$

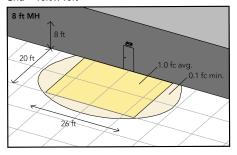

ARC2 LED 40K MVOLT E4WH

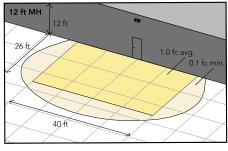

ARC2 LED 40K MVOLT E8WC

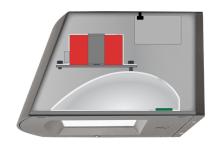

Self-contained solution for clean aesthetic

Mounting, Options & Accessories



E4WH and E8WC - Emergency Battery Backup

D = 6.5''

H = 5"

W = 11"



BBW - Standard Back Box

D = 1.5"

H = 4"

W = 5.5"

For surface conduit applications. 3/4" conduit entry holes.

FEATURES & SPECIFICATIONS

INTENDED USE

The clean architectural shape of the ARC LED was designed for applications such as hospitals, schools, malls, restaurants, and commercial buildings. The long-life LEDs and driver make this luminaire nearly maintenance-free.

CONSTRUCTION

The die-cast aluminum housing and door act as heat sinks to optimize thermal transfer from the light engine and driver to promote long-life. The die-cast door frame is fully gasketed with a one-piece solid silicone gasket to keep out moisture and dust, providing an IP65 rating for the luminaire.

FINISH

Exterior painted parts are protected by a zinc-infused Super Durable TGIC thermoset powder coat finish that provides superior resistance to corrosion and weathering. A tightly controlled multi-stage process ensures a 3 mils thickness for a finish that can withstand extreme climate changes without cracking or peeling. Standard Super Durable colors include dark bronze, black, natural aluminum, sandstone and white. Available in textured and non-textured finishes.

OPTICS

Recessed lens to cut off high angle light and reduce glare. Combination of diffused lens and reflector design has low surface brightness creating a visually comfortable environment with great distribution. LEDs are fully hidden from view to eliminate pixelization and harsh glare. The ARC LED has zero uplight and qualifies as a Nighttime Friendly™ product, meaning it is consistent with the LEED® and Green Globes™ criteria for eliminating wasteful uplight.

ELECTRICAL

Light engine consists of high-efficacy LEDs mounted to metal-core circuit boards to maximize heat dissipation and promote long-life (up to L88/100,000 hours at 25°C). The electronic driver has a power factor of >90%, THD <20%. Luminaire is 0-10V dimmable.

INSTALLATION

The universal wall plate, supplied with the luminaire, fits multiple size junction boxes and supports it during wiring for easy installation. Built-in wet location wiring compartment on the luminaire to accommodate wiring connections for applications with no junction box. Design can withstand up to a 1.5 G vibration load rating per ANSI C136.31.

LISTINGS


CSA certified to U.S. and Canadian standards. Luminaire is IP65 rated. DesignLights Consortium® (DLC) Premium qualified product and DLC qualified product. Not all versions of this product may be DLC Premium qualified or DLC qualified. Please check the DLC Qualified Products List at www.designlights.org/QPL to confirm which versions are qualified. International DarkSky Association (IDA) Fixture Seal of approval (FSA) is available for all products on this page utilizing 3000K color temperature only. Rated for -40°C minimum ambient.

WARRANTY

5-year limited warranty. Complete warranty terms located at: www.acuitybrands.com/support/warranty/terms-and-conditions

Note: Actual performance may differ as a result of end-user environment and application. All values are design or typical values, measured under laboratory conditions at 25 °C. Specifications subject to change without notice.



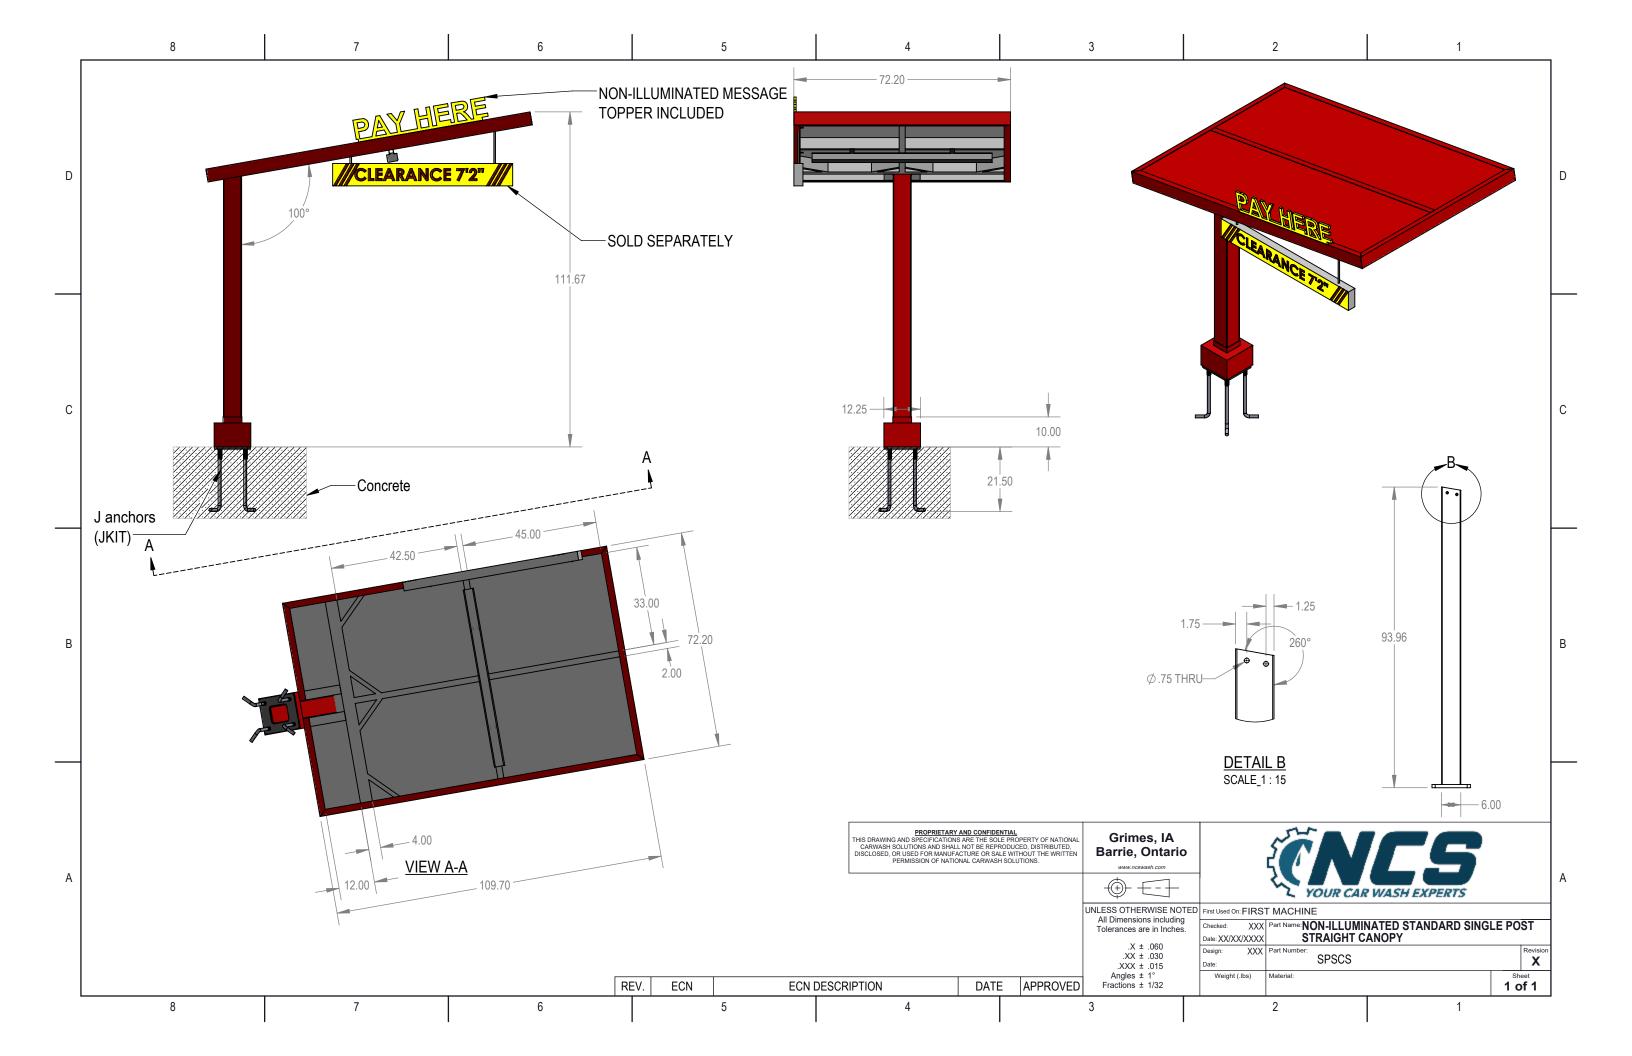



FEATURES & SPECIFICATIONS

INTENDED USE — **These specifications are for USA standards only.** Square Straight Steel is a general purpose light pole for up to 39-foot mounting heights. This pole provides a robust yet cost effective option for mounting area lights and floodlights.

CONSTRUCTION — **Pole Shaft:** The pole shaft is of uniform dimension and wall thickness and is made of a weldable-grade, hot-rolled, commercial-quality steel tubing with a minimum yield of 55 KSI (11-gauge, .1196"), or 50 KSI (7-gauge, .1793"). Shaft is one-piece with a full-length longitudinal high-frequency electric resistance weld. Uniformly square in cross-section with flat sides, small corner radii and excellent torsional qualities. Available shaft widths are 4", 5" and 6".

Pole Top: A flush non-metalic black top cap is provided for all poles that will receive drilling patterns for side-mount luminaire arm assemblies or when ordered with PT option.

Handhole: A reinforced handhole with grounding provision is provided at 18" from the base on side A. Positioning the handhole lower may not be possible and requires engineering review; consult Tech Support-Outdoor for further information. Every handhole includes a cover and cover attachment hardware. The handhole has a nominal dimension of 2.5" x 5".

Base Cover: A durable ABS plastic two-piece full base cover, finished to match the pole, is provided with each pole assembly. Additional base cover options are available upon request.

Anchor Base/ Bolts: Anchor base is fabricated from steel that meets ASTM A36 standards and can be altered to match existing foundations; consult factory for modifications. Anchor bolts are manufactured to ASTM F1554 Standards grade 55, (55 KSI minimum yield strength and tensile strength of 75-95 KSI). Top threaded portion (nominal 12") is hot-dipped galvanized per ASTM A-153.

HARDWARE – All structural fasteners are high-strength galvanized carbon steel. All non-structural fasteners are galvanized or zinc-plated carbon steel or stainless steel.

FINISH – Extra durable standard powder-coat finishes include Dark Bronze, White, Black, Medium Bronze and Natural Aluminum colors. Classic finishes include Sandstone, Charcoal Gray, Tennis Green, Bright Red and Steel Blue colors. Architectural Colors and Special Finishes are available by quote and include, but are not limited to Hot-dipped Galvanized, Paint over Hot-dipped Galvanized, RAL Colors, Custom Colors and Extended Warranty Finishes. Factory-applied primer paint finish is available for customer field-paint applications.


BUY AMERICAN – Product with the BAA option is assembled in the USA and meets the Buy America(n) government procurement requirements under FAR, DFARS and DOT. Please refer to www.acuitybrands.com/buy-american for additional information.

INSTALLATION — **Do not** erect poles without having fixtures installed. Factory-supplied templates must be used when setting anchor bolts. Lithonia Lighting will not accept claim for incorrect anchorage placement due to failure to use Lithonia Lighting factory templates. If poles are stored outside, all protective wrapping must be removed immediately upon delivery to prevent finish damage. Lithonia Lighting is not responsible for the foundation design.

WARRANTY — 1-year limited warranty. Complete warranty terms located at: www.acuitybrands.com/support/warranty/terms-and-conditions

NOTE: Actual performance may differ as a result of end-user environment and application. Specifications subject to change without notice.

Catalog Number	
Notes	
Туре	

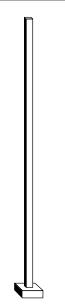

Anchor Base Poles

SSS

SQUARE STRAIGHT STEEL



ORDERING INFORMATION

Lead times will vary depending on options selected. Consult with your sales representative.

Example: SSS 20 5C DM19 DDB					

SSS						
Series	Nominal fixture mounting height	Nominal shaft base size/wall thickness ²	Mounting ³		Options	Finish 11
SSS1	10'-39' (for 1/2 ft increments, add -6 to the pole height. Ex: 20-6 equals 20ft 6in.) See technical information table for complete ordering information.)	4C 4" 11g (.1196") 4G 4" 7g (.1793") 5C 5" 11g (.1196") 5G 5" 7g (.1793") 6G 6" 7g (.1793") See technical information table for complete ordering information.)	PT Open top (includes top cap) T20 2-3/8" O.D. (2" NPS) T25 2-7/8" O.D. (2-1/2" NPS) T30 3-1/2" O.D. (3" NPS) T35 4" O.D. (3-1/2" NPS) KAC/KAD/KSE/KSF/KVR/KVF Drill mounting DM19 1at 90° DM28 2 at 180° DM28 PL 2 at 180° with one side plugged DM29 2 at 90° DM39 3 at 90° DM49 4 at 90° CSX/DSX/RSX/AERIS™/OMERO™/HLA/KAX Drill mounting DM19AS 1 at 90° DM28AS 2 at 180° DM29AS 2 at 180° DM29AS 2 at 90° DM39AS 3 at 90° DM49AS 4 at 90° RAD drill mounting DM19RAD 1 at 90° DM28RAD 2 at 180° DM29RAD 2 at 180° DM29RAD 2 at 90° DM39RAD 3 at 90° DM49AS 4 at 90° ESX Drill mounting DM19ESX 1 at 90° DM28ESX 2 at 180° DM29ESX 2 at 90° DM39ESX 3 at 90° DM39ESX 3 at 90° DM49ESX 2 at 90° DM39ESX 2 at 90° DM39ESX 3 at 90° DM49ESX 2 at 90° DM39ESX 3 at 90° DM49ESX 4 at 90°	AERIS™ Suspend drill mounting 4.5 DM19AST 1 at 90° DM28AST 2 at 180° DM39AST 3 at 90° DM49AST 4 at 90° OMERO™ Suspend drill mounting 4.5 DM19MRT 1 at 90° DM29MRT 2 at 180° DM39MRT 3 at 90° DM49MRT 4 at 90°	Shipped installed VD Vibration damper HAxy Horizontal arm bracket (1 fixture) 6:7 FDLxy Festoon outlet less electrical 6 CPL12/xy 1/2" coupling 6 CPL1/xy 1" coupling 6 CPL1/xy 1" coupling 6 NPL12/xy 1/2" threaded nipple 6 NPL12/xy 3/4" threaded nipple 6 NPL1/xy 1" threaded nipple 6 EHHxy Extra handhole 6:8 NEC NEC 410.30 compliant gasketed handhole (Not UL Labeled) IC Interior coating 9 L/AB Less anchor bolts (Include when anchor bolts are not needed) TP Tamper resistant handhole cover fasteners UL UL listed with label (Includes NEC compliant cover) BAA Buy America(n) Act Compliant 10	DBXD Dark bronze DWHXD White DBLXD Black DMBXD Medium bronze DNAXD Natural aluminum Classic colors DSS Sandstone DGC Charcoal gray DTG Tennis green DBR Bright red DSB Steel blue Architectural Colors and Special Finishes Galvanized, Paint over Galvanized, Paint over Galvanized, RAL Colors, Custom Colors and Extended Warranty Finishes available.

NOTES:

- Handhole covers (HHC), full base covers (FBC) and top caps (TC) shipped separately. No need to call out in nomenclature. For additional parts please order as replacements.
- Wall thickness will be signified with a "C" (11 Gauge) or a "G" (7-Gauge) in nomenclature. "C" 0.1196" | "G" 0.1793".
- 3. PT open top poles include top cap. When ordering tenon mounting and drill mounting for the same pole, follow this example: DM28/T20. The combination includes a required extra handhole.
- 4. Refer to the fixture spec sheet for the correct drilling template pattern and orientation compatibility.
- 5. Insert "1" or "2" to designate fixture size; e.g. DM19AST**2**.
- 6. Specify location and orientation when ordering option.

For "x": Specify the height above the base of pole in feet or feet and inches; separate feet and inches with a "-". Example: 5ft = 5 and 20ft 3in = 20-3

For "y": Specify orientation from handhole (A,B,C,D)
Refer to the Handhole Orientation diagram below.
Example: 1/2" coupling at 5' 8", orientation C = CPL12/5-8C


- Horizontal arm is 18" x 2-3/8" 0.D. tenon standard, with radius curve providing 12" rise and 2-3/8" 0.D. If ordering
 two horizontal arm at the same height, specify with HAxyy. Example: HA20BD.
- Combination of tenon-top and drill mount includes extra handhole. EHH does not include cover, order replacement part if needed.
- 9. Provides enhanced corrosion resistance.
- 10. Use when mill certifications are required.
- Additional colors available; see www.lithonia.com/archcolors or Architectural Colors brochure (Form No. 794.3). Available by formal quote only, consult factory for details.




	TECHNICAL INFORMATION — EPA (ft2) with 1.3 gust												
	Nominal	Pole Shaft Size					EPA (ft²) w	ith 1.3 gust			Bolt		Approximate
Catalog Number	Shaft Length (ft.)*	(Base in. x Top in. x ft.)	Wall thick (in)	Gauge	80 MPH	Max. weight	90 MPH	Max. weight	100 MPH	Max. weight	circle (in)	Bolt size (in. x in. x in.)	ship weight (lbs.)
SSS 10 4C	10	4.0 x 10.0	0.1196	11	30.6	765	23.8	595	18.9	473	89	3/4 x 18 x 3	75
SSS 12 4C	12	4.0 x 12.0	0.1196	11	24.4	610	18.8	470	14.8	370	89	3/4 x 18 x 3	90
SSS 14 4C	14	4.0 x 14.0	0.1196	11	19.9	498	15.1	378	11.7	293	89	3/4 x 18 x 3	100
SSS 16 4C	16	4.0 x 16.0	0.1196	11	15.9	398	11.8	295	8.9	223	89	3/4 x 18 x 3	115
SSS 18 4C	18	4.0 x 18.0	0.1196	11	12.6	315	9.2	230	6.7	168	89	3/4 x 18 x 3	125
SSS 20 4C	20	4.0 x 20.0	0.1196	11	9.6	240	6.7	167	4.5	150	89	3/4 x 18 x 3	140
SSS 20 4G	20	4.0 x 20.0	0.1793	7	14	350	11	275	8	200	89	3/4 x 30 x 3	198
SSS 20 5C	20	5.0 x 20.0	0.1196	11	17.7	443	12.7	343	9.4	235	1012	1 x 36 x 4	185
SSS 20 5G	20	5.0 x 20.0	0.1793	7	28.1	703	21.4	535	16.2	405	1012	1 x 36 x 4	265
SSS 25 4C	25	4.0 x 25.0	0.1196	11	4.8	150	2.6	100	1	50	89	3/4 x 18 x 3	170
SSS 25 4G	25	4.0 x 25.0	0.1793	7	10.8	270	7.7	188	5.4	135	89	3/4 x 30 x 3	245
SSS 25 5C	25	5.0 x 25.0	0.1196	11	9.8	245	6.3	157	3.7	150	1012	1 x 36 x 4	225
SSS 25 5G	25	5.0 x 25.0	0.1793	7	18.5	463	13.3	333	9.5	238	1012	1 x 36 x 4	360
SSS 30 4G	30	4.0 x 30.0	0.1793	7	6.7	168	4.4	110	2.6	65	89	3/4 x 30 x 3	295
SSS 30 5C	30	5.0 x 30.0	0.1196	11	4.7	150	2	50			1012	1 x 36 x 4	265
SSS 30 5G	30	5.0 x 30.0	0.1793	7	10.7	267	6.7	167	3.9	100	1012	1 x 36 x 4	380
SSS 30 6G	30	6.0 x 30.0	0.1793	7	19	475	13.2	330	9	225	1113	1 x 36 x 4	520
SSS 35 5G	35	5.0 x 35.0	0.1793	7	5.9	150	2.5	100			1012	1 x 36 x 4	440
SSS 35 6G	35	6.0 x 35.0	0.1793	7	12.4	310	7.6	190	4.2	105	1113	1 x 36 x 4	540
SSS 39 6G	39	6.0 x 39.0	0.1793	7	7.2	180	3	75			1113	1 x 36 x 4	605


^{*} EPA values are based ASCE 7-93 wind map. For 1/2 ft increments, add -6 to the pole height. Ex: 20-6 equals 20ft 6in.


BASE DETAIL

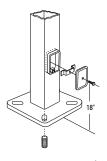

POLE DATA								
Shaft base size	Bolt circle A	Bolt projection B	Base diameter C	Base plate thickness	Template description	Anchor bolt description	Anchor bolt and template number	Anchor bolt description
4"C	8" – 9"	3.25"- 3.75"	8"- 8.25"	0.75"	ABTEMPLATE PJ50004	AB18-0	ABSSS-4C	3/4"x18"x3"
4"G	8" – 9"	3.38"- 3.75"	8"- 8.25"	0.875"	ABTEMPLATE PJ50004	AB30-0	ABSSS-4G	3/4"x30"x3"
5"	10" – 12"	3.5"- 4"	11"	1"	ABTEMPLATE PJ50010	AB36-0	ABSSS-5	1"x36"x4"
6"	11" – 13"	4"- 4.50"	12.5"	1"	ABTEMPLATE PJ50011	AB36-0	N/A	1"x36"x4"

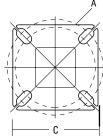

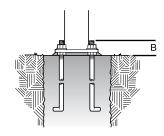

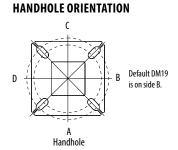

IMPORTANT INSTALLATION NOTES:

- **Do not** erect poles without having fixtures installed.
- Factory-supplied templates must be used when setting anchor bolts. Lithonia Lighting will not accept claim for incorrect anchorage placement due to failure to use Lithonia Lighting factory templates.
- If poles are stored outside, all protective wrapping must be removed immediately upon delivery to prevent finish damage.
- Lithonia Lighting is not responsible for the foundation design.

ITEM #6

DATE: September 21, 2023

TO: Planning Commission

FROM: R. Brent Savidant, Community Development Director

SUBJECT: PRELIMINARY SITE PLAN APPROVAL (JPLN2023-0028) - Proposed John R

Gardens Townhome Development, East side of John R, north of Big Beaver (PIN 88-20-23-476-017), Section 23, Zoned MF (Multi-Family Residential) Zoning District.

The petitioner Troy Sports Center, LLC. submitted the above referenced Preliminary Site Plan application for a 118-unit townhome development. The property is currently zoned MF (Multi-Family) Zoning District. Two-story attached residential units are permitted by right in the MF district. The Planning Commission is responsible for granting Preliminary Site Plan approval for this item.

The attached report prepared by Carlisle/Wortman Associates, Inc. (CWA), the City's Planning Consultant, summarizes the project. CWA prepared the report with input from various City departments including Planning, Engineering, Public Works and Fire. City Management supports the findings of fact contained in the report and the recommendations included therein.

Attachments:

- 1. Maps
- 2. Report prepared by Carlisle/Wortman Associates, Inc.
- 3. Preliminary site plan

G:\SITE PLANS\SP_JPLN2023-0028_JOHN R COMMONS TOWNHOME DEVELOPMENT\PC Memo 2023 09 26.docx

PROPOSED RESOLUTION

PRELIMINARY SITE PLAN APPROVAL (JPLN2023-0028) — Proposed John R Gardens Townhome Development, East side of John R, north of Big Beaver (PIN 88-20-23-476-017), Section 23, Zoned MF (Multi-Family Residential) Zoning District.

Resolution # PC-2023-09-

Moved by: Seconded by:

RESOLVED, That Preliminary Site Plan Approval, pursuant to Article 8 of the Zoning Ordinance, as requested for the proposed John R Gardens Townhome Development, located on the East side of John R, North of Big Beaver, Section 23, Zoned MF (Multi-Family Residential) District, be granted, subject to applicant the following:

- 1. Confirm tree removal and mitigation calculations.
- 2. Consider additional screening options including screen wall in addition to landscaping.
- 3. Show outdoor seating area on the site plan.
- 4. Consider additional outdoor and common amenities to complement the neighborhood atmosphere.
- 5. Provide scalable (CAD) elevations to ensure setbacks are met.
- 6. All architectural drawings shall be sealed and signed by a State of Michigan Professional Architect.
- 7. Indicate location of bicycle parking.
- 8. Provide signage for fire apparatus access roads and indicate access roads on plans.
- 9. Realign crosswalks along northern ring roads.
- 10. Add crosswalks along southern ring road.
- 11. Address OHMs circulation comments.
- 12. Add one (1) large evergreen tree to the western property line landscape screening.
- 13. Add three (3) deciduous trees along the north side of Nancy Bostwick Drive.
- 14. Provide trash enclosure with appropriate screening on site plan OR provide note highlighting individual trash pickup service via weekly pickup.
- 15. Provide full screened building light fixture.
- 16. Provide building elevations on all four sides that are dimensional.
- 17. Provide samples, swatches, or manufacturer's specification sheets of the predominant proposed exterior materials and colors of all buildings and permanent structures, including walls and fences.
- 18. All architectural drawings shall be sealed and signed by a State of Michigan Professional Architect.
- 19. Provide 3-D renderings from John R and internal to the development.

) or
(denied, for the following reasons:) or

MOTION CARRIED/FAILED	
Yes: No:	
(postponed, for the following reasons:)



GIS Online




eet

TROY

1,153

GIS Online

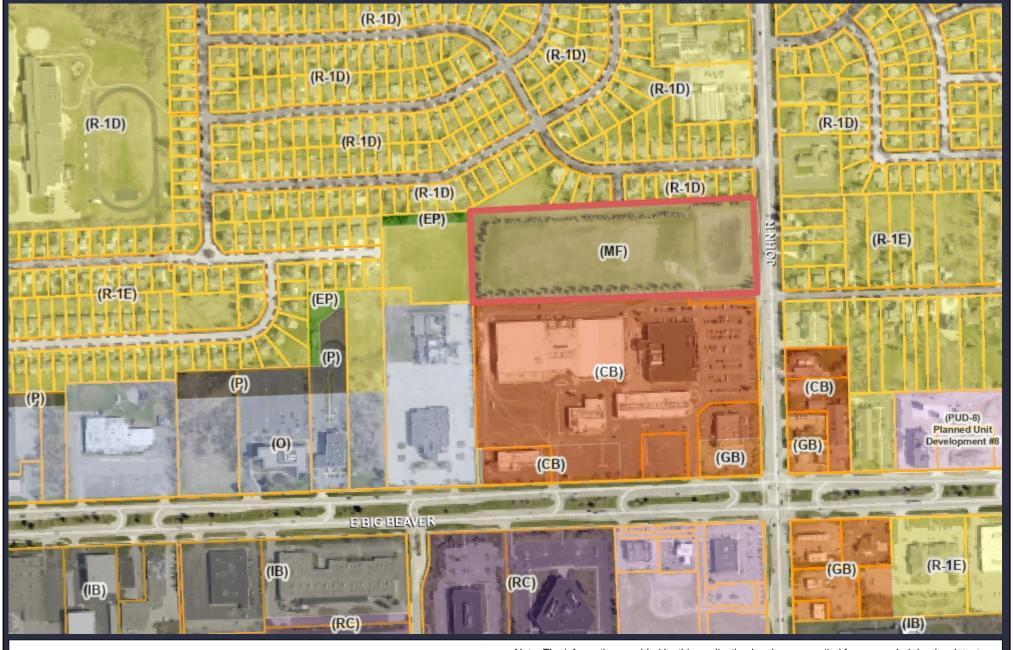

1,153Feet

577

Note: The information provided by this application has been compiled from recorded deeds, plats, tax maps, surveys, and other public records and data. It is not a legally recorded map survey. Users of this data are hereby notified that the source information represented should be consulted for verification.



117 NORTH FIRST STREET SUITE 70 ANN ARBOR, MI 48104 734.662.2200 734.662.1935 FAX

Date: September 18, 2023

Preliminary Site Plan For City of Troy, Michigan

Applicant: Troy Sports Center, LLC & JSD Real Estate, LLC

Project Name: John R Townhome Development

Plan Date: August 18, 2012

Location: Eastside of John R Road, North of Big Beaver

Zoning: MF, Multiple Family Residential

Action Requested: Preliminary Site Plan Approval

PROJECT AND SITE DESCRIPTION

An application has been submitted for a proposed multiple family building on the east side of John R Road just north of Big Beaver. The subject site is 11.86 acres. The site is currently vacant and used in part as stormwater detention.

The applicant is requesting approval of one hundred eighteen (118) units. The one hundred eighteen (118) units are distributed in twenty (20) buildings. The proposed residential use is permitted in the MF, Multiple Family district. The development is accessed via one proposed egress/ingress along Nancy Bostwick Drive as well as a secondary egress/ingress drive located at the western end of the development connecting to the Troy Sports Complex retail center. The site is served with internal private roadways.

The site is currently one parcel. There are no existing structures on the site.

Location of subject site:

East side of John R Road, north of Big Beaver Road.

Location and Aerial Image of Subject Site



Size of subject site:

The property is 11.68 acres in area.

Proposed use of subject site:

The proposed use is for one hundred eighteen (118) units.

John R Townhome Development September 18, 2023

Current use of subject site:

The property currently is vacant.

Current Zoning:

The property is currently zoned MF, Multiple Family Residential District.

Surrounding Property Details:


Direction	Zoning	<u>Use</u>
North	R1-D, One Family Residential District	Single Family Housing
South	CB, Community Business	Retail and Commercial Recreation
East	R1-E, One Family Residential District	Single Family Housing
West	R1-E, One Family Residential District	BWW Soccer Fields (Recreation)

PREVIOUS PLANNING COMMISSION REVIEW


The application was first reviewed by the Planning Commission on Mach 12, 2019, and April 23, 2019. The Planning Commission held discussion on:

- City Traffic Consultant review of site access and circulation; depth and focus of traffic study
- Lack of green space
- Density of urban residential zoning in relation to surrounding areas
- Architectural design, scaled-down transitional features to single family residential
- Comparison of multiple family and urban residential zoning as relates to density, building height, number of stories
- Safety concerns as relates to existing parking, sidewalks, rear access to hockey facility
- Creating a designated lane from existing retail parking to apartment development
- Garages and covered carports
- Water feature and pond
- Snow removal

At the April 23, 2019 meeting, the Planning Commission on a vote of 7-2 moved to recommend denial of the rezoning to the City Council. On the recommendation of the Planning Commission, the City Council denied the rezoning.

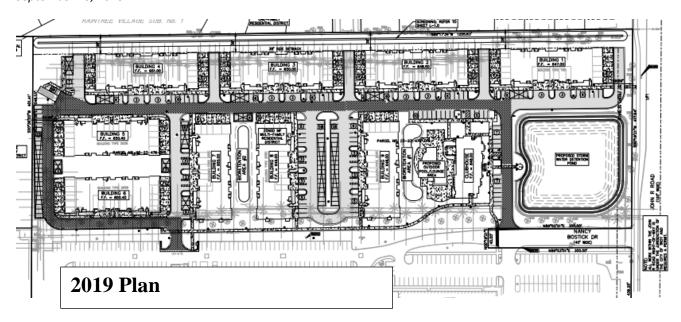

CHANGES SINCE LAST REVIEW

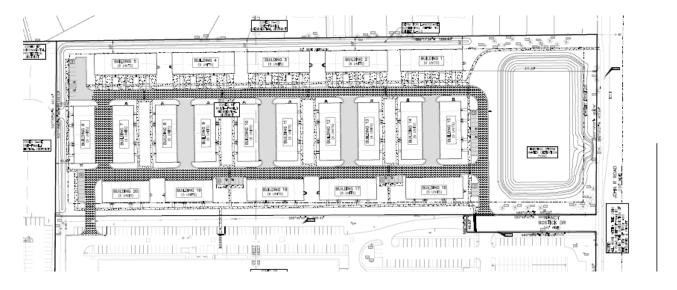

The site plan has significantly changed since the last Planning Commission review:

- Reduced the number of units from 247 to 118 units. By reducing the number of units, the applicant is not seeking a rezoning.
- Aligned the south side of the site with five (5) apartment buildings.
- Reshaped detention pond.
- Eliminated recreational area and clubhouse.
- Reduced height of buildings to 25-feet (see height section for more details).

NATURAL RESOURCES

Topography – The site is relatively flat with minor elevation changes.

Woodlands – The applicant has submitted a tree survey. Trees on site include Bradford Pear, White Spruce, Blue Spruce, Ginkgo, Sugar Maple, Norway Spruce, Silver Maple, Scotch Pine, White Pine, Norway Maple, Weeping Willow, Austrian Pine, Red Pine, and Cottonwood. The Existing Tree List on sheet T-1.2 shows one hundred ninety-one (191) woodland trees, nine (9) invasive trees and sixteen (16) landmark trees currently on the site. We note that it appears that the applicant is removing a number of landmark trees that their table indicates that they are saving. Specifically, trees identified as number 1910-1928. The applicant should confirm tree removal and mitigation calculations.

Wetlands/Floodplain: The site is not encumbered with wetlands or located in a floodplain.

Items to be Addressed: Confirm tree removal and mitigation calculations

SITE ARRANGEMENT

The one hundred eighteen (118) units are distributed in twenty (20) buildings. The development is accessed off Nancy Bostwick Drive which is off John R Road. The site is also served by an entrance/exit via the abutting commercial center to the south. An internal ring-private drive circulates traffic within the site.

Two buildings concepts, "A" and "B" are shown on the architectural sheets. Concept A provides for private garages located in the rear of the unit with access off north/south alley drives. Concept A is proposed for buildings six (6) through twenty (20). Buildings six (6) through fifteen (15) are located along the center of the development running north to south and face the adjacent building. Buildings sixteen (16) though twenty (20) face the southern lot line with garages oriented along the northern end of the units. Concept B provides for private garages located in the front of the unit with access from the primary ring road servicing the site. Concept B is proposed for buildings one (1) through five (5) which are located along the north lot line and face the primary private ring road to the south.

Buildings sixteen (16) through twenty (20) front on the backside of the Kroger parking lot and the backside/loading area/service area of the shopping center. The applicant is proposing to screen this area with a row of spruce evergreens, which complies with minimum screening requirement. We note that in the future residents will likely have concerns about noise, odor, and lighting. The applicant should consider additional screening options, including additional landscaping and a screen wall.

We note that other than sidewalks and a small outdoor seating area (between building 16 and 17), there are no site amenities. Please note that outdoor seating area is shown on the landscape plan but not on the site plan. The site plan should be amended to show the outdoor seating area. In addition, the applicant should consider adding additional outdoor and common amenities to the site.

Items to be Addressed: 1). Consider additional screening options including screen wall in addition to landscaping; 2). Show outdoor seating area on the site plan; and 3). Consider additional outdoor and common amenities to complement the neighborhood atmosphere.

AREA, WIDTH, HEIGHT, SETBACKS

Required and Provided Dimensions:

Table 4.08.C establishes the requirements for the MF, Multiple Family District. The site abuts single family housing to the north which requires stricter height and density regulations. The requirements and the proposed dimensions are as follows:

	Required / Allowed:	<u>Provided:</u>	<u>Compliance:</u>
Front	30 feet	311 feet	Complies
Rear	30 feet	40 feet	Complies
Side (northern property line)	30 feet	30 feet	Complies
Setbacks Adjacent to Residential	Where a property is abutting a one-family or one-family attached district, all setbacks abutting said district shall be equal to the height of the building.	2 stories, (25ft shown on sheet C-2.0 but no height measurement provided on architectural sheets)	Cannot Confirm
Density	10 units an acre	9.95 units an acre	Complies
Maximum Height	2 stories / 25ft	2 stories, (25ft shown on sheet C-2.0 but no height measurement provided on architectural sheets)	Cannot confirm
Maximum Lot Area Covered by Buildings	35%	25.83 %	Complies
Minimum Floor Area per Unit	1,000 sq/ft for three bedroom	Over 1,650-1,750 sq/ft per unit	Complies
Distance between Buildings	30 feet	30 feet – 78 feet	Complies
Recreation Space. (450) square feet per dwelling unit. Such recreational facilities may include, but not be limited to, swimming pools, tennis courts, playgrounds, picnic areas, playfields, and jogging trails.	450 sq/ft x 118 = 53,100 sq/ft.	59,045 sq/ft.	Complies

Sheet C-2.0 details recreation space as "walks, picnic areas, and misc. open space". Sheet L-1.0 details outdoor recreation areas including "pergolas, outdoor seating, and firepits".

John R Townhome Development September 18, 2023

We noted that the applicant has provided black and white renderings but has not provided scalable (CAD) elevations in order for us to confirm building height.

Items to be addressed: (1) Provide scalable (CAD) elevations to ensure setbacks are met. (2) All architectural drawings shall be sealed and signed by a State of Michigan Professional Architect.

SITE ACCESS AND CIRCULATION

Vehicular Access:

Primary site access is directly from Nancy Bostwick Drive with secondary access from the commercial center to the south. Vehicular circulation is provided via an internal drive. The Fire Department notes that the applicant shall provide signage for fire apparatus access roads and indicate access roads on plans.

A traffic study was not required as part of Engineering review.

Pedestrian Circulation:

The applicant is providing a complete pedestrian circulation system within development with access to John R Road, Nancy Bostwick Drive and the commercial center. Four (4) crosswalks along the northern ring road conflict with driveways of buildings two through five. These should be realigned to connect with the northern sidewalk. In addition, the applicant should add crosswalks between buildings seventeen and eighteen and buildings nineteen and twenty that lead from the southern border sidewalk through the greenspace between those buildings north to the common area between buildings seven and eight as well as buildings eleven and twelve.

OHM has reviewed the circulation plan and offers the following additional comments:

- Sidewalk ramps are only provided at some of the crosswalks. These should be provided at all crosswalks.
- The accessible parking spaces should be spaced out throughout the site to provide access for all users. The southwest set of parking spaces does no have any accessible parking spaces provided. Add at least one accessible parking space there.
- It is preferred that sidewalk is not adjacent to the curb/roadway. Providing a buffer space is ideal. This applies to the sidewalk segments between townhomes 7 and 8, 9 and 10, 11 and 12, and 13 and 14.
- The signs for the accessible parking spaces should be placed behind the sidewalk in the grass.
- The driveway in the southwest corner of the site seems to eliminate several parking spaces for the adjacent site. Has this been agreed upon/coordinated with the adjacent site?

Items to be Addressed: 1). Provide signage for fire apparatus access roads and indicate access roads on plans; 2). Realign crosswalks along northern ring roads; 3). Add crosswalks along southern ring road; and 4). Address OHMs circulation comments.

PARKING

Section 13.06.G of the Zoning Ordinance requires:

	Required	Provided
MF Multiple Family: 2 spaces per unit	118 Units = 236 spaces	236 spaces within garages + 41 at-grade guest
		spaces
Barrier Free	8	8
Bicycle Parking	2	0
Loading	0	0
Total	236 automobile + 0 bicycle	277 spaces + 0 bicycle

Details for bike racks are provided on sheet L-1.2 however their location is absent from any site plan sheets.

Items to be Addressed: Indicate location of bicycle parking.

LANDSCAPING

Landscaping is regulated by Section 13.02:

	Required:	<u>Provided:</u>	Compliance:
John R Road and Nancy Bostwick Drive Street Trees: The Ordinance requires that the greenbelt shall be landscaped with a	John R Road 416 feet = 14 trees	14 trees	Complies
minimum of one (1) deciduous tree for every thirty (30) lineal feet, or fraction	NBD 300 feet = 10 trees	7 trees	Does not
thereof, of frontage abutting a public road right-of-way.			comply
Site landscaping: A minimum of twenty (20%) of the site area shall be comprised of landscape material. Up to twenty-five percent (25%) of the required landscape area may be brick, stone, pavers, or other public plaza elements, but shall not include any parking area or required sidewalks.	20%	33%	Complies
Screening between uses: Table 13.02A and 13.02B set forth	North: 126 trees West: 41 trees	North: 126 trees West: 40 trees	Does not comply. One
screening requirements relating to adjacent land uses. Applicant selected one (1) large evergreen tree per ten (10) lineal feet.	South: 96 trees	South: 96 trees	additional tree is needed along west property line
Parking Lot Trees: 1 per 8 spaces	337 spaces = 43 trees	43 trees	Complies

The applicant is proposing planted landscaping for all screening requirements but has indicated existing private fences along the northern property line.

John R Townhome Development September 18, 2023

Grading:

The applicant is proposing a two-to-three-foot berm along the northern and western property line. In addition, the applicant is proposing evergreen planting on top of berm.

<u>Transformer / Trash Enclosure:</u>

No trash enclosures were shown on drawings as well as no notes regarding refuse services.

Equipment:

Mechanical equipment, including HVAC, are not shown on the plans. If placed at grade, applicant should indicate screening.

Items to be Addressed: 1). Add one (1) large evergreen tree to the western property line landscaped screening; 2). Add three (3) deciduous trees along the north side of Nancy Bostwick Drive; and 3). Provide trash enclosure with appropriate screening on site plan OR provide note highlighting individual trash pickup service via weekly pickup.

LIGHTING

The applicant has provided limited lighting details on sheet SL-1.0. The information provided shows the proposed light fixture to be attached to the buildings. There is a note indicating fixtures are to be directed away from neighboring properties and roadways; however we note that the light source of the proposed building light is visible and not screened. Applicant shall replace fixture with full screened fixture.

The applicant is not proposing any parking lot lighting.

Items to be Addressed: Provide full screened building light fixture

FLOOR PLANS AND ELEVATIONS

The applicant has submitted limited floor plans and rendering. Drawings include concept facade elevations only without exterior dimensions. Building materials are not provided. Floor plans are included but only provide general dimensions for larger areas such as bedrooms and living spaces. Dimensions for bathrooms, closets, hallways, etc. are not provided. All architectural drawings are missing seals and signatures.

In addition, the applicant should provide 3-D rendering of the site. The renderings should include a view from John R, as well as internal to the development to confirm if landscaping and berm is sufficient to properly screen existing neighborhood.

Items to be Addressed: 1) Provide building elevations on all four sides that are dimensional; 2). Provide samples, swatches, or manufacturer's specification sheets of the predominant proposed exterior materials and colors of all buildings and permanent structures, including walls and fences; 3). All architectural drawings shall be sealed and signed by a State of Michigan Professional Architect; and 4). Provide 3-D renderings from John R and internal to the development.

SITE PLAN REVIEW STANDARDS

Section 8.06 outlines Site Plan Review Design Standards.

- 1. Development shall ensure compatibility to existing commercial districts and provide a transition between land uses.
 - a. Building design shall enhance the character of the surrounding area in relation to building and parking placement, landscape and streetscape features, and architectural design.
 - b. Street fronts shall provide a variety of architectural expression that is appropriate in its context and prevents monotony.
 - c. Building design shall achieve a compatible transition between areas with different height, massing, scale, and architectural style.
- 2. Development shall incorporate the recognized best architectural building design practices.
 - a. Foster a lasting impact on the community through the provision of high quality design, construction, and detailing.
 - b. Provide high quality, durable materials, such as but not limited to stone, brick, glass, and metal. E.I.F.S. or material equivalent shall only be used as an accent material.
 - c. Develop buildings with creativity that includes balanced compositions and forms.
 - d. Design roofs that are appropriate to the architectural style of the building and create an appropriate visual exterior mass of the building given the context of the site.
 - e. For commercial buildings, incorporate clearly defined, highly visible customer entrances using features such as canopies, porticos, arcades, arches, wing walls, ground plane elements, and/or landscape planters.
 - f. Include community amenities that add value to the development such as patio/ seating areas, water features, art work or sculpture, clock towers, pedestrian plazas with park benches or other features located in areas accessible to the public.
- 3. Enhance the character, environment and safety for pedestrians and motorists.
 - a. Provide elements that define the street and the pedestrian realm.
 - b. Create a connection between the public right of way and ground floor activities.
 - c. Create a safe environment by employing design features to reduce vehicular and pedestrian conflict, while not sacrificing design excellence.
 - d. Enhance the pedestrian realm by framing the sidewalk area with trees, awnings, and other features.
 - e. Improve safety for pedestrians through site design measures.

Items to be Addressed: Planning Commission to consider if site plan standards have been met.

RECOMMENDATIONS

The Planning Commission should review the development and confirm if the site plan standards have been met. If the Planning Commission grants preliminary site plan approval, we recommend that the following items be addressed by the applicant as part of the final site plan submittal.


- 1. Confirm tree removal and mitigation calculations.
- 2. Consider additional screening options including screen wall in addition to landscaping.


- 3. Show outdoor seating area on the site plan.
- 4. Consider additional outdoor and common amenities to complement the neighborhood atmosphere.
- 5. Provide scalable (CAD) elevations to ensure setbacks are met.
- 6. All architectural drawings shall be sealed and signed by a State of Michigan Professional Architect.
- 7. Indicate location of bicycle parking.
- 8. Provide signage for fire apparatus access roads and indicate access roads on plans.
- 9. Realign crosswalks along northern ring roads.
- 10. Add crosswalks along southern ring road.
- 11. Address OHMs circulation comments.
- 12. Add one (1) large evergreen tree to the western property line landscape screening.
- 13. Add three (3) deciduous trees along the north side of Nancy Bostwick Drive.
- 14. Provide trash enclosure with appropriate screening on site plan OR provide note highlighting individual trash pickup service via weekly pickup.
- 15. Provide full screened building light fixture.
- 16. Provide building elevations on all four sides that are dimensional.
- 17. Provide samples, swatches, or manufacturer's specification sheets of the predominant proposed exterior materials and colors of all buildings and permanent structures, including walls and fences.
- 18. All architectural drawings shall be sealed and signed by a State of Michigan Professional Architect.
- 19. Provide 3-D renderings from John R and internal to the development.

CARLISLE/WORTMAN ASSOC., INC. Benjamin R. Carlisle, LEED AP, AICP

JOHN R COMMONS TOWNHOME DEVELOPMENT

PART OF THE 1/4 SECTION 23, T.2N, R.11E CITY OF TROY, OAKLAND COUNTY, MICHIGAN

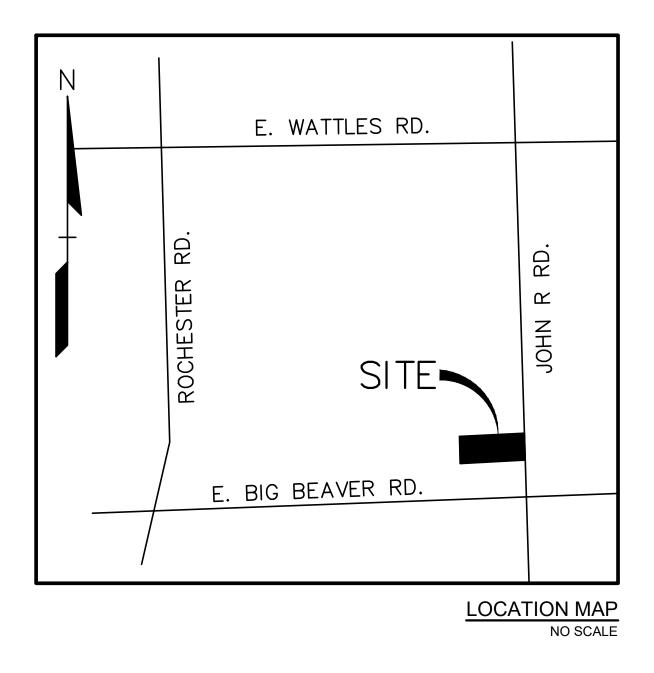

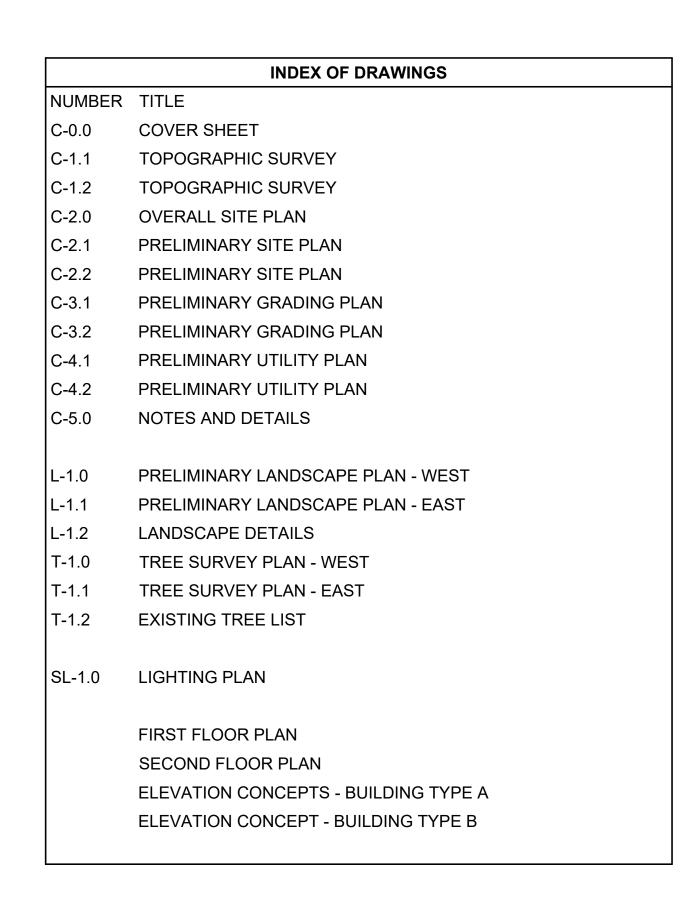

DESIGN TEAM

OWNER/APPLICANT/DEVELOPER

TROY SPORTS CENTER, LLC & JSD REAL ESTATE, LLC
1819 EAST BIG BEAVER ROAD
TROY, MI 48083
CONTACT: DENNIS BOSTICK
PHONE: 248.709.4001
EMAIL: DENNISBOSTICK@ATT.NET

ARCHITECT

BRIAN NEEPER ARCHITECTURE P.C. 630 N. OLD WOODWARD SUITE 203 BIRMINGHAM, MI 48009 CONTACT: BRIAN NEEPER PHONE: 248.259.1784


CIVIL ENGINEER

PEA GROUP 1849 POND RUN AUBURN HILLS, MI 48326 CONTACT: GREG BONO, PE PHONE: 844.813.2949 EMAIL: GBONO@PEAGROUP.COM


LANDSCAPE ARCHITECT

PEA GROUP 7927 NEMCO WAY, STE. 115 BRIGHTON, MI 48116 CONTACT: JEFF SMITH, PLA, LEED AP PHONE: 844.813.2949 EMAIL: JSMITH@PEAGROUP.COM

PENA GROUP

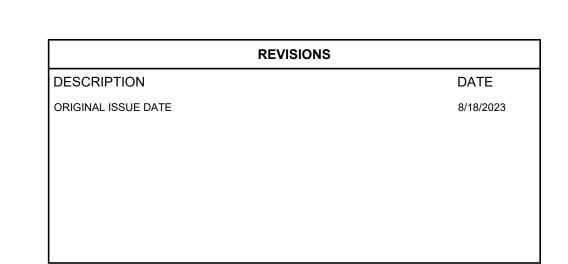




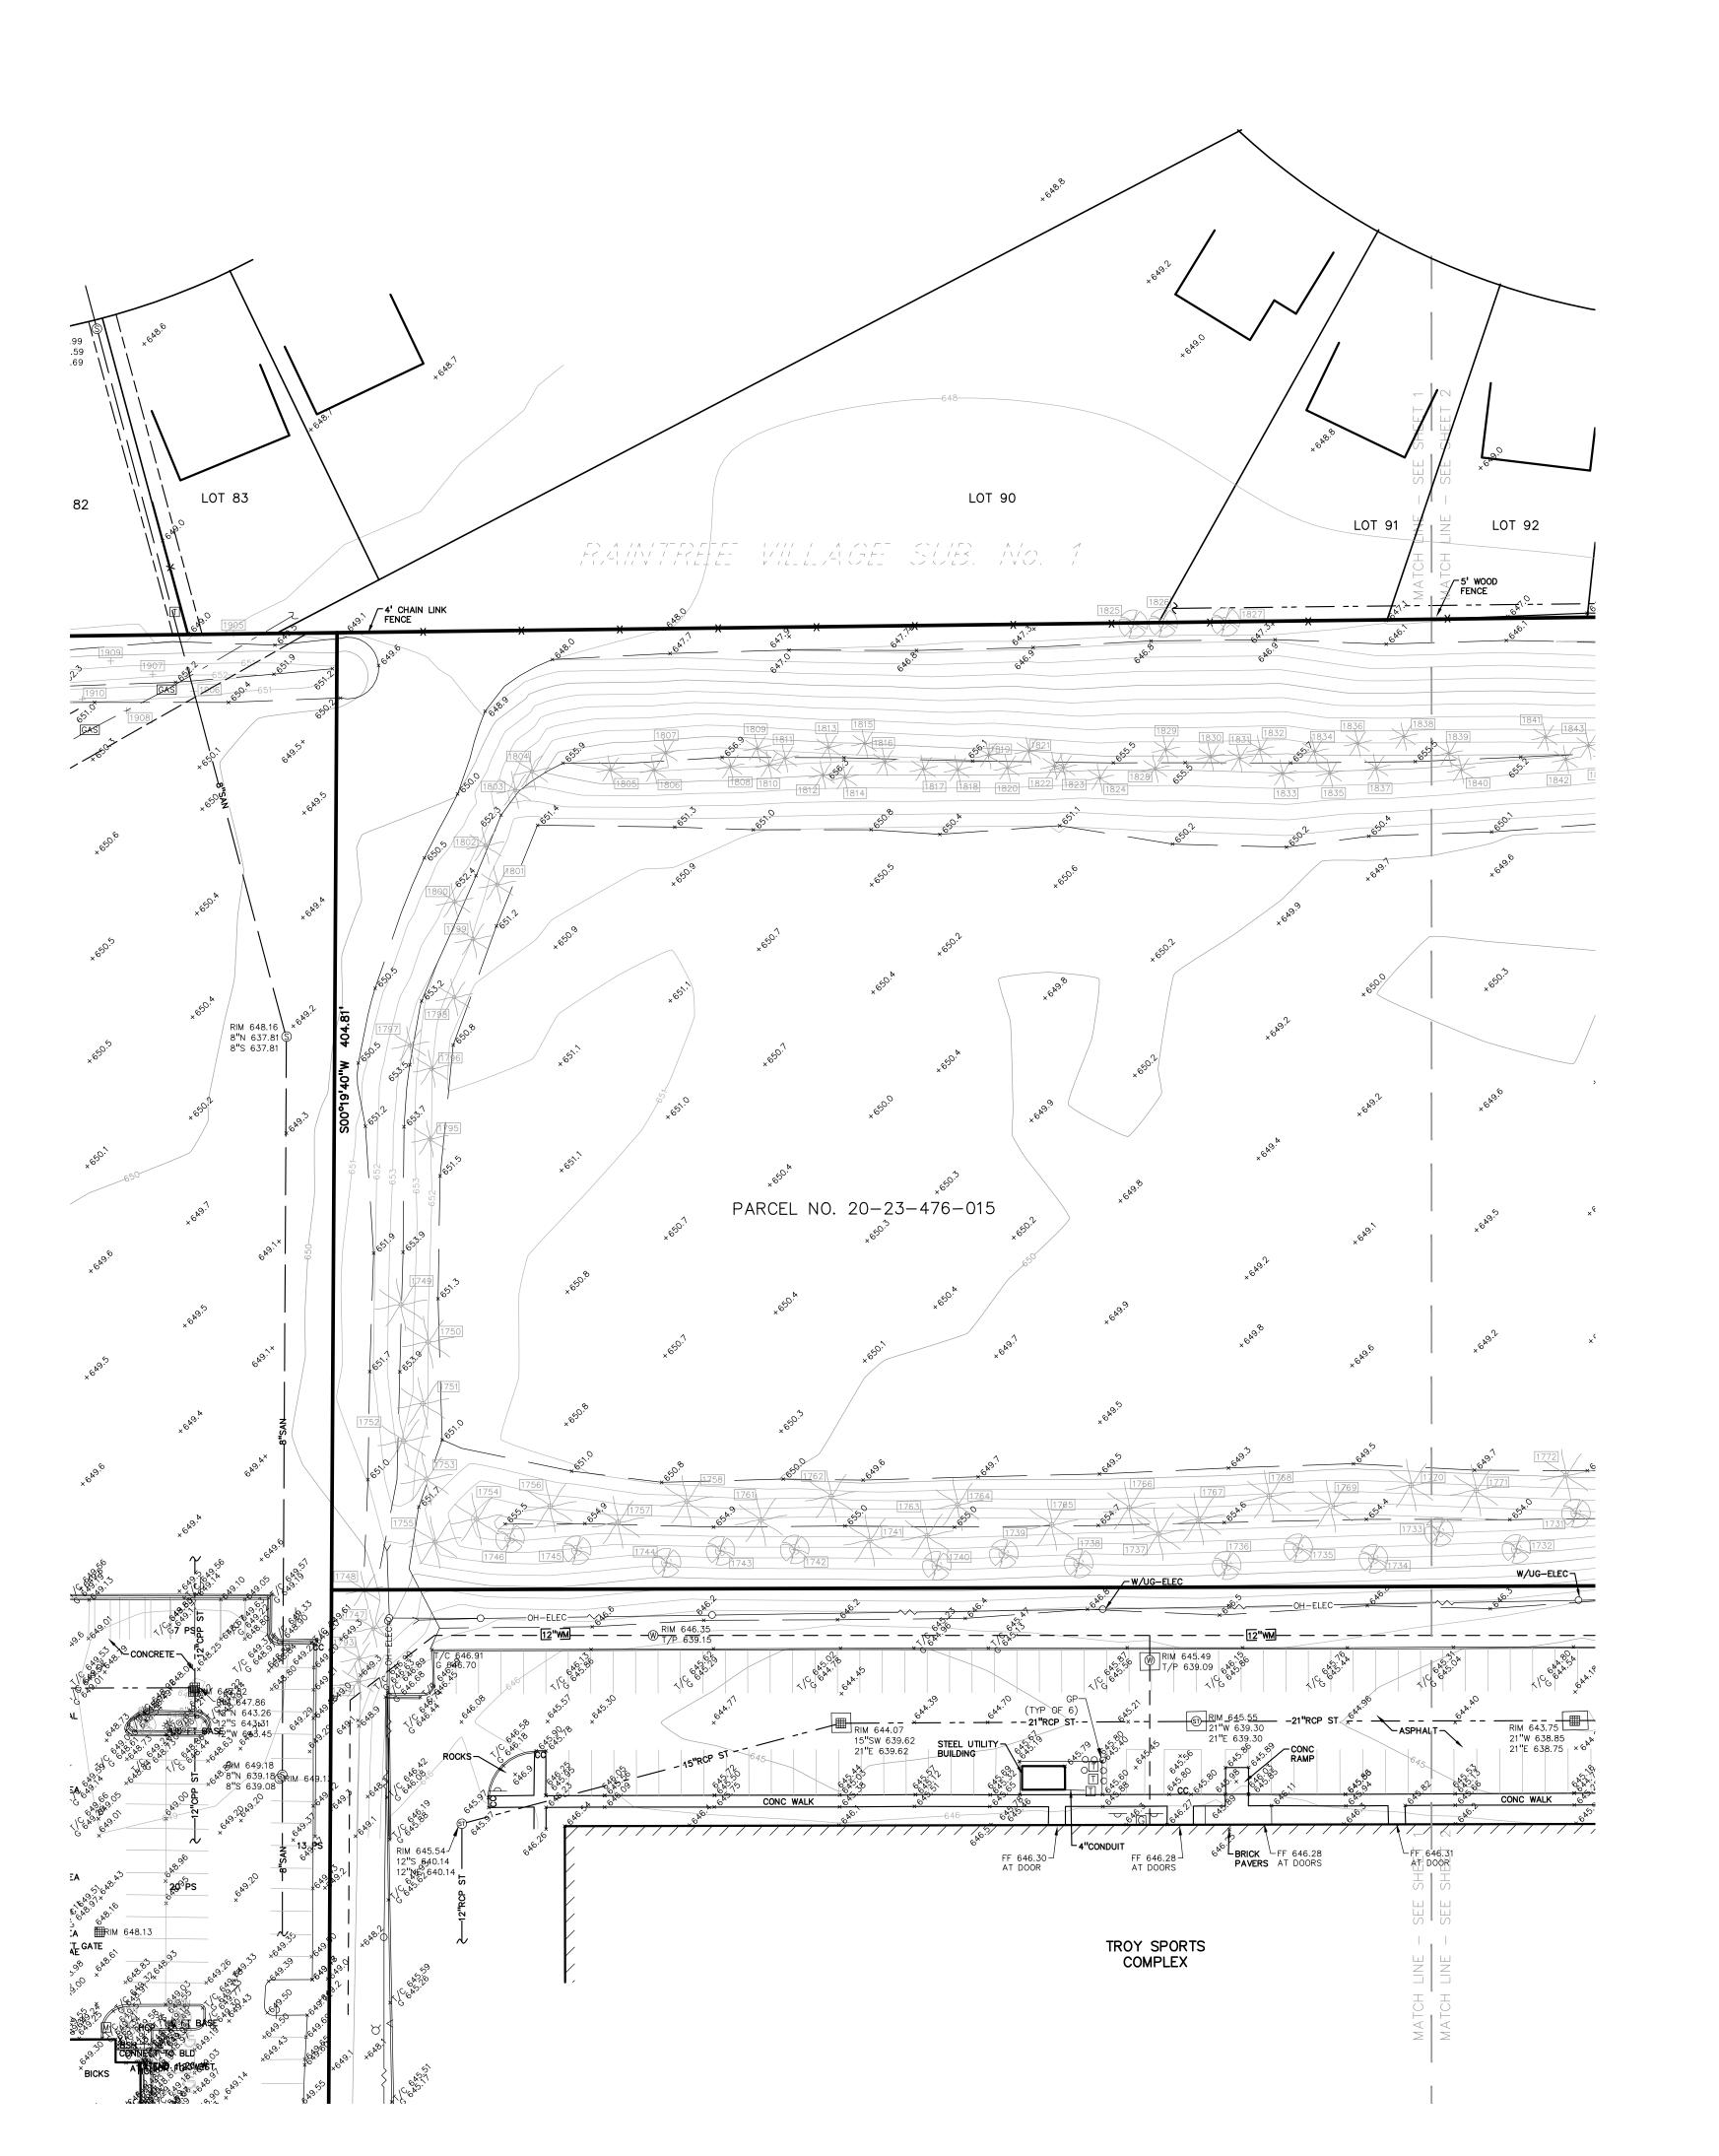







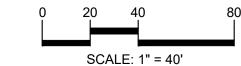



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CLIENT

TROY SPORTS CENTER, LLC 1819 EAST BIG BEAVER ROAD

(Per City of Troy Assessing) T2N, R11E, SEC 23 LASIER GARDENS SUB LOTS 1, 2 & 3 EXC E 7 FT TAKEN FOR JOHN R RD, ALSO N 96 FT OF LOT 4 EXC E 7 FT TAKEN FOR JOHN R RD, ALSO N 96 FT OF LOT 7, ALSO LOTS 8 TO 34 INCL EXC S 49 FT OF LOTS 15, 16, 25 & 26 TAKEN FOR BIG BEAVER RD, ALSO EXC PART OF LOTS 2, 9, 12 & VAC MANHATTAN AVE DESC AS BEG AT PT DIST N 00-15-00 E 102 FT & S 89-48-40 W 60 FT & N 00-15-00 E 766.33 FT FROM SE SEC COR, TH N 00-15-00 E 40 FT, TH S 89-48-00 W 300 FT, TH S 00-15-00 W 40 FT, TH N 89-48-40 E 300 FT TO BEG, ALSO LOTS 37 TO 40 INCL, ALSO ALL OF VAC MANHATTAN, ALGER, BRONX, BELLINGHAM & WALFORD AVES ADJ TO SAME EXC E 27 FT OF VAC MANHATTAN AVE ADJ TO LOT 6, ALSO EXC E 27 FT OF VAC MANHATTAN AVE ADJ TO LOT 7 EXC N 96 FT, ALSO EXC W 1/2 OF VAC BRONX AVE ADJ TO LOT 35, ALSO EXC E 7 FT OF VAC WALFORD AVE, ALSO PART OF LOT 4, PART OF LOT 7 & PART OF VAC MANHATTAN AVE DESC AS BEG AT PT DIST N 00-15-00 E 102 FT & S 89-48-00 W 329.14 FT FROM SE SEC COR, TH S 89-48-40 W 2.86 FT, TH N 00-15-00 E 330 FT, TH N 89-48-40 E 272 FT, TH S 00-15-00 W 4.30 FT, TH N 89-45-00 W 211.18 FT, TH S 52-13-38 W 73.56 FT, TH S 00-15-00 W 282.45 FT TO BEG

LEGAL DESCRIPTION (20-23-476-015)

PROJECT TITLE

2N., R. 11E. TROY, OAKLAND COUNTY, MI

REVISIONS

COMMONS **TOWNHOME DEVELOPMENT** PART OF THE SE 1/4 OF SECTION 23, T

BENCHMARKS (GPS DERIVED - NAVD88)

BM #300
ARROW ON HYDRANT WEST SIDE JOHN R ROAD 11' OF B/CURB, AND 95' SOUTH OF NORTH PROPERTY LINE OF SITE.
ELEV. — 648.05

BM #301
MAG NAIL ON NORTH SIDE OF CONCRETE LIGHT POLE BASE 21' SOUTH
OF CENTERLINE NANCY BOSTICK DRIVE, AND 29' EAST OF ENTRANCE TO
KROGER PARKING LOT FROM SAID DRIVE.
ELEV. — 648.13

BM #302
ARROW ON HYDRANT FLANGE 6' NORTH OF B/CURB FOR PARKING
ALONG NANCY BOSTICK DRIVE, AND ±80' WEST OF EAST BUILDING LINE
OF TROY SPORTS COMPLEX.
ELEV. — 647.09

FLOODPLAIN NOTE:

BY GRAPHICAL PLOTTING, SITE IS WITHIN ZONE 'X', AREA DETERMINED TO BE OUTSIDE OF THE 0.2% ANNUAL CHANCE FLOODPLAIN PER FLOOD INSURANCE RATE MAP NUMBER 26125C0553G, DATED JANUARY 16, 2009.


ORIGINAL ISSUE DATE: AUGUST 18, 2023

DRAWING TITLE **TOPOGRAPHIC SURVEY**

JOB NO.	18-003

G.M.B. C.N.R. G.M.B. DES. DRAWING NUMBER:

NOT FOR CONSTRUCTION

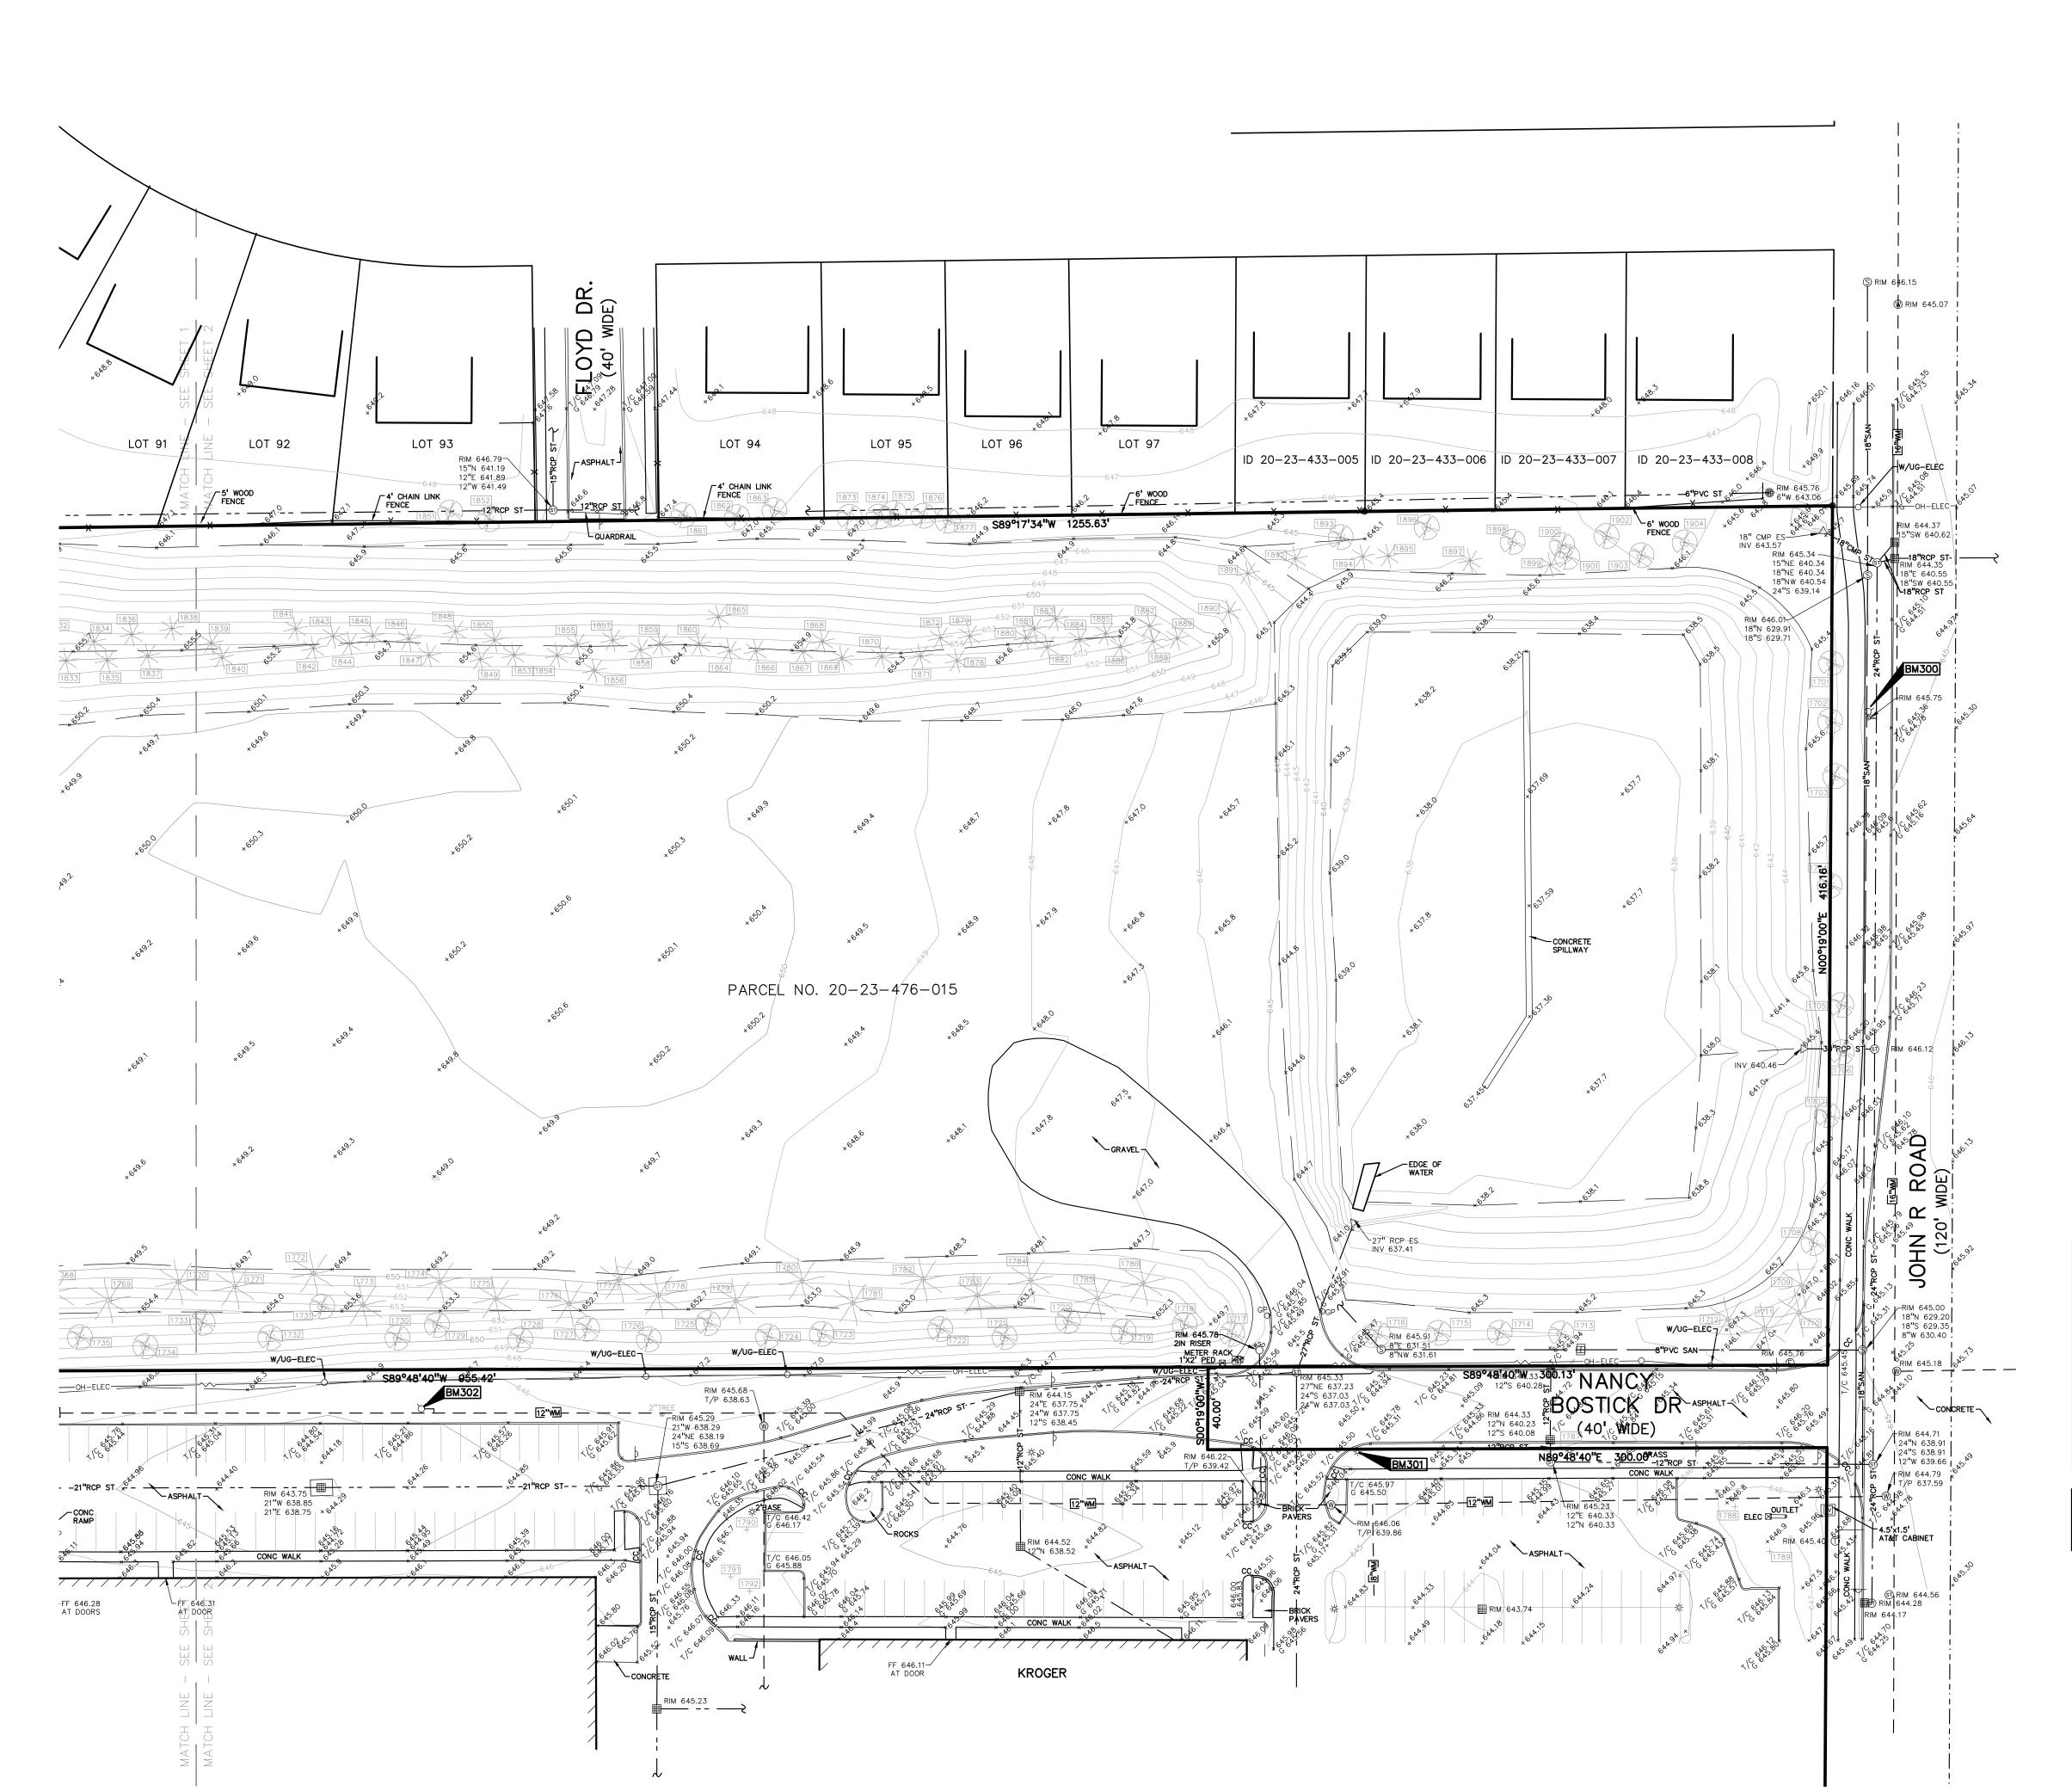











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CLIENT

TROY SPORTS CENTER, LLC 1819 EAST BIG BEAVER ROAD

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(Per City of Troy Assessing)

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COMMONS DEVELOPMENT PART OF THE SE 1/4 OF SECTION 23, T

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REVISIONS

ORIGINAL ISSUE DATE: AUGUST 18, 2023

DRAWING TITLE

TOPOGRAPHIC SURVEY

PEA JOB NO.	18-0034
P.M.	G.M.B
DN.	C.N.R
DES.	G.M.B
DRAWING NUMBER:	

BENCHMARKS (GPS DERIVED - NAVD88)

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FLOODPLAIN NOTE:

ELEV. - 647.09


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GENERAL NOTES:


THESE NOTES APPLY TO ALL CONSTRUCTION ACTIVITIES ON THIS PROJECT.


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- REFER TO SHEET C-5.0 FOR ON-SITE PAVING DETAILS.
- REFER TO SHEET C-5.0 FOR ON-SITE SIDEWALK RAMP DETAILS.
- . 'NO PARKING-FIRE LANE' SIGNS SHALL BE POSTED ALONG ALL FIRE LANES AT 100 FOOT INTERVALS OR AS DIRECTED BY THE FIRE OFFICIAL.
- . ALL CONSTRUCTION SHALL BE IN ACCORDANCE WITH CITY OF TROY CURRENT STANDARDS AND REGULATIONS.
- 6. THE CONTRACTOR SHALL NOTIFY THE CITY ENGINEER AND/OR THE AUTHORITY HAVING JURISDICTION 3 BUSINESS DAYS PRIOR TO THE BEGINNING OF CONSTRUCTION.
- ANY WORK WITHIN THE STREET OR HIGHWAY RIGHTS-OF-WAY SHALL BE PERFORMED IN ACCORDANCE WITH THE REQUIREMENTS OF THE AGENCIES HAVING JURISDICTION AND SHALL NOT BEGIN UNTIL ALL NECESSARY PERMITS HAVE BEEN ISSUED FOR THE WORK.
- B. IT SHALL BE THE RESPONSIBILITY OF THE CONTRACTOR TO ADJUST THE TOP OF ALL EXISTING AND PROPOSED STRUCTURES (MANHOLES, CATCH BASINS, INLETS, GATE WELLS ETC.) WITHIN GRADED AND OR PAVED AREAS TO FINAL GRADE SHOWN ON THE PLANS. ALL SUCH ADJUSTMENTS SHALL BE INCIDENTAL TO THE JOB AND WILL NOT BE PAID FOR SEPARATELY.





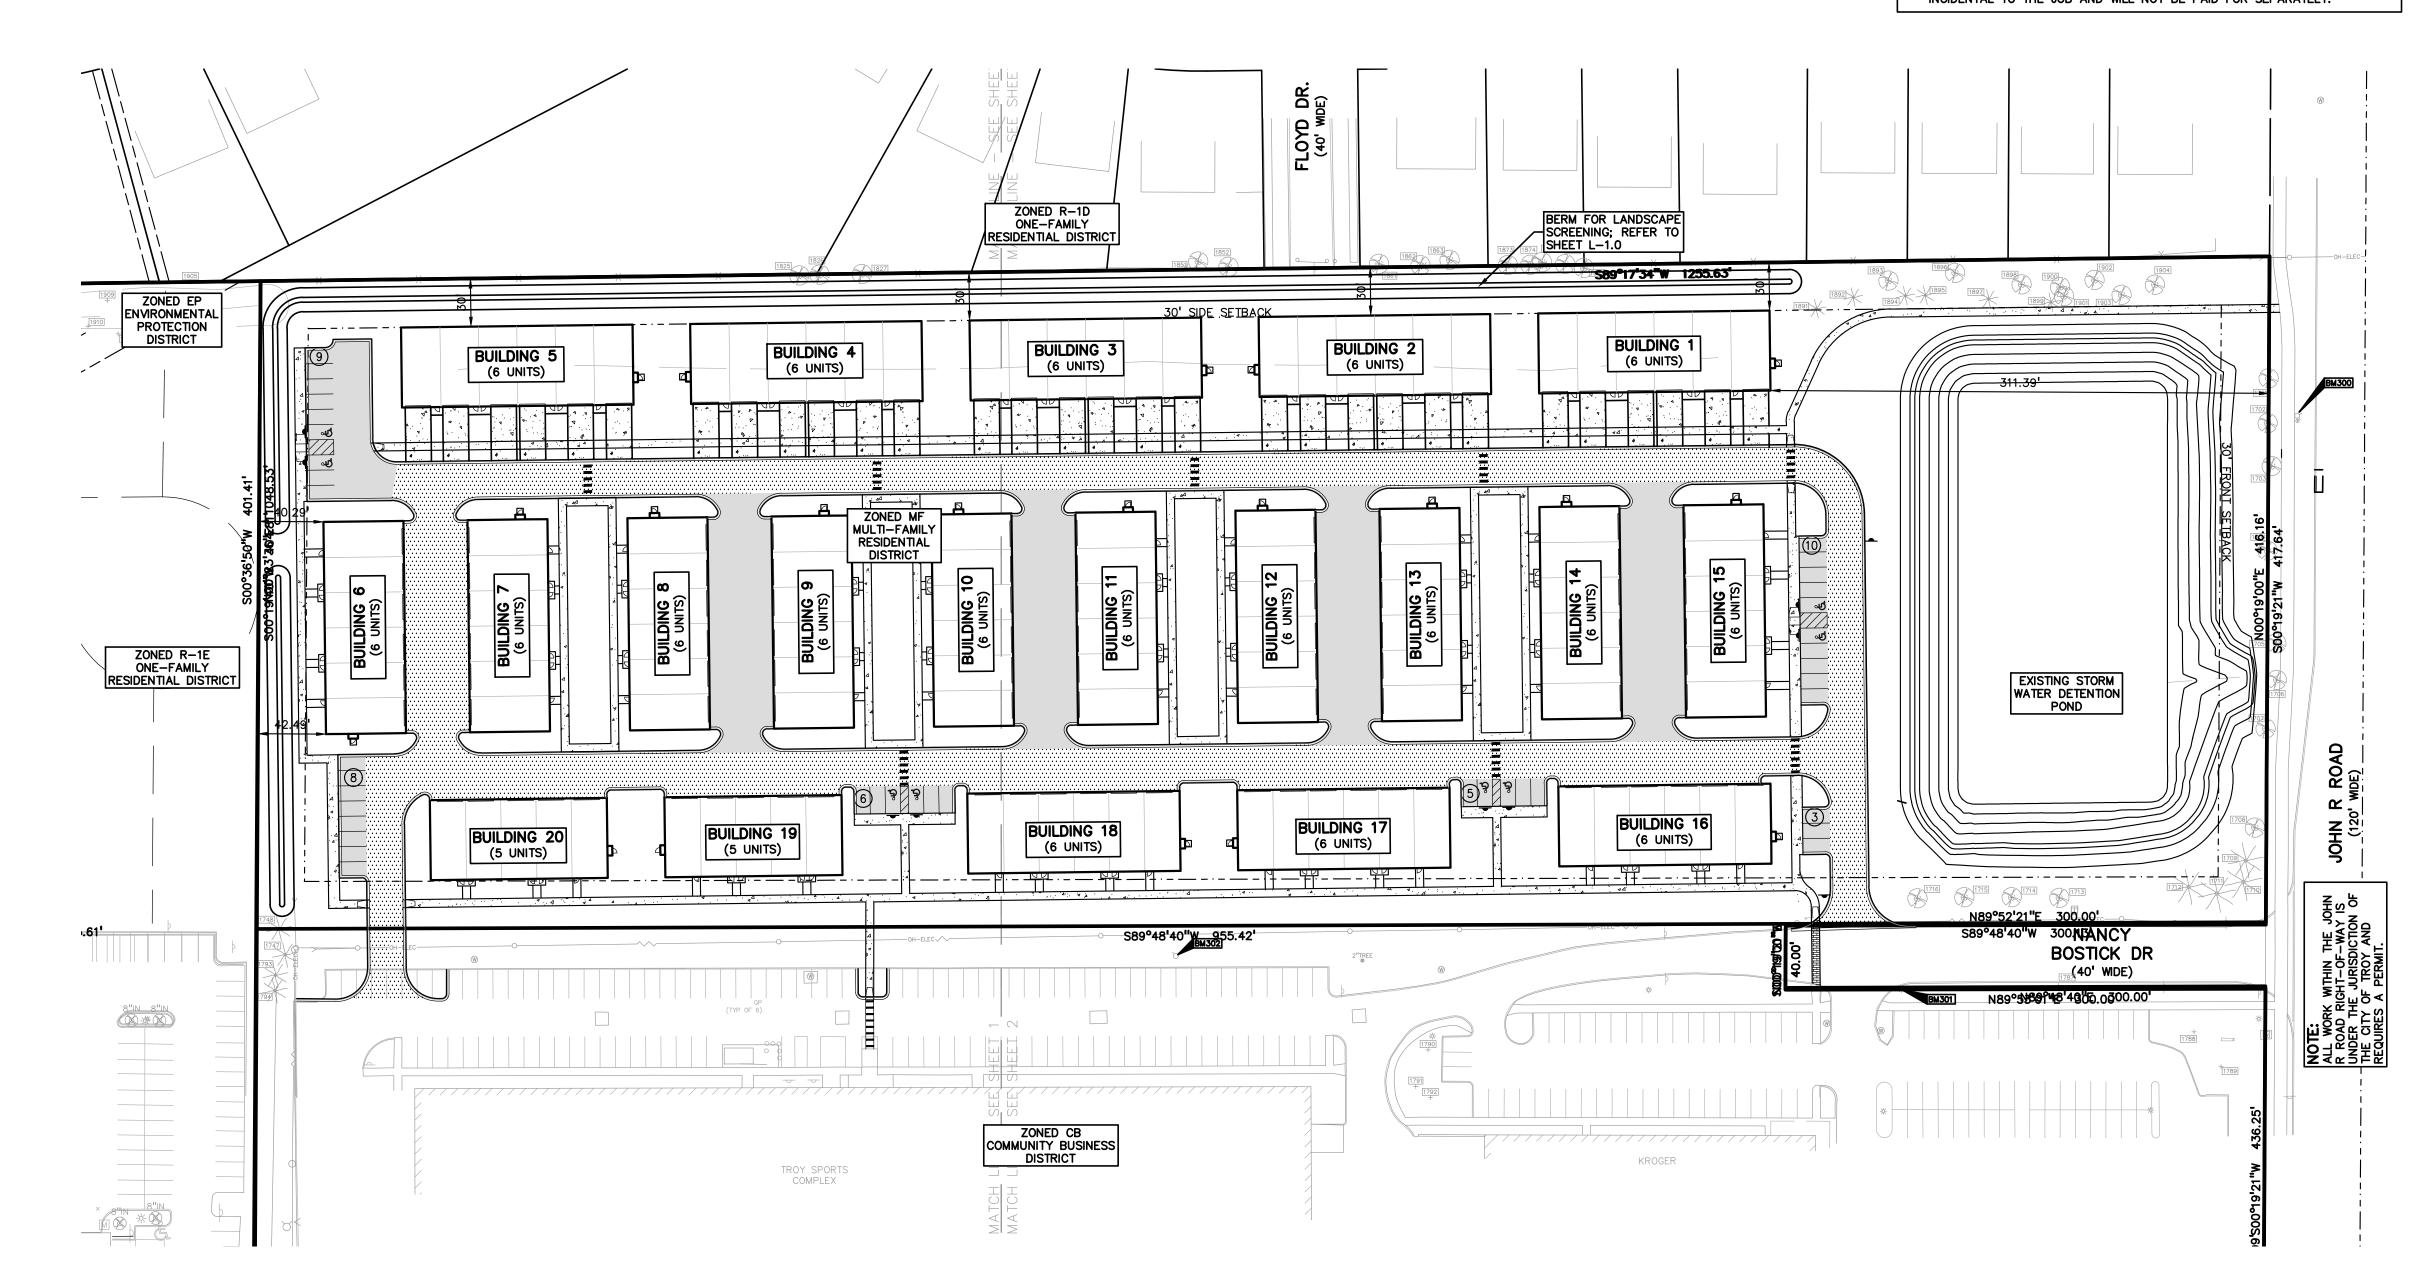

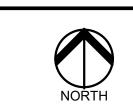

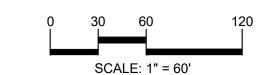



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CLIENT **TROY SPORTS CENTER, LLC** 1819 EAST BIG BEÁVER ROAD

SITE DATA TABLE:

SITE AREA: 11.86 AC (516,625 SF) NET AND GROSS ZONING: MF, (MULTI-FAMILY RESIDENTIAL) PROPOSED USE: MULTI-FAMILY RESIDENTIAL (118-UNIT DEVELOPMENT)

BUILDING INFORMATION:
BUILDING HEIGHT = 25 FEET (2 STORIES) BUILDING TYPE A (FRONT GARAGE) = 7,233 SF BUILDING TYPE B (6-UNIT REAR GARAGE) = 6,633 SF

BUILDING TYPE C (5-UNIT REAR GARAGE) = 5,533 SF

MAXIMUM BUILDING LOT COVERAGE = 35%
PROPOSED BUILDING LOT COVERAGE:
= 7,233 x 5 + 6,633 x 13 + 5,533 x 2
= 133,460 SF = 25.83%
516,625 SF

SETBACK REQUIREMENTS: FRONT SETBACK (EAST): SIDE SETBACK (NORTH): REAR SETBACK (WEST):

30 FEET 30 FEET 30 FEET 40.29 FEET PARKING CALCULATIONS:
MULTI-FAMILY RESIDENTIAL = 2 SPACES PER DWELLING UNIT PARKING REQUIRED: = 118 UNITS * 2 SPACES/UNIT = 236 SPACES

REQUIRED 30 FEET

= 20 SPACES

= 41 SPACES

337 SPACES

PROPOSED 311.39 FEET

PARKING PROVIDED: BUILDINGS 1-5:

12 GARAGE SPACES \times 5 = 60 SPACES 12 DRIVEWAY SPACES \times 5 = 60 SPACES BUILDINGS 6-20: 12 GARAGE SPACES x 13 =156 SPACES

10 GARAGE SPACES x 2 **GUEST PARKING:** SURFACE SPACES

TOTAL PARKING PROVIDED:

RECREATION SPACE:
MULTI-FAMILY RESIDENTIAL = 450 SF PER DWELLING UNIT = 118 UNITS * 450 SF/UNIT = 53,100 SF

= 59,045 SF (WALKS, PICNIC AREAS, AND MISC. OPEN SPACE)

PROJECT TITLE JOHN R COMMONS

TOWNHOME DEVELOPMENT PART OF THE SE 1/4 OF SECTION 23, 1 2N., R. 11E. TROY, OAKLAND COUNTY, MI

REVISIONS

ORIGINAL ISSUE DATE:

AUGUST 18, 2023

DRAWING TITLE **OVERALL SITE PLAN**

18-0034 PEA JOB NO. G.M.B. C.N.R. DES. G.M.B. DRAWING NUMBER:

NOT FOR CONSTRUCTION

BENCHMARKS (GPS DERIVED - NAVD88)

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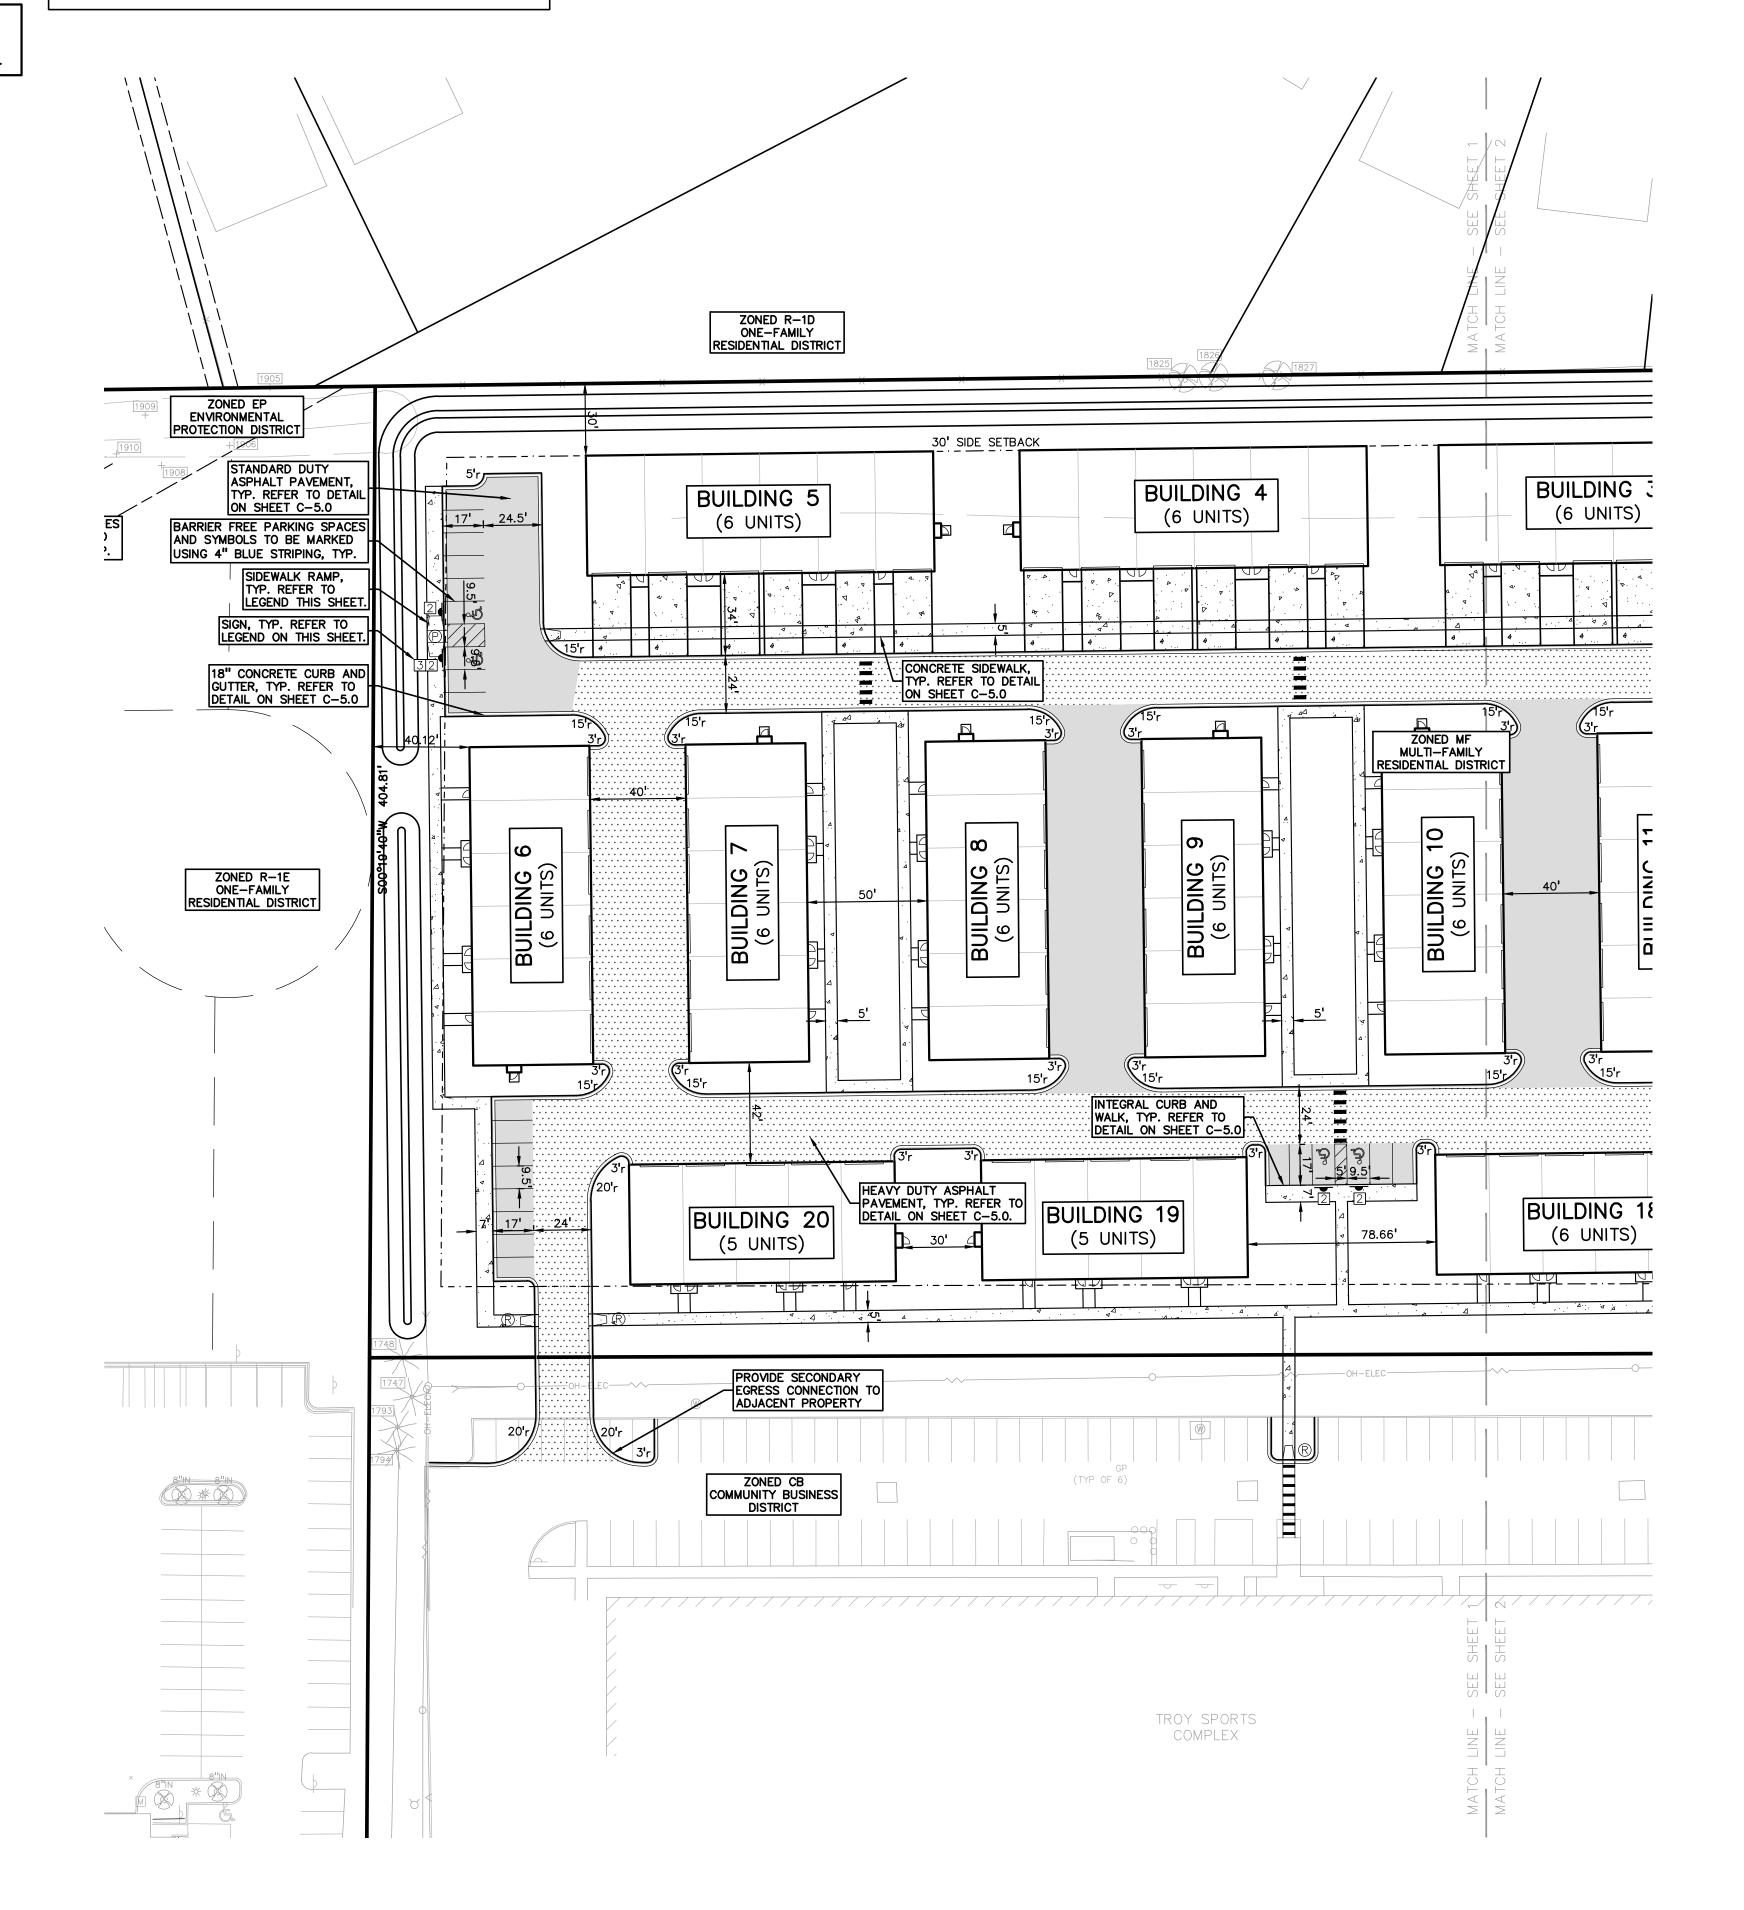
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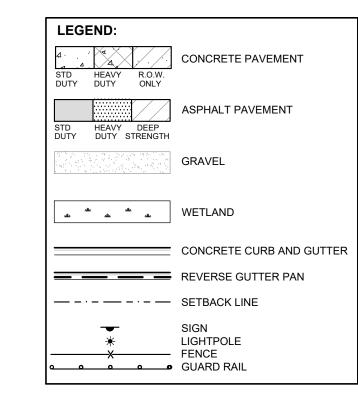
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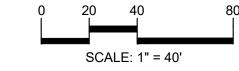














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CLIENT

TTOY, MI 48083

TROY SPORTS **CENTER, LLC** 1819 EAST BIG BEÁVER ROAD

SIDEWALK RAMP 'TYPE P' REFER TO LATEST M.D.O.T. R-28 STANDARD RAMP

AND DETECTABLE WARNING DETAILS SIGN LEGEND: 'STOP' SIGN

'BARRIER FREE PARKING' SIGN 'VAN ACCESSIBLE' SIGN

REFER TO SHEET C-5.0 FOR SIGN DETAILS

SIDEWALK RAMP LEGEND:

SIDEWALK RAMP 'TYPE R'

GENERAL NOTES:

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JOHN R COMMONS **TOWNHOME DEVELOPMENT**

PROJECT TITLE

PART OF THE SE 1/4 OF SECTION 23, T 2N., R. 11E. TROY, OAKLAND COUNTY, MI

EVISIONS			
		-	

ORIGINAL ISSUE DATE: AUGUST 18, 2023

DRAWING TITLE **PRELIMINARY SITE PLAN**

18-0034 PEA JOB NO. G.M.B. C.N.R. DES. G.M.B.

DRAWING NUMBER:

NOT FOR CONSTRUCTION

BENCHMARKS (GPS DERIVED - NAVD88)

BM #300

ELEV. - 647.09

ARROW ON HYDRANT WEST SIDE JOHN R ROAD 11' OF B/CURB, AND 95' SOUTH OF NORTH PROPERTY LINE OF SITE.

BM #301
MAG NAIL ON NORTH SIDE OF CONCRETE LIGHT POLE BASE 21' SOUTH
OF CENTERLINE NANCY BOSTICK DRIVE, AND 29' EAST OF ENTRANCE TO
KROGER PARKING LOT FROM SAID DRIVE.
ELEV. — 648.13


BM #302
ARROW ON HYDRANT FLANGE 6' NORTH OF B/CURB FOR PARKING
ALONG NANCY BOSTICK DRIVE, AND ±80' WEST OF EAST BUILDING LINE
OF TROY SPORTS COMPLEX.


FLOODPLAIN NOTE:

LEGAL DESCRIPTION (20-23-476-015)
(Per City of Troy Assessing)

T2N, R11E, SEC 23 LASIER GARDENS SUB LOTS 1, 2 & 3 EXC E 7 FT TAKEN FOR JOHN R RD, ALSO N 96 FT OF LOT 4 EXC E 7 FT TAKEN FOR JOHN R RD, ALSO N 96 FT OF LOT 7, ALSO LOTS 8 TO 34 INCL EXC S 49 FT OF LOTS 15, 16, 25 & 26 TAKEN FOR BIG BEAVER RD, ALSO EXC PART OF LOTS 2, 9, 12 & VAC MANHATTAN AVE DESC AS BEG AT PT DIST N 00-15-00 E 102 FT & S 89-48-40 W 60 FT & N 00-15-00 E 766.33 FT FROM SE SEC COR, TH N 00-15-00 E 40 FT, TH S 89-48-00 W 300 FT, TH S 00-15-00 W 40 FT, TH N 89-48-40 E 300 FT TO BEG, ALSO LOTS 37 TO 40 INCL, ALSO ALL OF VAC MANHATTAN, ALGER, BRONX, BELLINGHAM & WALFORD AVES ADJ TO SAME EXC E 27 FT OF VAC MANHATTAN AVE ADJ TO LOT 6, ALSO EXC E 27 FT OF VAC MANHATTAN AVE ADJ TO LOT 7 EXC N 96 FT, ALSO EXC W 1/2 OF VAC BRONX AVE ADJ TO LOT 35, ALSO EXC E 7 FT OF VAC WALFORD AVE, ALSO PART OF LOT 4, PART OF LOT 7 & PART OF VAC MANHATTAN AVE DESC AS BEG AT PT DIST N 00-15-00 E 102 FT & S 89-48-00 W 329.14 FT FROM SE SEC COR, TH S 89-48-40 W 2.86 FT, TH N 00-15-00 E 330 FT, TH N 89-48-40 E 272 FT, TH S 00-15-00 W 4.30 FT, TH N 89-45-00 W 211.18


FT, TH S 52-13-38 W 73.56 FT, TH S 00-15-00 W 282.45 FT TO BEG

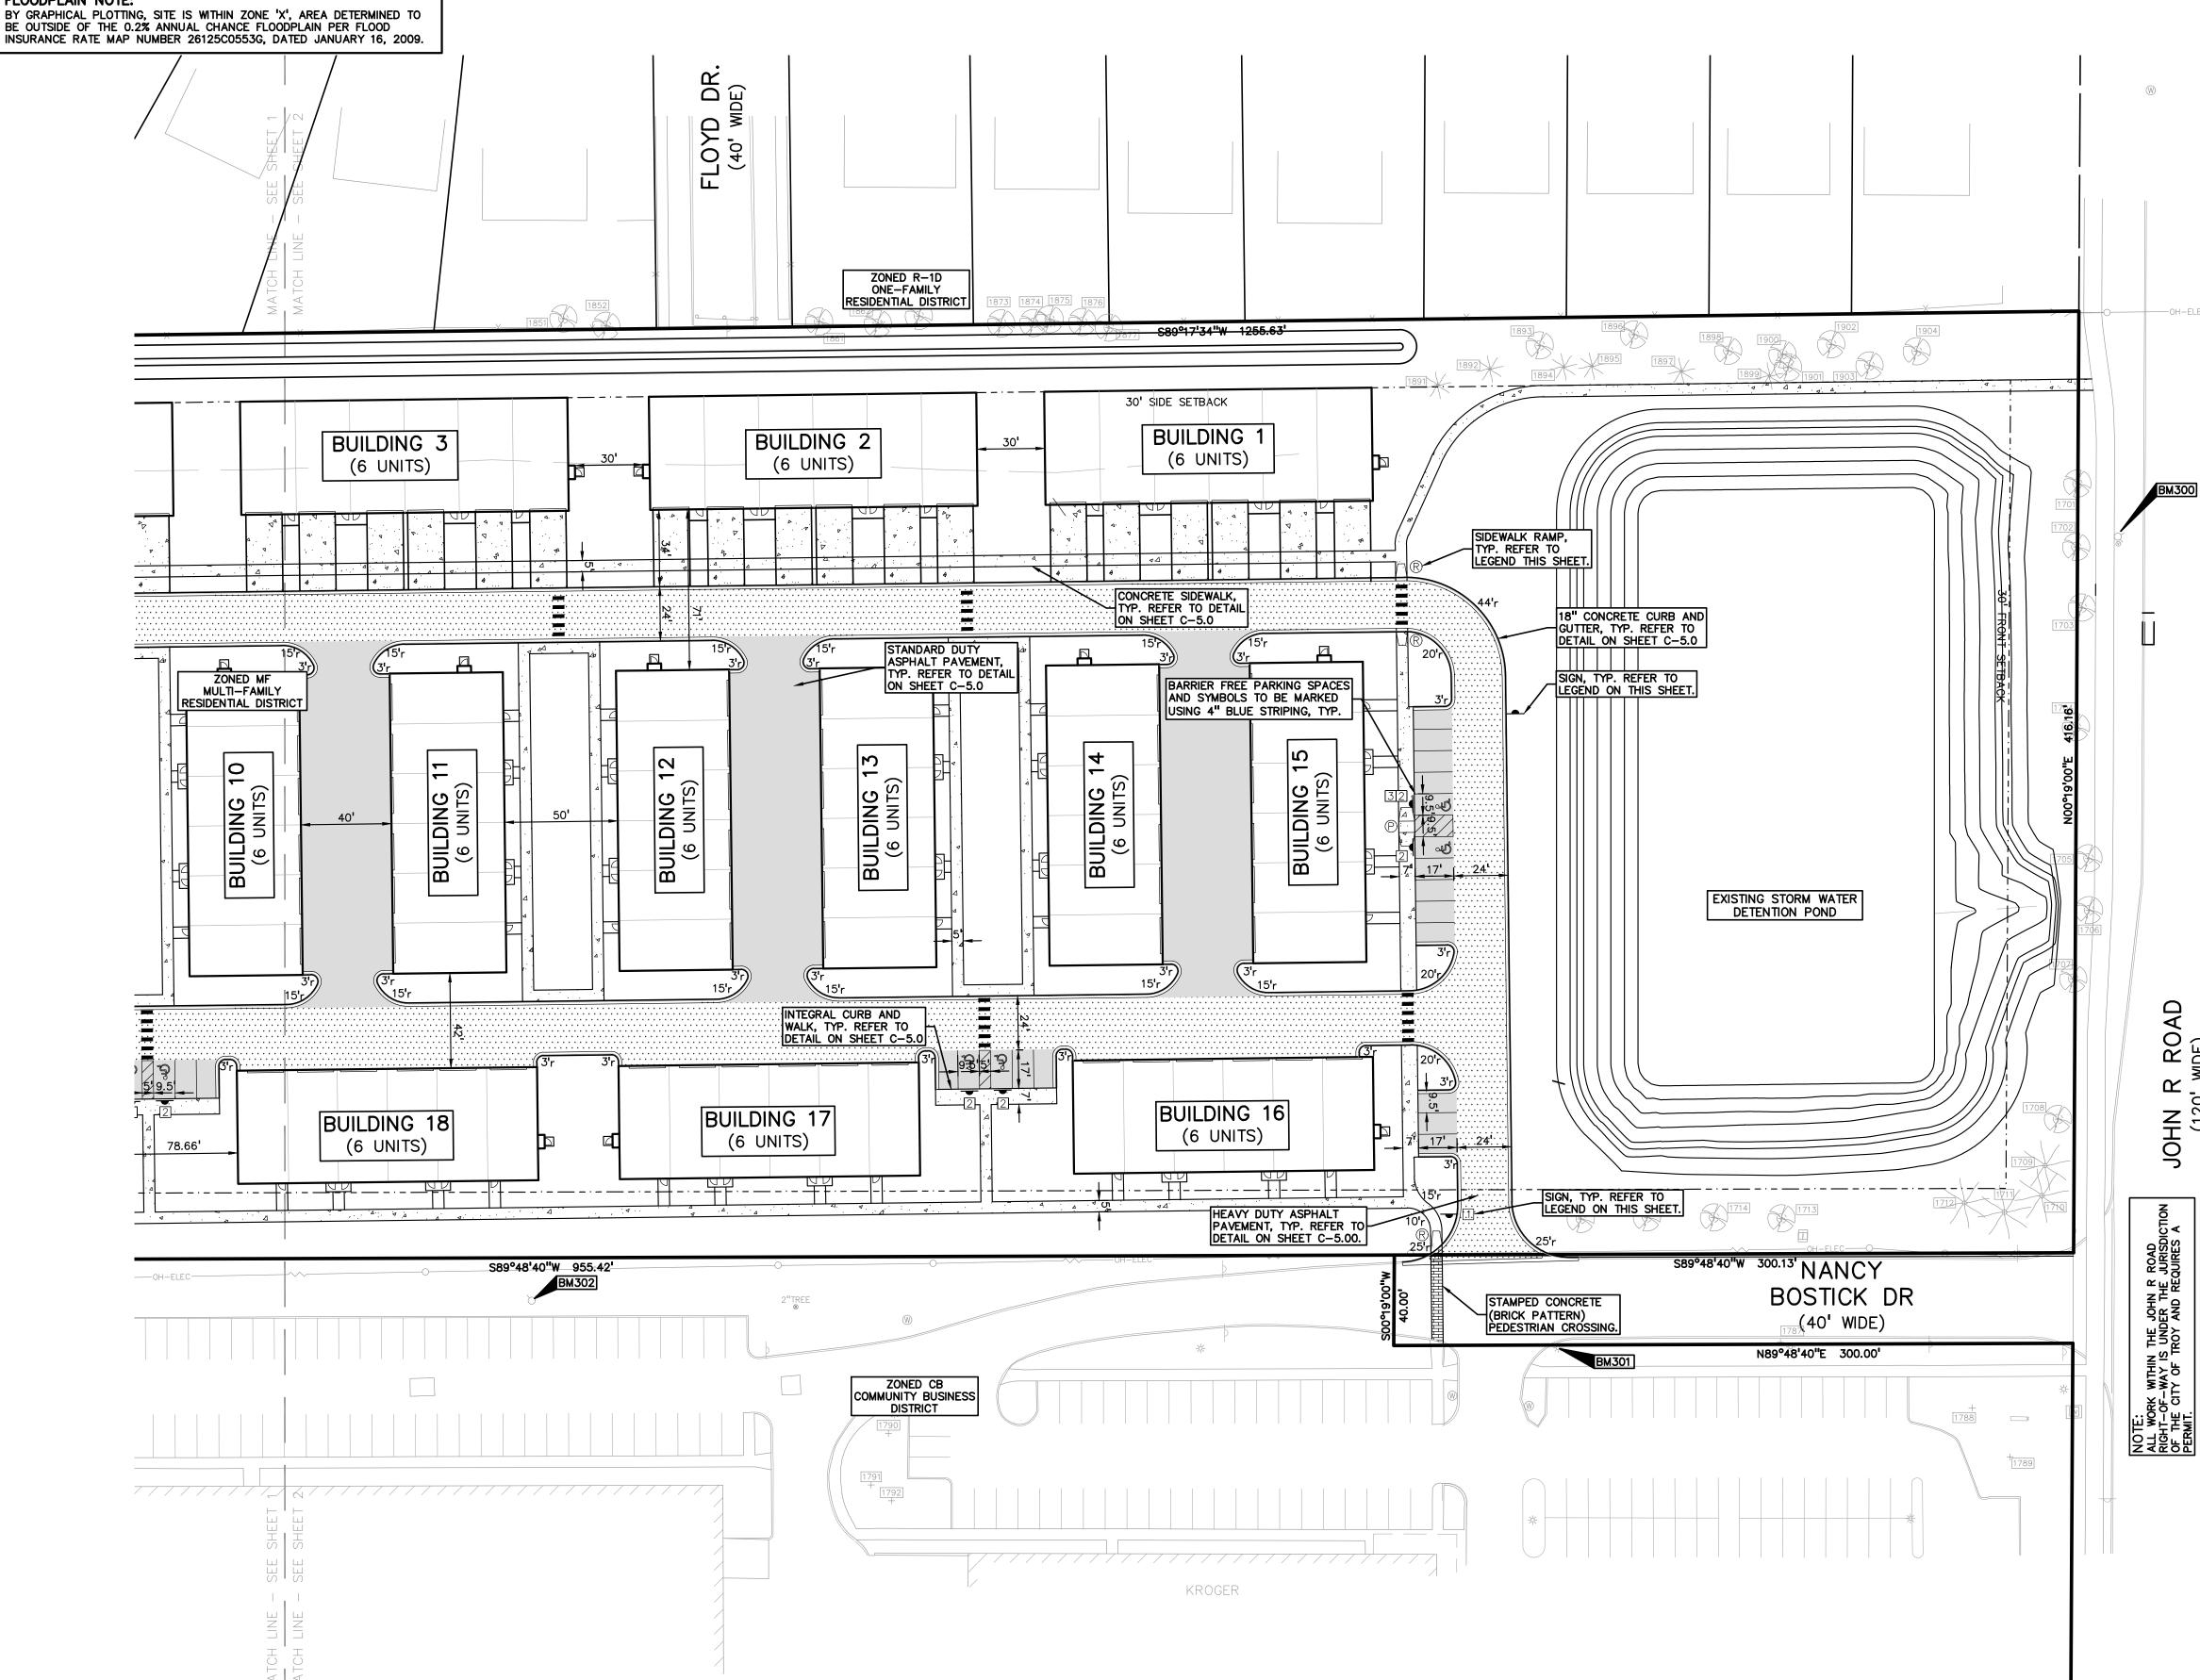

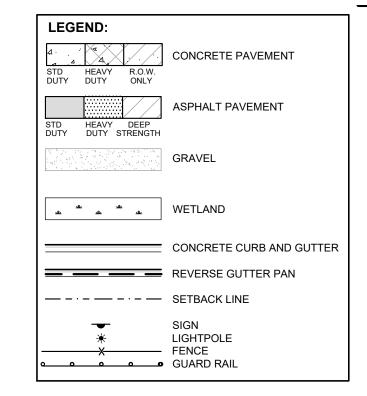





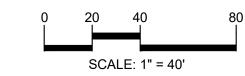



CAUTION!!

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TROY SPORTS CENTER, LLC 1819 EAST BIG BEAVER ROAD TTOY, MI 48083

CLIENT

SIDEWALK RAMP 'TYPE P'

REFER TO LATEST M.D.O.T. R-28 STANDARD RAMP AND DETECTABLE WARNING DETAILS

SIGN LEGEND:

'STOP' SIGN

SIDEWALK RAMP LEGEND:

SIDEWALK RAMP 'TYPE R'

'BARRIER FREE PARKING' SIGN

'VAN ACCESSIBLE' SIGN

3

REFER TO SHEET C-5.0 FOR SIGN DETAILS

TTOY, MI 48083

PROJECT TITLE

JOHN R
COMMONS
TOWNHOME
DEVELOPMENT

PART OF THE SE 1/4 OF SECTION 23, T.
2N., R. 11E.
TROY, OAKLAND COUNTY, MI

ORIGINAL ISSUE DATE:
AUGUST 18, 2023

PRELIMINARY
SITE PLAN

PEA JOB NO. 18-0034

P.M. G.M.B.

DN. C.N.R.

DES. G.M.B.

DRAWING NUMBER:

NOT FOR CONSTRUCTION

C-2.2

BENCHMARKS (GPS DERIVED - NAVD88)


ARROW ON HYDRANT WEST SIDE JOHN R ROAD 11' OF B/CURB, AND 95' SOUTH OF NORTH PROPERTY LINE OF SITE.

MAG NAIL ON NORTH SIDE OF CONCRETE LIGHT POLE BASE 21' SOUTH OF CENTERLINE NANCY BOSTICK DRIVE, AND 29' EAST OF ENTRANCE TO KROGER PARKING LOT FROM SAID DRIVE. ELEV. - 648.13

ARROW ON HYDRANT FLANGE 6' NORTH OF B/CURB FOR PARKING ALONG NANCY BOSTICK DRIVE, AND ±80' WEST OF EAST BUILDING LINE OF TROY SPORTS COMPLEX. ELEV. - 647.09

FLOODPLAIN NOTE:

BY GRAPHICAL PLOTTING, SITE IS WITHIN ZONE 'X', AREA DETERMINED TO BE OUTSIDE OF THE 0.2% ANNUAL CHANCE FLOODPLAIN PER FLOOD INSURANCE RATE MAP NUMBER 26125C0553G, DATED JANUARY 16, 2009.

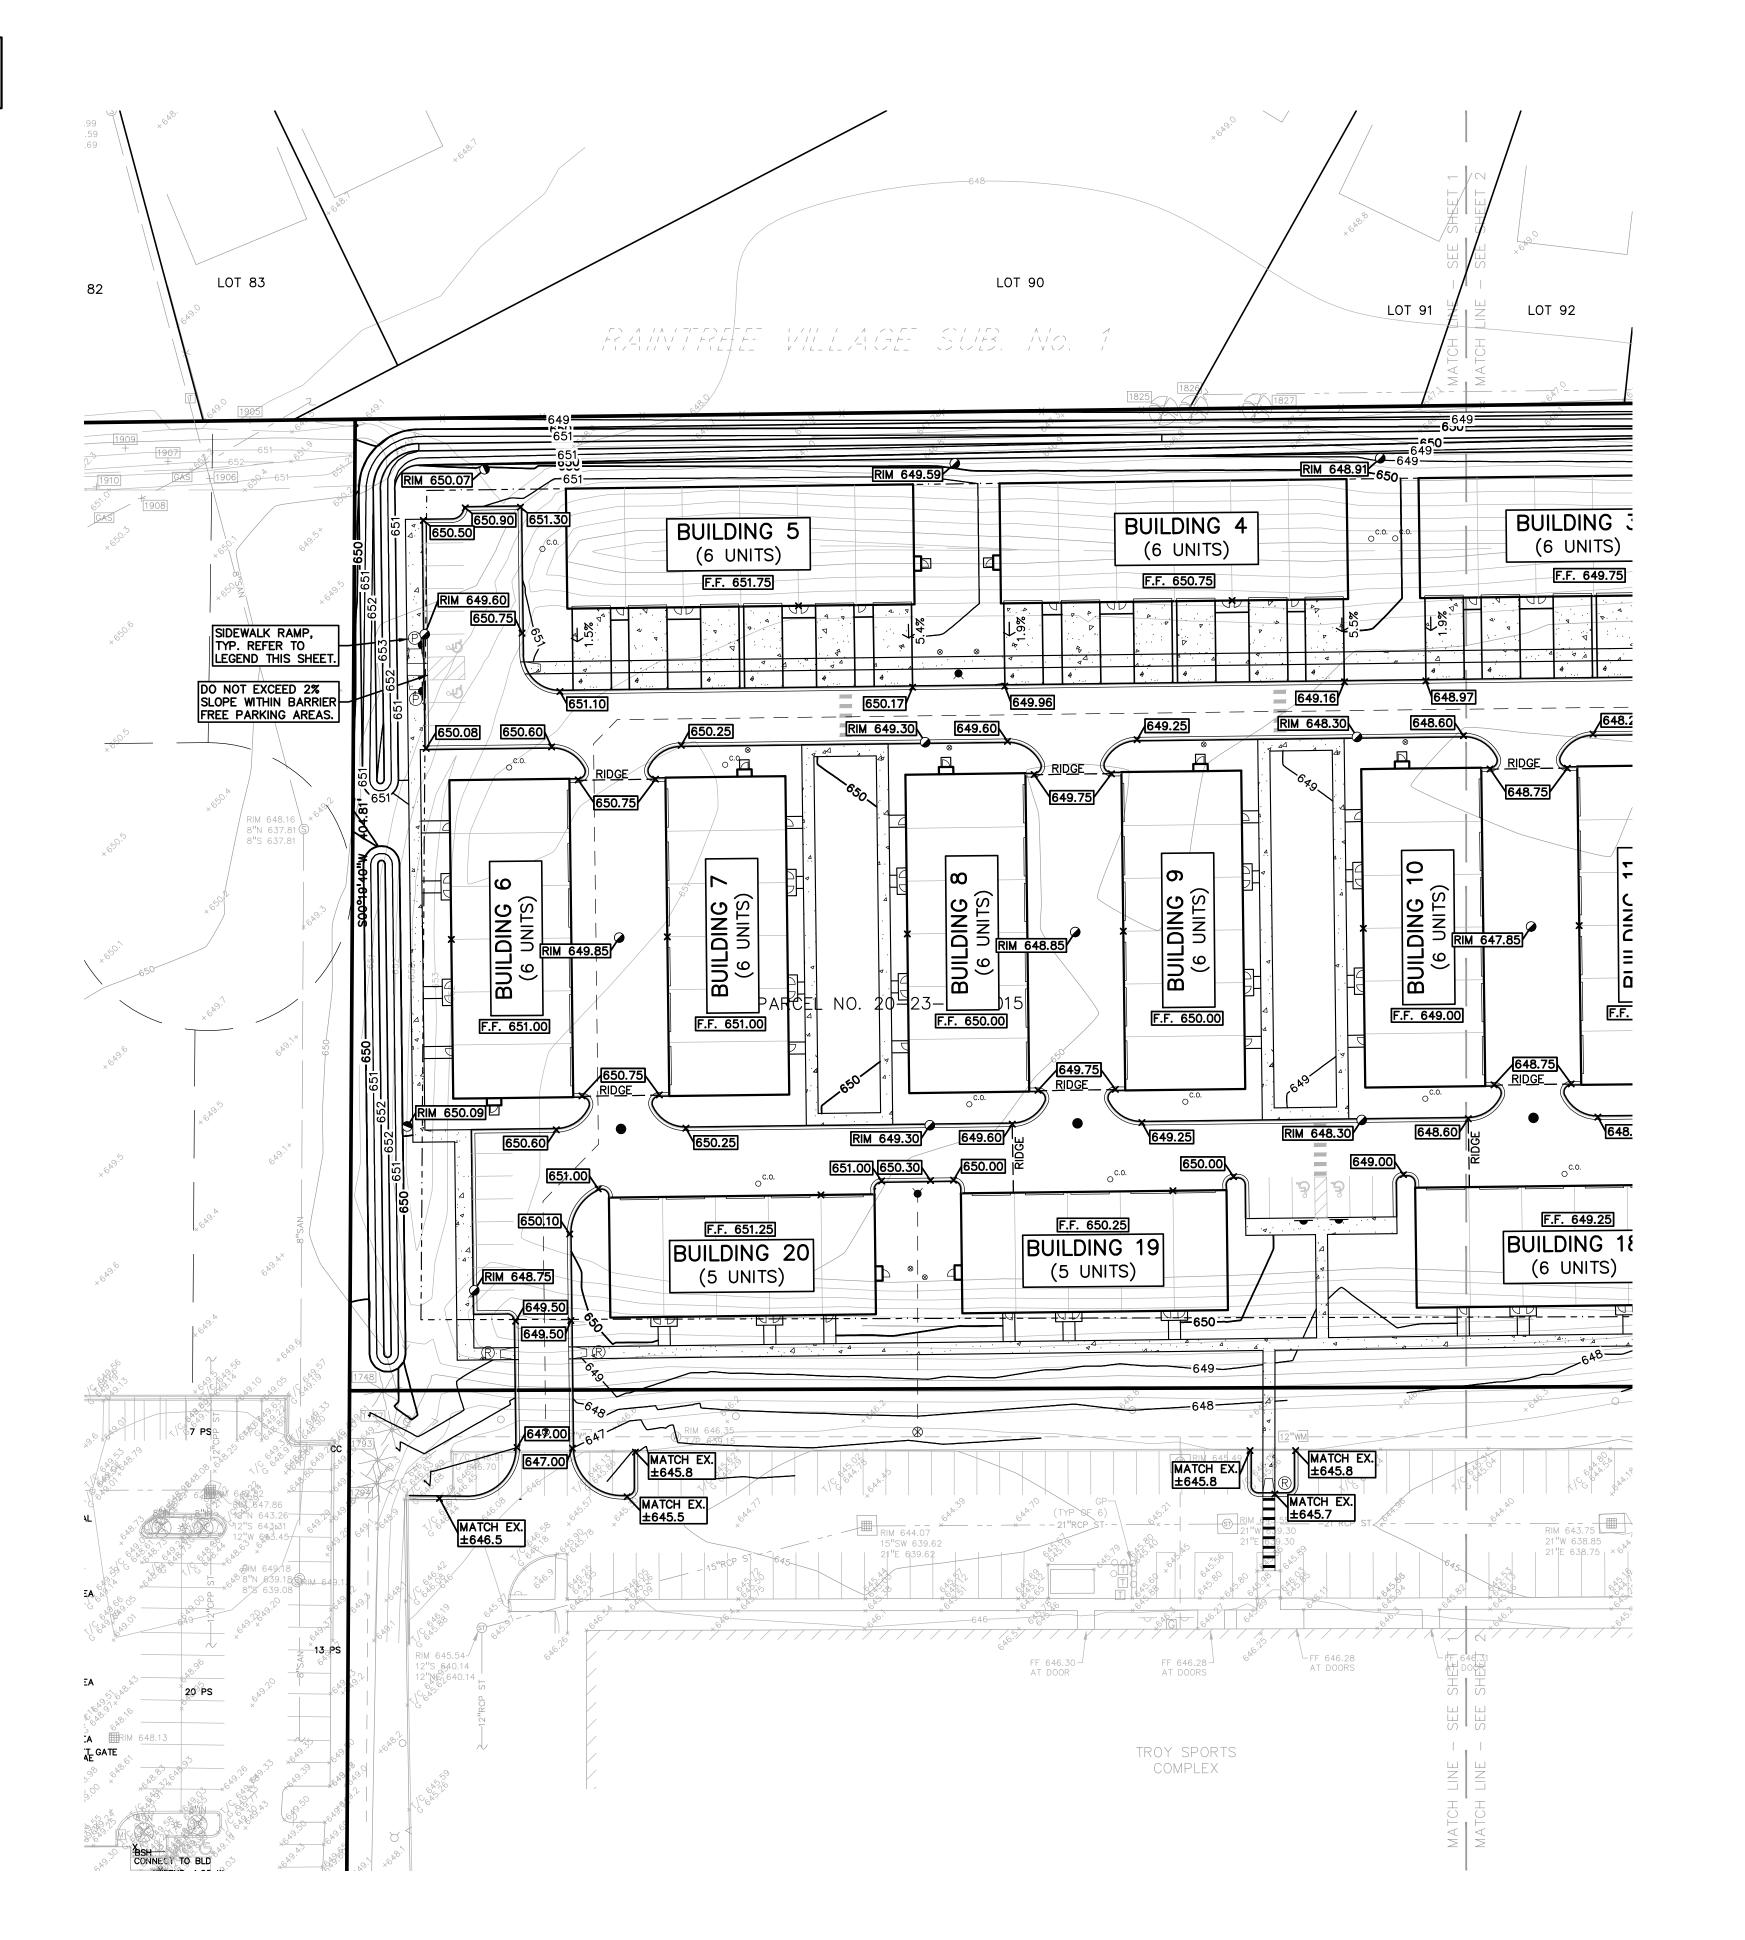

SIDEWALK RAMP LEGEND:

SIDEWALK RAMP 'TYPE R'

SIDEWALK RAMP 'TYPE P'

REFER TO LATEST M.D.O.T. R-28 STANDARD RAMP AND DETECTABLE WARNING DETAILS

SYMBOLS: GRADING

PROPOSED CONTOUR LINE

PROPOSED SPOT GRADE ELEVATION. ALL GRADES INDICATED ARE TOP OF PAVEMENT UNLESS OTHERWISE NOTED.

694.50 ----695---

EARTHWORK BALANCING NOTE:

THE CONTRACTOR SHALL BE RESPONSIBLE FOR IMPORTING OR EXPORTING ALL MATERIALS AS REQUIRED TO PROPERLY GRADE THIS PROJECT TO THE FINISHED ELEVATIONS SHOWN ON THE APPROVED PLANS. THE CONTRACTOR SHALL MAKE THEIR OWN DETERMINATION OF CUT AND FILL QUANTITIES AND ALLOW FOR REMOVAL OF EXCESS OR IMPORTATION OF ADDITIONAL MATERIAL AT NO ADDITIONAL COST TO THE OWNER.

GENERAL GRADING AND EARTHWORK NOTES:


- THESE NOTES APPLY TO ALL CONSTRUCTION ACTIVITIES ON THIS PROJECT
- CONTRACTOR TO FIELD VERIFY ALL EXISTING TREES AND BRUSH AND REMOVE ALL THAT ARE NECESSARY TO GRADE SITE.
- 2. ALL GRADES ARE TO TOP OF PAVEMENT UNLESS OTHERWISE NOTED.
- THE STAGING OF CONSTRUCTION ACTIVITIES SHALL OCCUR ONLY WITHIN THE SITE BOUNDARIES. ANY CONSTRUCTION ACTIVITIES OUTSIDE OF THE SITE BOUNDARIES SHALL BE AT THE SOLE RESPONSIBILITY AND RISK OF THE CONTRACTOR.
- REQUIREMENTS OF THE CITY OF TROY. AN EROSION CONTROL PERMIT MUST BE SECURED FROM THE CITY PRIOR TO CONSTRUCTION.
- ALL EARTHWORK AND GRADING OPERATIONS SHALL BE PERFORMED IN ACCORDANCE WITH THE SOILS INVESTIGATION AND REPORT.
- THE DETENTION BASIN SIDE SLOPES AND ALL SLOPE EXCEEDING 1:6 MUST BE STABILIZED BY SODDING OR BY PLACING A MULCH BLANKET PEGGED IN PLACE
- . ALL DISTURBED AREAS SHALL BE SEEDED AND MULCHED OR SODDED IN ACCORDANCE WITH THE LANDSCAPE PLANS. PROVIDE A MINIMUM OF 3" OF TOPSOIL IN THESE AREAS UNLESS OTHERWISE NOTED.
- . THE CONTRACTOR SHALL NOTE EXISTING UNDERGROUND UTILITIES WITHIN AND ADJACENT TO THE SITE. BACKFILL FOR EXISTING UTILITY TRENCHES SHALL BE EXAMINED CRITICALLY. ANY TRENCHES FOUND TO HAVE SOFT, UNSTABLE OR UNSUITABLE BACKFILL MATERIAL, IN THE OPINION OF THE GEOTECHNICAL ENGINEER, THAT ARE TO BE WITHIN THE ZONE OF INFLUENCE OF PROPOSED BUILDINGS OR PAVEMENT SHALL BE COMPLETELY EXCAVATED AND BACKFILLED WITH SUITABLE MATERIAL.




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CLIENT

TROY SPORTS CENTER, LLC 1819 EAST BIG BEAVER ROAD TTOY, MI 48083


PROJECT TITLE

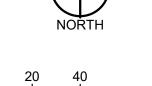JOHN R
COMMONS
TOWNHOME
DEVELOPMENT
PART OF THE SE 1/4 OF SECTION 23, T.
2N., R. 11E.
TROY, OAKLAND COUNTY, MI

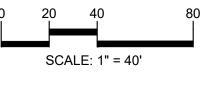ORIGINAL ISSUE DATE: AUGUST 18, 2023 DRAWING TITLE

PRELIMINARY GRADING PLAN

PEA JOB NO.	18-0034
P.M.	G.M.B
DN.	C.N.R
DES.	G.M.B
DRAWING NUMBER:	

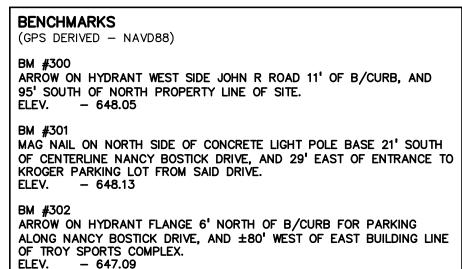

FLOODPLAIN NOTE: BY GRAPHICAL PLOTTING, SITE IS WITHIN ZONE 'X', AREA DETERMINED TO BE OUTSIDE OF THE 0.2% ANNUAL CHANCE FLOODPLAIN PER FLOOD INSURANCE RATE MAP NUMBER 26125C0553G, DATED JANUARY 16, 2009. S RIM 646.15 ₩ RIM 645.07 LOYD (40' W LOT 91 LOT 92 LOT 95 LOT 96 LOT 97 ID 20-23-433-005 | ID 20-23-433-006 | ID 20-23-433-007 | ID 20-23-433-008 RIM 647.05 RIM 647.78 BUILDING 1 BUILDING 2 BUILDING 3 (6 UNITS) (6 UNITS) (6 UNITS) F.F. 647.75 F.F. 648.75 F.F. 649.75 SIDEWALK RAMP, TYP. REFER TO 646.18 646.10 RIM 645.69 646.25 RIM 646.30 RIM 647.30 <u>RIDGE</u> 646.75 645.75 N 645.45 F.F. 647.00 F.F. 648.00 F.F. 647.00 F.F. 648.00 F.F. 649.00 F.F. 649.00 DO NOT EXCEED 2% SLOPE WITHIN BARRIER FREE PARKING AREAS. RIM 646.30 646.60 647.25 648.30 647.60 648.60 647.00 649.00 F.F. 647.25 F.F. 648.25 646.25 F.F. 649.25 **BUILDING 16 BUILDING 17** BUILDING 18 (6 UNITS) (6 UNITS) 648,76 (6 UNITS) MATCH EX. ±645.0 S89°48'40"W 955.42' MATCH EX. BOSTICK DR (40' WDE) MATCH EX. ±645.8 N89°48'40"E 300.00" TCH EX. 45.7 -FF 646.28 AT DOORS KROGER

SIDEWALK RAMP LEGEND:

SIDEWALK RAMP 'TYPE R'

SIDEWALK RAMP 'TYPE P'

REFER TO LATEST M.D.O.T. R-28 STANDARD RAMP AND DETECTABLE WARNING DETAILS

SYMBOLS: GRADING

PROPOSED SPOT GRADE ELEVATION. ALL GRADES INDICATED ARE TOP OF PAVEMENT UNLESS OTHERWISE NOTED.

----695*-*--

EARTHWORK BALANCING NOTE:

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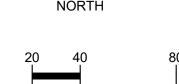
- ALL SOIL EROSION AND SEDIMENTATION CONTROL MEASURES SHALL MEET THE REQUIREMENTS OF THE CITY OF TROY. AN EROSION CONTROL PERMIT MUST BE SECURED FROM THE CITY PRIOR TO CONSTRUCTION.
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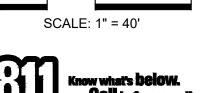


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CLIENT

TROY SPORTS CENTER, LLC 1819 EAST BIG BEAVER ROAD

PROJECT TITLE

JOHN R
COMMONS
TOWNHOME
DEVELOPMENT
PART OF THE SE 1/4 OF SECTION 23, T.
2N., R. 11E.
TROY, OAKLAND COUNTY, MI

REVISIONS

ORIGINAL ISSUE DATE: AUGUST 18, 2023 DRAWING TITLE

PRELIMINARY GRADING PLAN

18-0034 PEA JOB NO. G.M.B. C.N.R. G.M.B. DES. DRAWING NUMBER:

BENCHMARKS (GPS DERIVED - NAVD88)


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SAND BACKFILL NOTE:

ALL UTILITIES UNDER PAVEMENT OR WITHIN 3' OF THE EDGE OF PAVEMENT (OR WITHIN THE 45° LINE OF INFLUENCE OF PAVEMENT) SHALL HAVE M.D.O.T. CLASS II GRANULAR BACKFILL COMPACTED TO 95% MAX. DRY DENSITY (ASTM D-1557).

PUBLIC UTILITY EASEMENTS:

ALL SANITARY SEWERS 8" AND LARGER IN DIAMETER ARE TO BE PUBLIC AND SHALL BE LOCATED IN A 20' WIDE EASEMENT. ALL WATER MAIN SHALL BE LOCATED IN A 20' WIDE EASEMENT.

UTILITY LEGEND:

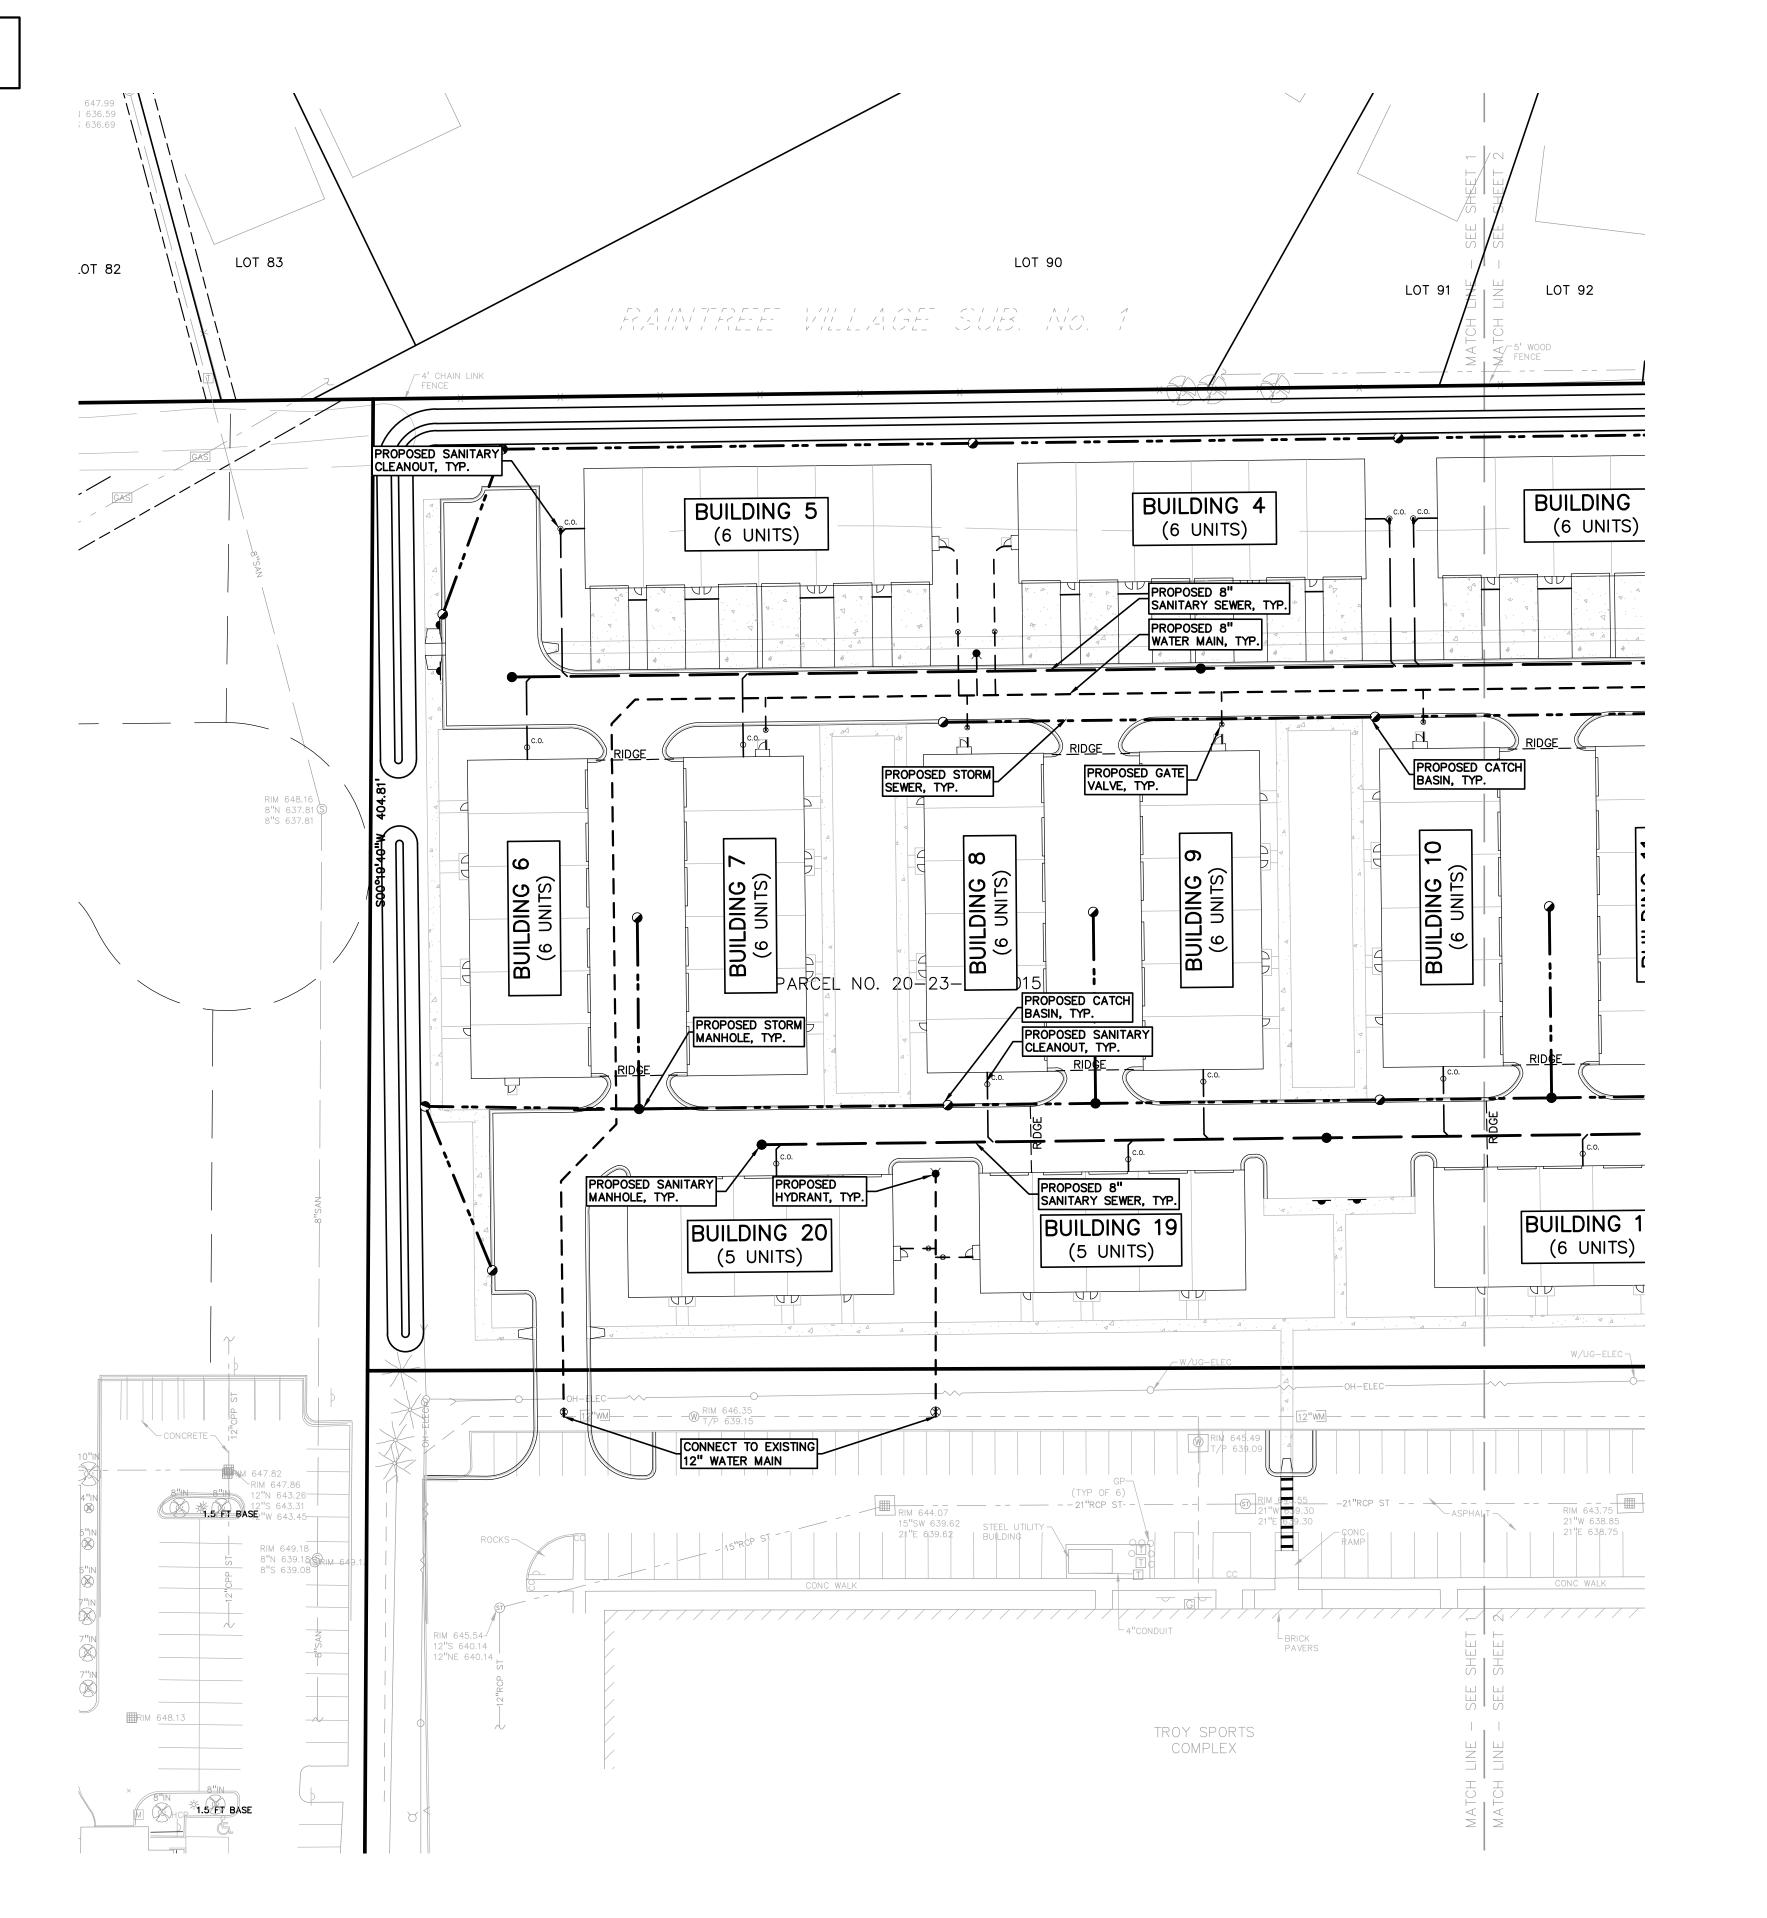-OH-ELEC-W-O- EX. OH. ELEC, POLE & GUY WIRE -UG-CATV-V EX. U.G. CABLE TV & PEDESTAL -UG-ELEC-E-E-EX. U.G. ELEC,MANHOLE, METER & HANDHOLE — – — – EX. GAS LINE © GAS EX. GAS VALVE & GAS LINE MARKER EX. TRANSFORMER & IRRIGATION VALVE — — — EX. WATER MAIN

∀ -> W EX. HYDRANT, GATE VALVE & POST INDICATOR VALVE EX. SANITARY SEWER S EX. SANITARY CLEANOUT & MANHOLE EX. COMBINED SEWER MANHOLE — EX. STORM SEWER EX. CLEANOUT & MANHOLE EX. SQUARE, ROUND, & BEEHIVE CATCH BASIN

EX. YARD DRAIN & ROOF DRAIN EX. UNIDENTIFIED STRUCTURE PROPOSED WATER MAIN PROPOSED HYDRANT AND GATE VALVE PROPOSED TAPPING SLEEVE, VALVE & WELL PROPOSED POST INDICATOR VALVE


PROPOSED SANITARY SEWER OC.O. PROPOSED SANITARY CLEANOUT & MANHOLE PROPOSED STORM SEWER ○ C.O. ■ PROPOSED STORM SEWER CLEANOUT & MANHOLE PROPOSED CATCH BASIN, INLET & YARD DRAIN

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CLIENT TROY SPORTS CENTER, LLC 1819 EAST BIG BEAVER ROAD TTOY, MI 48083

PROJECT TITLE

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ORIGINAL ISSUE DATE: AUGUST 18, 2023

DRAWING TITLE **PRELIMINARY UTILITY PLAN**

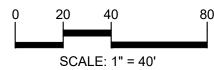PEA JOB NO. 18-0034 G.M.B. C.N.R. DES. G.M.B. DRAWING NUMBER:

NOT FOR CONSTRUCTION

BENCHMARKS (GPS DERIVED - NAVD88) ARROW ON HYDRANT WEST SIDE JOHN R ROAD 11' OF B/CURB, AND 95' SOUTH OF NORTH PROPERTY LINE OF SITE. MAG NAIL ON NORTH SIDE OF CONCRETE LIGHT POLE BASE 21' SOUTH OF CENTERLINE NANCY BOSTICK DRIVE, AND 29' EAST OF ENTRANCE TO KROGER PARKING LOT FROM SAID DRIVE. ELEV. - 648.13 ARROW ON HYDRANT FLANGE 6' NORTH OF B/CURB FOR PARKING ALONG NANCY BOSTICK DRIVE, AND ±80' WEST OF EAST BUILDING LINE OF TROY SPORTS COMPLEX. ELEV. - 647.09

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UTILITY LEGEND: -OH-ELEC-VV-O- EX. OH. ELEC, POLE & GUY WIRE -UG-CATV-V EX. U.G. CABLE TV & PEDESTAL UG-ELEC-E-E-EX. U.G. ELEC,MANHOLE, METER & HANDHOLE - --- - EX. GAS LINE © EX. GAS VALVE & GAS LINE MARKER EX. TRANSFORMER & IRRIGATION VALVE WATER MAIN SHALL BE LOCATED IN A 20' WIDE EASEMENT. — — — EX. WATER MAIN EX. WATER VALVE BOX & SHUTOFF EX. SANITARY SEWER

-UG-COMM---⊠-Ū- EX. U.G. COMMUNICATION LINE, PEDESTAL & MANHOL ∀ -○- W EX. HYDRANT, GATE VALVE & POST INDICATOR VALVE © S EX, SANITARY CLEANOUT & MANHOLE EX. COMBINED SEWER MANHOLE EX. STORM SEWER EX. CLEANOUT & MANHOLE EX. SQUARE, ROUND, & BEEHIVE CATCH BASIN EX. YARD DRAIN & ROOF DRAIN EX. UNIDENTIFIED STRUCTURE PROPOSED WATER MAIN PROPOSED HYDRANT AND GATE VALVE PROPOSED TAPPING SLEEVE, VALVE & WELL PROPOSED POST INDICATOR VALVE PROPOSED SANITARY SEWER PROPOSED SANITARY CLEANOUT & MANHOLE PROPOSED STORM SEWER


PROPOSED STORM SEWER CLEANOUT & MANHOLE

PROPOSED CATCH BASIN, INLET & YARD DRAIN







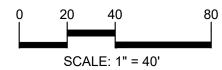



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CLIENT TROY SPORTS CENTER, LLC 1819 EAST BIG BEAVER ROAD

PROJECT TITLE JOHN R COMMONS
TOWNHOME
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PART OF THE SE 1/4 OF SECTION 23, T.


REVISIONS

2N., R. 11E.
TROY, OAKLAND COUNTY, MI

ORIGINAL ISSUE DATE: AUGUST 18, 2023

DRAWING TITLE **PRELIMINARY UTILITY PLAN**

PEA JOB NO.	18-0034
Р.М.	G.M.B.
ON.	C.N.R.
DES.	G.M.B.
DRAWING NUMBER:	

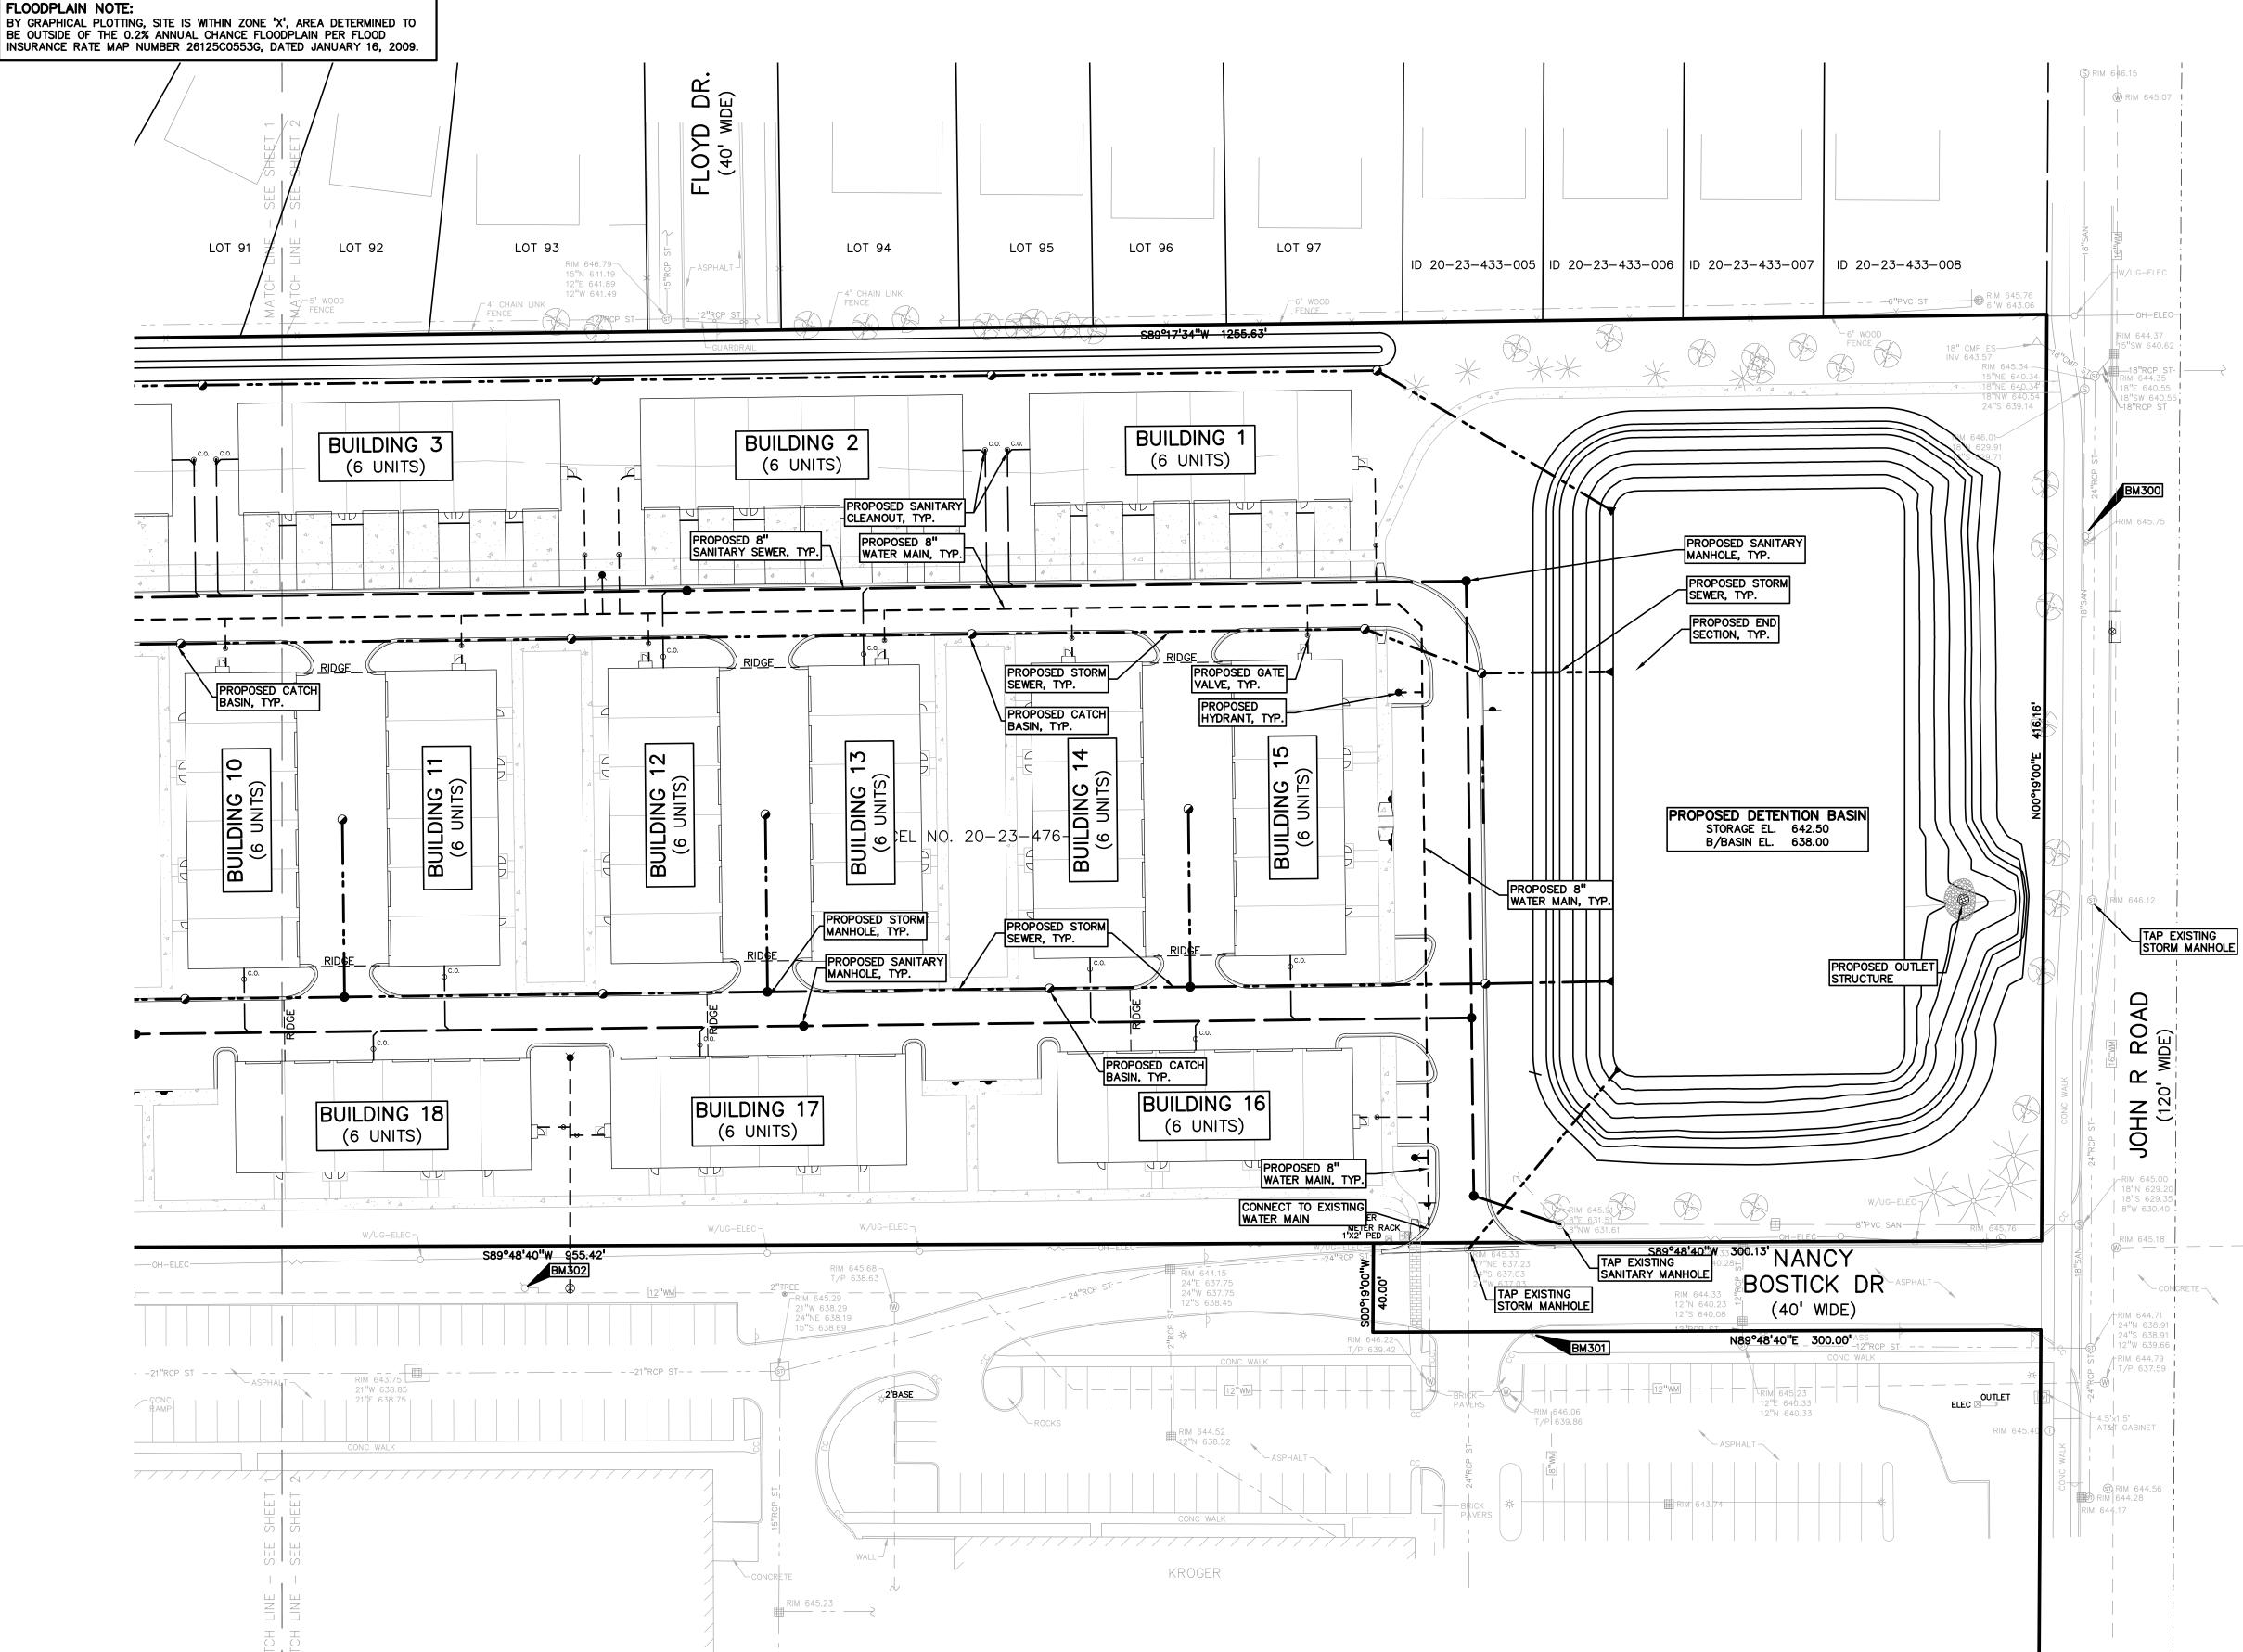

Rainfall Intensity	-	
Time of Concentration (T _C)	20.00	min
Since 15 <tc<60, equation<="" intensity="" td="" use=""><td></td><td></td></tc<60,>		
I1 = 30.2 /[(T + 9.17)^.81]	1.97	in/hr
I10 = 50.12 / [(T + 9.17)^.81]	3.26	in/hr
1100 = 83.3/[(T + 9.17)^.81]	5.42	in/hr
CPVC: Channel Protection Volume Control Vol	lume	
Vcpvc = (4719)CA	43,095	cf
CPRC: Channel Protection Rate Control Volum	e: Extended l	Detention
VED= (6897)CA	62,985	cf
CPRC Allowable Outlet Rate		
$Q_{VED} = V_{ED} / (48*60*60)$	0.36	cfs
Water Quality Control		
Forebay Volume = (545)CA	4,977	cf
Forebay Release Rate: QVF = VF/(48*60*60)	0.03	cfs
100-Year Allowable Outlet Rate		
Since 2 <a<100, qvrr="1.1055-0.206xln(A)</td"><td></td><td></td></a<100,>		
Q _{VRR} =	0.60	cfs/ac
100-Year Peak Allowable Discharge		
Area, A =	11.86	ac
$Q_{100P} = Q_{VRR}(A)$	7.07	cfs
100-Year Runoff Volume		
V100R = (18,985)CA	173,376	cf
100-Year Peak Inflow		
$Q_{100IN} = C(I_{100})A$	49.50	cfs
Storage Curve Factor (Vs/Vr)		
R = 0.206-0.15 x In(Q100P/Q100IN)	0.498	
100-Year Storage Volume		
Vs = R(V100R)	86,341	cf
Infiltration will be provided. CPVC can be ded	_	
V100 = Vs-Vcpvc EXISTING VOLUME FROM TROY SPORTS DEVE	86,341 ELOPMENT	cf
	111,472	cf
V _{TROYSPORTS} = DETENTION VOLUME REQUIRED =	197,813	
DETENTION VOLUME REQUIRED =	187,013	U
Design Requirements		
CPRC Extended Detention: V _{ED} =	62,98	
CPRC Allowable Outlet Rate: Q _{VED} =		6 cfs
	407.04	3 of
100-Year Storage Volume, V _{100D} =	197,81	5 61
100-Year Storage Volume, V _{100D} = 100-Year Allowable Outlet Rate: Q _{VRR} =		or cfs

639.62 642.31 Vol. (cf)

36,856

42,054

47,575

53,415

28,935

CPRC Storage Elevation:

100-yr Storage Elevation:

Bottom Elevation of Pond:

638.00 639.00

640.00

641.00

642.00

642.50

643.50

Area (sf)

34,362

39,349

44,758

56,439

59,300

62,985 cf

197,813 cf

Total Vol. (cf)

36,856


78,909

126,484

179,899 208,833


208,833

638.00

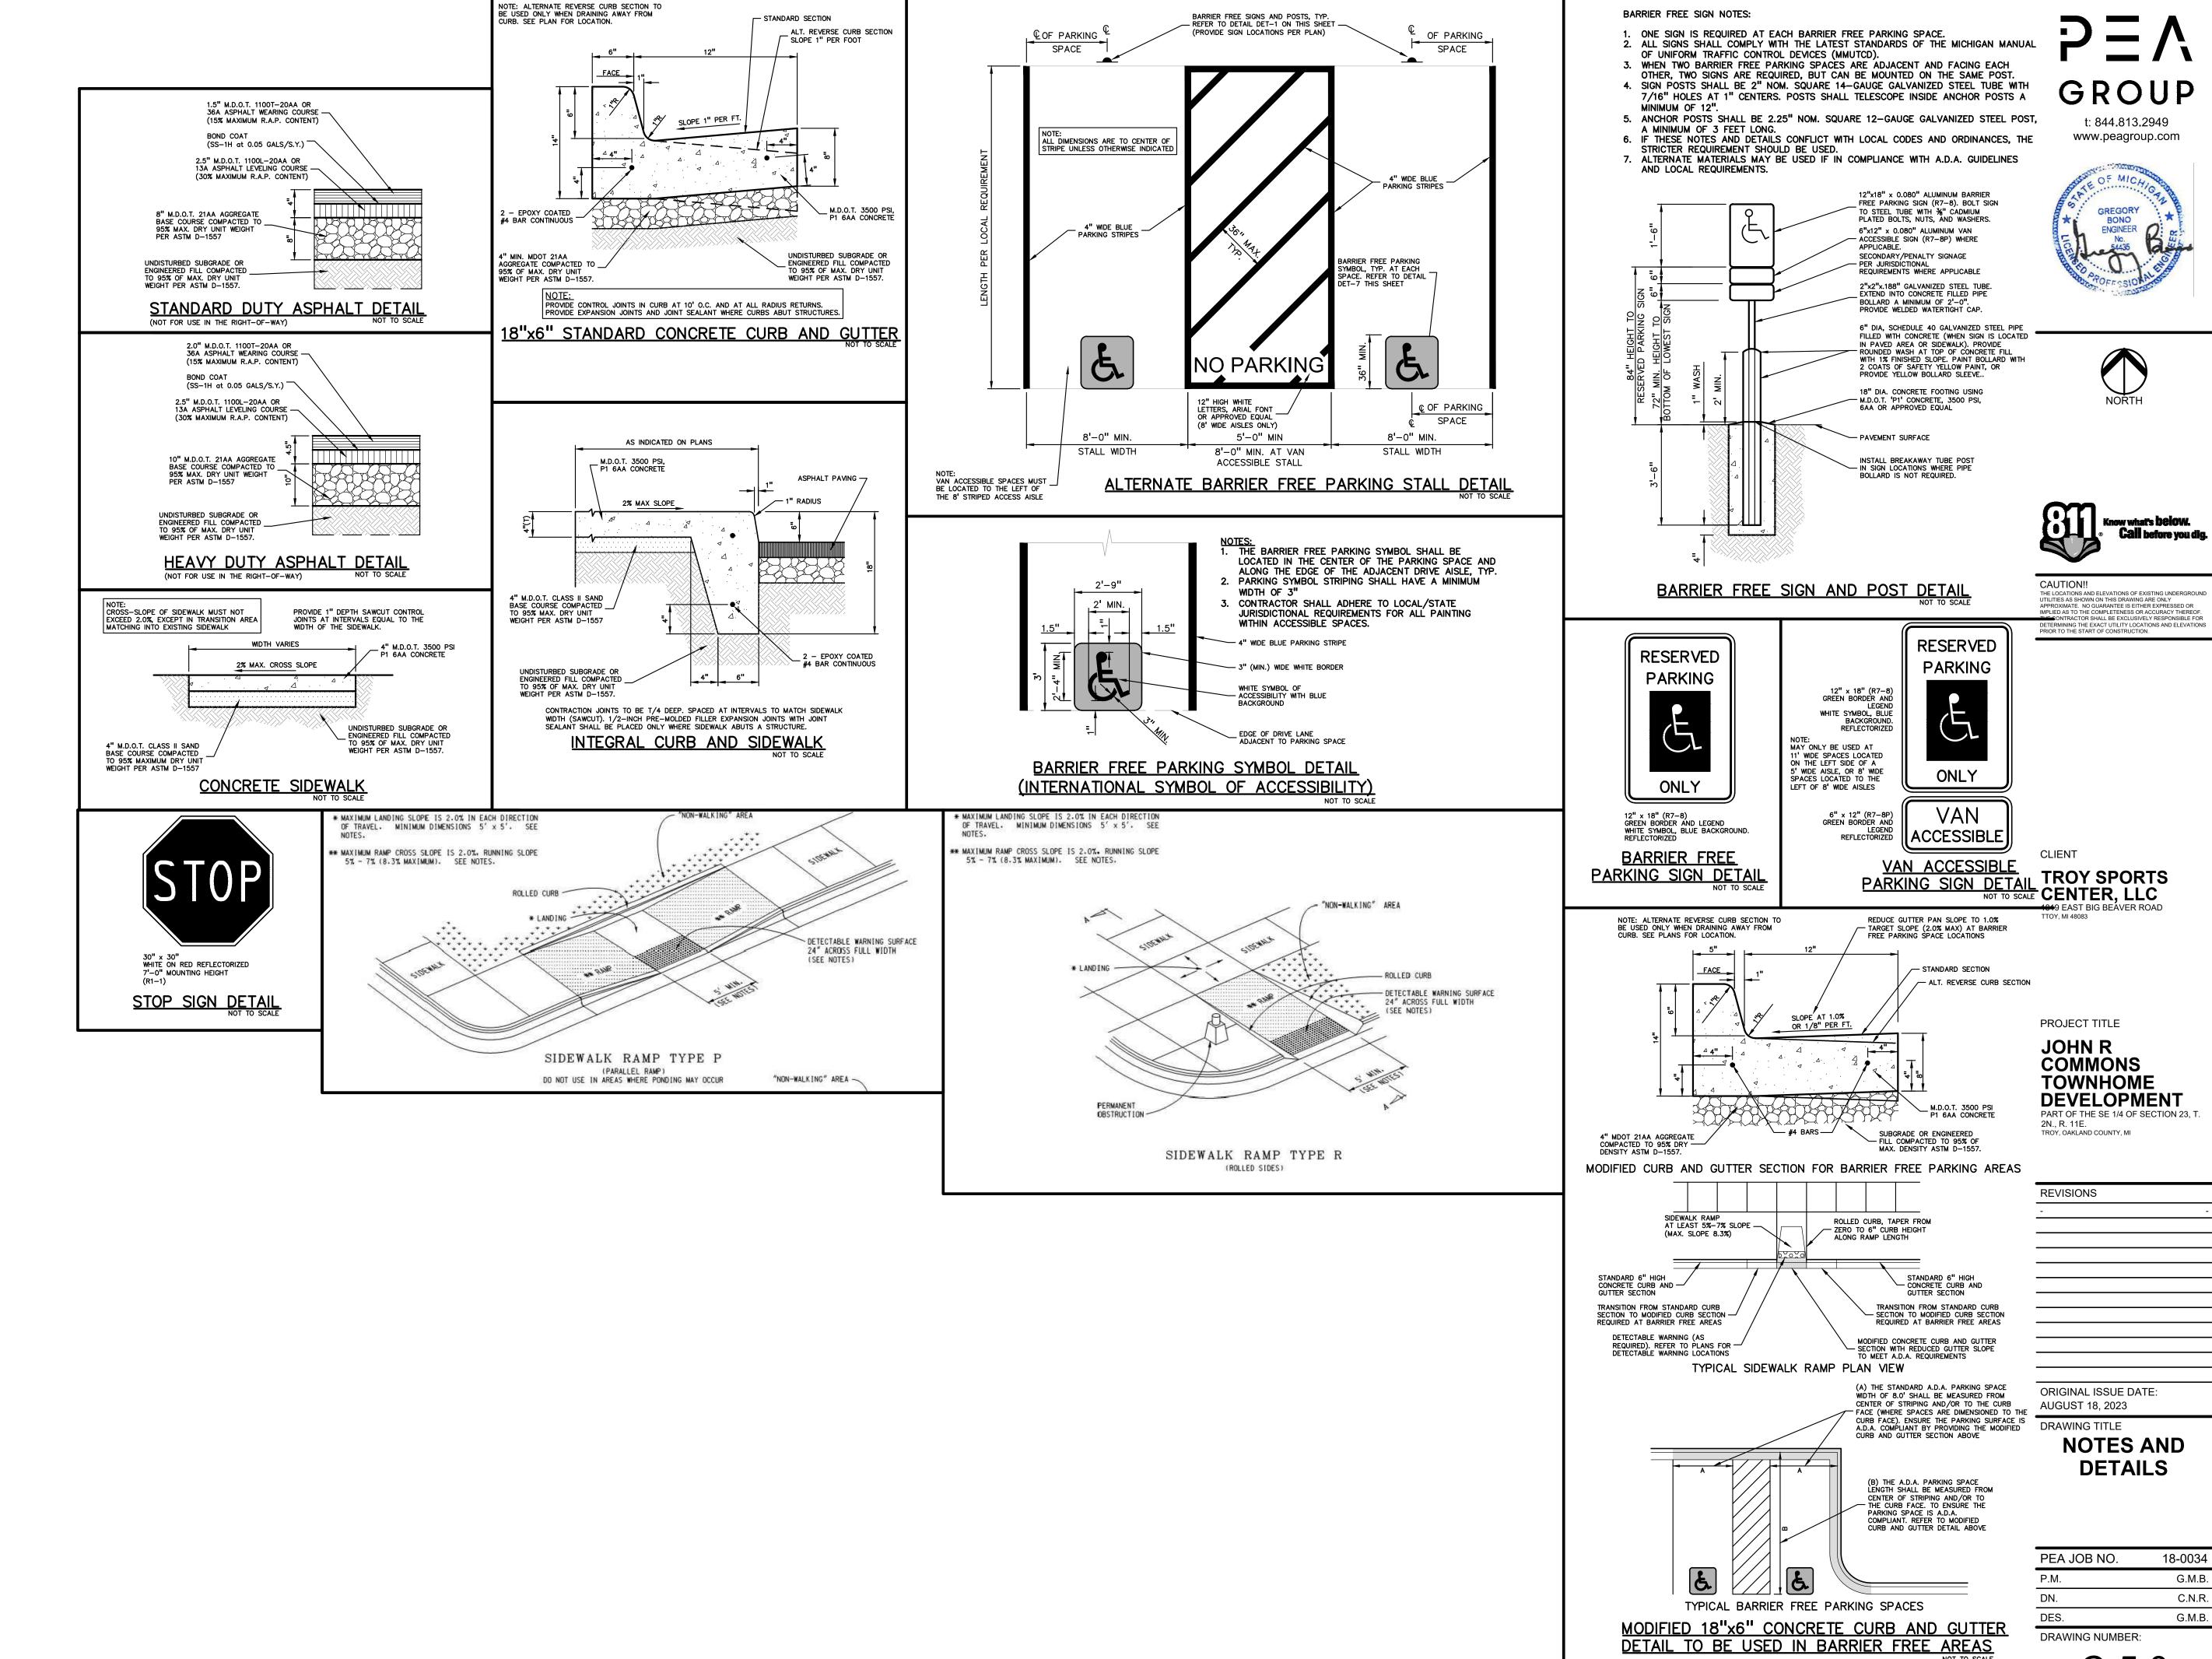



NOT FOR CONSTRUCTION

C-5.0

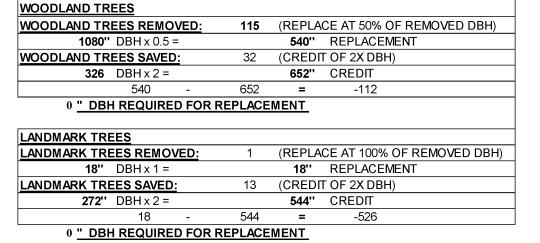

<u>S)</u>		
53	Trees	
		•

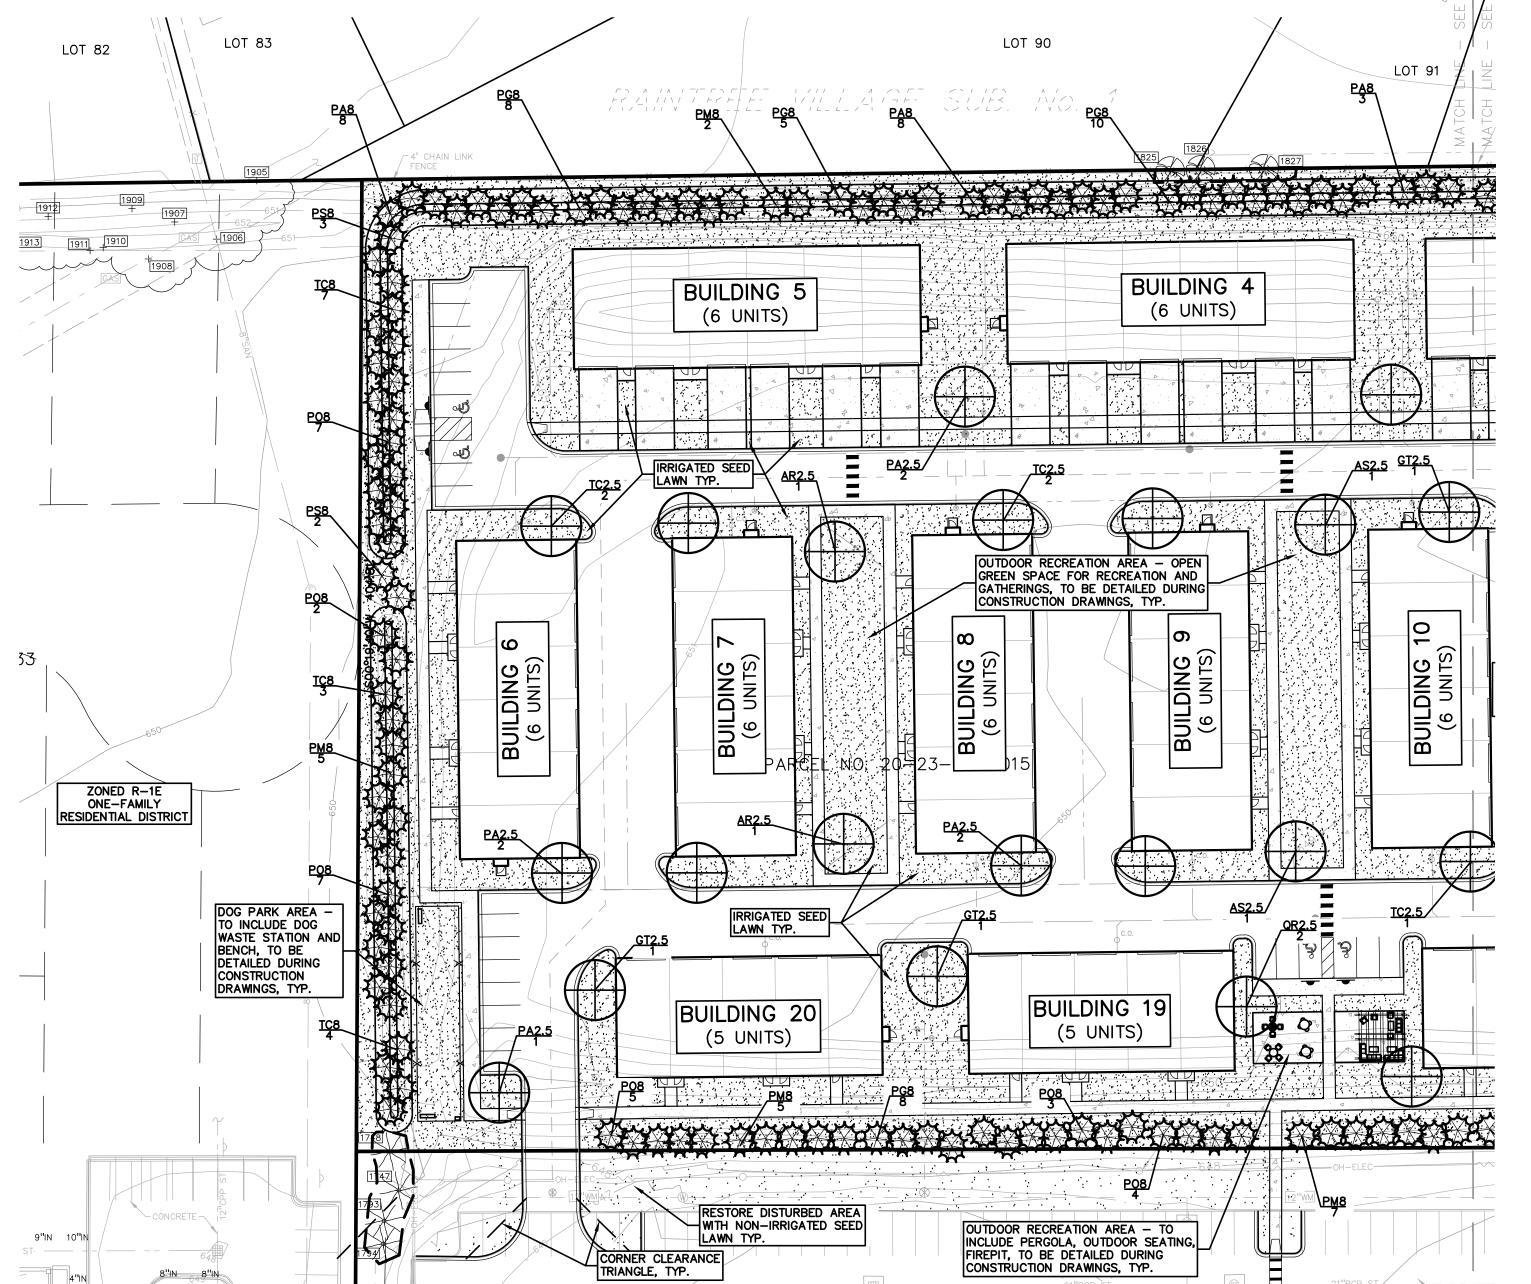

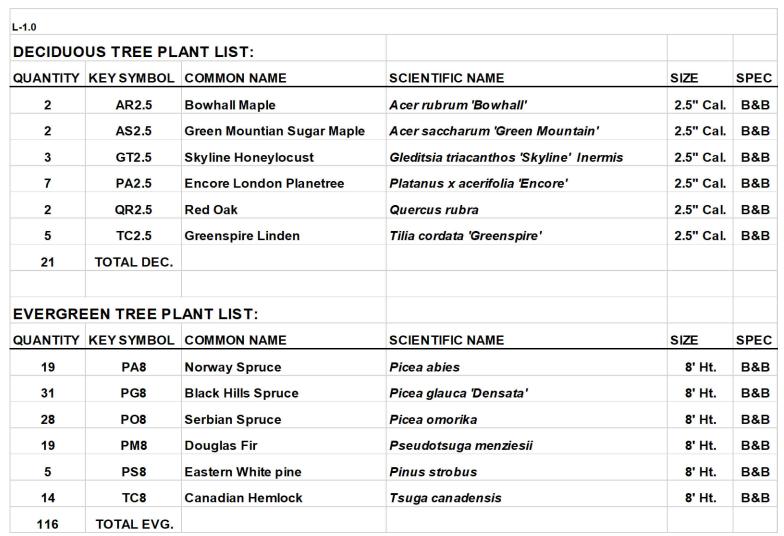

LANDSCAPE CONTRACTOR SHALL VISIT SITE, INSPECT EXISTING SITE CONDITIONS AND REVIEW

CONSTRUCTION ON HIS/HER PHASE OF WORK. ELECTRIC. GAS. TELEPHONE. CABLE TELEVISION

ALL PLANT MATERIAL TO BE PREMIUM GRADE NURSERY STOCK AND SHALL SATISFY AMERICAN

ASSOCIATION OF NURSERYMEN STANDARD FOR NURSERY STOCK. ALL LANDSCAPE MATERIAL

. CONTRACTOR IS RESPONSIBLE FOR VERIFYING ALL QUANTITIES SHOWN ON LANDSCAPE PLAN

THE OWNER'S REPRESENTATIVE RESERVES THE RIGHT TO REJECT ANY PLANT MATERIAL NOT

6. ALL SINGLE STEM SHADE TREES TO HAVE STRAIGHT TRUNKS AND SYMMETRICAL CROWNS.

SIDED TREES OR THOSE WITH THIN OR OPEN CROWNS SHALL NOT BE ACCEPTED.

IN SHAPE AND NOT SHEARED FOR THE LAST FIVE GROWING SEASONS.

LAWN AREAS WITHIN THE DRIP LINE OF EXISTING TREES.

15. ALL LANDSCAPED AREAS SHALL RECEIVE 3" COMPACTED TOPSOIL.

ALL SINGLE TRUNK SHADE TREES TO HAVE A CENTRAL LEADER; TREES WITH FORKED OR

. ALL MULTI STEM TREES SHALL BE HEAVILY BRANCHED AND HAVE SYMMETRICAL CROWNS. ONE

9. ALL EVERGREEN TREES SHALL BE HEAVILY BRANCHED AND FULL TO THE GROUND, SYMMETRICAL

10. ALL TREES TO HAVE CLAY OR CLAY LOAM BALLS, TREES WITH SAND BALLS WILL BE REJECTED. 1. NO MACHINERY IS TO BE USED WITHIN THE DRIP LINE OF EXISTING TREES; HAND GRADE ALL

12. ALL TREE LOCATIONS SHALL BE STAKED BY LANDSCAPE CONTRACTOR AND ARE SUBJECT TO

EMERGENT, SEE SPECIFICATIONS. SHREDDED PALETTE AND DYED MULCH WILL NOT BE ACCEPTED.

16. SEE SPECIFICATIONS FOR ADDITIONAL COMMENTS, REQUIREMENTS, PLANTING PROCEDURES AND

17. FOR NON-LAWN SEED MIX AREAS, AS NOTED ON PLAN, BRUSH MOW ONCE SEASONALLY FOR

18. CONTRACTOR SHALL NOT INSTALL PLANTS UNDER BUILDING OVERHANG AND SHALL NOTIFY

19. TREES SHALL NOT CONFLICT/ BLOCK PROPOSED REGULATORY/ DIRECTION SIGNAGE, MONUMENT SIGNS, ADDRESS OR LIGHT POLES. SHIFT TREES AS NECESSARY TYP.

LANDSCAPE ARCHITECT IF DRAWINGS CONFLICT WITH BUILDING OVERHANGS.

THE APPROVAL OF THE LANDSCAPE ARCHITECT PRIOR TO INSTALLATION OF THE PLANT

13. IT IS MANDATORY THAT POSITIVE DRAINAGE IS PROVIDED AWAY FROM ALL BUILDINGS.

14. ALL PLANTING BEDS SHALL RECEIVE 3" SHREDDED HARDWOOD BARK MULCH WITH PRE

MAY BE LOCATED BY CALLING MISS DIG 1-800-482-7171. ANY DAMAGE OR INTERRUPTION OF SERVICES SHALL BE THE RESPONSIBILITY OF CONTRACTOR. CONTRACTOR SHALL COORDINATE ALL RELATED ACTIVITIES WITH OTHER TRADES ON THE JOB AND SHALL REPORT ANY

PROPOSED PLANTING AND RELATED WORK. IN CASE OF DISCREPANCY BETWEEN PLAN AND PLANT LIST, PLAN SHALL GOVERN QUANTITIES. CONTACT LANDSCAPE ARCHITECT WITH ANY

CONTRACTOR SHALL VERIFY LOCATIONS OF ALL ON SITE UTILITIES PRIOR TO BEGINNING

UNACCEPTABLE JOB CONDITIONS TO OWNER'S REPRESENTATIVE PRIOR TO COMMENCING.

GENERAL PLANTING NOTES:

SHALL BE NORTHERN GROWN, NO. 1. GRADE.

IRREGULAR TRUNKS WILL NOT BE ACCEPTED.

PRIOR TO PRICING THE WORK.


MEETING SPECIFICATIONS.

MATERIAL.

WARRANTY STANDARDS.


INVASIVE SPECIES CONTROL.



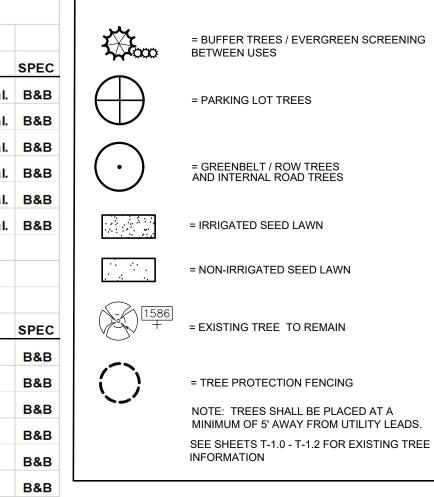

KEY:



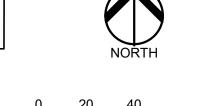



CAUTION!! THE LOCATIONS AND ELEVATIONS OF EXISTING UNDERGROUND UTILITIES AS SHOWN ON THIS DRAWING ARE ONLY APPROXIMATE. NO GUARANTEE IS EITHER EXPRESSED OR IMPLIED AS TO THE COMPLETENESS OR ACCURACY THEREOF. THE CONTRACTOR SHALL BE EXCLUSIVELY RESPONSIBLE FOR DETERMINING THE EXACT UTILITY LOCATIONS AND ELEVATIONS PRIOR TO THE START OF CONSTRUCTION.

PROVIDED: LANDSCAPE HEDGE SCREEN WHERE VISIBLE ON JOHN R. RD

337 PARKING SPACES / 8 = 42.25 TREES REQUIRED

REQUIRED: 5.03. B-1 = SCREENING HEDGE IF VISIBLE TO PUBLIC ROAD

LANDSCAPE CALCULATIONS:
PER CITY OF TROY ZONING ORDINANCE: MF - MULTIFAMILY RESIDENTIAL

REQUIRED: 1 NARROW EVG. TREE/3 FT OR 1 LARGE EVG. TREE/10 LF

5.03 C-1a. = GENERAL SITE LANDSCAPE
REQUIRED: 20% OF SITE AREA SHALL BE LANDSCAPE MATERIAL
516,625 SF * 20% = 103,325 SQ FT REQUIRED

PROVIDED: 173,048 SQ FT LANDSCAPE

NORTH SIDE: 1,255.63 LF /10 = 125.6 LARGE EVG.

WEST SIDE: 40 LARGE EVG. SOUTH SIDE: 72 LARGE EVG. AND 24 NARROW EVG.

13.02 C. PARKING LOT LANDSCAPE REQUIRED: 13.02 C2.= 1 TREE PER 8 SPACES

NORTH SIDE: 120 LARGE EVG. AND 6 EXISTING EVG. TREES

WEST SIDE: 401.41 LF /10 = 40.1 LARGE EVG.

13.02 B. SCREENING BETWEEN USES R-1D TO NORTH SIDE OF SITE.

SOUTH SIDE: 959 LF /10 = 95.9

REQUIRED: 1 TREE / 30 LF OF FRONTAGE TO PUBLIC RD. JOHN R. ROAD = 417.64 LF FRONTAGE / 30 = 13.9 TREES PROVIDED: 3 PROPOSED TREES AND 11 EXISTING TREES TO REMAIN ALONG

PER CITY OF TROY ZONING ORDINANCE; **SOUTH EAST END OF SITE** INTERNAL PUBLIC ROADS STREET TREES

NANCY BOSTICK DRIVE: 300 LF / 50 LF = 6 TREES * 2 (BOTH SIDES RD.) = 12 TREES

PROVIDED: 1 PROPOSED TREE AND 11 EXISTING TREES ON BOTH SIDES OF NANCY BOSTICK DRIVE TO REMAIN

TREE REPLACEMENT:

WOODLAND TREES: WOODLAND TREES REMOVED (115 TREES): REPLACE AT 50% OF REMOVED DBH 1080" DBH \times .5 = 540" REPLACEMENT

WOODLAND TREES SAVED (32 TREES): CREDIT OF 2X DBH 326" DBH X 2 = 656" CREDIT 540" - 652"= -112" NO REPLACEMENT REQUIRED

LANDMARK TREES: LANDMARK TREES REMOVED (1 TREES): REPLACE AT 100% OF REMOVED DBH 18" DBH X 1 = 18" REPLACEMENT LANDMARK TREES SAVED (13 TREES): CREDIT OF 2X DBH

18"-544" = -526" NO REPLACEMENT REQUIRED

*NOTE: TREES SHALL BE PLACED AT A MINIMUM OF

5' AWAY FROM UTILITY LEADS.

 $272" \times 2 = 544" \text{ CREDIT}$

TROY SPORTS CENTER, LLC 1819 EAST BIG BEÁVER ROAD

TTOY, MI 48083

PROJECT TITLE


JOHN R **COMMONS TOWNHOME DEVELOPMENT** PART OF THE SE 1/4 OF SECTION 23, T 2N., R. 11E. TROY, OAKLAND COUNTY, MI


REVISIONS

ORIGINAL ISSUE DATE: AUGUST 18, 2023

DRAWING TITLE **PRELIMINARY** LANDSCAPE **PLAN - WEST**

PEA JOB NO.	18-003
P.M.	G.M.E
DN.	BG
DES.	JLE
DRAWING NUMBER:	

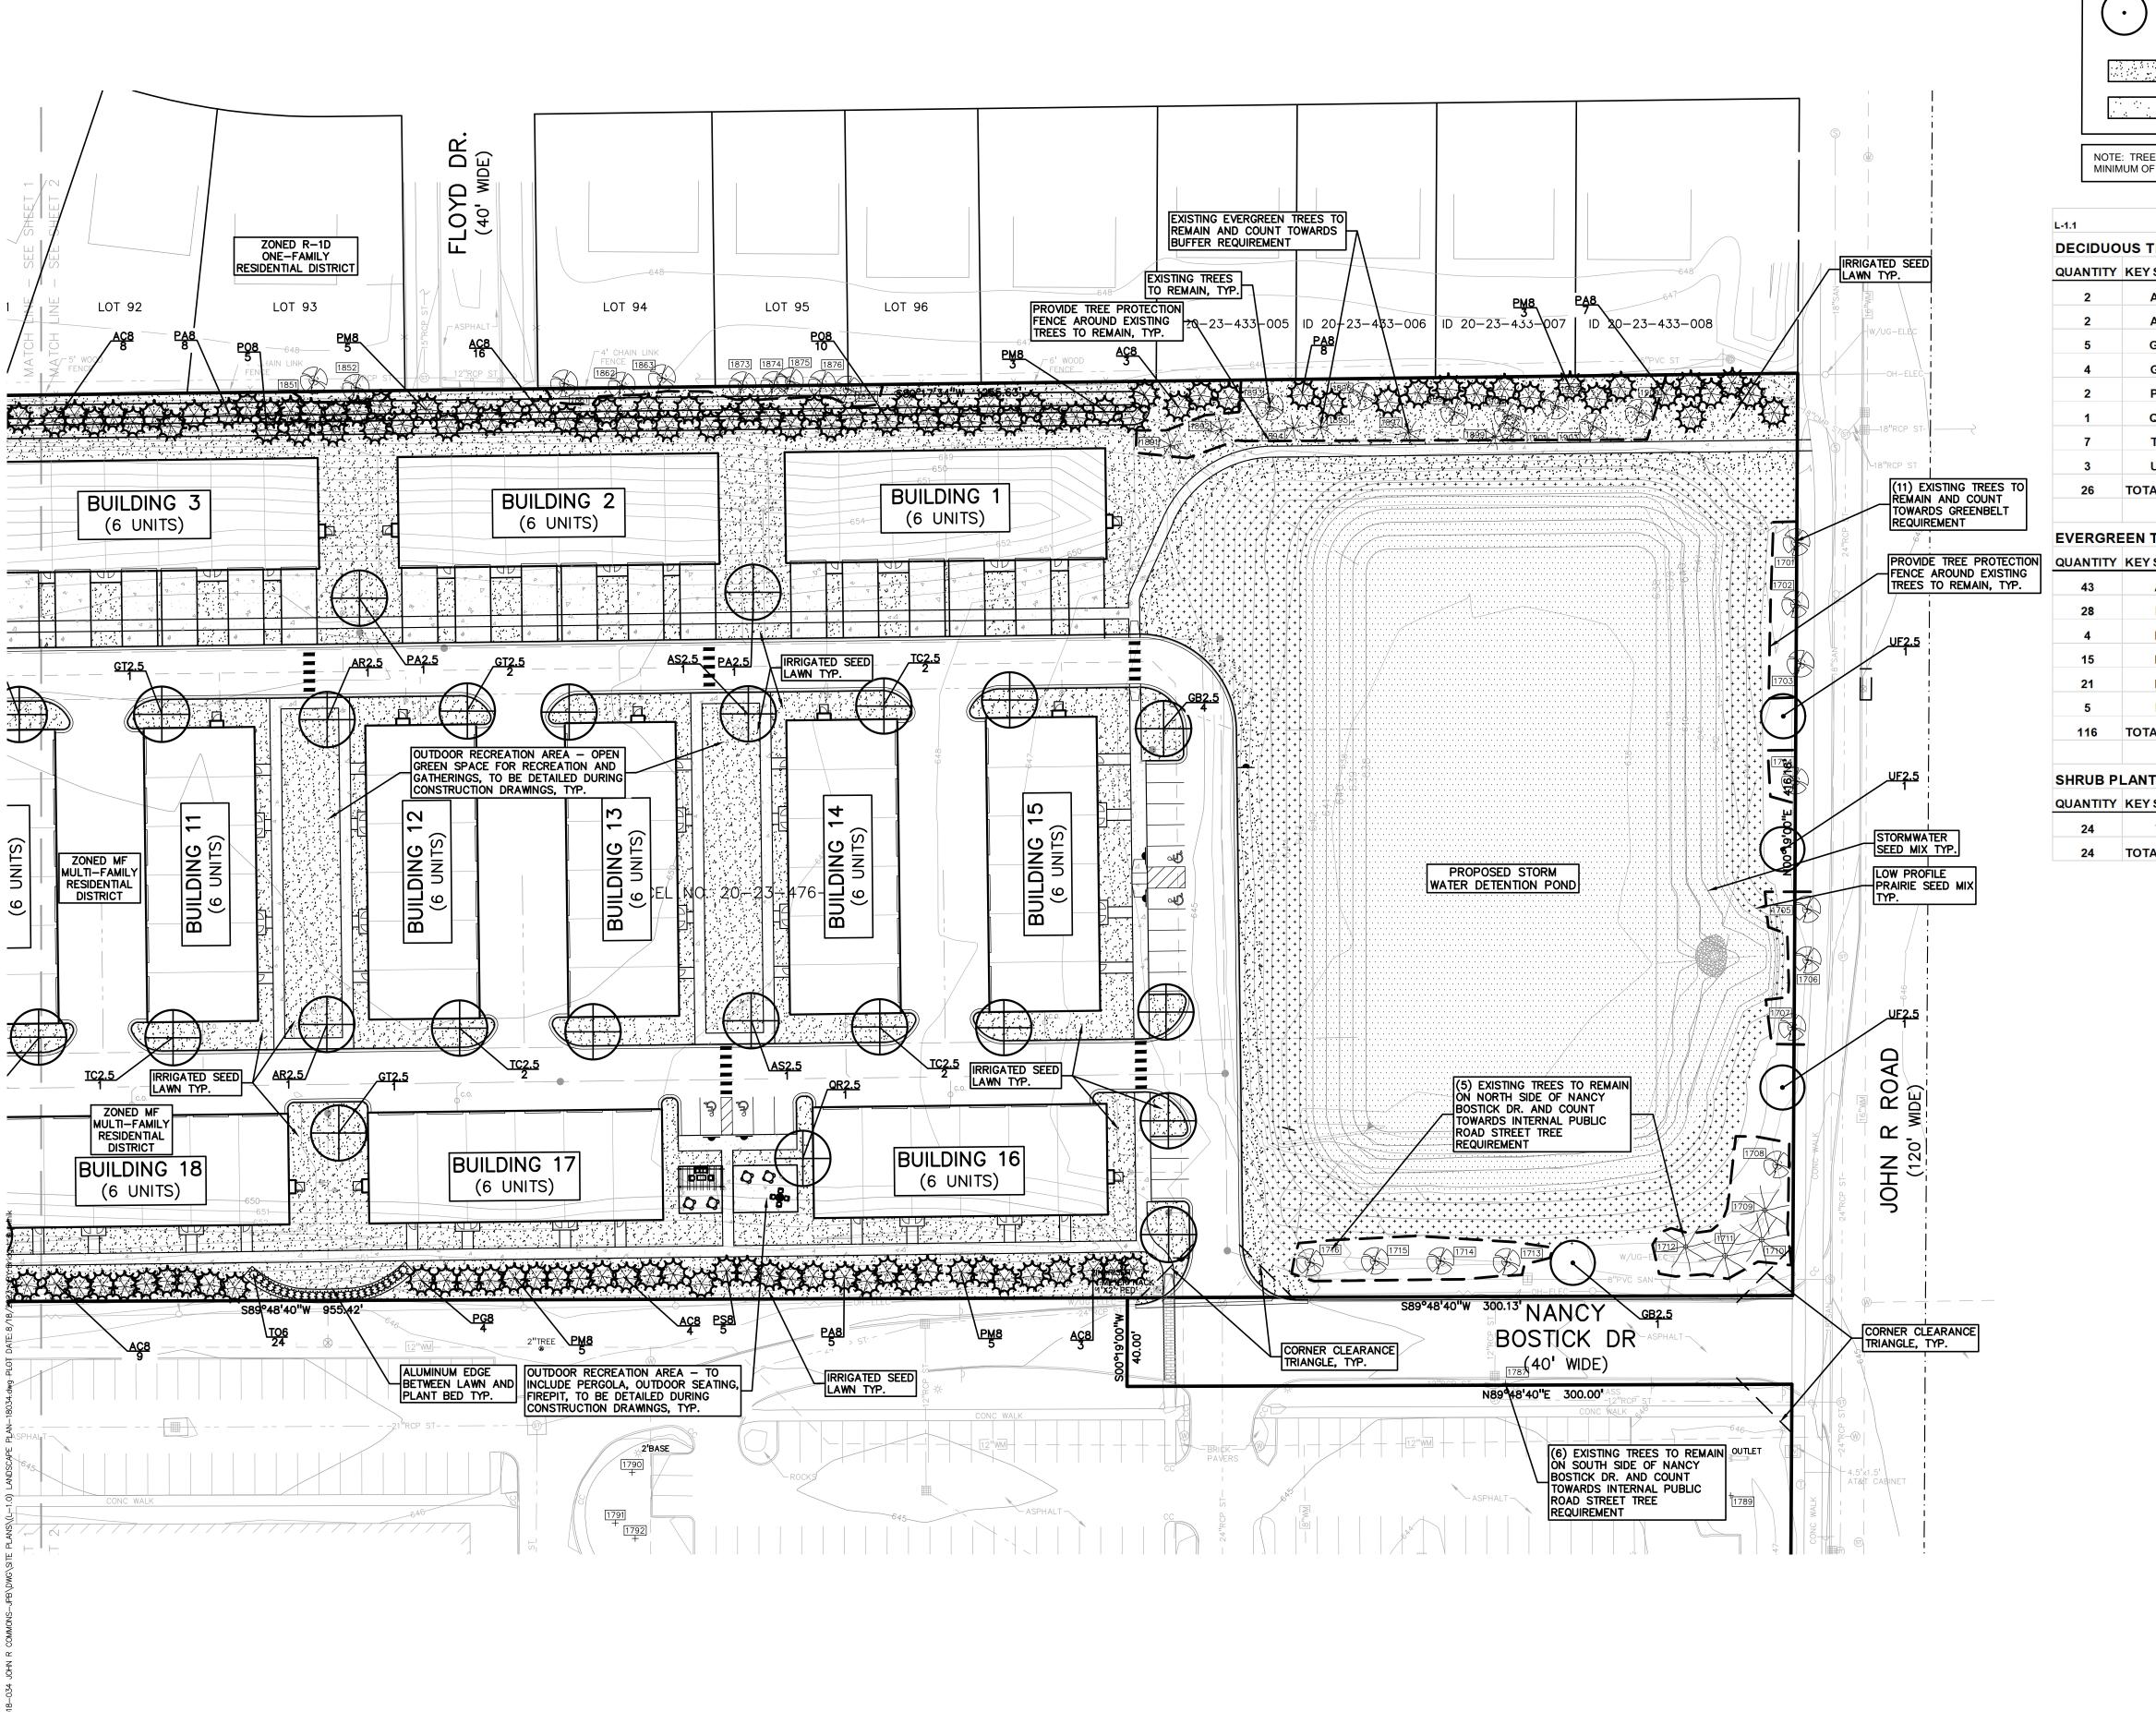

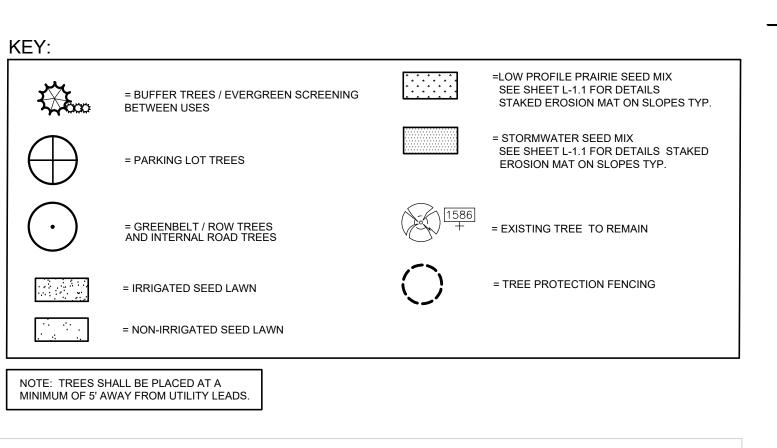


L-1.1					
DECIDUO	US TREE PL	ANT LIST:			
QUANTITY	KEY SYMBOL	COMMON NAME	SCIENTIFIC NAME	SIZE	SPEC
2	AR2.5	Bowhall Maple	Acer rubrum 'Bowhall'	2.5" Cal.	B&B
2	AS2.5	Green Mountian Sugar Maple	Acer saccharum 'Green Mountain'	2.5" Cal.	B&B
5	GB2.5	Magyar Ginkgo	Ginkgo biloba 'Magyar'	2.5" Cal.	B&B
4	GT2.5	Skyline Honeylocust	Gleditsia triacanthos 'Skyline' Inermis	2.5" Cal.	B&B
2	PA2.5	Encore London Planetree	Platanus x acerifolia 'Encore'	2.5" Cal.	B&B
1	QR2.5	Red Oak	Quercus rubra	2.5" Cal.	B&E
7	TC2.5	Greenspire Linden	Tilia cordata 'Greenspire'	2.5" Cal.	B&E
3	UF2.5	Frontier Elm	Ulmus 'Frontier'	2.5" Cal.	B&E
26	TOTAL DEC.				
EVERGRI	EEN TREE PL	ANT LIST:			
QUANTITY	KEY SYMBOL	COMMON NAME	SCIENTIFIC NAME	SIZE	SPEC
QUANTITY 43	KEY SYMBOL AC8	COMMON NAME Concolor Fir	SCIENTIFIC NAME Abies concolor	SIZE 8' Ht.	
					B&E
43	AC8	Concolor Fir	Abies concolor	8' Ht.	B&B
43 28	AC8 PA8	Concolor Fir Norway Spruce	Abies concolor Picea abies	8' Ht. 8' Ht.	B&B B&B B&B
43 28 4	AC8 PA8 PG8	Concolor Fir Norway Spruce Black Hills Spruce	Abies concolor Picea abies Picea glauca 'Densata'	8' Ht. 8' Ht. 8' Ht.	B&B B&B B&B
43 28 4 15	AC8 PA8 PG8 PO8	Concolor Fir Norway Spruce Black Hills Spruce Serbian Spruce	Abies concolor Picea abies Picea glauca 'Densata' Picea omorika	8' Ht. 8' Ht. 8' Ht. 8' Ht.	B&E B&E B&E B&E
43 28 4 15 21	AC8 PA8 PG8 PO8 PM8	Concolor Fir Norway Spruce Black Hills Spruce Serbian Spruce Douglas Fir	Abies concolor Picea abies Picea glauca 'Densata' Picea omorika Pseudotsuga menziesii	8' Ht. 8' Ht. 8' Ht. 8' Ht. 8' Ht.	B&E B&E B&E B&E
43 28 4 15 21 5	AC8 PA8 PG8 PO8 PM8 PS8	Concolor Fir Norway Spruce Black Hills Spruce Serbian Spruce Douglas Fir	Abies concolor Picea abies Picea glauca 'Densata' Picea omorika Pseudotsuga menziesii	8' Ht. 8' Ht. 8' Ht. 8' Ht. 8' Ht.	B&E B&E B&E B&E
43 28 4 15 21 5 116	AC8 PA8 PG8 PO8 PM8 PS8 TOTAL EVG.	Concolor Fir Norway Spruce Black Hills Spruce Serbian Spruce Douglas Fir	Abies concolor Picea abies Picea glauca 'Densata' Picea omorika Pseudotsuga menziesii	8' Ht. 8' Ht. 8' Ht. 8' Ht. 8' Ht.	B&B B&B B&B B&B B&B
43 28 4 15 21 5 116	AC8 PA8 PG8 PO8 PM8 PS8 TOTAL EVG.	Concolor Fir Norway Spruce Black Hills Spruce Serbian Spruce Douglas Fir Eastern White pine	Abies concolor Picea abies Picea glauca 'Densata' Picea omorika Pseudotsuga menziesii Pinus strobus	8' Ht. 8' Ht. 8' Ht. 8' Ht. 8' Ht.	B&B B&B B&B B&B B&B B&B B&B B&B

t: 844.813.2949

www.peagroup.com





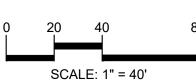



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CLIENT

TROY SPORTS CENTER, LLC 1819 EAST BIG BEAVER ROAD

PROJECT TITLE JOHN R COMMONS
TOWNHOME
DEVELOPMENT
PART OF THE SE 1/4 OF SECTION 23, T. 2N., R. 11E.
TROY, OAKLAND COUNTY, MI

REVISIONS

ORIGINAL ISSUE DATE: AUGUST 18, 2023 DRAWING TITLE

PRELIMINARY LANDSCAPE **PLAN - EAST**

PEA JOB NO.	18-0034
P.M.	G.M.B
DN.	BGG
DES.	JLE
DRAWING NUMBER:	

Low-profile Prairie Seed Mix Stantec Native Plant Nursery 574-586-2412 stantec.com/native-plant-nursery

Botanical Name Common Name Permanent Grasses: Bouteloua curtipendula Side Oats Grama Prairie Carex Mix Carex spp. Canada Wild Rye Elymus canadensis June Grass Koeleria pyramidata Panicum virgatum Switch Grass Schizachyrium scoparium Little Bluestem

Temporary Cover: Avena sativa Lolium multiflorum

Common Oat Annual Rye

Lead Plant Amorpha canescens Anemone cylindrica ThimbleWeed Common Milkweed Asclepias syriaca Asclepias tuberosa Butterfly MilkWeed Baptisia alba White Wild Indigo Chamaecrista fasciculata Partridge Pea Sand Coreopsis Coreopsis lanceolata Coreopsis palmata Prairie Coreopsis Dalea candida White Prairie Clover Dalea purpurea Desmanthus illinoensis

Purple Prairie Clover Illinois Sensitive Plant Echinacea purpurea Broad-Leaved Purple Coneflower Rattlesnake Master Eryngium yuccifolium Lespedeza capitata Round-Head Bush Clover Rough Blazing Star Liatris aspera Lupinus perennis Wild Lupine Monarda fistulosa Wild Bergamot Oligoneuron rigidum Stiff Goldenrod Parthenium integrifolium Wild Quinine Penstemon digitalis Foxglove Beard Tongue Hairy Beard Tongue Penstemon hirsutus Common Mountain Mint Pycnanthemum virginianum Yellow Coneflower Ratibida pinnata Rudbeckia hirta Black-Eyed Susan Rudbeckia subtomentosa Sweet Black-Eyed Susan

Prairie Dock

Solidago speciosa Showy Goldenrod Symphyotrichum ericoides Heath Aster Smooth Blue Aster Symphyotrichum laeve Symphyotrichum novae-angliae New England Aster Tradescantia ohiensis Common Spiderwort Verbena stricta Hoary Vervain Ironweed (Various Mix) Vernonia spp. Veronicastrum virginicum Culvers Root

Silphium terebinthinaceum

Stormwater Seed Mix Stantec Native Plant Nursery 574-586-2412 stantec.com/native-plant-nursery

Botanical Name Common Name Permanent Grasses/Sedges/Rushes: Bolboschoenus fluviatilis River Bulrush Carex cristatella Crested Oval Sedge Bottlebrush Sedge Carex lurida Carex vulpinoidea Brown Fox Sedge Virginia Wild Rye Elymus virginicus Glyceria striata Juncus effusus Leersia oryzoides Panicum virgatum

Scirpus atrovirens

Scirpus cyperinus

Avena sativa

Alisma spp.

Bidens spp.

Iris virginica

Temporary Cover:

Lolium multiflorum

Forbs & Shrubs:

Asclepias incamata

Helenium autumnale

Lycopus americanus

Mimulus ringens

Polygonum spp.

Rudbeckia triloba

Sagittaria latifolia

Senna hebecarpa

Thalictrum dasycarpum

Oligoneuron riddellii

Penthorum sedoides


Rudbeckia subtomentosa

Symphyotrichum novae-angliae

Fowl Manna Grass Common Rush Rice Cut Grass Switch Grass Schoenoplectus tabernaemontani Softstem Bulrush Dark Green Rush Wool Grass

> Common Oat Annual Rye

> > Water Plantain (Various Mix) Swamp Milkweed Bidens (Various Mix) Sneezeweed Blue Flag Common Water Horehound Monkey Flower Riddell's Goldenrod Ditch Stonecrop Pinkweed (Various Mix) Sweet Black-Eyed Susan Brown-Eyed Susan Common Arrowhead Wild Senna New England Aster Purple Meadow Rue

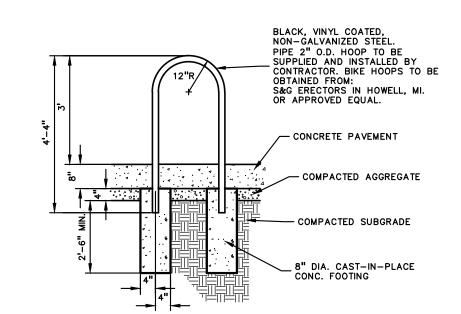

BIKE RACK DETAIL, OR EQUAL




BENCH: 72" PLAINWELL, ALUMINUM BY: LANDSCAPE FORMS OR APPROVED EQUAL PHONE: 800-521-2546 COLOR: TITANIUM OR SILVER, POWDER COATED, OWNER TO SELECT/APPROVE COLOR


QUANTITY: X, QTY. TO BE APPROVED BY OWNER



LITTER CONTAINER: PLAINWELL, ALUMINUM WITH SIDE OPEN LID AT 30"x38" HIGH BY: LANDSCAPE FORMS OR APPROVED EQUAL PHONE: 800-521-2546 COLOR: TITANIUM OR SILVER, POWDER COATED, OWNER TO SELECT/APPROVE COLOR QUANTITY: X QTY. TO BE APPROVED BY OWNER

BENCH AND LITTER IMAGE DETAIL, OR EQUAL NOT TO SCALE

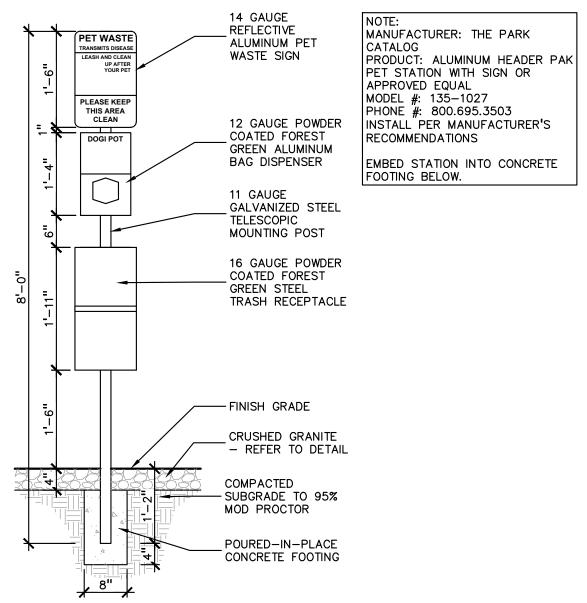


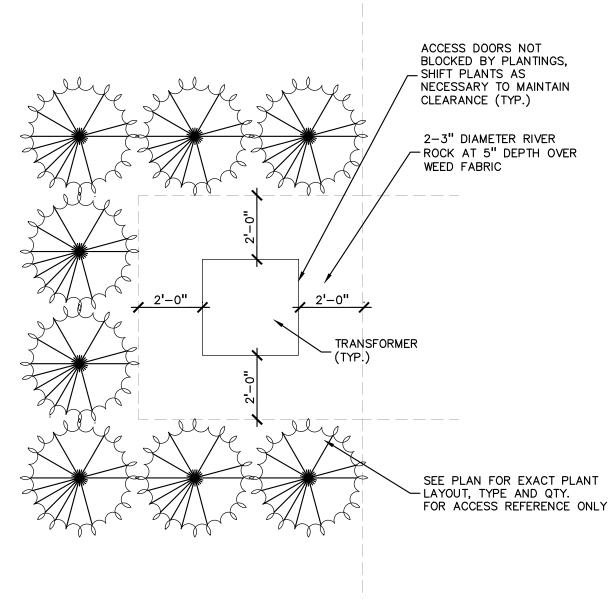

TRANSFORMER SCREENING DETAIL

SCALE: 1'' = 3'-0''

SCALE: 1/2'' = 1'-0''

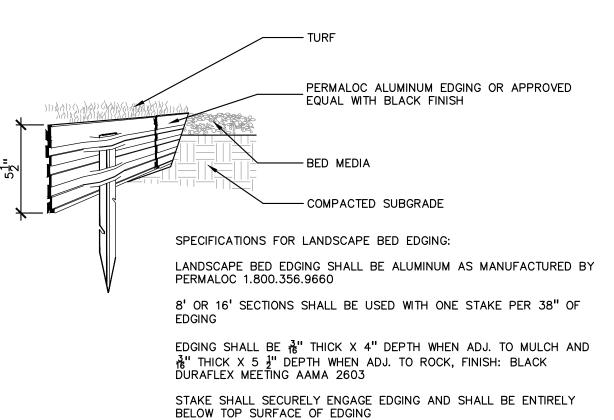

EDGING SHALL HAVE A MINIMUM OF 2" OF INTERLOCKING OVERLAP BETWEEN SECTIONS INSTALL AS PER MANUFACTURER'S SPECIFICATIONS WITH TOP OF

EDGING $\frac{1}{4}$ " ABOVE COMPACTED FINISH GRADE. FINISH GRADE TO BE COMPACTED ON BOTH SIDES OF EDGING TO MAINTAIN STABILITY LUMINUM EDGE DETAIL

PET STATION DETAIL, OR EQUAL SCALE: $1 \frac{1}{2}$ " = 1'-0"

PLANT SO THAT TOP OF ROOT BALL IS FLUSH TO GRADE OR 1-2" HIGHER IF IN POORLY DRAINED SOILS DO NOT COVER TOP OF ROOTBALL WITH SOIL FORM SAUCER WITH 4" HIGH CONTINUOUS RIM SHREDDED HARDWOOD BARK MULCH 3" DEEP AND LEAVE 3" CIRCLE OF BARE SOIL AROUND TRUNK. DO NOT PLACE MULCH IN CONTACT WITH TRUNK - FINISH GRADE SPECIFIED PLANTING MIX. WATER AND TAMP TO REMOVE AIR POCKETS REMOVE ALL BURLAP FROM TOP 1 OF -ROOTBALL, DISCARD ALL NON-BIODEGRADABLE MATERIAL OFF SITE VARIES ON CONTAINER OR BALL SIZE PLACE ROOTBALL ON UNEXCAVATED OR SHRUB PLANTING DETAIL SCALE: 1'' = 2'-0''STAKING/GUYING LOCATION CONTINUOUS RIM

MIN. TYP.

SCALE: 1'' = 3'-0''

EVERGREEN TREE PLANTING DETAIL



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PEA

GROUP

t: 844.813.2949

www.peagroup.com

LANDSCAPE ARCHITECT

DRIPLINE. 3" DEEP AND LEAVE 3" CIRCLE OF CLIENT BARE SOIL AROUND TREE TRUNK. DO NOT TROY SPORTS **CENTER, LLC**

— FINISH GRADE SPECIFIED PLANTING MIX, WATER & TAMP TO - REMOVE AIR POCKETS, AMEND SOIL PER SITE CONDITIONS & TREE REQUIREMENTS EXPOSE ROOT FLARE OF TREE. CONTRACTOR MAY HAVE TO REMOVE EXCESS SOIL FROM TOP OF ROOTBALL. REMOVE ALL BURLAP FROM TOP 3 OF ROOTBALL. DISCARD ALL NON-BIODEGRADABLE MATERIAL OFF SITE PROJECT TITLE

PLANT SO THAT THE TREE'S ROOT FLARE

(TRUNK FLARE) IS FLUSH WITH GRADE OR

STAKE JUST BELOW BRANCHES WITH 2"-3"

WIDE NYLON OR PLASTIC STRAPS. CONNECT

FLEXIBILITY. REMOVE AFTER (1) ONE YEAR.

THREE 2"X2" HARDWOOD STAKES OR STEEL T-POSTS DRIVEN A MIN. OF 18" DEEP

FROM TREE TO STAKE AND ALLOW FOR

(DO NOT USE WIRE & HOSE)

BACKFILLING

FIRMLY INTO SUBGRADE PRIOR TO

SHREDDED HARDWOOD BARK MULCH TO

PLACE MULCH IN CONTACT WITH TREE TRUNK. FORM SAUCER WITH 4" HIGH

1-2" HIGHER IN POORLY DRAIN SOIL.

PLACE ROOTBALL ON UNEXCAVATED OR

JOHN R COMMONS **TOWNHOME DEVELOPMENT** PART OF THE SE 1/4 OF SECTION 23, T. 2N., R. 11E.


TROY, OAKLAND COUNTY, MI

ORIGINAL ISSUE DATE:

AUGUST 18, 2023

DRAWING TITLE


REVISIONS

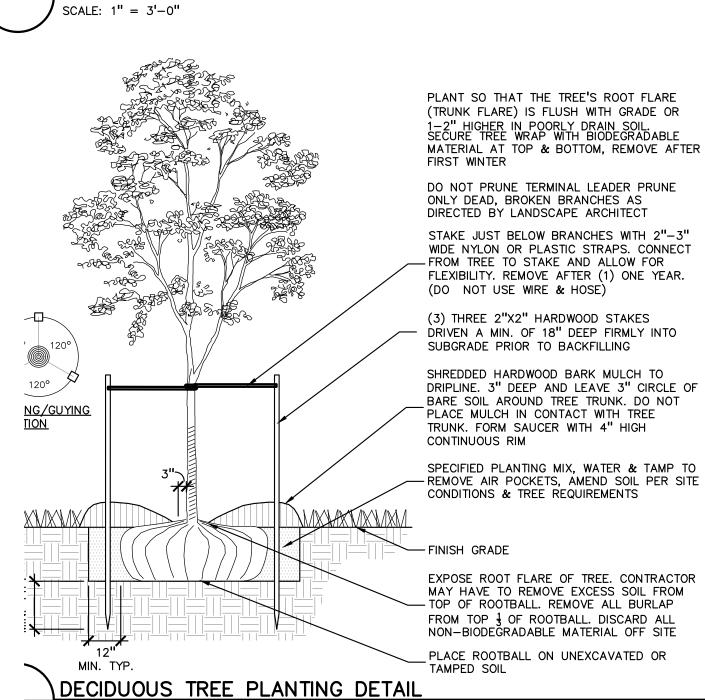


DETAILS PEA JOB NO. 18-0034 P.M. G.M.B. DN. BGG DES. JLE DRAWING NUMBER:

LANDSCAPE

NOT FOR CONSTRUCTION

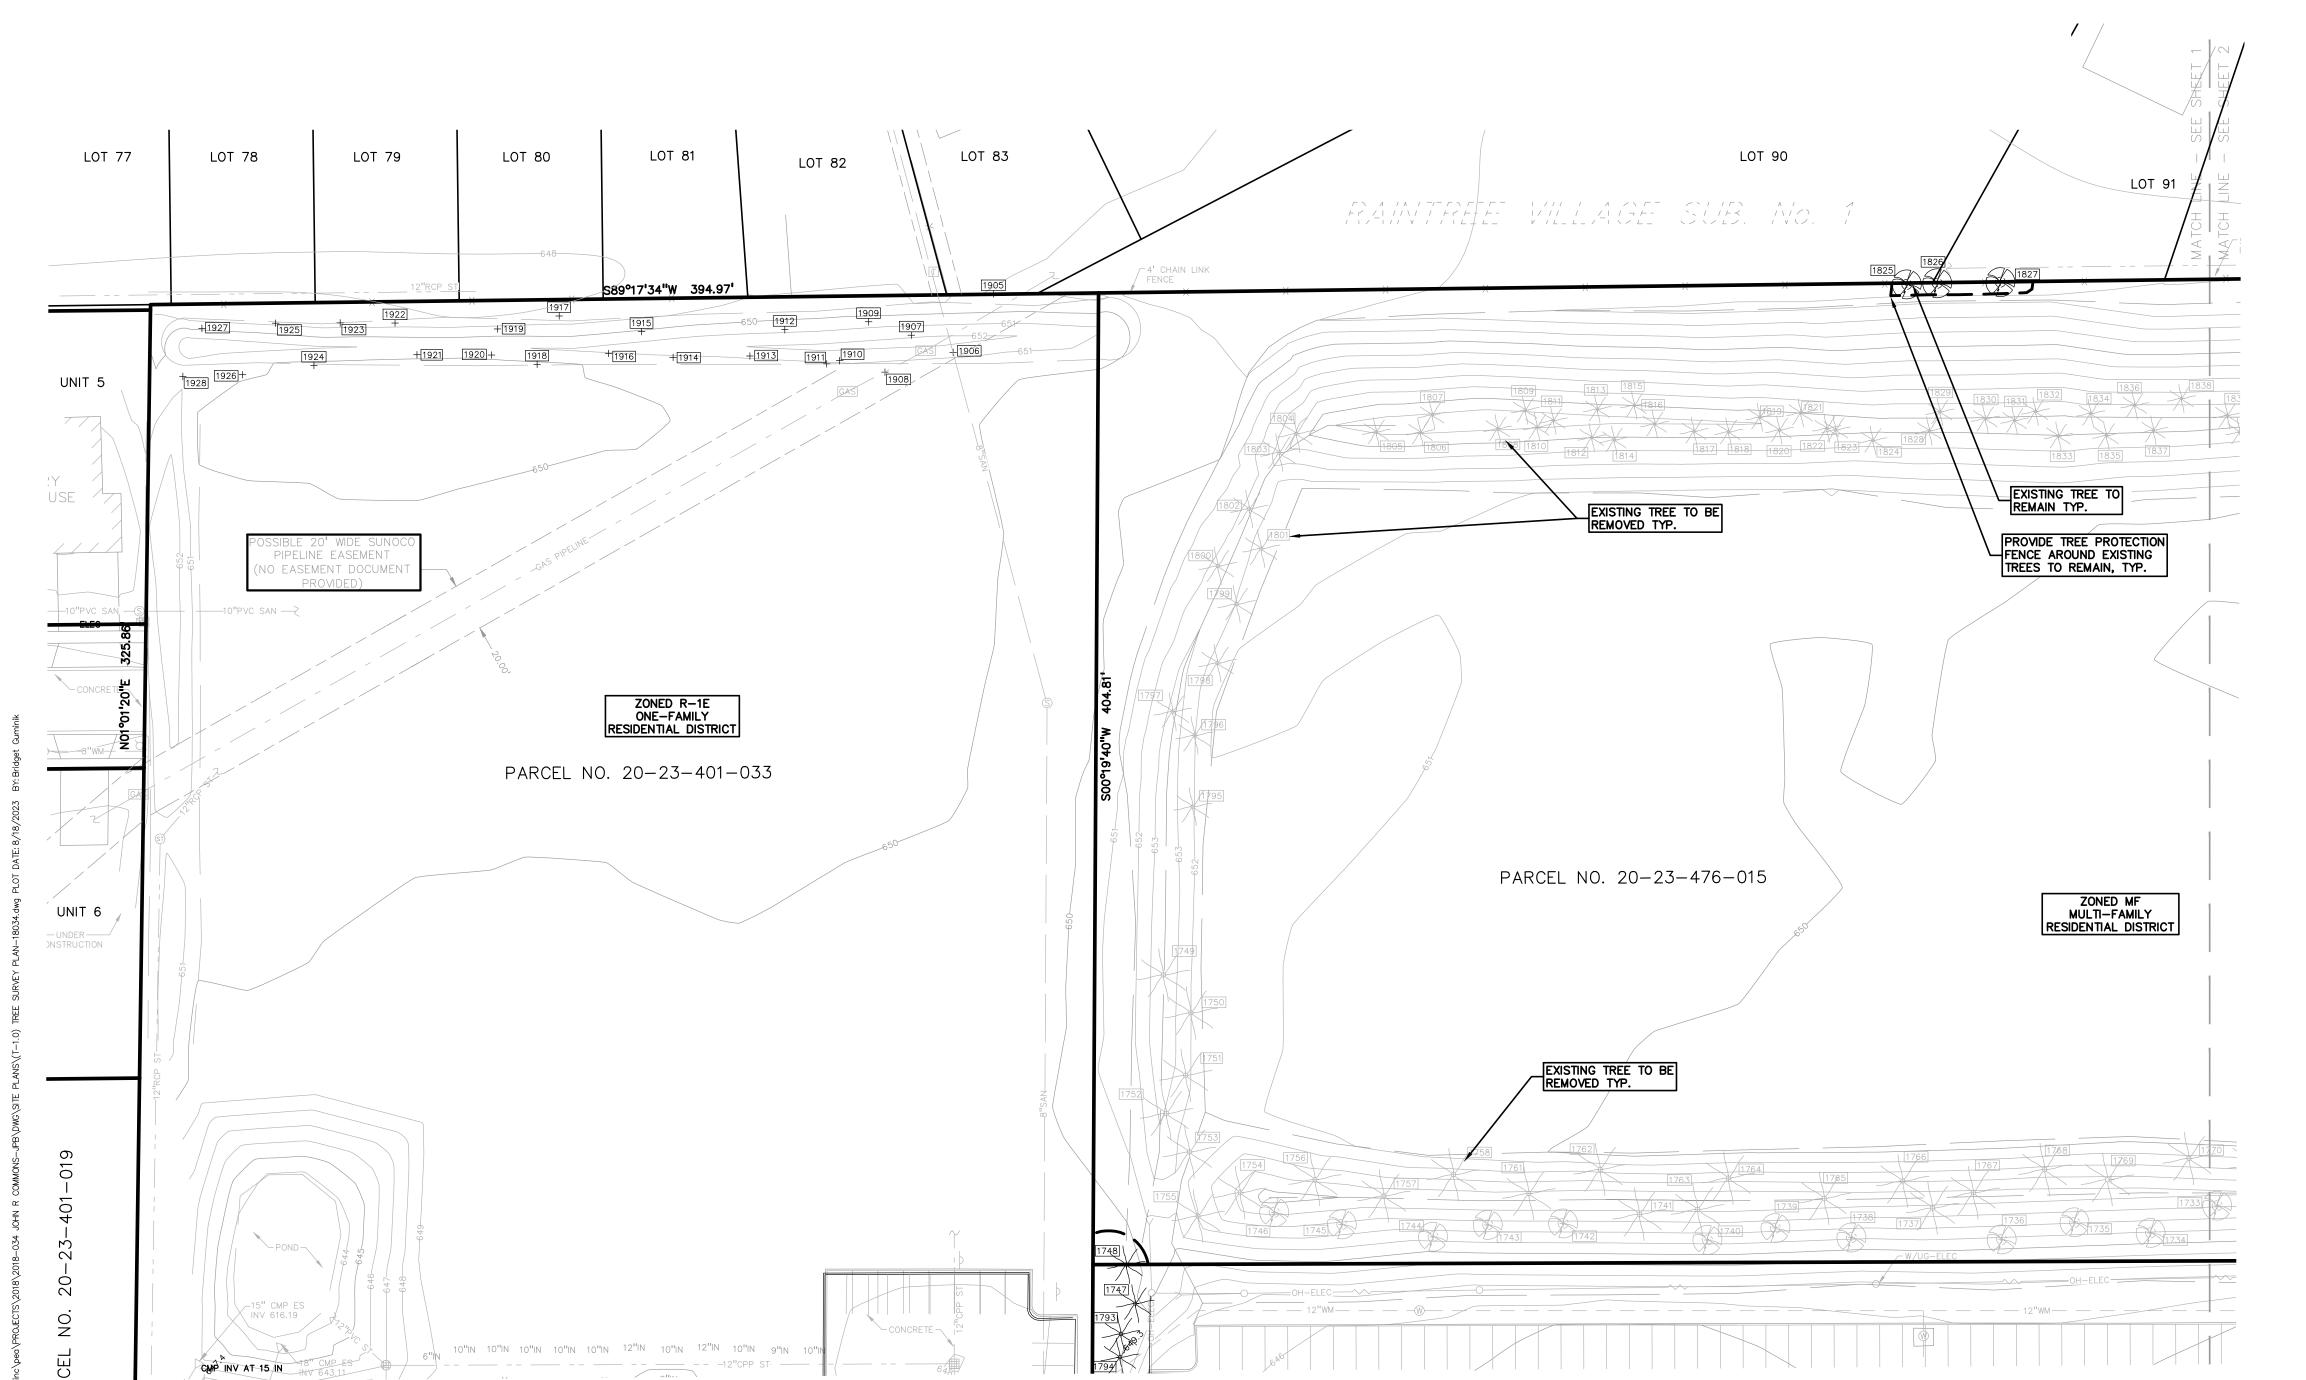

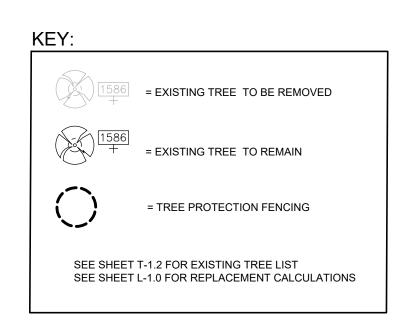

TREE PROTECTION WILL BE ERECTED PRIOR TO START OF CONSTRUCTION ACTIVITIES AND SHALL REMAIN IN PLACE UNTIL CONSTRUCTION IS COMPLETE.

NO PERSON MAY CONDUCT ANY ACTIVITY WITHIN THE DRIP LINE OF ANY TREE DESIGNATED TO REMAIN; INCLUDING, BUT NOT LIMITED TO PLACING SOLVENTS, BUILDING MATERIAL, CONSTRUCTION EQUIPMENT OR SOIL DEPOSITS WITHIN DRIP LINES.

GRADE CHANGES MAY NOT OCCUR WITHIN THE DRIP LINE OF PROTECTED TREES.

DURING CONSTRUCTION, NO PERSON SHALL ATTACH ANY DEVICE OR WIRE TO ANY REMAINING TREE.


ALL UTILITY SERVICE REQUESTS MUST INCLUDE NOTIFICATION TO THE INSTALLER THAT PROTECTED TREES MUST BE AVOIDED. ALL TRENCHING SHALL OCCUR OUTSIDE OF THE PROTECTIVE FENCING.


- 4' HIGH PROTECTIVE FENCING WITH STEEL POSTS - 10' O.C.








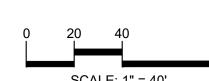

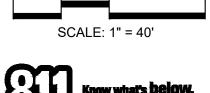

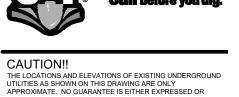

TREES LOCATED ON ADJACENT PROPERTY THAT MAY BE AFFECTED BY CONSTRUCTION ACTIVITIES MUST BE PROTECTED. THE LOCATIONS AND ELEVATIONS OF EXISTING UNDERGROUND UTILITIES AS SHOWN ON THIS DRAWING ARE ONLY APPROXIMATE. NO GUARANTEE IS EITHER EXPRESSED OR IMPLIED AS TO THE COMPLETENESS OR ACCURACY THEREOF. THE CONTRACTOR SHALL BE EXCLUSIVELY RESPONSIBLE FOR DETERMINING THE EXACT UTILITY LOCATIONS AND ELEVATIONS PRIOR TO THE START OF CONSTRUCTION. TREES TO BE PRESERVED SHALL BE IDENTIFIED WITH FLAGGING PRIOR TO THE TREE CLEARING OPERATIONS. PROVIDE FENCE AROUND CRITICAL ROOT ZONE OF TREE. FENCE SHALL BE PLACED IN A CIRCLE WITH A RADIUS OF 1' PER 1" DIAMETER OF THE TREE MEASURED AT 4.5' ABOVE GROUND.



CLIENT TROY SPORTS CENTER, LLC 1819 EAST BIG BEAVER ROAD TTOY, MI 48083

PROJECT TITLE


JOHN R
COMMONS
TOWNHOME
DEVELOPMENT
PART OF THE SE 1/4 OF SECTION 23, T.
2N., R. 11E.
TROY, OAKLAND COUNTY, MI


REVISIONS

ORIGINAL ISSUE DATE: AUGUST 18, 2023

TREE SURVEY PLAN - WEST

PEA JOB NO.	18-0034
P.M.	G.M.B.
DN.	BGG
DES.	JLE
DRAWING NUMBER:	

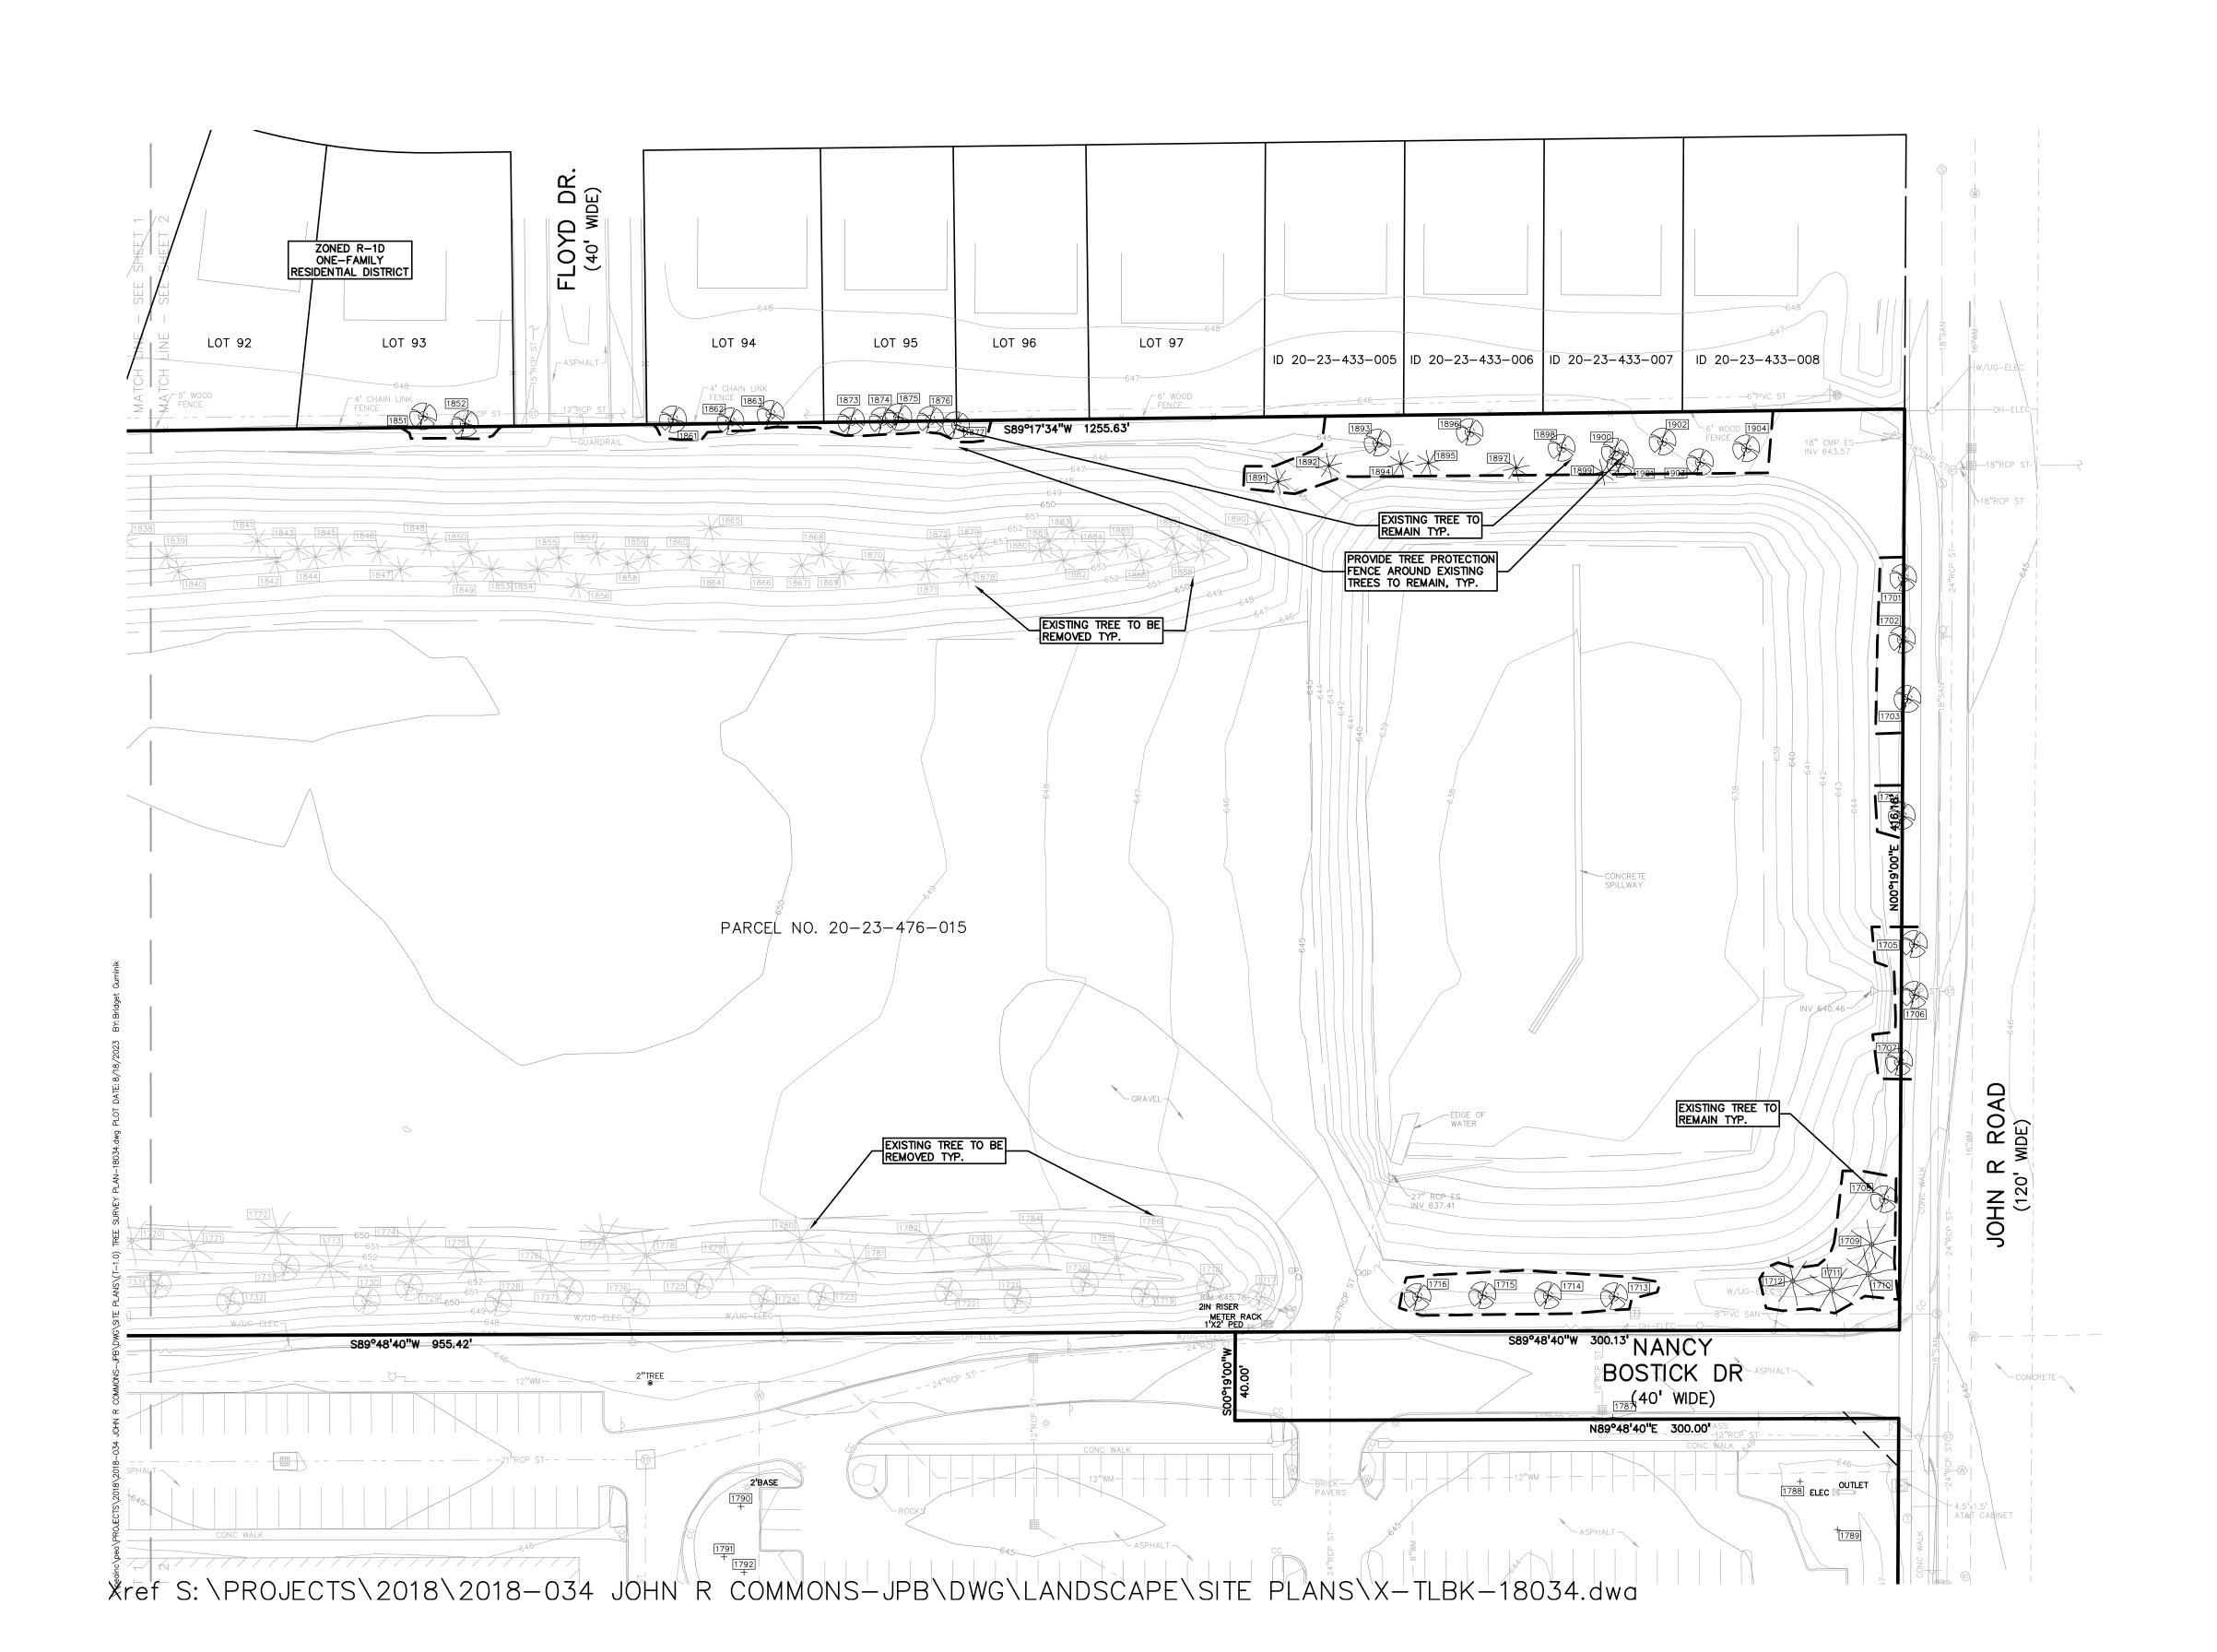


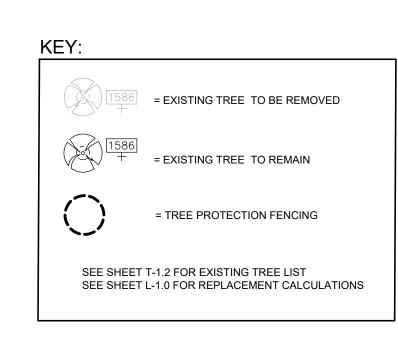







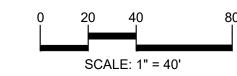





TROY SPORTS CENTER, LLC 1819 EAST BIG BEAVER ROAD TTOY, MI 48083

PROJECT TITLE

JOHN R
COMMONS
TOWNHOME
DEVELOPMENT
PART OF THE SE 1/4 OF SECTION 23, T.
2N., R. 11E.
TROY, OAKLAND COUNTY, MI

•	REVISIONS
	-
•	

TREE SURVEY PLAN - EAST

ORIGINAL ISSUE DATE: AUGUST 18, 2023

PEA JOB NO.	18-0034
P.M.	G.M.B.
DN.	BGG
DES.	JLE
DRAWING NUMBER:	

01	BP	DBH 15	Bradford Pear	LATIN NAME Pyrus calleryanna	COND Fair	COMMENT CLASS INVASIVE	SAVE / REMOVE	ON-SITE
:	BP BP	13	Bradford Pear	Pyrus calleryanna Pyrus calleryanna	Fair	INVASIVE INVASIVE	S S	Y
Ī	BP BP	15 15	Bradford Pear Bradford Pear	Pyrus calleryanna Pyrus calleryanna	Fair Fair	INVASIVE	S	N Y
	BP BP	14	Bradford Pear	Pyrus calleryanna	Fair	INVASIVE INVASIVE	S S	N
	BP BP	14 11	Bradford Pear Bradford Pear	Pyrus calleryanna Pyrus calleryanna	Poor Fair	INVASIVE	S	N Y
	WS	8	White Spruce	Picea glauca	Poor	INVASIVE WOODLAND	S S	Y
	BS BS	10 9	Blue Spruce Blue Spruce	Picea pungens Picea pungens	Fair Good	WOODLAND	S	Y
)	BS	12	Blue Spruce	Picea pungens	Good	WOODLAND WOODLAND	S S	Y
	WS G	12 6	White Spruce Ginkgo	Picea glauca Ginkgo biloba	Fair Good	WOODLAND	S	Y
	G	6	Ginkgo	Ginkgo biloba Ginkgo biloba	Good	WOODLAND WOODLAND	S S	Y
5	G	6	Ginkgo	Ginkgo biloba	Good	WOODLAND	S	Y
6 7	G SU	6 8	Ginkgo Sugar Maple	Ginkgo biloba Acer saccharum	Poor Poor	WOODLAND WOODLAND	S R	Y ¥
3	SU	10	Sugar Maple	Acer saccharum	Good	WOODLAND	R	¥
))	SU SU	10 6	Sugar Maple Sugar Maple	Acer saccharum Acer saccharum	Good Good	WOODLAND WOODLAND	R R	¥ ¥
1	SU	9	Sugar Maple	Acer saccharum	Good	WOODLAND	R	¥
2 3	SU SU	9	Sugar Maple Sugar Maple	Acer saccharum Acer saccharum	Good Good	WOODLAND WOODLAND	R R	¥ ¥
4 5	SU	8	Sugar Maple	Acer saccharum	Good	WOODLAND	R	¥
→	SU SU	9	Sugar Maple Sugar Maple	Acer saccharum Acer saccharum	Good Good	WOODLAND WOODLAND	R R	¥ ¥
Z 3	SU	9	Sugar Maple	Acer saccharum	Good	WOODLAND	R	¥
	SU SU	9 10	Sugar Maple Sugar Maple	Acer saccharum Acer saccharum	Good Good	WOODLAND WOODLAND	R R	X X
	SU	10	Sugar Maple	Acer saccharum	Good	WOODLAND	R	¥
+	SU SU	10 8	Sugar Maple Sugar Maple	Acer saccharum Acer saccharum	Good Good	WOODLAND WOODLAND	R R	¥
	SU	10	Sugar Maple	Acer saccharum	Good	WOODLAND	R	¥
\dashv	SU SU	10 10	Sugar Maple Sugar Maple	Acer saccharum Acer saccharum	Good Good	WOODLAND WOODLAND	R R	¥ ¥
\exists	SU	9	Sugar Maple	Acer saccharum	Good	WOODLAND	K R	¥
4	SU SU	10 9	Sugar Maple Sugar Maple	Acer saccharum Acer saccharum	Good Good	WOODLAND WOODLAND	R	¥ ¥
3	SU	8	Sugar Maple Sugar Maple	Acer saccharum Acer saccharum	Good	WOODLAND WOODLAND	R R	¥
	SU	9	Sugar Maple	Acer saccharum	Good	WOODLAND	R	¥
+	SU SU	9 10	Sugar Maple Sugar Maple	Acer saccharum Acer saccharum	Good Good	WOODLAND WOODLAND	R R	¥ ¥
	SU	10	Sugar Maple	Acer saccharum	Good	WOODLAND	R	¥
+	SU SU	8	Sugar Maple Sugar Maple	Acer saccharum Acer saccharum	Good Good	WOODLAND WOODLAND	R R	¥ ¥
#	SU	8	Sugar Maple	Acer saccharum	Good	WOODLAND	R	¥
+	BS WS	11	Blue Spruce White Spruce	Picea pungens Picea glauca	Good Good	WOODLAND WOODLAND	S S	Y
#	₩S	15	White Spruce	Picea glauca	Fair	WOODLAND	R	¥
	₩ S BS	9 16	White Spruce Blue Spruce	Picea glauca Picea pungens	Very Poor Fair	WOODLAND WOODLAND	R R	¥ ¥
‡	BS	18	Blue Spruce	Picea pungens	Fair	LANDMARK	R	¥
	BS BS	16 16	Blue Spruce Blue Spruce	Picea pungens Picea pungens	Poor Good	WOODLAND WOODLAND	R R	¥ ¥
1	₩S	10	White Spruce	Picea glauca	Fair	WOODLAND	R	¥
+	BS BS	11 12	Blue Spruce Blue Spruce	Picea pungens Picea pungens	Good Good	WOODLAND WOODLAND	R R	¥ ¥
#	₩S	14	White Spruce	Picea glauca	Poor	WOODLAND	R	¥
+	WS WS	13 14	White Spruce White Spruce	Picea glauca Picea glauca	Fair Good	WOODLAND WOODLAND	R R	¥ ¥
†	BS	12	Blue Spruce	Picea pungens	Fair	WOODLAND WOODLAND	R	¥
f	BS BS	15 15	Blue Spruce Blue Spruce	Picea pungens Picea pungens	Good Good	WOODLAND	R	¥ ¥
t	₩S	10	White Spruce	Picea glauca	Poor	WOODLAND WOODLAND	R R	¥
	BS BS	11 15	Blue Spruce Blue Spruce	Picea pungens Picea pungens	Very Poor Fair	WOODLAND	R	¥
f	BS	12	Blue Spruce	Picea pungens Picea pungens	Fair	WOODLAND WOODLAND	R R	¥
ŀ	BS BS	12 12	Blue Spruce Blue Spruce	Picea pungens Picea pungens	Fair Fair	WOODLAND	R	¥ ¥
ŀ	BS BS	12 13	Blue Spruce Blue Spruce	Picea pungens Picea pungens	Good	WOODLAND WOODLAND	R R	¥ ¥
-	BS	12	Blue Spruce	Picea pungens	Fair	WOODLAND	R	¥
+	BS BS	12 14	Blue Spruce Blue Spruce	Picea pungens Picea pungens	Fair Fair	WOODLAND WOODLAND	R R	¥ ¥
#	BS	12	Blue Spruce	Picea pungens	Good	WOODLAND	R	¥
+	BS BS	12 11	Blue Spruce Blue Spruce	Picea pungens Picea pungens	Fair Fair	WOODLAND WOODLAND	R R	¥
ļ	ЯS	9	Norway Spruce	Picea Abies	Poor	WOODLAND	R	¥
+	RS RA	10 11	Norway Spruce Norway Spruce	Picea Abies Picea Abies	Poor Poor	WOODLAND WOODLAND	R R	¥ ¥
1	NS	13	Norway Spruce	Picea Abies	Good	WOODLAND	R	¥
1	RA SA	8 10	Norway Spruce Norway Spruce	Picea Abies Picea Abies	Fair Fair	WOODLAND WOODLAND	R R	Y Y
1	S	8	Norway Spruce	Picea Abies	Poor	WOODLAND	R	¥
4	NS G	10 8	Norway Spruce Ginkgo	Picea Abies Ginkgo biloba	Fair Good	WOODLAND WOODLAND	R S	Y N
-	BS	7	Blue Spruce	Picea pungens	Fair	WOODLAND	S	Y
f	BS NS	7 11	Blue Spruce Norway Spruce	Picea pungens Picea Abies	Fair Fair	WOODLAND	S	Y
	BS	7	Blue Spruce	Picea Ables Picea pungens	Poor	WOODLAND WOODLAND	S S	Y
#	BS NS	8 14	Blue Spruce	Picea pungens Picea Abies	Poor	WOODLAND	S	Y
+	NS NS	14	Norway Spruce Norway Spruce	Picea Abies Picea Abies	Good Good	WOODLAND WOODLAND	S S	Y
#	BS BS	16	Blue Spruce	Picea pungens	Good	WOODLAND	R	¥
+	BS WS	13 12	Blue Spruce White Spruce	Picea pungens Picea glauca	Good Fair	WOODLAND WOODLAND	R R	Y Y
	BS	10	Blue Spruce	Picea pungens	Poor	WOODLAND	R	¥
+	₩ S BS	10 13	White Spruce Blue Spruce	Picea glauca Picea pungens	Fair Fair	WOODLAND WOODLAND	R R	¥
‡	BS	12	Blue Spruce	Picea pungens	Poor	WOODLAND	R	¥
_	BS BS	10 9	Blue Spruce Blue Spruce	Picea pungens Picea pungens	Poor Good	WOODLAND WOODLAND	R R	¥
1	BS	9	Blue Spruce	Picea pungens	Fair	WOODLAND	R	¥
f	WS WS	8	White Spruce White Spruce	Picea glauca Picea glauca	Fair Fair	WOODLAND WOODLAND	R	¥ ¥
+	₩S	8	White Spruce	Picea glauca Picea glauca	Fair	WOODLAND WOODLAND	R R	¥
#	BS	7	Blue Spruce	Picea pungens	Good	WOODLAND	R	¥
+	BS BS	7 8	Blue Spruce Blue Spruce	Picea pungens Picea pungens	Fair Fair	WOODLAND WOODLAND	R R	¥ ¥
#	BS	8	Blue Spruce	Picea pungens	Fair	WOODLAND	R	¥
+	BS BS	7 8	Blue Spruce Blue Spruce	Picea pungens Picea pungens	Fair Fair	WOODLAND WOODLAND	R R	Y Y
1	BS	6	Blue Spruce	Picea pungens	Poor	WOODLAND	R	¥
+	BS BS	8 7	Blue Spruce Blue Spruce	Picea pungens Picea pungens	Fair Fair	WOODLAND WOODLAND	R R	¥ ¥
ŀ	BS	8	Blue Spruce	Picea pungens Picea pungens	Fair	WOODLAND WOODLAND	R R	¥
-	BS BS	7	Blue Spruce	Picea pungens	Poor	WOODLAND	R	¥
	6-0	9	Blue Spruce Blue Spruce	Picea pungens Picea pungens	Fair Poor	WOODLAND WOODLAND	R R	¥ ¥

ΓAG NO.	CODE	DBH	COMMON NAME	LATIN NAME	COND	COMMENT	CLASS	SAVE / REMOVE		:
1821 1822	BS WS	9	Blue Spruce White Spruce	Picea pungens Picea glauca	Fair Fair		WOODLAND WOODLAND	R R	Ż Ż	REPLACI REPLACI
1823	BS	8	Blue Spruce	Picea pungens	Fair		WOODLAND	R	¥	REPLACI
1824 1825	BS SM	7 6	Blue Spruce Silver Maple	Picea pungens Acer saccharinum	Poor Good		WOODLAND INVASIVE	R S	Y Y	- -
1826	SC	16	Scotch Pine	Pinus sylvestris	Fair		WOODLAND	S	Y	 -
1827 1828	WP BS	16 7	(Eastern) White Pine Blue Spruce	Pinus strobus Picea pungens	Fair Fair		WOODLAND WOODLAND	S R	Y Y	- REPLACI
1829	BS	8	Blue Spruce	Picea pungens	Fair		WOODLAND	R	¥	REPLACI
1830 1831	₩\$ ₩\$	7 6	White Spruce White Spruce	Picea glauca Picea glauca	Fair Poor		WOODLAND WOODLAND	R R	¥ ¥	REPLACI
1832	₩S	6	White Spruce	Picea glauca	Poor		WOODLAND	R	¥	 -
1833 1834	WS WS	6	White Spruce White Spruce	Picea glauca Picea glauca	Poor		WOODLAND WOODLAND	R R	¥ ¥	- -
1835	₩S	6	White Spruce	Picea glauca	Fair		WOODLAND	R	¥	REPLACI
1836 1837	BS WS	6	Blue Spruce White Spruce	Picea pungens Picea glauca	Good Poor		WOODLAND WOODLAND	R R	¥ ¥	REPLACI
1838	₩S	7	White Spruce	Picea glauca	Fair		WOODLAND	R	¥	REPLACI
1839 1840	₩\$ ₩\$	8	White Spruce White Spruce	Picea glauca Picea glauca	Fair Fair		WOODLAND WOODLAND	R R	¥ ¥	REPLACI REPLACI
1841	BS	8	Blue Spruce	Picea pungens	Good		WOODLAND	R	¥	REPLACI
1842 1843	₩ S BS	9	White Spruce Blue Spruce	Picea glauca Picea pungens	Fair Fair		WOODLAND WOODLAND	R R	¥ ¥	REPLACI REPLACI
1844	₩S	6	White Spruce	Picea glauca	Poor		WOODLAND	R	¥	-
1845 1846	BS BS	8	Blue Spruce Blue Spruce	Picea pungens Picea pungens	Fair Good		WOODLAND WOODLAND	R R	¥ ¥	REPLACI REPLACI
1847	₩S	6	White Spruce	Picea glauca	Poor		WOODLAND	R	¥	-
1848 1849	BS BS	8 7	Blue Spruce Blue Spruce	Picea pungens Picea pungens	Fair Fair		WOODLAND WOODLAND	R R	¥ ¥	REPLACI REPLACI
1850	BS	8	Blue Spruce	Picea pungens	Fair		WOODLAND	R	¥	REPLACI
1851 1852	NS NS	12 13	Norway Spruce Norway Spruce	Picea Abies Picea Abies	Fair Fair		WOODLAND WOODLAND	S S	N N	- -
1853	BS	8	Blue Spruce	Picea pungens	Fair		WOODLAND	R	¥	REPLACI
1854 1855	WS BS	8	White Spruce Blue Spruce	Picea glauca Picea pungens	Fair Fair		WOODLAND WOODLAND	R R	¥ ¥	REPLACI REPLACI
1856	₩\$	9	White Spruce	Picea glauca	Fair		WOODLAND	R	¥	REPLACI
1857 1858	BS WS	8	Blue Spruce White Spruce	Picea pungens Picea glauca	Fair Poor		WOODLAND WOODLAND	R R	¥ ¥	REPLACI
1859	BS	8	Blue Spruce	Picea pungens	Fair		WOODLAND	R	¥	REPLACI
1860 1861	BS NM	9 10	Blue Spruce Norway Maple	Picea pungens Acer platanoides	Fair Good		WOODLAND INVASIVE	R S	Y N	REPLACI
1862	BP	13	Bradford Pear	Pyrus calleryanna	Good		INVASIVE	S	N	 -
1863 1864	SM BS	12 7	Silver Maple Blue Spruce	Acer saccharinum Picea pungens	Fair Poor		INVASIVE WOODLAND	S R	N ¥	- -
1865	BS	9	Blue Spruce	Picea pungens	Fair		WOODLAND	R	¥	REPLACI
1866 1867	₩\$ ₩\$	9	White Spruce White Spruce	Picea glauca Picea glauca	Poor Poor		WOODLAND WOODLAND	R R	¥ ¥	- -
1868	BS	7	Blue Spruce	Picea pungens	Fair		WOODLAND	R	¥	REPLACI
1869 1870	WS WS	5 5	White Spruce White Spruce	Picea glauca Picea glauca	Poor		WOODLAND WOODLAND	R R	¥ ¥	- -
1871	₩S	6	White Spruce	Picea glauca	Poor		WOODLAND	R	¥	-
1872 1873	BS NM	8	Blue Spruce Norway Maple	Picea pungens Acer platanoides	Fair Good		WOODLAND INVASIVE	R S	Y N	REPLACI
1874	NM	6	Norway Maple	Acer platanoides	Good		INVASIVE	S	N]-
1875 1876	NM NS	6 8	Norway Maple Norway Spruce	Acer platanoides Picea Abies	Good Good		INVASIVE WOODLAND	S	N N	- -
1877	NS	8	Norway Spruce	Picea Abies	Good		WOODLAND	S	Y	-
1878 1879	BS BS	7 8	Blue Spruce Blue Spruce	Picea pungens Picea pungens	Fair Good		WOODLAND WOODLAND		¥ ¥	REPLACI REPLACI
1880 1881	BS BS	8	Blue Spruce Blue Spruce	Picea pungens	Good Fair		WOODLAND		¥	REPLACI
1882	BS	7	Blue Spruce	Picea pungens Picea pungens	Poor		WOODLAND WOODLAND		¥ ¥	REPLACI
1883 1884	BS BS	9 7	Blue Spruce Blue Spruce	Picea pungens Picea pungens	Fair Fair		WOODLAND	†	¥ ¥	REPLACI REPLACI
1885	BS	8	Blue Spruce	Picea pungens	Fair		WOODLAND WOODLAND		¥	REPLAC
1886 1887	BS BS	8 7	Blue Spruce Blue Spruce	Picea pungens Picea pungens	Fair Fair		WOODLAND WOODLAND		¥ ¥	REPLACI REPLACI
1888	WS	8	White Spruce	Picea glauca	Fair		WOODLAND		¥	REPLAC
1889 1890	WS BS	8 7	White Spruce Blue Spruce	Picea glauca Picea pungens	Fair Poor		WOODLAND WOODLAND	t e	¥	REPLACI
1891	BS	7	Blue Spruce	Picea pungens	Fair		WOODLAND		Y	-
1892 1893	BS BS	6 11	Blue Spruce Blue Spruce	Picea pungens Picea pungens	Poor Fair		WOODLAND WOODLAND	S S	Y	- -
1894	BS	4	Blue Spruce	Picea pungens	Fair		WOODLAND		Y	-
1895 1896	WS NS	8 12	White Spruce Norway Spruce	Picea glauca Picea Abies	Poor Fair		WOODLAND WOODLAND		Y	- -
1897	BS	12	Blue Spruce	Picea pungens	Fair		WOODLAND		Y	<u> </u> -
1898 1899	BS WW	11 12	Blue Spruce Weeping Willow	Picea pungens Salix babylonica	Poor Poor		WOODLAND INVASIVE	S S	Y	- -
1900	WW	13	Weeping Willow	Salix babylonica	Fair		INVASIVE	S	Y	-
1901 1902	NS NS	7	Norway Spruce Norway Spruce	Picea Abies Picea Abies	Very Poor Very Poor		WOODLAND WOODLAND	S S	Y	- -
1903	BS	10	Blue Spruce	Picea pungens	Very Poor		WOODLAND		Y	 -
1904 1905	NS AU	14 27	Norway Spruce Austrian Pine	Picea Abies Pinus nigra	Fair Good		WOODLAND LANDMARK	S S	Y	- -
1906	AU	23	Austrian Pine	Pinus nigra	Good		LANDMARK	S	Y	 -
1907 1908	RP RP	19 14	Red Pine Red Pine	Pinus resinosa Pinus resinosa	Fair Fair		LANDMARK WOODLAND	S S	Y	- -
1909	СТ	58	Cottonwood	Populus deltoides	Good		INVASIVE	S	Y	ļ-
1910 1911	RP RP	14 20	Red Pine Red Pine	Pinus resinosa Pinus resinosa	Fair Good		WOODLAND LANDMARK	S	Y	- -
1912	RP	22	Red Pine	Pinus resinosa	Good		LANDMARK	S	Y	ŀ
1913 1914	RP RP	23 18	Red Pine Red Pine	Pinus resinosa Pinus resinosa	Good Fair		LANDMARK LANDMARK	S S	Y	<u> </u>
1915	RP	21	Red Pine	Pinus resinosa	Fair		LANDMARK	S	Y	<u> </u> -
1916 1917	RP RP	19 17	Red Pine Red Pine	Pinus resinosa Pinus resinosa	Poor Fair		LANDMARK WOODLAND	S S	Y	[
1918	RP	17	Red Pine	Pinus resinosa	Poor		WOODLAND	S	Y	<u> </u> -
1919 1920	RP CT	19 40	Red Pine Cottonwood	Pinus resinosa Populus deltoides	Poor Good		LANDMARK INVASIVE	S S	Y	<u> </u>
1921	RP	21	Red Pine	Pinus resinosa	Fair		LANDMARK	S	Y	 -
1922 1923	RP RP	20 17	Red Pine Red Pine	Pinus resinosa Pinus resinosa	Fair Fair		LANDMARK WOODLAND	S S	Y	<u> </u>
	RP	18	Red Pine	Pinus resinosa	Fair		LANDMARK	S	Y	 -
1924			Red Pine	Pinus resinosa	Fair	i	LANDMARK	S	Υ	I.
1924 1925 1926	RP RP	21 19	Red Pine	Pinus resinosa	Fair		LANDMARK	S	Y	<u> </u>

KEY: NIC FOR REPLACEMENT = DEA	AD, DAMAGED	, DISEASE	D, INVASIVE SPECIE	S			
STRIKETHROUGH, R = TREES TO REMO TYP. TEXT = TREES TO SAVE. S	VE						
	ENT IF APPL	CABLE					
WOODLAND TREES							
WOODLAND TREES REMOVED:	115	(REPLA	CE AT 50% OF RI	EMOVED DBH)			
1080" DBH x 0.5 =		540''	REPLACEMENT				
WOODLAND TREES SAVED:	32	(CREDIT	ΓOF 2X DBH)				
326 DBH x 2 =		652''	CREDIT				
540 -	652	=	-112				
0 " DBH REQUIRED FOR REPLACEMENT							
LANDMARK TREES							
LANDMARK TREES REMOVED:	1	(REPLA	CE AT 100% OF F	REMOVED DBH)			
18" DBH x 1 =		18''	REPLACEMENT	•			
LANDMARK TREES SAVED:	13	(CREDI	ΓOF 2X DBH)				
272'' DBH x 2 =		544"	CREDIT				
	STRIKETHROUGH, R = TREES TO REMOTH TYP. TEXT = TREES TO SAVE, S SEE SHEET L-1.0 FOR TREE REPLACEM WOODLAND TREES WOODLAND TREES REMOVED: 1080" DBH x 0.5 = WOODLAND TREES SAVED: 326 DBH x 2 = 540 - 0 " DBH REQUIRED FOR LANDMARK TREES LANDMARK TREES REMOVED: 18" DBH x 1 = LANDMARK TREES SAVED:	STRIKETHROUGH, R = TREES TO REMOVE TYP. TEXT = TREES TO SAVE, S SEE SHEET L-1.0 FOR TREE REPLACEMENT IF APPLI WOODLAND TREES WOODLAND TREES REMOVED: 115 1080" DBH x 0.5 = WOODLAND TREES SAVED: 32 326 DBH x 2 = 540 - 652 0 "DBH REQUIRED FOR REPLACEMENT IF APPLI LANDMARK TREES LANDMARK TREES LANDMARK TREES REMOVED: 1 18" DBH x 1 = LANDMARK TREES SAVED: 13	STRIKETHROUGH, R = TREES TO REMOVE TYP. TEXT = TREES TO SAVE, S SEE SHEET L-1.0 FOR TREE REPLACEMENT IF APPLICABLE WOODLAND TREES WOODLAND TREES REMOVED: 115 (REPLACEMENT) 1080" DBH x 0.5 = 540" WOODLAND TREES SAVED: 32 (CREDIT 1080) 326 DBH x 2 = 652" 540 - 652 = 0 "DBH REQUIRED FOR REPLACEMENT LANDMARK TREES LANDMARK TREES LANDMARK TREES REMOVED: 1 (REPLACEMENT) 18" DBH x 1 = 18" LANDMARK TREES SAVED: 13 (CREDIT 108)	TYP. TEXT = TREES TO SAVE, S SEE SHEET L-1.0 FOR TREE REPLACEMENT IF APPLICABLE WOODLAND TREES WOODLAND TREES REMOVED: 115 (REPLACE AT 50% OF RI 1080" DBH x 0.5 = 540" REPLACEMENT WOODLAND TREES SAVED: 32 (CREDIT OF 2X DBH) 326 DBH x 2 = 652" CREDIT 540 - 652 = -112 0 " DBH REQUIRED FOR REPLACEMENT LANDMARK TREES LANDMARK TREES REMOVED: 1 (REPLACE AT 100% OF FI 18" DBH x 1 = 18" REPLACEMENT LANDMARK TREES SAVED: 13 (CREDIT OF 2X DBH)			

	•		·			
272" DBH x 2 =	544''	CREDIT				
18 -	544 =	-526				
0 " DBH REQUIRED FOR REPLACEMENT						
EXEMPT TREES						
(NO REPLACEMENT REQUIRED	FOR EXEMPT TREE	<u> </u>				
SAVED EXEMPT TREES:	8 Trees					
EXEMPT TREES ON SITE:	8 Trees	;				

TOTAL SAVED TREES 6" AND ABOVE ON SITE:







CAUTION!!
THE LOCATIONS AND ELEVATIONS OF EXISTING UNDERGROUND UTILITIES AS SHOWN ON THIS DRAWING ARE ONLY APPROXIMATE. NO GUARANTEE IS EITHER EXPRESSED OR IMPLIED AS TO THE COMPLETENESS OR ACCURACY THEREOF. THE CONTRACTOR SHALL BE EXCLUSIVELY RESPONSIBLE FOR DETERMINING THE EXACT UTILITY LOCATIONS AND ELEVATIONS PRIOR TO THE START OF CONSTRUCTION.

TROY SPORTS
CENTER, LLC
1819 EAST BIG BEAVER ROAD
TTOY, MI 48083

PROJECT TITLE


JOHN R
COMMONS
TOWNHOME
DEVELOPMENT
PART OF THE SE 1/4 OF SECTION 23, T.
2N., R. 11E.
TROY, OAKLAND COUNTY, MI

REVISIONS
-


ORIGINAL ISSUE DATE: AUGUST 18, 2023 DRAWING TITLE

EXISTING TREE LIST


PEA JOB NO.	18-0034
P.M.	G.M.B
DN.	BGG
DES.	JLE
DRAWING NUMBER:	

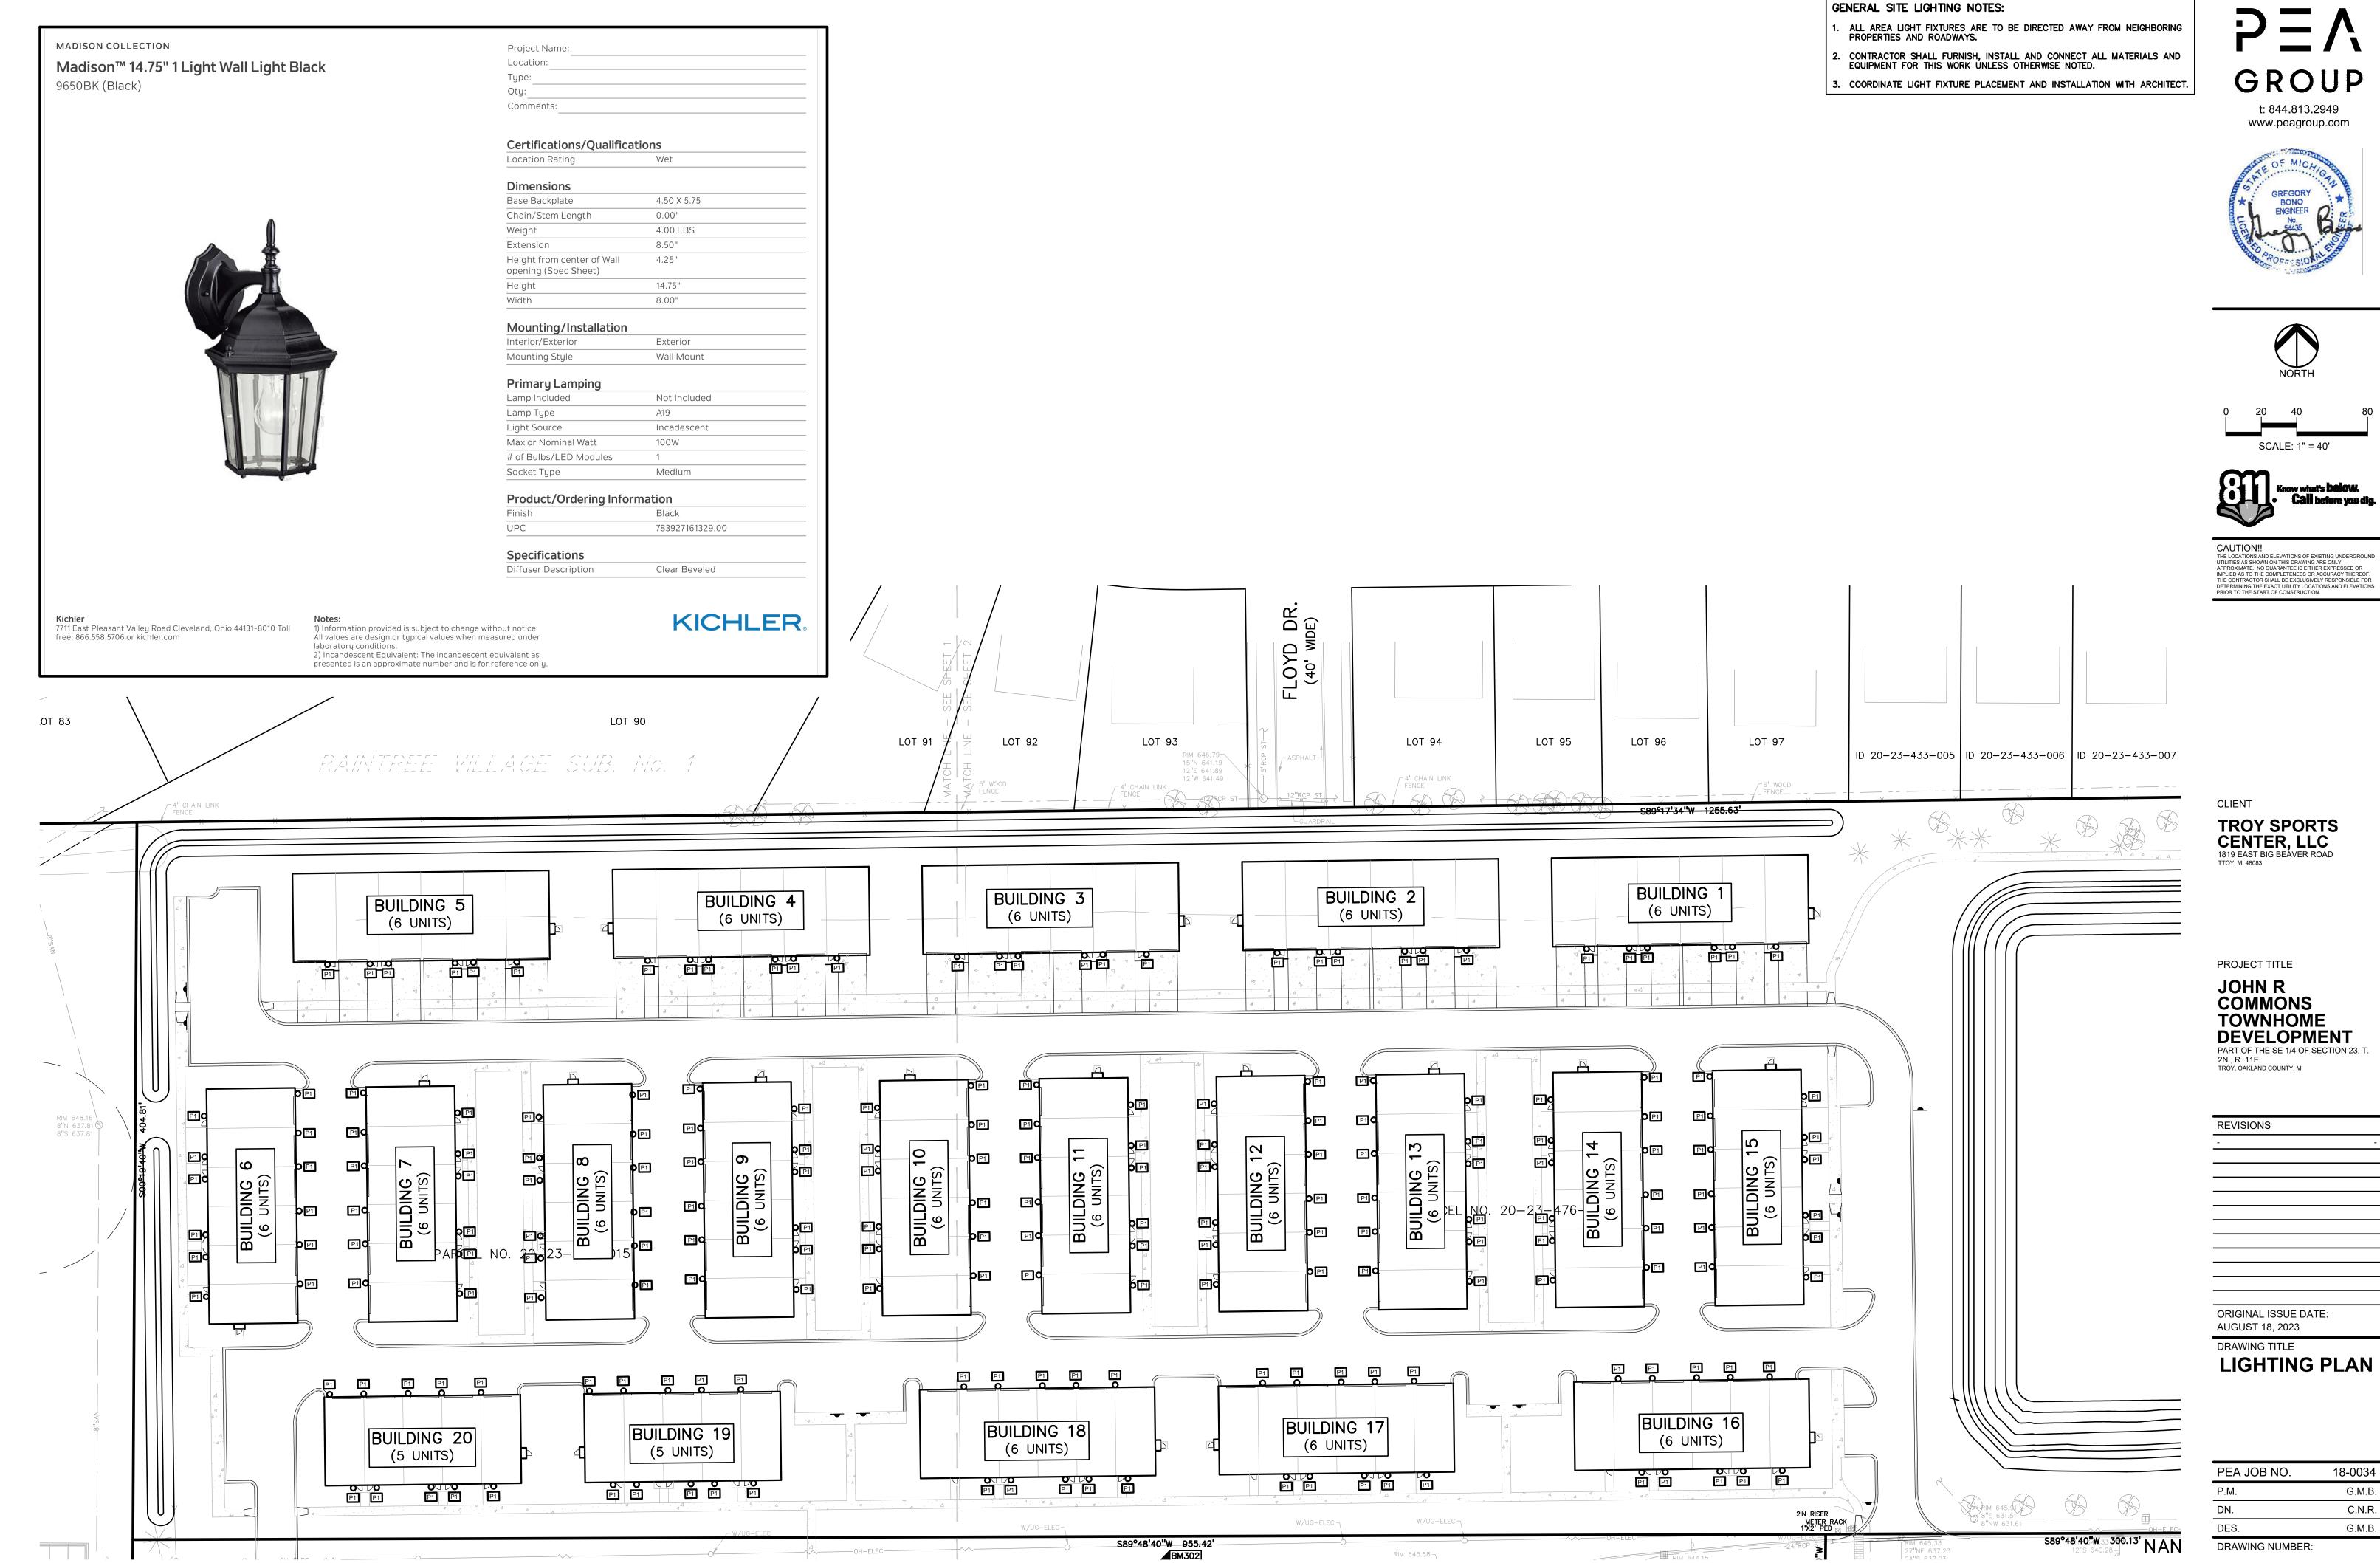

NOT FOR CONSTRUCTION SL-1.0

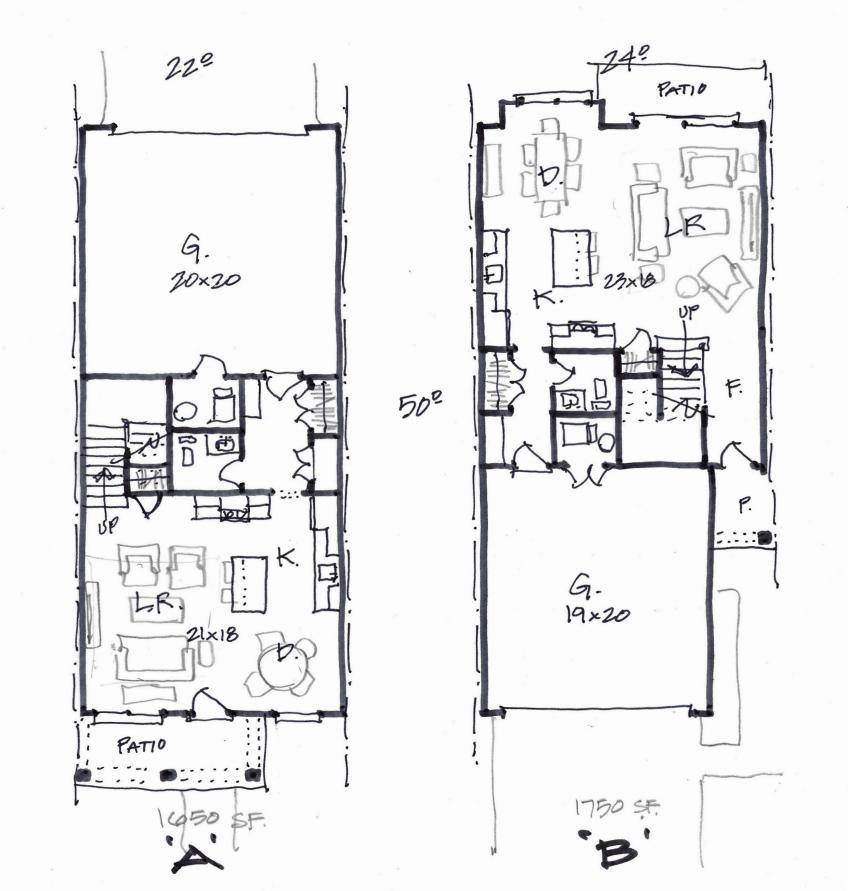



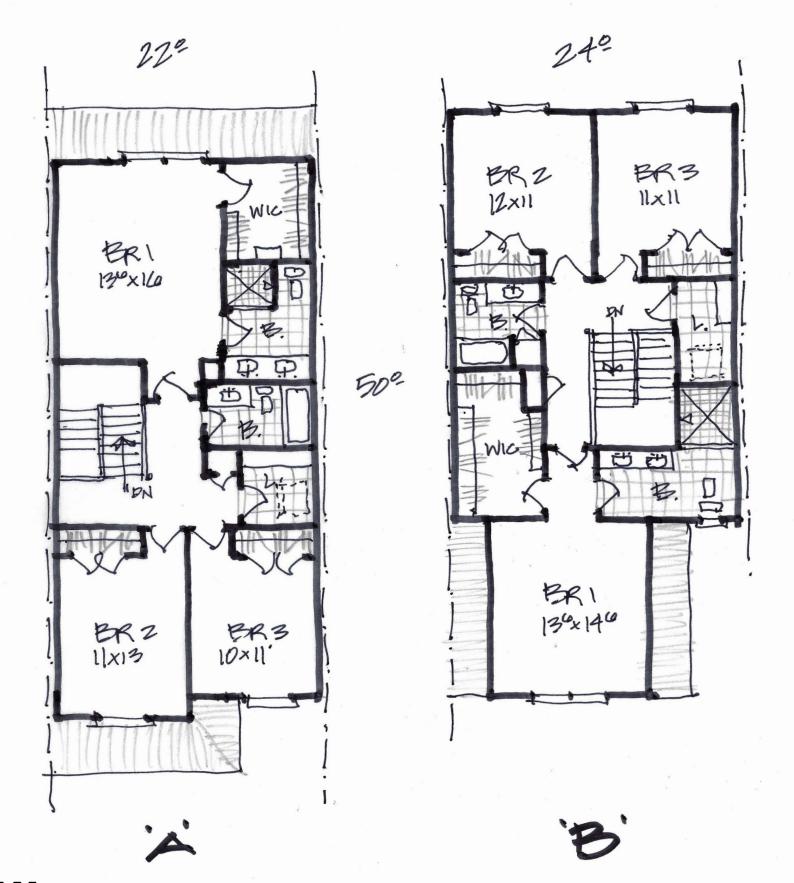



John R Townhome Concepts

BRIAN NEEPER ARCHITECTURE P.C. BRIANNEEPER.COM 2 4 8. 2 5 9. 1 7 8 4



ELEVATION CONCEPTS — BUILDING TYPE A

Troy, Michigan

BRIAN NEEPER ARCHITECTURE P.C.

