

PLANNING COMMISSION MEETING AGENDA REGULAR MEETING

Marianna Perakis, Chair, Lakshmi Malalahalli, Vice Chair Toby Buechner, Carlton Faison, Tyler Fox, Michael W. Hutson, Tom Krent, Dave Lambert and John J. Tagle

February 13, 2024 7:00 P.M.

Council Chambers

- 1. ROLL CALL
- 2. APPROVAL OF AGENDA
- 3. APPROVAL OF MINUTES January 23, 2024
- 4. PUBLIC COMMENT For Items Not on the Agenda

PRELIMINARY SITE PLAN

 PRELIMINARY SITE PLAN APPROVAL (JPLN2023-0033) –. Proposed Premier Academy Troy daycare center and preschool, Northwest corner of Crooks and Wattles (PIN 88-20-17-476-056, 0-57 & -061), Section 17, Zoned NN (Neighborhood Node "I") Zoning District.

OTHER ITEMS

- 6. PUBLIC COMMENT- For Items on the Agenda
- 7. PLANNING COMMISSION COMMENT
- 8. ADJOURN

Chair Perakis called the Regular meeting of the Troy City Planning Commission to order at 7:00 p.m. on January 23, 2024, in the Council Chamber of the Troy City Hall. Chair Perakis and Vice Chair Malalahalli presented opening remarks relative to the role of the Planning Commission and procedure of tonight's meeting.

1. ROLL CALL

Present:

Toby Buechner
Carlton M. Faison
Tyler Fox
Michael W. Hutson
Tom Krent
David Lambert
Lakshmi Malalahalli
Marianna Perakis
John J. Tagle

Also Present:

Ben Carlisle, Carlisle Wortman & Associates R. Brent Savidant, Community Development Director Julie Quinlan Dufrane, Assistant City Attorney Kathy L. Czarnecki, Recording Secretary

2. <u>APPROVAL OF AGENDA</u>

Resolution # PC-2024-01-004

Moved by: Faison Support by: Buechner

RESOLVED, To approve the Agenda as prepared.

Yes: All present (9)

MOTION CARRIED

3. <u>APPROVAL OF MINUTES</u> – January 9, 2024

Resolution # PC-2024-01-005

Moved by: Lambert Support by: Faison

RESOLVED, To approve the minutes of January 9, 2024 Regular meeting as submitted.

Yes: All present (9)

MOTION CARRIED

4. <u>PUBLIC COMMENT</u> – For Items Not on the Agenda

There was no one present who wished to speak.

PRELIMINARY SITE PLAN

 PRELIMINARY SITE PLAN APPROVAL (JPLN2023-0028) – Proposed John R Commons Townhome Development, West side of John R, North of Big Beaver (PIN 88-20-23-476-017), Section 23, Zoned MF (Multi-Family Residential) Zoning District

Mr. Savidant announced three dimensional (3-D) color renderings requested of the applicant are displayed in the visual presentation this evening.

Mr. Carlisle gave a brief history of a previous 2019 application of the John R Commons Townhome Development in which the applicant requested a rezoning of the parcels and was denied by the City Council. Mr. Carlisle stated the application before the Board this evening is a by-right development and not for a rezoning change. He identified the significant changes to the application as relates to a reduction in the number of units, alignment of five apartment buildings along the south property line, reconfiguration of the detention pond, a reduction of size/massing of the buildings abutting the northern property line, elimination of recreational area and clubhouse, reduction of building height to 25 feet and adding outdoor amenity spaces.

Mr. Carlisle addressed site arrangement, setbacks, building height, buffers along both the north and south property lines, access and circulation, mitigation of trees, trash removal, elevations, landscaping, and parking. He asked the applicant to consider some type of physical screening and/or additional landscaping to improve the buffer adjacent to the commercial uses. Mr. Carlisle asked the applicant to provide color renderings and to address building materials, specifically the type of siding.

Mr. Carlisle announced that the City Traffic Consultant Stephen Dearing of OHM Advisors is present this evening to address any traffic concerns.

In summary, Mr. Carlisle asked the Planning Commission to consider in its deliberations if the application meets Site Plan Review Design Standards (Section 8.06) and that the applicant consider additional screening options including a screen wall with additional landscaping as part of the Final Site Plan submittal.

Some of the comments during discussion among the administration related to:

- Ingress and egress.
- Width of typical residential streets and private roads.
- Public stub street off John R.
- Bicycle parking.
- Green space.
- Recreational amenities.

Property owner/applicant Dennis Bostick, Civil Engineer Greg Bono of PEA and Project Architect Brian Neeper were present.

Mr. Bostick addressed the proposed rezoning that the City Council denied in 2019. He said the 2019 townhome project offered more amenities than the proposed development for Planning Commission consideration this evening. He identified properties he owns, including five acres behind the San Marino Club zoned for single family residential.

There was discussion, some comments related to:

- Ingress and egress.
 - Nancy Bostick Drive
 - Commercial center to the south.
- Buffer/screening on both the north side adjacent to residential and the south side adjacent to the commercial uses.
 - o Solid screening (brick wall) to buffer residential to north.
 - Additional landscaping.
 - Difference of north and south density of buffering.
 - Applicant prefers landscaping.
- Potential for light spillage and noise pollution from commercial uses.
- Pedestrian circulation within development; pattern of sidewalks.
- Pedestrian access to commercial uses.
- Commercial entrances; both front and rear.
- Retention pond, as relates to aesthetics.
- Green space, amenities offered; i.e., outdoor seating, dog park, internal sidewalk loops, optional recreational uses.
- Concerns with traffic circulation, traffic pattern.
 - o Internal circulation.
 - Access points.
 - o Safety of children and pedestrians (nearby soccer fields and commercial parking).
 - Traffic calming devices.
 - Emergency vehicular access (EVA).
- Bicycle parking, location of bicycle spaces.
- Marketing of townhomes; option to rent or own.
- Building materials and color scheme.
- Site arrangement; soften with green space, vertical landscaping.
- Tree survey; removal of landmark tree.
- Architectural features as relates to Site Plan Design Standards.

Mr. Bostick indicated he is amenable to the Planning Commission comments.

City Traffic Consultant Stephen Dearing addressed the ingress and egress accesses off Nancy Bostick Drive and the commercial center to the south. He said the traffic impact study completed for the previously proposed development in 2019 determined that access off Nancy Bostick Drive should be signalized. Mr. Dearing said the reduced density of the proposed development before the Board this evening would generate less traffic. He indicated a rudimentary analysis of generated traffic during peak hours would go either way; to signalize Nancy Bostwick Drive or install an EVA. He addressed traffic calming techniques that might ease concerns for safety.

Chair Perakis opened the floor for public comment. Acknowledging there was no one present who wished to speak, Chair Perakis closed the floor for public comment.

Resolution # PC-2024-01-006

Moved by: Lambert Seconded by: Fox

RESOLVED, That Preliminary Site Plan Approval, pursuant to Article 8 of the Zoning Ordinance, as requested for the proposed John R Commons Townhome Development, located on the West side of John R, North of Big Beaver, Section 23, Zoned MF (Multi-Family Residential) District, be postponed for the following reasons to address the Planning Commission comments:

- 1. Landscape buffer on the south side of the development.
- 2. Landscape enhancements.
- 3. Pedestrian amenities.
- 4. Vehicular access at the southwest entrance.
- 5. Recreational amenities.
- 6. Consideration of saving additional trees.

Yes: All present (9)

MOTION CARRIED

OTHER ITEMS

6. PLANNING COMMISSION 2023 ANNUAL REPORT

Mr. Savidant acknowledged Mr. Lambert and Mr. Krent brought to his attention a few corrections to the 2023 Annual Report. He said he would submit a corrected version of the report to the City Council.

7. <u>PUBLIC COMMENT</u> – For Items on the Agenda

There was no one present who wished to speak.

8. PLANNING COMMISSION COMMENT

There were general Planning Commission comments, some relating to:

- Upcoming Oakland County online webinar on stormwater standards.
- Administrative review of tree surveys submitted by applicants.
- Review/consideration of the Master Plan is scheduled on the City Council January 29, 2024 meeting.
- Setback requirements in relation to the number of variance requests going before the Zoning Board of Appeals (ZBA).

Ms. Dufrane clarified the procedure that the Board is required to follow for Resolutions that recommend approval and/or denial of an application for action by the City Council.

9. ADJOURN

The Regular meeting	g of the Planning	Commission ad	liourned at 8:34 i	o.m.

Respectfully submitted,	
Marianna Perakis, Chair	-
	_
Kathy L. Czarnecki, Recording Secretary	_

https://d.docs.live.net/2f7ed4fe5f664ea8/Documents/Kathy/COT Planning Commission Minutes/2024/2024 01 23 Draft.docx

DATE: February 7, 2024

TO: Planning Commission

FROM: R. Brent Savidant, Community Development Director

SUBJECT: PRELIMINARY SITE PLAN APPROVAL (JPLN2023-0033) -. Proposed Premier

Academy Troy daycare center and preschool, Northwest corner of Crooks and Wattles (PIN 88-20-17-476-056, 0-57 & -061), Section 17, Zoned NN (Neighborhood Node "I")

Zoning District.

The petitioner JS Capitol Group submitted the above referenced Preliminary Site Plan application for a 14,328 square-foot daycare and preschool center. The property is currently zoned NN (Neighborhood Node "I") Zoning District. The Planning Commission is responsible for granting Preliminary Site Plan approval for this item.

The attached report prepared by Carlisle/Wortman Associates, Inc. (CWA), the City's Planning Consultant, summarizes the project. CWA prepared the report with input from various City departments including Planning, Engineering, Public Works and Fire. City Management supports the findings of fact contained in the report and the recommendations included therein.

Attachments:

- 1. Maps
- 2. Report prepared by Carlisle/Wortman Associates, Inc.
- 3. Preliminary site plan

G:\SITE PLANS\SP_JPLN2023-0033_PREMIER ACADEMY TROY\PC Memo 2024 02 13.docxENT\PC Memo 2024 01 23.docx

PROPOSED RESOLUTION

PRELIMINARY SITE PLAN APPROVAL (JPLN2023-0033) –. Proposed Premier Academy Troy daycare center and preschool, Northwest corner of Crooks and Wattles (PIN 88-20-17-476-056, 0-57 & -061), Section 17, Zoned NN (Neighborhood Node "I") Zoning District.

Resolution	#PC	-202	4-02-
------------	-----	------	-------

Moved by: Seconded by:

RESOLVED, That Preliminary Site Plan Approval, pursuant to Article 8 of the Zoning Ordinance, as requested for the proposed Premier Academy Troy daycare center and preschool, located on the northwest corner of Crooks and Wattles (PIN 88-20-17-476-056, 0-57 & -061), Section 17, Zoned NN (Neighborhood Node "I") Zoning District, be granted, subject to the following:


- 1) Obtain LOMA prior to Final Engineering approval.
- 2) Obtain EGLE wetland permit, if necessary, prior to Final Engineering approval.
- 3) Provide bicycle parking.

) or
(denied, for the following reasons:) or
(postponed, for the following reasons:)
Yes: No:	

MOTION CARRIED/FAILED

TROY

GIS Online

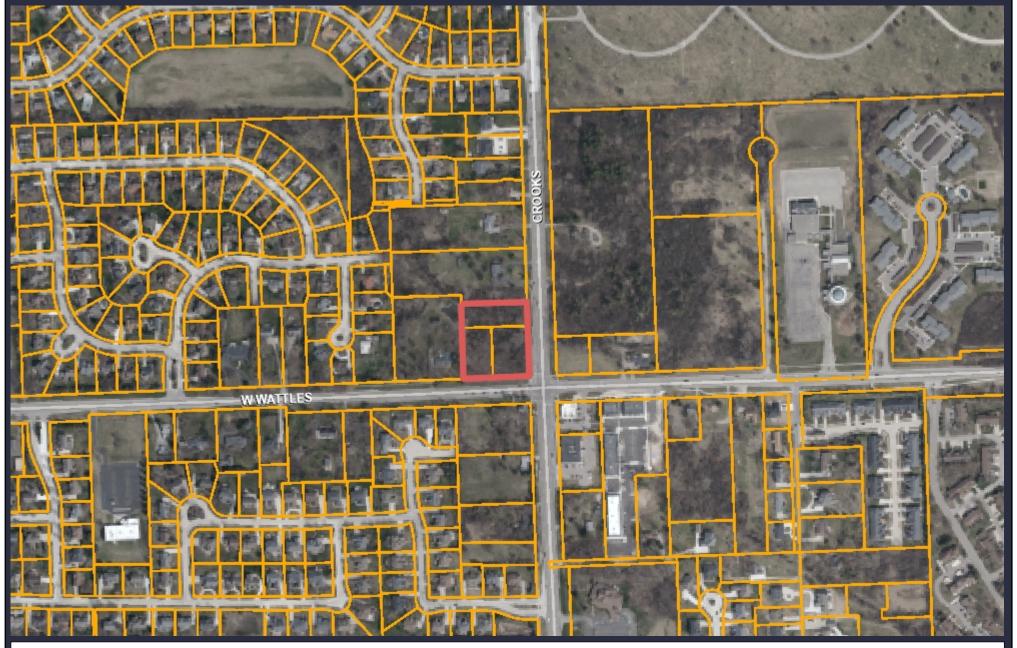

1,153 0 577 1,153Feet



Note: The information provided by this application has been compiled from recorded deeds, plats, tax maps, surveys, and other public records and data. It is not a legally recorded map survey. Users of this data are hereby notified that the source information represented should be consulted for verification.

TROY

GIS Online



1,153 0 577 1,153 Feet



Note: The information provided by this application has been compiled from recorded deeds, plats, tax maps, surveys, and other public records and data. It is not a legally recorded map survey. Users of this data are hereby notified that the source information represented should be consulted for verification.



117 NORTH FIRST STREET SUITE 70 ANN ARBOR, MI 48104 734.662.2200 734.662.1935 FAX

Date: January 11, 2024 Revised: February 8, 2024

For City of Troy, Michigan

Applicant: JS Capitol Group

Project Name: Premier Academy

Location: Northwest corner of Crooks and Wattles

Plan Date: December 8, 2023

Zoning: NN, Neighborhood Nodes ("I")

Action Requested: Preliminary Site Plan

SITE DESCRIPTION

This is a review for Premier Academy, a one-story freestanding 14,328 square-foot daycare and preschool center. There are currently four (4) other Premier Academy facilities in Michigan. The site is located at the northwest corner of Crooks and Wattles. The building includes a pre-k classroom, pre-school classroom, four Montessori's, and designated infant and toddler areas; plus a lobby, laundry room, kitchen, gym, playground, and other smaller rooms such as restrooms and storage spaces.

Premier Academy has locations in Rochester Hills, Northville, Macomb, and Oakland Township.

The site is zoned Neighborhood Node, site type B. Childcare centers are a permitted use.

The proposed site contains three parcels of undeveloped land. Each parcel is part of Lot 4 of the "SUPERVISOR'S PLAT OF TROY FARMSITES" subdivision.

Parcel A: 20-17-476-061
Parcel B: 20-17-476-056
Parcel C: 20-17-476-057

If approved, the lots will need to be combined.

Site Location:



Proposed Uses of Subject Parcel:

One-story freestanding 14,328 square foot retail building.

Current Zoning:

The property is currently zoned NN, Neighborhood Nodes ("I") Form Based District.

Surrounding Property Details:

Direction	Zoning	Use
North	NN, Neighborhood Nodes ("I")	Single-Family Residential
South	NN, Neighborhood Nodes ("I")	Single-Family Residential
East	NN, Neighborhood Nodes ("I")	Vacant
	R-1B One Family Residential	
West	NN, Neighborhood Nodes ("I")	Single-Family Residential

NATURAL FEATURES

Topography/Wetlands/Drain: The existing site contains a 6,100 sq/ft wetland area and lies in a designated floodplain. The wetland area covers the site entirely at the north end of the property and subsides roughly halfway towards the southern end of the property. An existing county drain (Lane Drain) runs through Parcels A and C. The applicant is developing and grading within the 100-year floodplain and installing a retaining wall between the parking lot and floodplain/drain. To do the proposed work, the applicant will be required to obtain a Letter of Map Amendment (LOMA) from the Federal Emergency Management Agency (FEMA). A LOMA is an official amendment, by letter, to an effective National Flood Insurance Program (NFIP) map. In addition, due to wetlands associated with the Lane Drain, a wetland permit may be required from EGLE.

Prior to final site plan approval and any Engineering approval, the applicant is required to obtain the LOMA and wetland permit, if necessary. It should be noted that the applicant may be able to reduce impact and development within the floodplain and wetland if they are able to eliminate the 11 parking spaces located north of the building adjacent to the proposed retaining wall. See parking section for more information.

Woodlands: The site contains roughly 230 existing trees of various native and invasive species. Of the 230 trees, 36 are regulated trees. Of the woodland trees, the applicant will remove 32 trees and save 3. There is one singular Landmark tree on-site which will also be removed.

Full replacement and preservation details are shown in Table 2.

Table 2. – Woodland Protection Ordinance

Replacement Details			
Protected Tree Inches Removed Replacement Required			
Landmark	12 inches	12 inches	
Woodland	312 inches	156 inches	

Preservation/Mitigation	Inches Preserved	Credit
Landmark	0 inches	0 inches
Woodland	27 inches	54 inches
Total	114 inches required for replacement.	

Items to be addressed:

- 1) Consider removing or landbank parking to reduce impact upon floodplain and drain. See details under "Parking" section.
- 2) Obtain LOMA prior to final site plan approval.
- 3) If required, EGLE wetland permit will be obtained prior to final Engineering approvals.

AREA, WIDTH, HEIGHT, SETBACKS

The proposed building is being reviewed under Building Form A.

	Required / Maximum	Provided	Compliance
Front (South)	10-foot build-to-line	10-feet	Complies
Front (East)	10-foot build-to-line	21.5-feet	Complies with Planning Commission approval
Side (West)	N/A, building may be placed up to property line	89.75-feet	Complies
Rear (North)	30-foot minimum setback	236-feet	Complies
Building Height	1 story, 14-feet, 2.5 stories, 30-feet	1 story, 18.5 feet	Complies
Open Space	30%	56.5%	Complies
Parking Location	Cannot be located in front yard	Located behind building	Complies

Items to be addressed: None

PARKING

	Required	Provided
Day Care Center: 2 spaces plus 1 additional space for each 8 children	196/8 + 2 spaces = 27 spaces	44
Loading zone	1	None
Barrier Free	2	2
Bicycle	2	2
Total	27	44

In order to reduce impervious surface and not overpark sites, parking in excess of 20% of the parking minimum requires Planning Commission approval. The applicant is required to have 27 spaces but is providing 44 spaces, 61% over the required. We note that there are 11 spaces located north of the building. Removing these 11 spaces may allow a reduction in the amount of grading within the floodplain and impact upon drain and wetlands. Removing these 11 spaces would reduce the total number of spaces to 33, which still exceeds the parking required for the site. In conversations with the applicant, they note that they need a certain amount of parking based on their need. We had raised this issue with the applicant in a previous review. They note that based on their experience of other facilities, they think parking is sufficient. The applicant provided a parking summary, depicting the average number of arrivals and departures per hour at other Premier Academy locations. Applicant states that having less than 44 parking spaces would lead to congestion and inconvenience.

A designated loading zone is not indicated on the site plan. The applicant states that like all other Premier Academy facilities, operations do not require any kind of large deliveries; therefore, a loading zone is not necessary.

Items to be Addressed:

- 1) Planning Commission to consider allowing parking to exceed greater than the 20% of the parking minimum. Applicant to provide written justification. As part of discussion, the Planning Commission should discuss with the applicant removing or landbanking the 11 spaces on the north side of the building to reduce impact upon floodplain and the necessity of a loading zone.
- 2) Applicant states that bicycle parking has been added; however, we have not been able to locate such parking on the revised site plans. Provide bicycle parking.

TRAFFIC and CIRCULATION

The site plan has been reviewed by the Engineering Department and by OHM. In their review they note that:

The Fire Department has reviewed the project and found access and circulation to be sufficient. OHM concerns have been addressed.

Items to be addressed: None.

SPECIFIC USE PROVISIONS

Day Care Centers have specific use standards as set forth in Section 6.09 of the Zoning Ordinance:

1. Frontage on either a major or minor arterial street shall be required.

CWA Comment: Complies

 A separate drop-off and pickup area shall be required adjacent to the main building entrance, located off of a public street and the parking access lane, and shall be of sufficient size so as to not create congestion on the site or within a public roadway.

CWA Comment: There is no separate drop-off and pickup area. The applicant explains that the staggered nature of drop-off and pick up times allows for a smooth and even flow of visitors throughout the day. They state that designated parking spaces shall be marked "reserved" for drop-off and pick up.

3. There shall be an outdoor play area of at least one thousand (1,000) square feet provided on the premises. Said play area shall not be located within the front setback. This requirement may be waived if a public play area is available five hundred (500) feet from the subject parcel.

CWA Comment: The play area greatly exceeds 1,000 sq.ft.

4. Appropriate licenses with the State shall be maintained.

CWA Comment: The applicant will be required to obtain and maintain the required state licenses.

Items to be Addressed:

1) Explain the drop-off and pickup operation to confirm that congestion on the site or within a public roadway will not be created.

Site Plan Revisions 1/26/24:

LANDSCAPING

A landscaping plan has been provided on Sheet L101. The following table discusses the development's compliance with the landscape requirements set forth in Section 13.02.

	Required:	<u>Provided:</u>	<u>Compliance:</u>
Crooks and Wattles: The Ordinance requires that the greenbelt shall be landscaped with a minimum of one (1) deciduous tree for every thirty (30) lineal feet, or fraction thereof, of frontage abutting a public road right-of-way.	Crooks: 330 feet = 11 trees Wattles: 292 feet = 10 trees	11 trees 10 trees	Complies
Site landscaping: A minimum of twenty (20%) of the site area shall be comprised of landscape material. Up to twenty-five percent (25%) of the required landscape area may be brick, stone, pavers, or other public plaza elements, but shall not include any parking area or required sidewalks.	20%	60%	Complies
Screening between uses: Table 13.02A and 13.02B set forth screening requirements relating to adjacent land uses.	East: Screening required	Not provided	Complies
Parking Lot Trees: 1 per 8 spaces	44 spaces = 6 trees	7 trees	Complies
Tree mitigation:	Required 114 inches	Provided 114 inches	Complies

<u>Transformer / Trash Enclosure:</u>

The trash enclosure will be screened with a masonry block wall.

Retaining Wall/ Play Area Fence

A concrete Versa-Lok retaining wall system will be utilized. A four (4) foot ornamental steel fence shall be erected around the playground.

Items to be Addressed: None.

PHOTOMETRICS

The applicant is proposing three (3) new parking lot lights, and three (3) wall lights. We note that the fixtures and footcandle measurements comply and the parking lot lighting averages over 3FC throughout the lot.

Items to be Addressed: None.

FLOOR PLAN AND ELEVATIONS

The applicant has submitted floor plans and elevations. The proposed building materials include modular metal panels in shades of blue, green, grey, and white. The colors proposed for the building are Premier Academy's corporate colors. The south elevation (adjacent to Wattles) of the building includes many windows, with the largest window featuring an oversized decal of Premier Academy's logo (dimensions not included).

Items to be Addressed: None.

DESIGN STANDARDS AND SITE PLAN REVIEW STANDARDS

The Neighborhood Node design standards as well as Site Plan review standards provide the Planning Commission with direction when reviewing the proposed site plan and design features of this development. We note that the applicant is compliant with the following transparency requirements:

- South (Wattles): 50% required, 62% provided (as calculated by applicant)
- East (Crooks): 50% required, 58% provided (as calculated by applicant)
- West (parking lot): 30% required, 48% provided (as calculated by applicant)
- North (parking lot): 30% required, 50% provided (as calculated by applicant)

Section 8.06 outlines Site Plan Review Design Standards.

- 1. Development shall ensure compatibility with existing commercial districts and provide a transition between land uses.
 - a. Building design shall enhance the character of the surrounding area in relation to building and parking placement, landscape and streetscape features, and architectural design.
 - b. Street fronts shall provide a variety of architectural expression that is appropriate in its context and prevents monotony.
 - c. Building design shall achieve a compatible transition between areas with different height, massing, scale, and architectural style.
- 2. Development shall incorporate the recognized best architectural building design practices.

- a. Foster a lasting impact on the community through the provision of high quality design, construction, and detailing.
- b. Provide high quality, durable materials, such as but not limited to stone, brick, glass, and metal. E.I.F.S. or material equivalent shall only be used as an accent material.
- c. Develop buildings with creativity that includes balanced compositions and forms.
- d. Design roofs that are appropriate to the architectural style of the building and create an appropriate visual exterior mass of the building given the context of the site.
- e. For commercial buildings, incorporate clearly defined, highly visible customer entrances using features such as canopies, porticos, arcades, arches, wing walls, ground plane elements, and/or landscape planters.
- f. Include community amenities that add value to the development such as patio/ seating areas, water features, art work or sculpture, clock towers, pedestrian plazas with park benches or other features located in areas accessible to the public.
- 3. Enhance the character, environment and safety for pedestrians and motorists.
 - a. Provide elements that define the street and the pedestrian realm.
 - b. Create a connection between the public right of way and ground floor activities.
 - c. Create a safe environment by employing design features to reduce vehicular and pedestrian conflict, while not sacrificing design excellence.
 - d. Enhance the pedestrian realm by framing the sidewalk area with trees, awnings, and other features.
 - e. Improve safety for pedestrians through site design measures.

Items to be Addressed: None.

SUMMARY

As part of the deliberation, the Planning Commission and the applicant shall discuss:

- 1) Allowing parking to exceed greater than the 20% of the parking minimum. As part of discussion, the Planning Commission should discuss with the applicant removing the 11 spaces on the north side of the building or landbanking that parking to reduce impact upon floodplain.
- 2) Compliance with Section 8.06 Site Plan Review Standards.

If Planning Commission approves the preliminary site plan, the following conditions shall be required as part of the final site plan submittal:

- 1) Obtain LOMA prior to Final Engineering approval.
- 2) Obtain EGLE wetland permit, if necessary, prior to Final Engineering approval.
- Provide bicycle parking

Premier Academy February 8, 2024

Sincerely,

CARLISLE/WORTMAN ASSOC., INC. Benjamin R. Carlisle, AICP, LEED AP President

CARLISLE/WORTMAN ASSOC., INC. Shana Kot Community Planner

PREMIER ACADEMY - TROY

NORTHWEST CORNER OF CROOKS AND WATTLES TROY, OAKLAND COUNTY, MICHIGAN

PERMIT / APPROVAL SUMMARY

DATE SUBMITTED DATE APPROVED PERMIT / APPROVAL



INDEX OF DRAWINGS NUMBER TITLE **COVER SHEET** TOPOGRAPHIC SURVEY PRELIMINARY DIMENSION PLAN PRELIMINARY GRADING PLAN PRELIMINARY UTILITY PLAN **NOTES AND DETAILS** PRELIMINARY LANDSCAPE PLAN LANDSCAPE DETAILS TREE PRESERVATION PLAN TREE LIST PHOTOMETRIC PLAN ARCHITECTURAL PLANS A.100 FLOOR PLAN EXTERIOR ELEVATIONS A.201 **EXTERIOR ELEVATIONS** A.300 RENDERINGS

DESIGN TEAM

OWNER/APPLICANT/DEVELOPER

JS CAPITOL GROUP
155 ROMEO ROAD, SUITE 300
ROCHESTER, MI 48307
CONTACT: JEFF SCHMITZ
PHONE: 810.841.0587
EMAIL: JEFF.SCHMITZ@JSCAPITOL.COM

ARCHITECT

KRIEGER KLATT ARCHITECTS, INC 2120 EAST ELEVEN MILE ROAD ROYAL OAK, MI 48067 CONTACT: JEFF KLATT PHONE: 248.414 9270 EMAIL: JEFF@KRIEGERKLATT.COM


CIVIL ENGINEER

PEA GROUP 1849 POND RUN AUBURN HILLS, MI 48326 CONTACT: JOHN STEBELTON, PE PHONE: 248.689.9090 EMAIL: JSTEBELTON@PEAGROUP.COM


LANDSCAPE ARCHITECT

PEA GROUP
7927 NEMCO WAY, STE. 115
BRIGHTON, MI 48116
CONTACT: LYNN WHIPPLE, PLA
PHONE: 844.813.2949
EMAIL: LWHIPPLE@PEAGROUP.COM

PENA GROUP

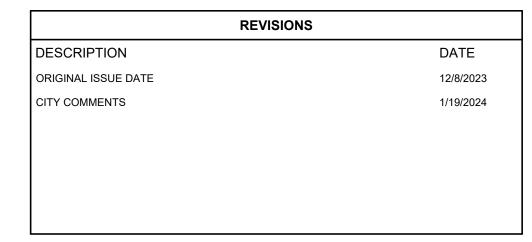





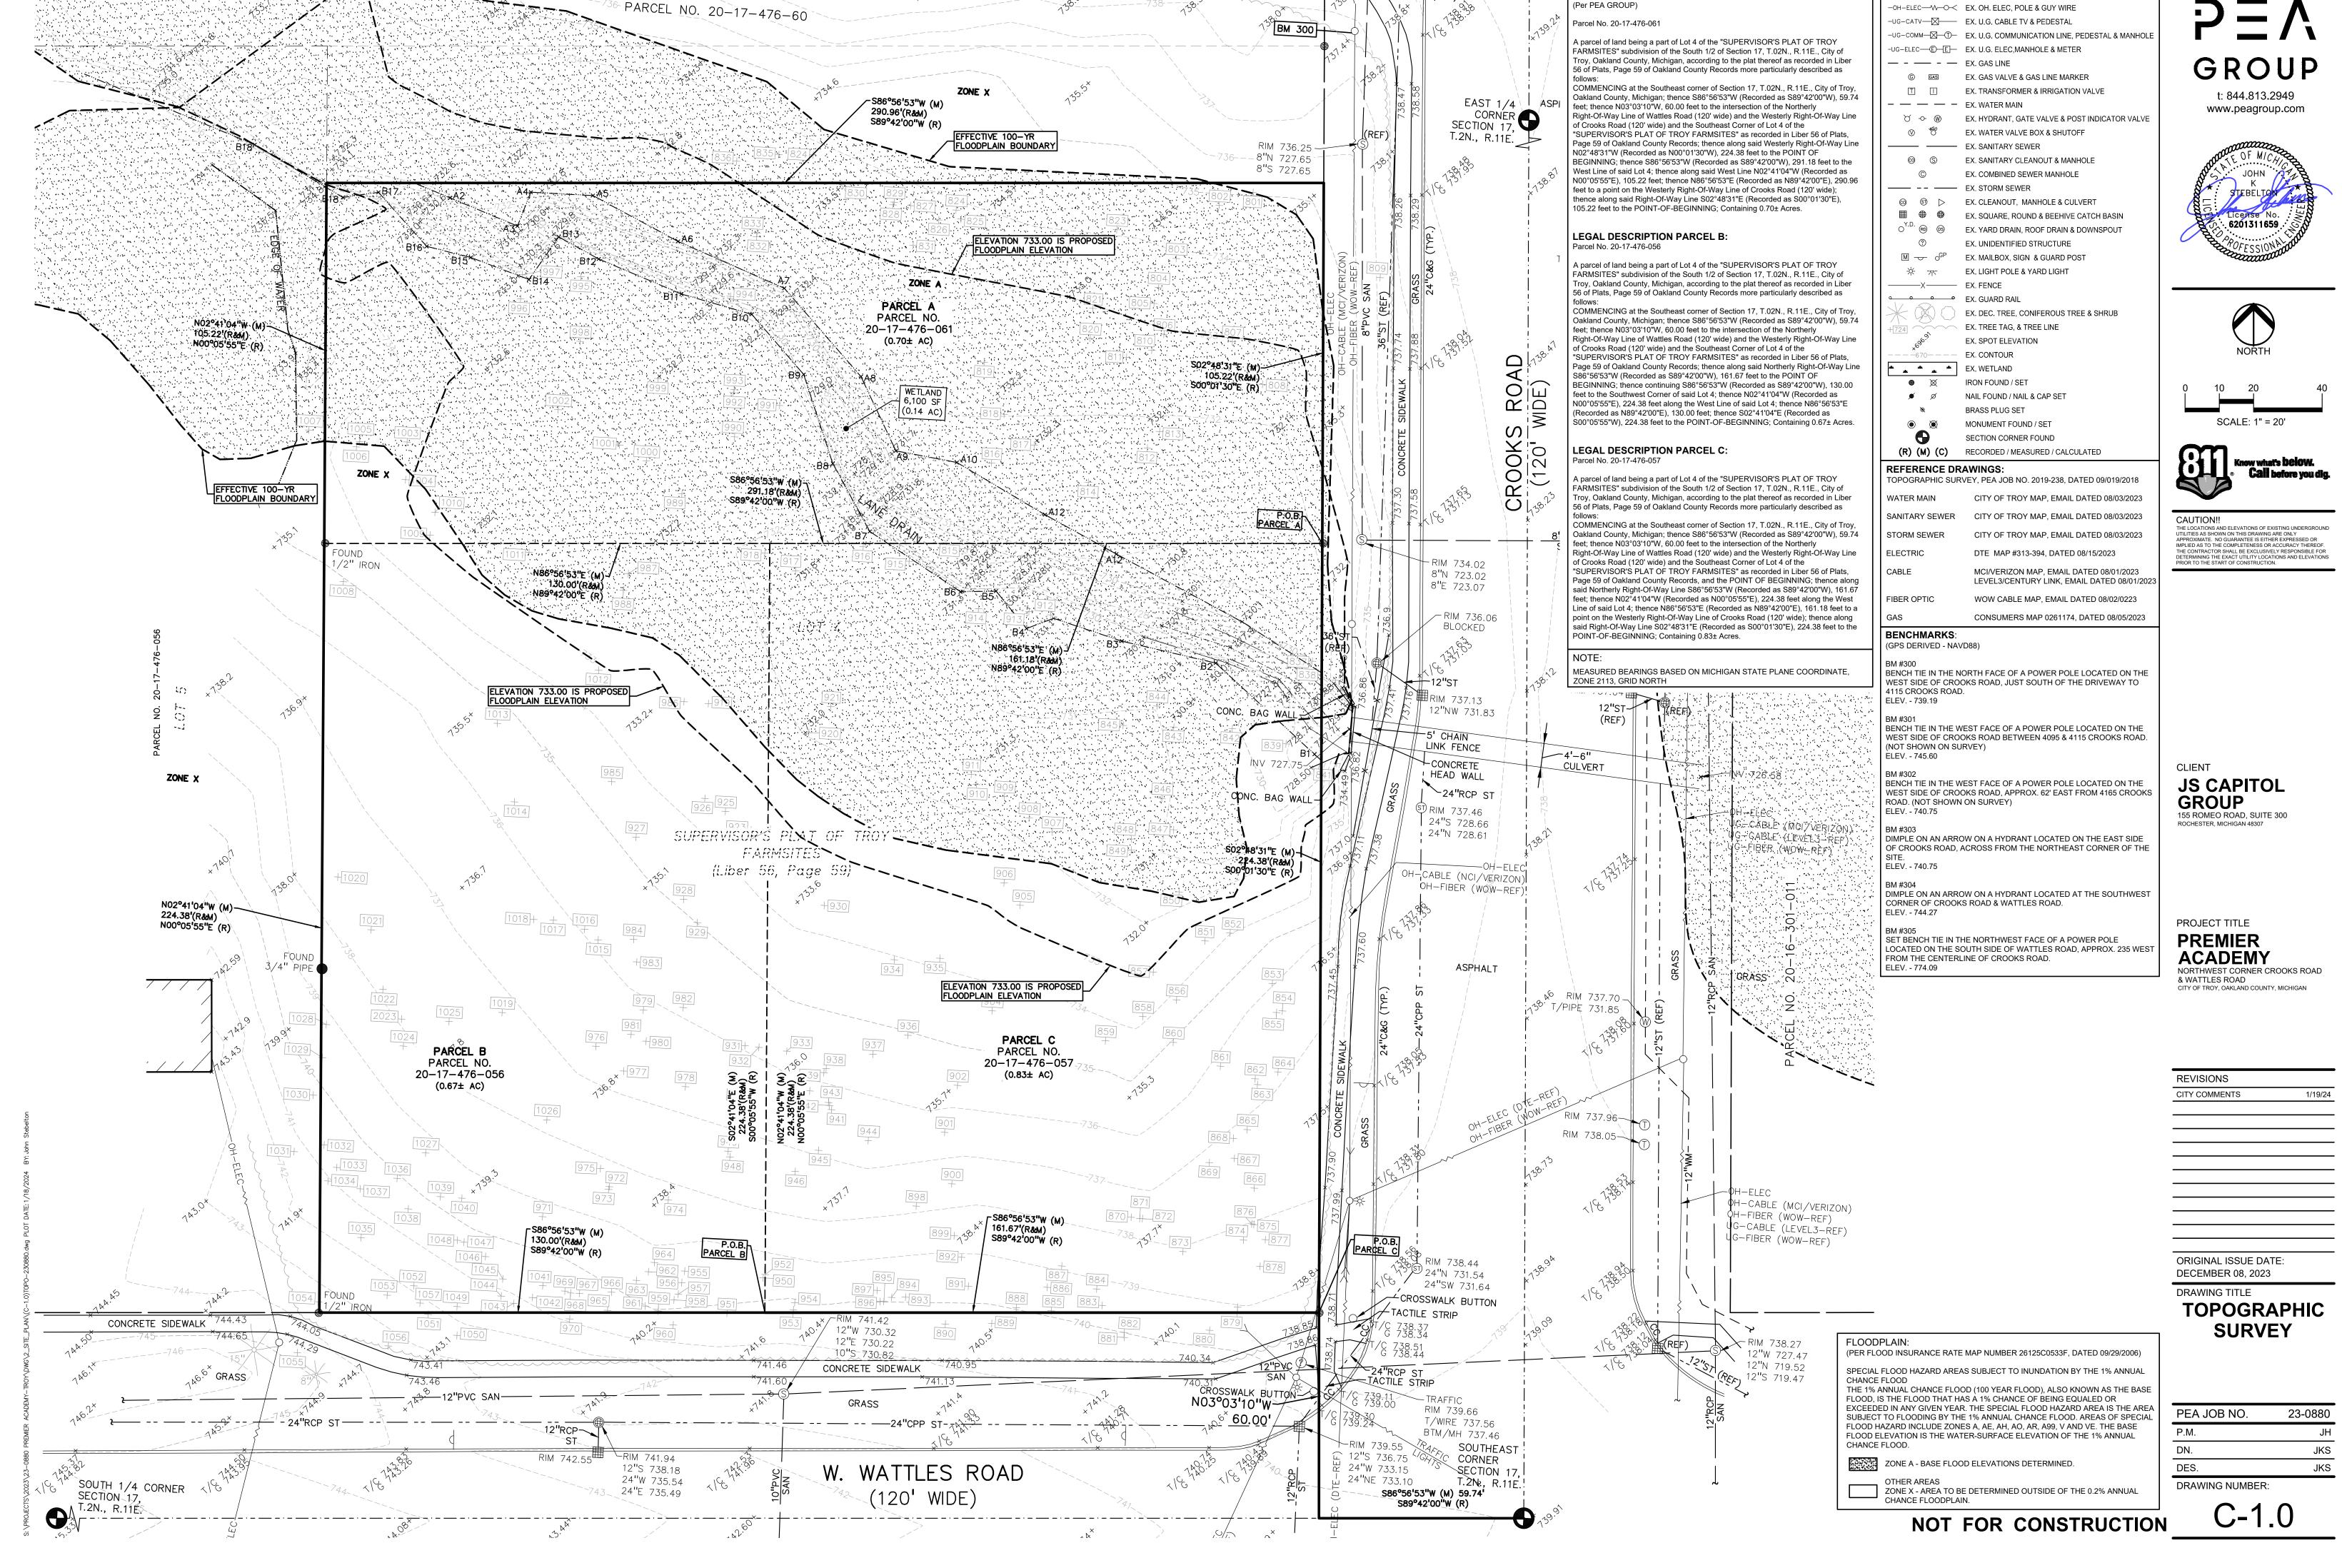

LEGEND:

LEGAL DESCRIPTION PARCEL A:

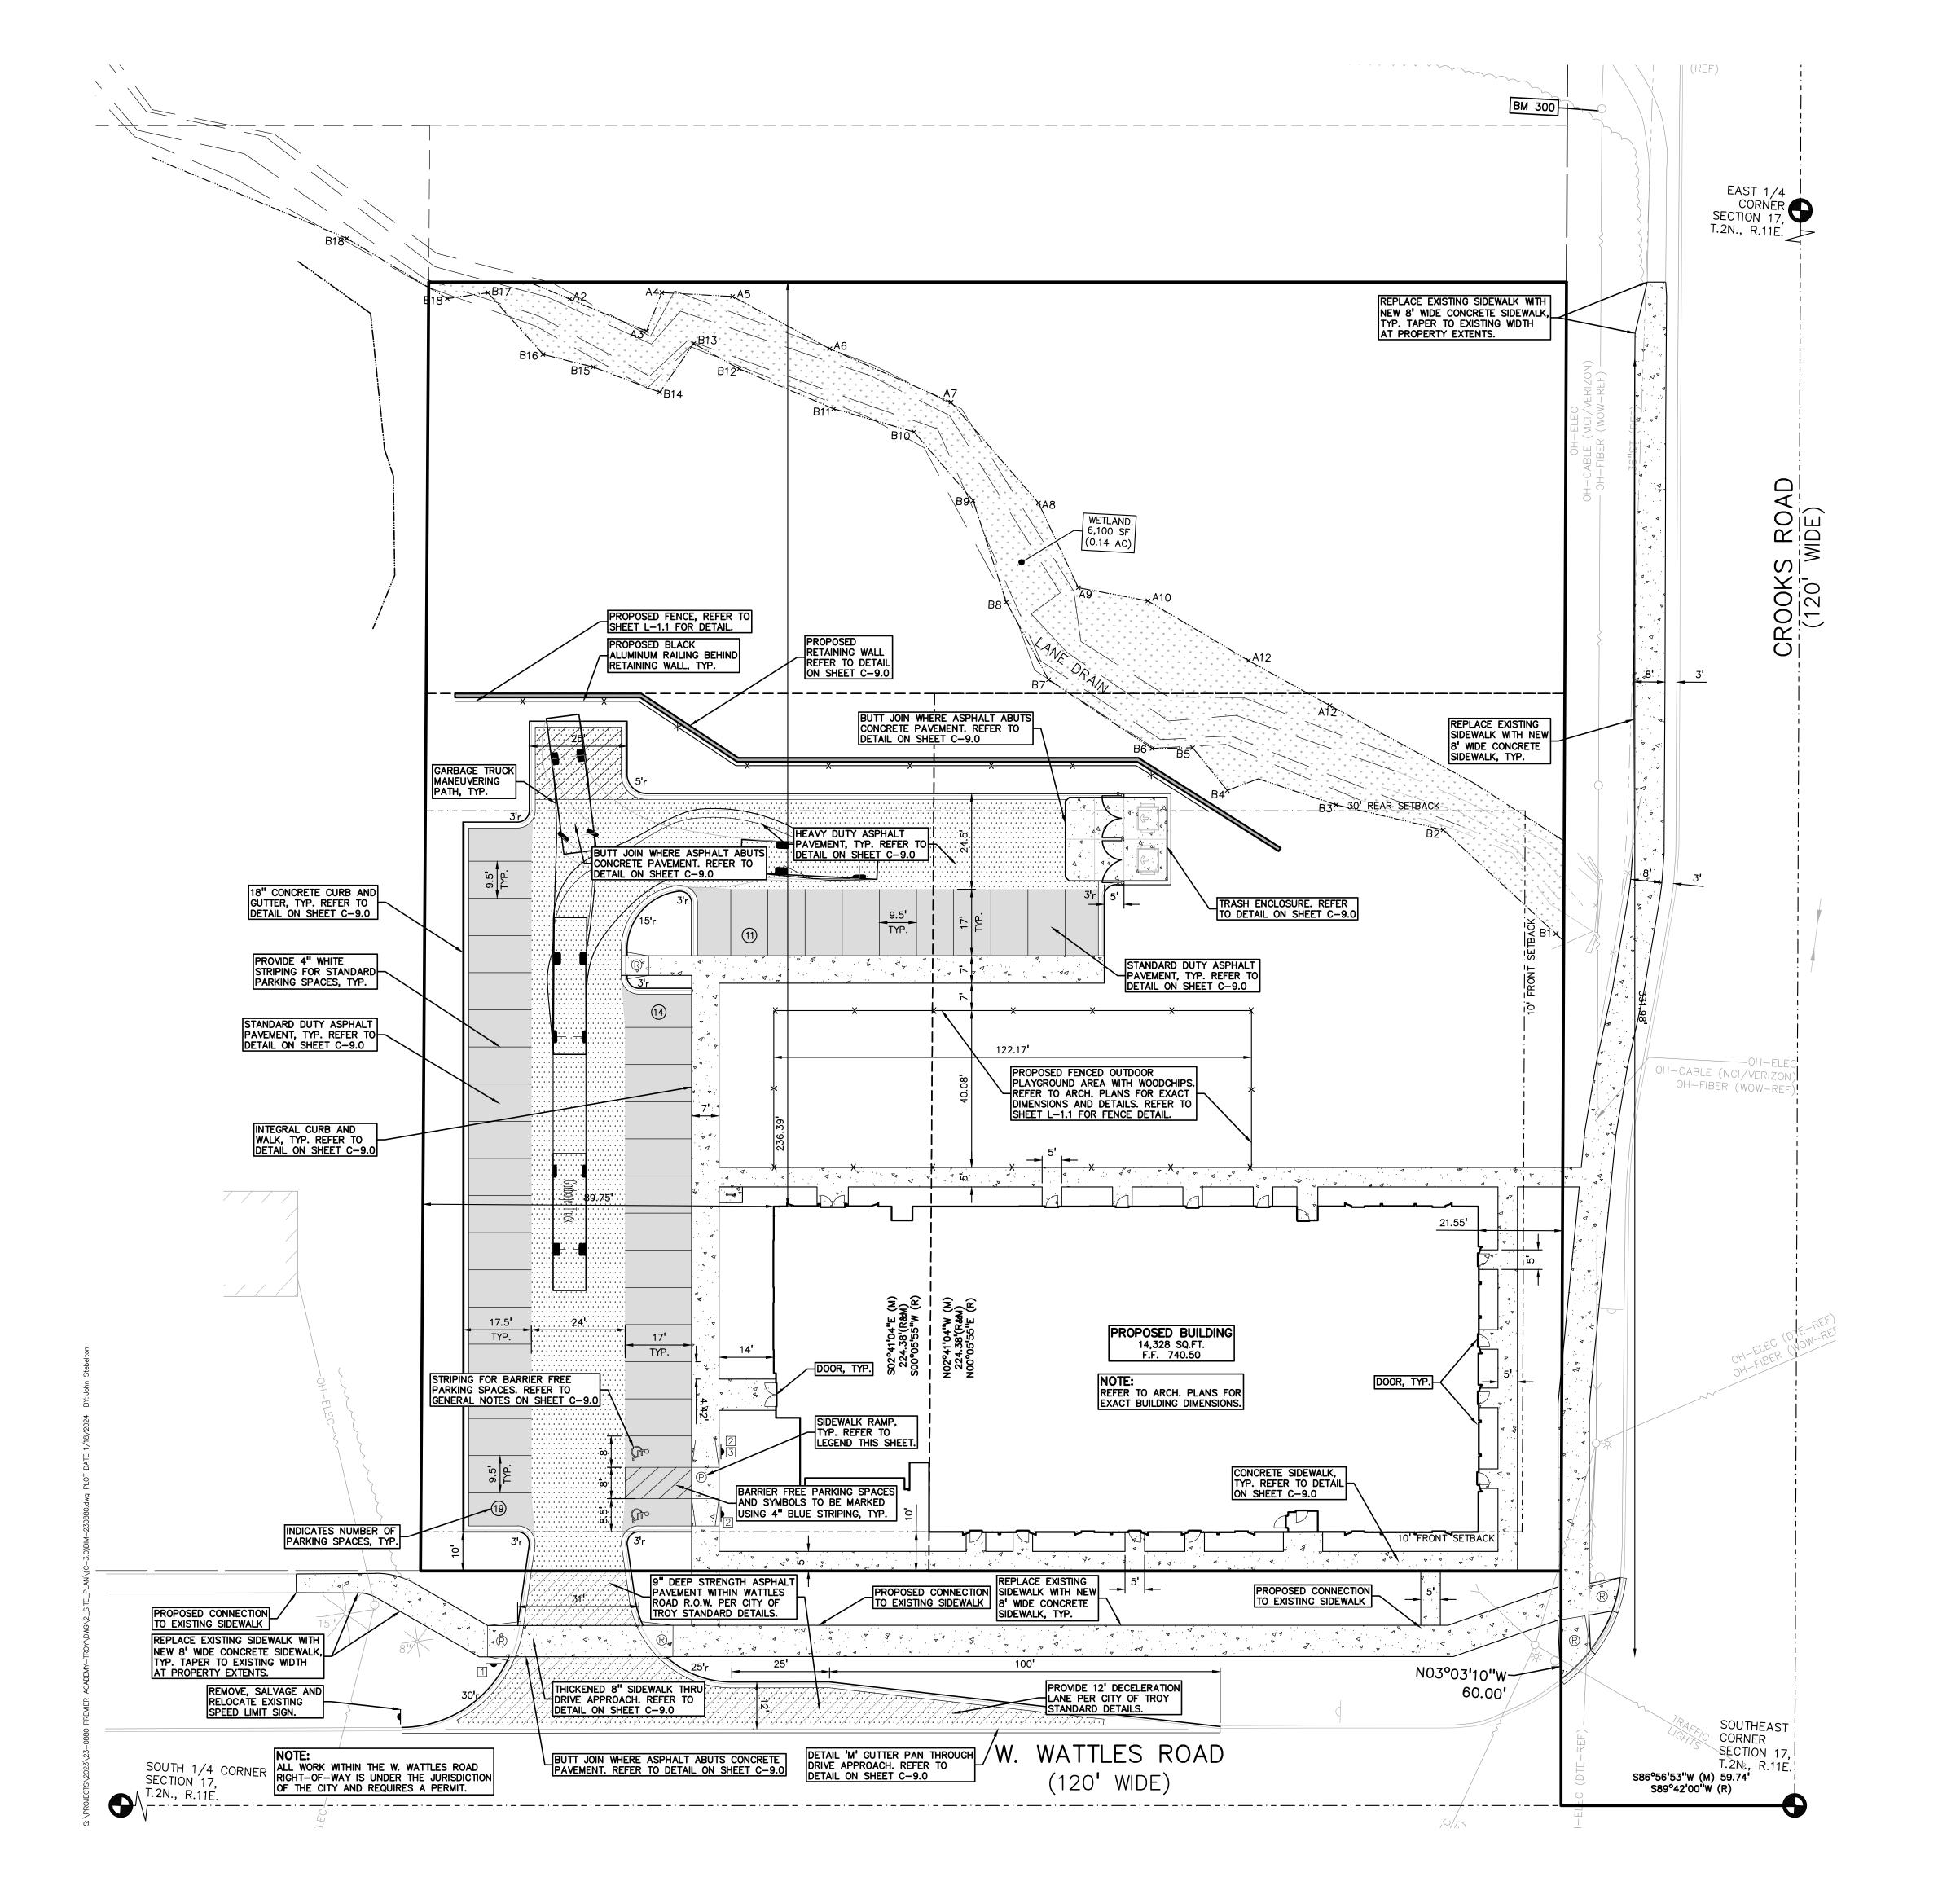

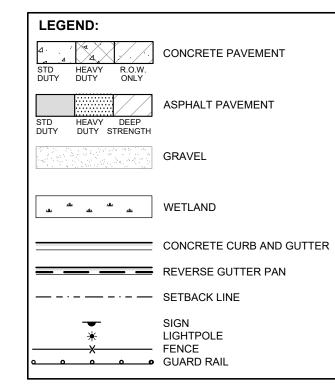

SIGN LEGEND:

'STOP' SIGN

'BARRIER FREE PARKING' SIGN

'VAN ACCESSIBLE' SIGN

'EMERGENCY VEHICLES ONLY' SIGN

REFER TO SHEET C-9.0 FOR SIGN DETAILS

PROPOSED:

89.75'

236.39'

CURB DROP ONLY

REFER TO LATEST MDOT R-28 STANDARD RAMP AND DETECTABLE WARNING DETAILS

NORTH
0 10 20

SCALE: 1" = 20'

GROUP

t: 844.813.2949

www.peagroup.com

Know what's below.

Call before you dig.

CAUTION!!
THE LOCATIONS AND ELEVATIONS OF EXISTING UNDERGROUND UTILITIES AS SHOWN ON THIS DRAWING ARE ONLY APPROXIMATE. NO GUARANTEE IS EITHER EXPRESSED OR IMPLIED AS TO THE COMPLETENESS OR ACCURACY THEREOF. THE CONTRACTOR SHALL BE EXCLUSIVELY RESPONSIBLE FOR DETERMINING THE EXACT UTILITY LOCATIONS AND ELEVATIONS PRIOR TO THE START OF CONSTRUCTION.

CLIENT
JS CAPITOL
GROUP

155 ROMEO ROAD, SUITE 300

ROCHESTER, MICHIGAN 48307

SITE SOILS INFORMATION:
ACCORDING TO THE USDA NATURAL RESOURCES CONSERVATION
SERVICE WEB SOIL SURVEY FOR OAKLAND COUNTY, THE SITE
CONSISTS OF THE FOLLOWING SOIL TYPES:

GENERAL NOTES:

THESE NOTES APPLY TO ALL CONSTRUCTION ACTIVITIES ON THIS PROJECT.

<u>OPEN SPACE:</u>
MINIMUM OPEN SPACE REQUIRED = 30%

PROVIDED OPEN SPACE = 56%

SITE DATA TABLE:

SITE AREA: 2.20 ACRES 96,016 SQ.FT.) GROSS

MAXIMUM ALLOWABLE BUILDING HEIGHT = 45 FEET (3 STORIES)
PROPOSED BUILDING HEIGHT = TBD

PARKING CALCULATIONS:
DAY CARE CENTER = 2 SPACES PLUS 1 ADDITIONAL SPACE FOR EACH 8 CHILDREN OF LICENSED AUTHORIZED CAPACITY

TOTAL PROPOSED PARKING SPACES = 44 SPACES INC. 2 H/C

ShbuaB SHEBEON-URBAN LAND COMPLEX, 0 TO 4 % SLOPES

TOTAL REQUIRED PARKING SPACES = 196 CHILDREN / 8 CHILDREN +2 SPACES = 27 SPACES

ZONING: NN (NEIGHBORHOOD NODES)

PROPOSED USE: CHILD CARE (14,328 SF)

BUILDING FOOTPRINT AREA = 14,328 SQ.FT.

BUILDING LOT COVERAGE = 14.9%

FRONT (SOUTH):

FRONT (EAST):

REAR (NORTH):

SIDE (WEST):

- 1. ALL DIMENSIONS SHOWN ARE TO BACK OF CURB, FACE OF SIDEWALK, OUTSIDE FACE OF BUILDING, PROPERTY LINE, CENTER OF MANHOLE/CATCH BASIN OR CENTERLINE OF PIPE UNLESS OTHERWISE NOTED.
- 2. 'NO PARKING-FIRE LANE' SIGNS SHALL BE POSTED ALONG ALL FIRE LANES AT 100 FOOT INTERVALS OR AS DIRECTED BY THE FIRE OFFICIAL.
- 3. REFER TO NOTES & DETAILS SHEET FOR ON-SITE PAVING DETAILS.
- 4. REFER TO NOTES & DETAILS SHEET FOR ON-SITE SIDEWALK RAMP DETAILS

PROJECT TITLE
PREMIER
ACADEMY
NORTHWEST CORNER CROOKS ROAD

CITY OF TROY, OAKLAND COUNTY, MICHIGAN

& WATTLES ROAD

REVISIONS	
CITY COMMENTS	1/19/24
-	
-	
-	

ORIGINAL ISSUE DATE: DECEMBER 08, 2023

PRELIMINARY
DIMENSION
PLAN

PEA JOB NO. 23-0880

P.M. JH


DN. JKS

DES. JKS

DRAWING NUMBER:

NOT FOR CONSTRUCTION

C-2.0

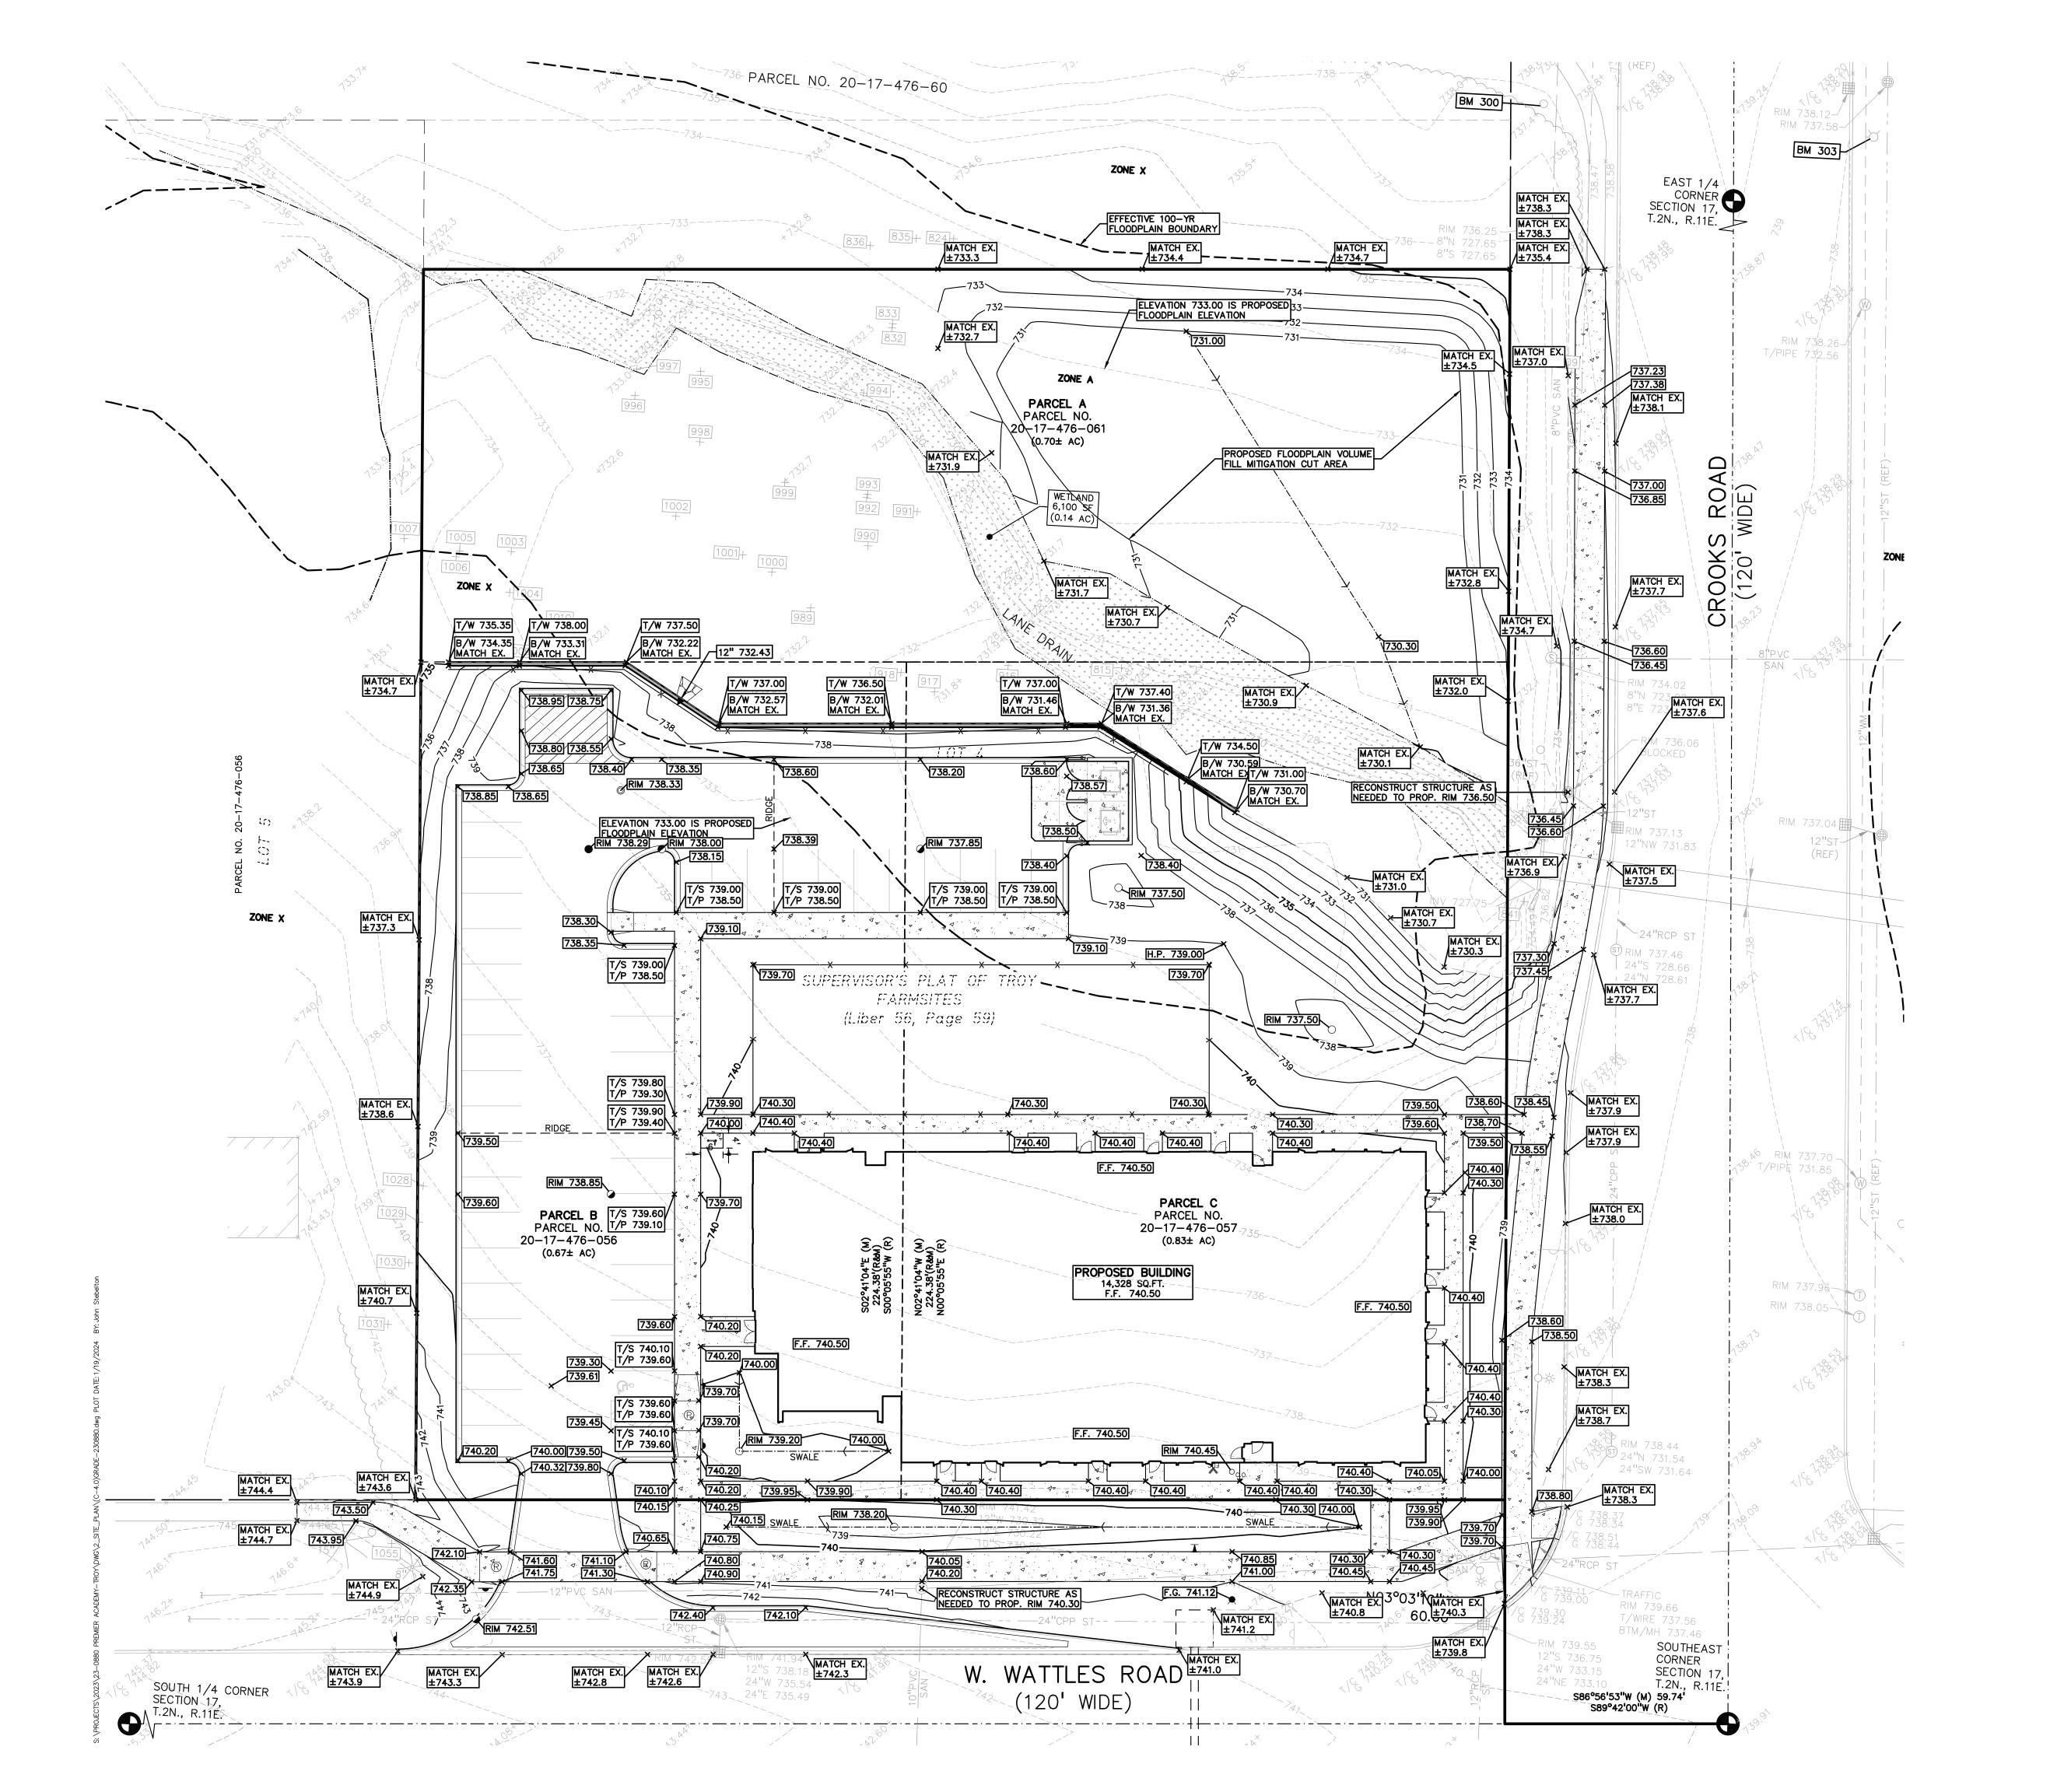



622.50 EXISTING SPOT ELEVATION

PROPOSED SPOT ELEVATION:
TYPICALLY TOP OF PAVEMENT
IN PAVED AREAS, GUTTER GRADE

IN CURB LINES.

670 EXISTING CONTOUR

PROPOSED CONTOUR

PROPOSED CONTOUR

PROPOSED REVERSE GUTTER PAN

PROPOSED RIDGE LINE

----- PROPOSED SWALE/DITCH

ABBREVIATIONS

T/C = TOP OF CURB

T/P = TOP OF PAVEMENT

T/S = TOP OF SIDEWALK

T/W = TOP OF WALL

B/W = BOTTOM OF WALL

G = GUTTER GRADE

FF = FINISH FLOOR


RIM = RIM ELEVATION

REFER TO GRADING NOTES ON SHEET C-X.X

RETAINING WALL NOTE:


TOP OF WALL (T/W) AND BOTTOM OF WALL (B/W) GRADES ARE THE FINISH GRADE AT THE TOP AND BOTTOM OF THE RETAINING WALL, NOT ACTUAL TOP AND BOTTOM OF THE WALL STRUCTURE.



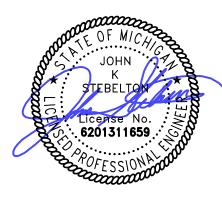

www.peagroup.com



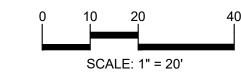



CAUTION!!

THE LOCATIONS AND ELEVATIONS OF EXISTING UNDERGROUND UTILITIES AS SHOWN ON THIS DRAWING ARE ONLY APPROXIMATE. NO GUARANTEE IS EITHER EXPRESSED OR IMPLIED AS TO THE COMPLETENESS OR ACCURACY THEREOF. THE CONTRACTOR SHALL BE EXCLUSIVELY RESPONSIBLE FOR DETERMINING THE EXACT UTILITY LOCATIONS AND ELEVATIONS PRIOR TO THE START OF CONSTRUCTION.

CLIENT

JS CAPITOL
GROUP

155 ROMEO ROAD, SUITE 300
ROCHESTER, MICHIGAN 48307

PROJECT TITLE

PREMIER

ACADEMY

NORTHWEST CORNER CROOKS ROA

& WATTLES ROAD

CITY OF TROY, OAKLAND COUNTY, MICHIGAN

REVISIONS
CITY COMMENTS 1/19/24

DECEMBER 08, 2023

DRAWING TITLE

PRELIMINAR

ORIGINAL ISSUE DATE:

PRELIMINARY GRADING PLAN

PEA JOB NO. 23-0880

P.M. JH


DN. JKS


DES. JKS


DRAWING NUMBER:

NOT FOR CONSTRUCTION

C-4.0

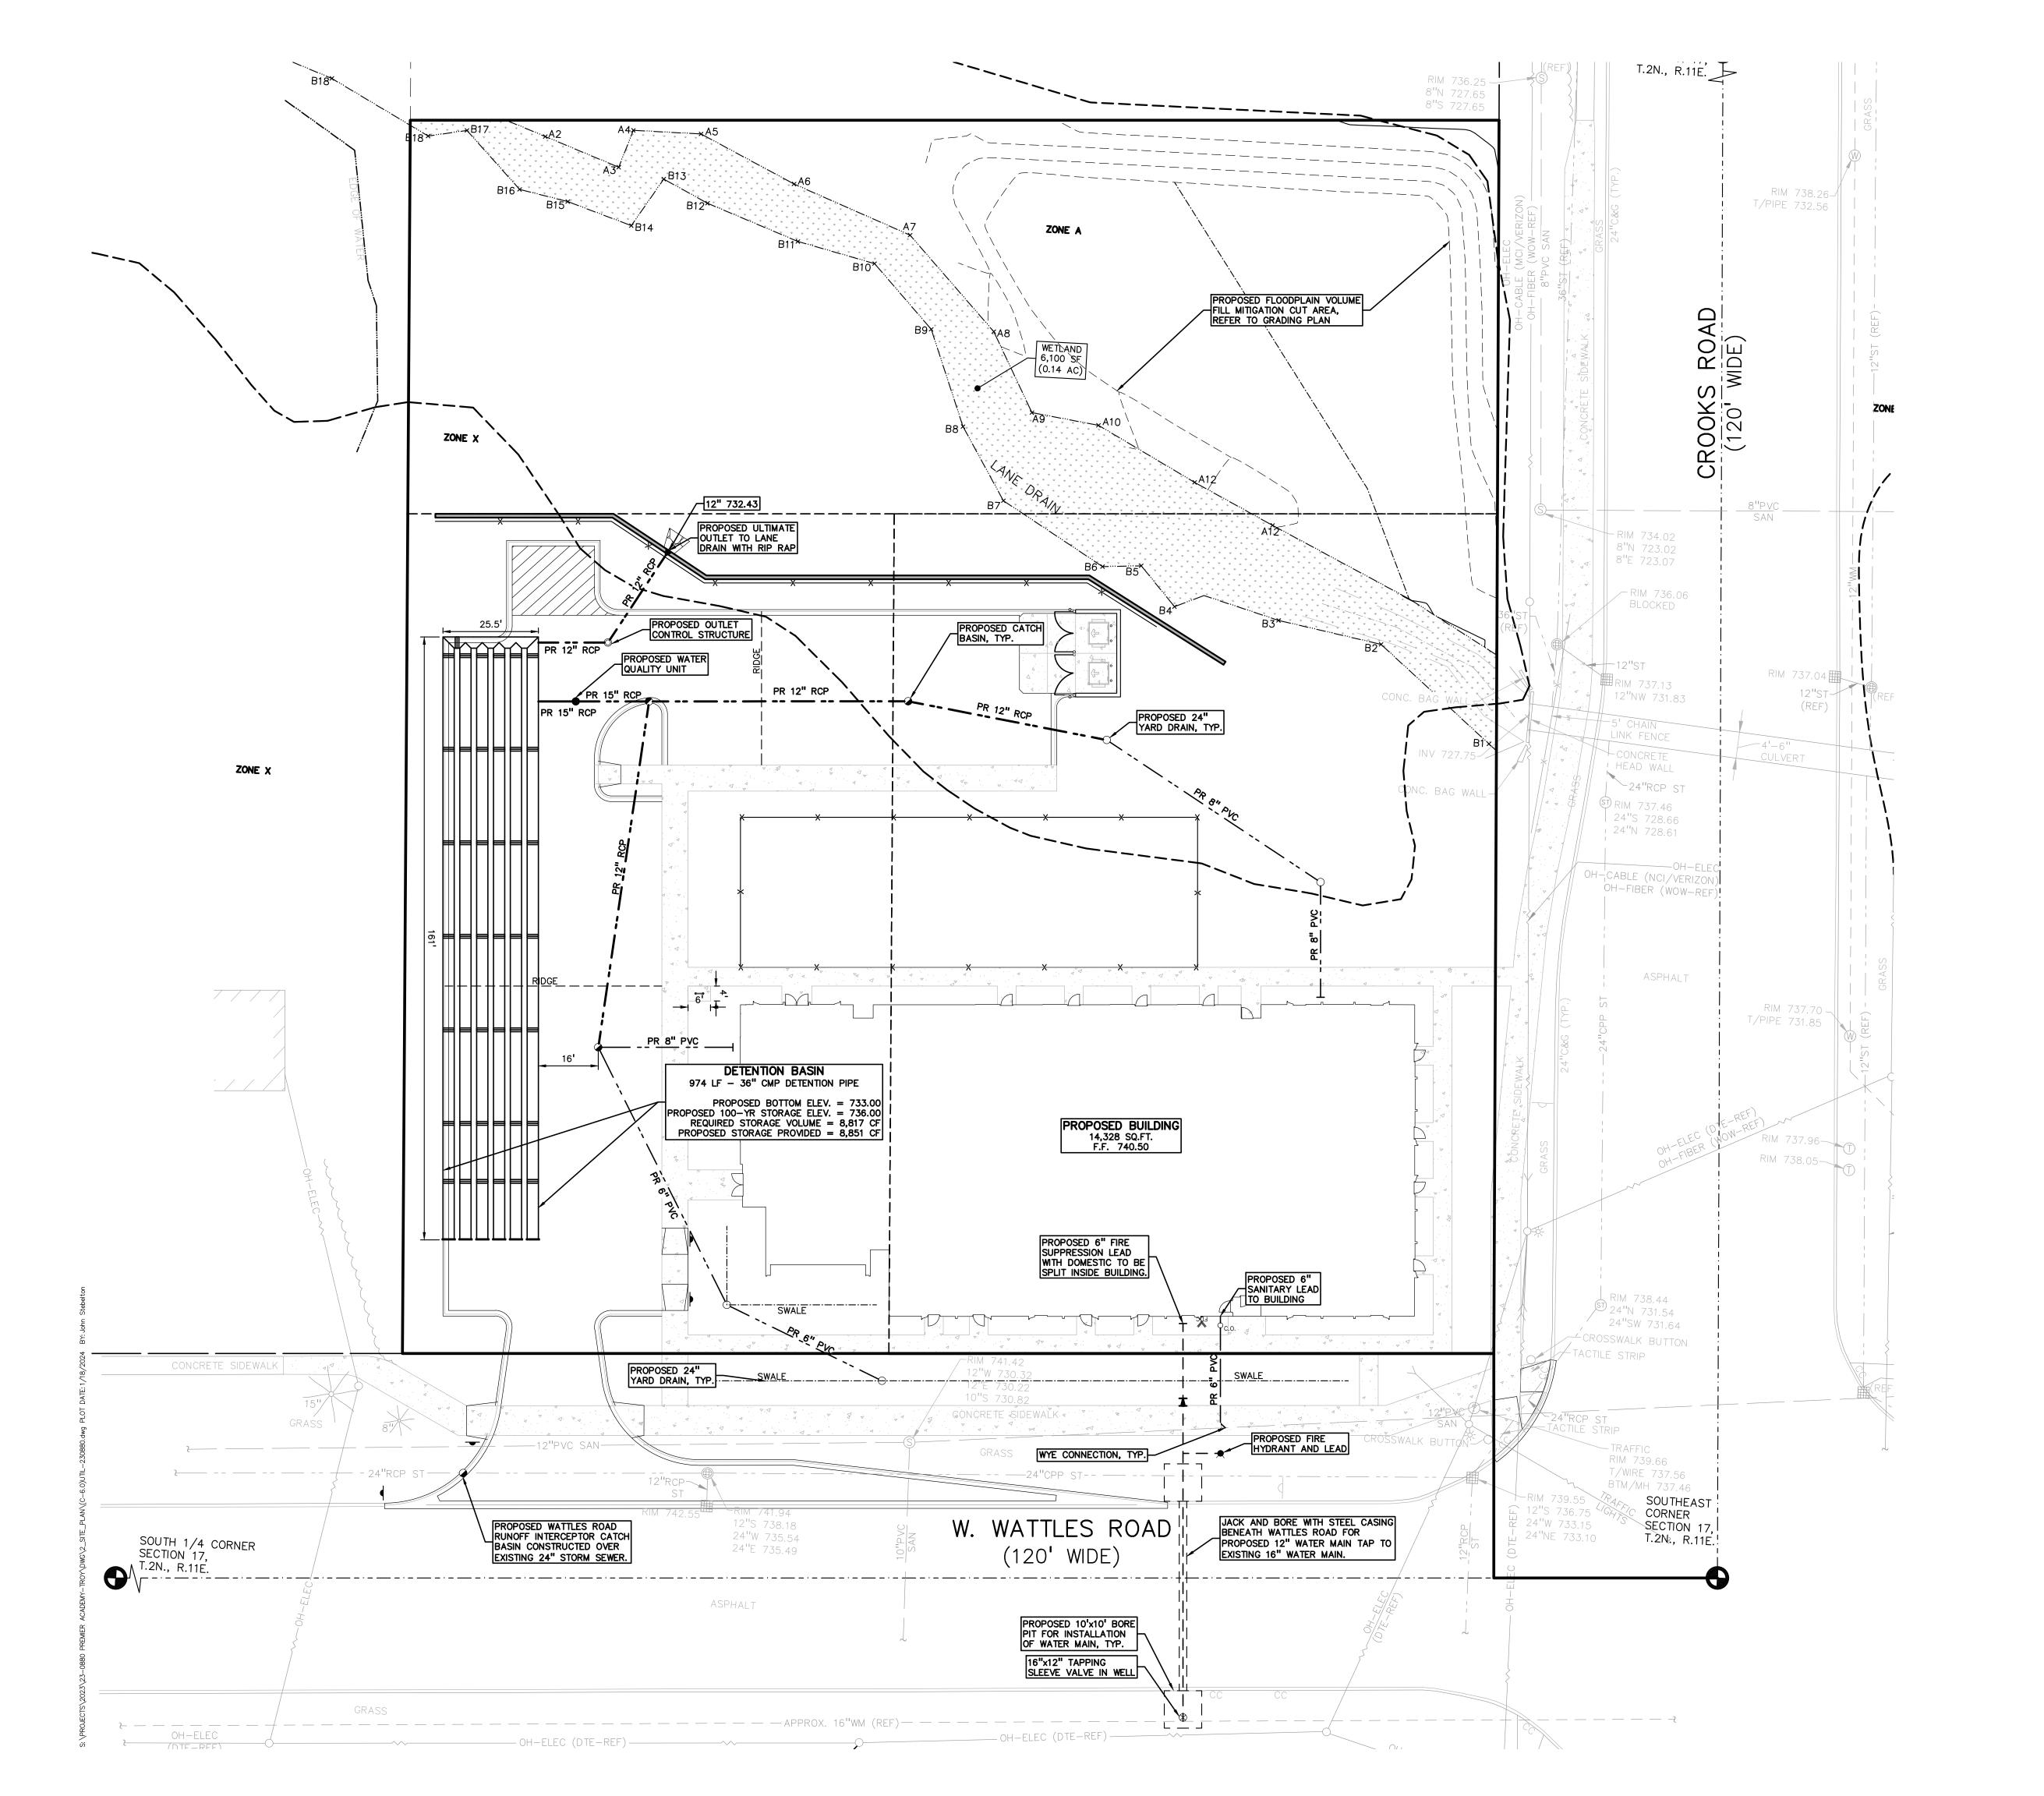

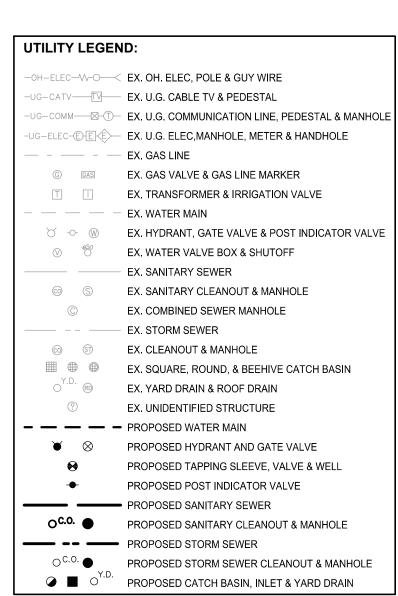

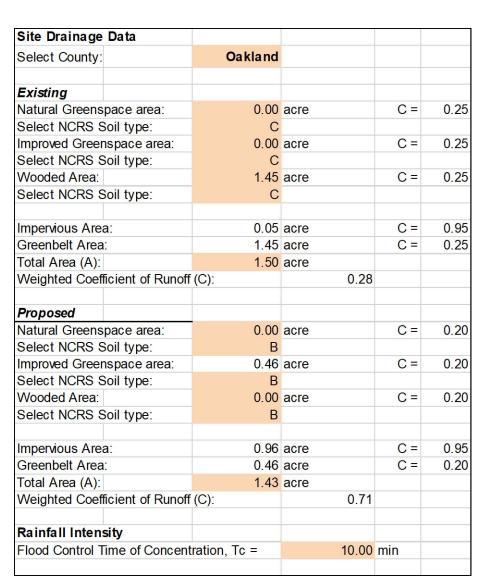

Design Requirements

CPRC Extended Detention: V_{ED} =

CPRC Allowable Outlet Rate: Q_{VED} =

100-Year Allowable Outlet Rate: Q_{VRR} =

100-Year Storage Volume, V_{100D} =

UNDERGROUND D	ETENTION	SYSTE

6,978 cf

8,817 cf

0.04 cfs

1.43 cfs

CALCULATION DETAILS
• LOADING = HS20/HS25
• APPROX. LINEAR FOOTAGE = 974 LF
STORAGE SUMMARY
• STORAGE VOLUME REQUIRED = 8,817 CF
PIPE STORAGE VOLUME = 6,881 CF
BACKFILL STORAGE VOLUME = 1,970 CF
• TOTAL STORAGE PROVIDED = 8,851 CF

PIPE DETAILS

• DIAMETER = 36"

• CORRUGATION = 2 2/3x1/2

• GAGE = 16

• COATING = ALT2

• WALL TYPE = SOLID


• BARREL SPACING = 18"

P			\
GF	RO	U	P
t: 8	344.813.	2949	

www.peagroup.com





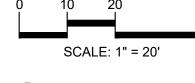



CAUTION!!

THE LOCATIONS AND ELEVATIONS OF EXISTING UNDERGROUND UTILITIES AS SHOWN ON THIS DRAWING ARE ONLY APPROXIMATE. NO GUARANTEE IS EITHER EXPRESSED OR IMPLIED AS TO THE COMPLETENESS OR ACCURACY THEREOF. THE CONTRACTOR SHALL BE EXCLUSIVELY RESPONSIBLE FOR DETERMINING THE EXACT UTILITY LOCATIONS AND ELEVATIONS PRIOR TO THE START OF CONSTRUCTION.

CLIENT

JS CAPITOL
GROUP

155 ROMEO ROAD, SUITE 300
ROCHESTER, MICHIGAN 48307

PROJECT TITLE

PREMIER
ACADEMY
NORTHWEST CORNER CROOKS RO
& WATTLES ROAD
CITY OF TROY, OAKLAND COUNTY, MICHIGAN


REVISIONS
CITY COMMENTS 1/19/2

ORIGINAL ISSUE DATE: DECEMBER 08, 2023


DRAWING TITLE

PRELIMINARY UTILITY PLAN

PEA JOB NO.	23-0880
P.M.	Jŀ
DN.	JKS
DES.	JKS
DRAWING NUMBER	

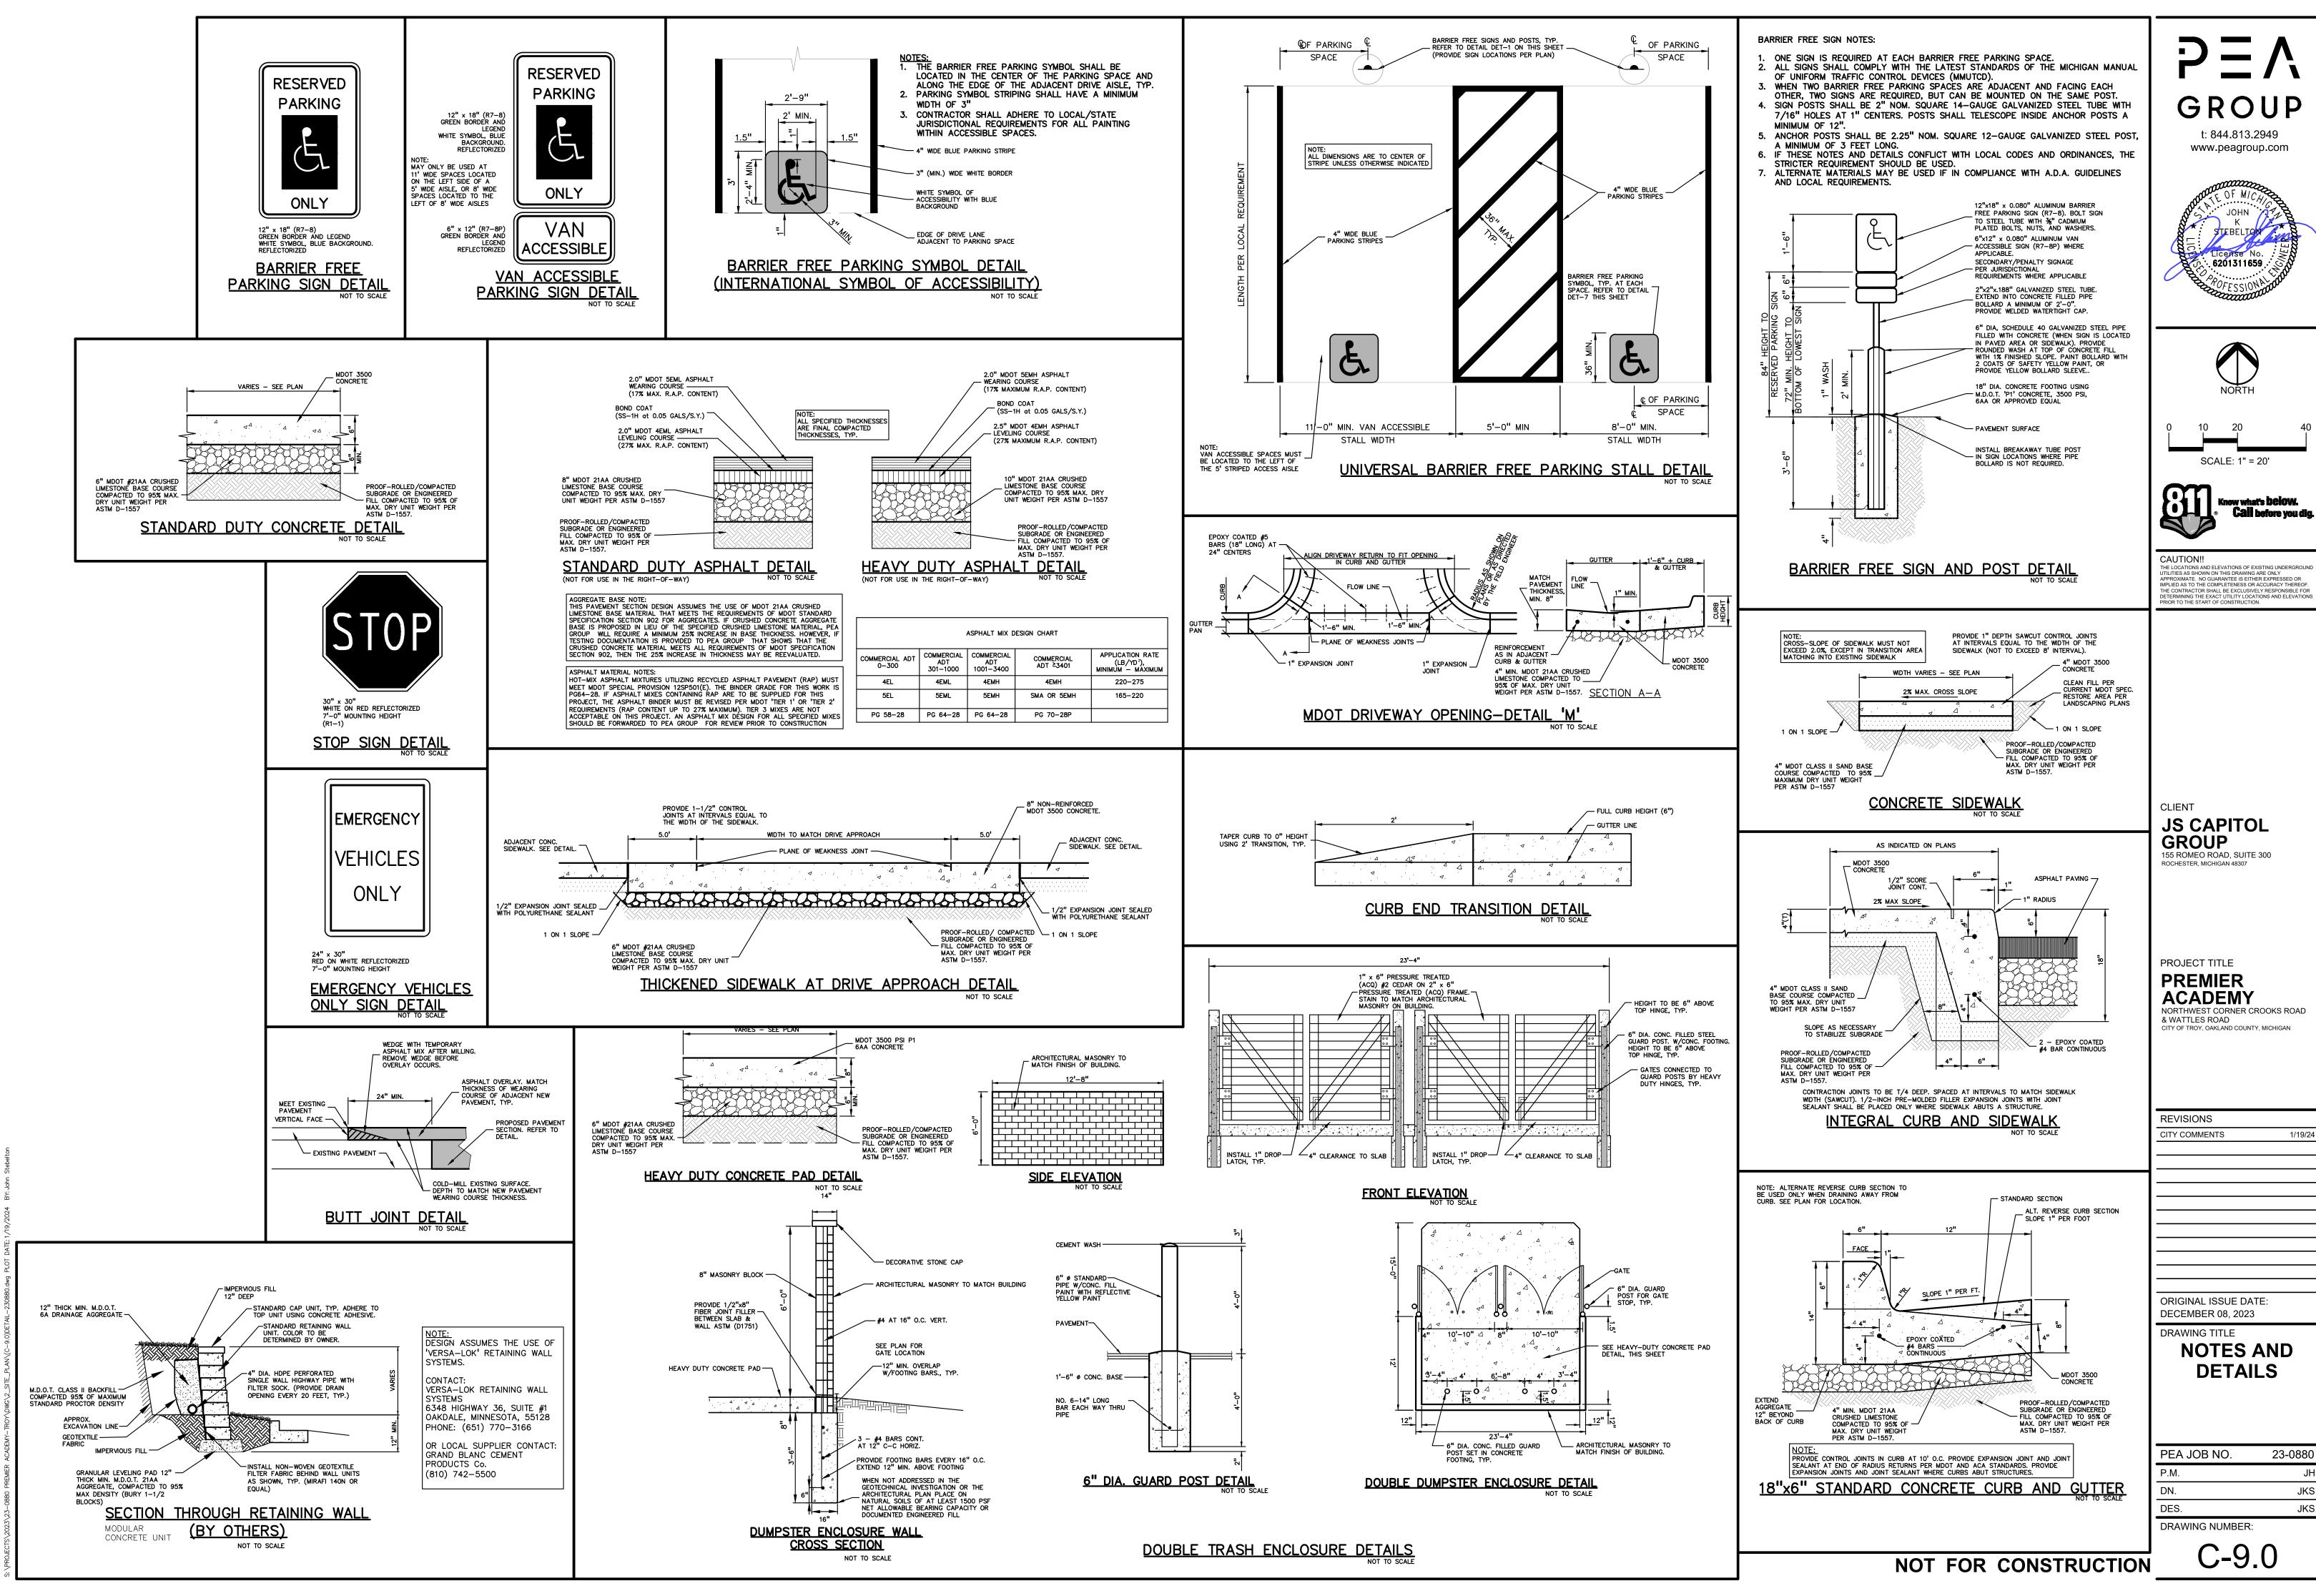




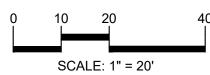



THE CONTRACTOR SHALL BE EXCLUSIVELY RESPONSIBLE FOR DETERMINING THE EXACT UTILITY LOCATIONS AND ELEVATIONS PRIOR TO THE START OF CONSTRUCTION.

JKS JKS

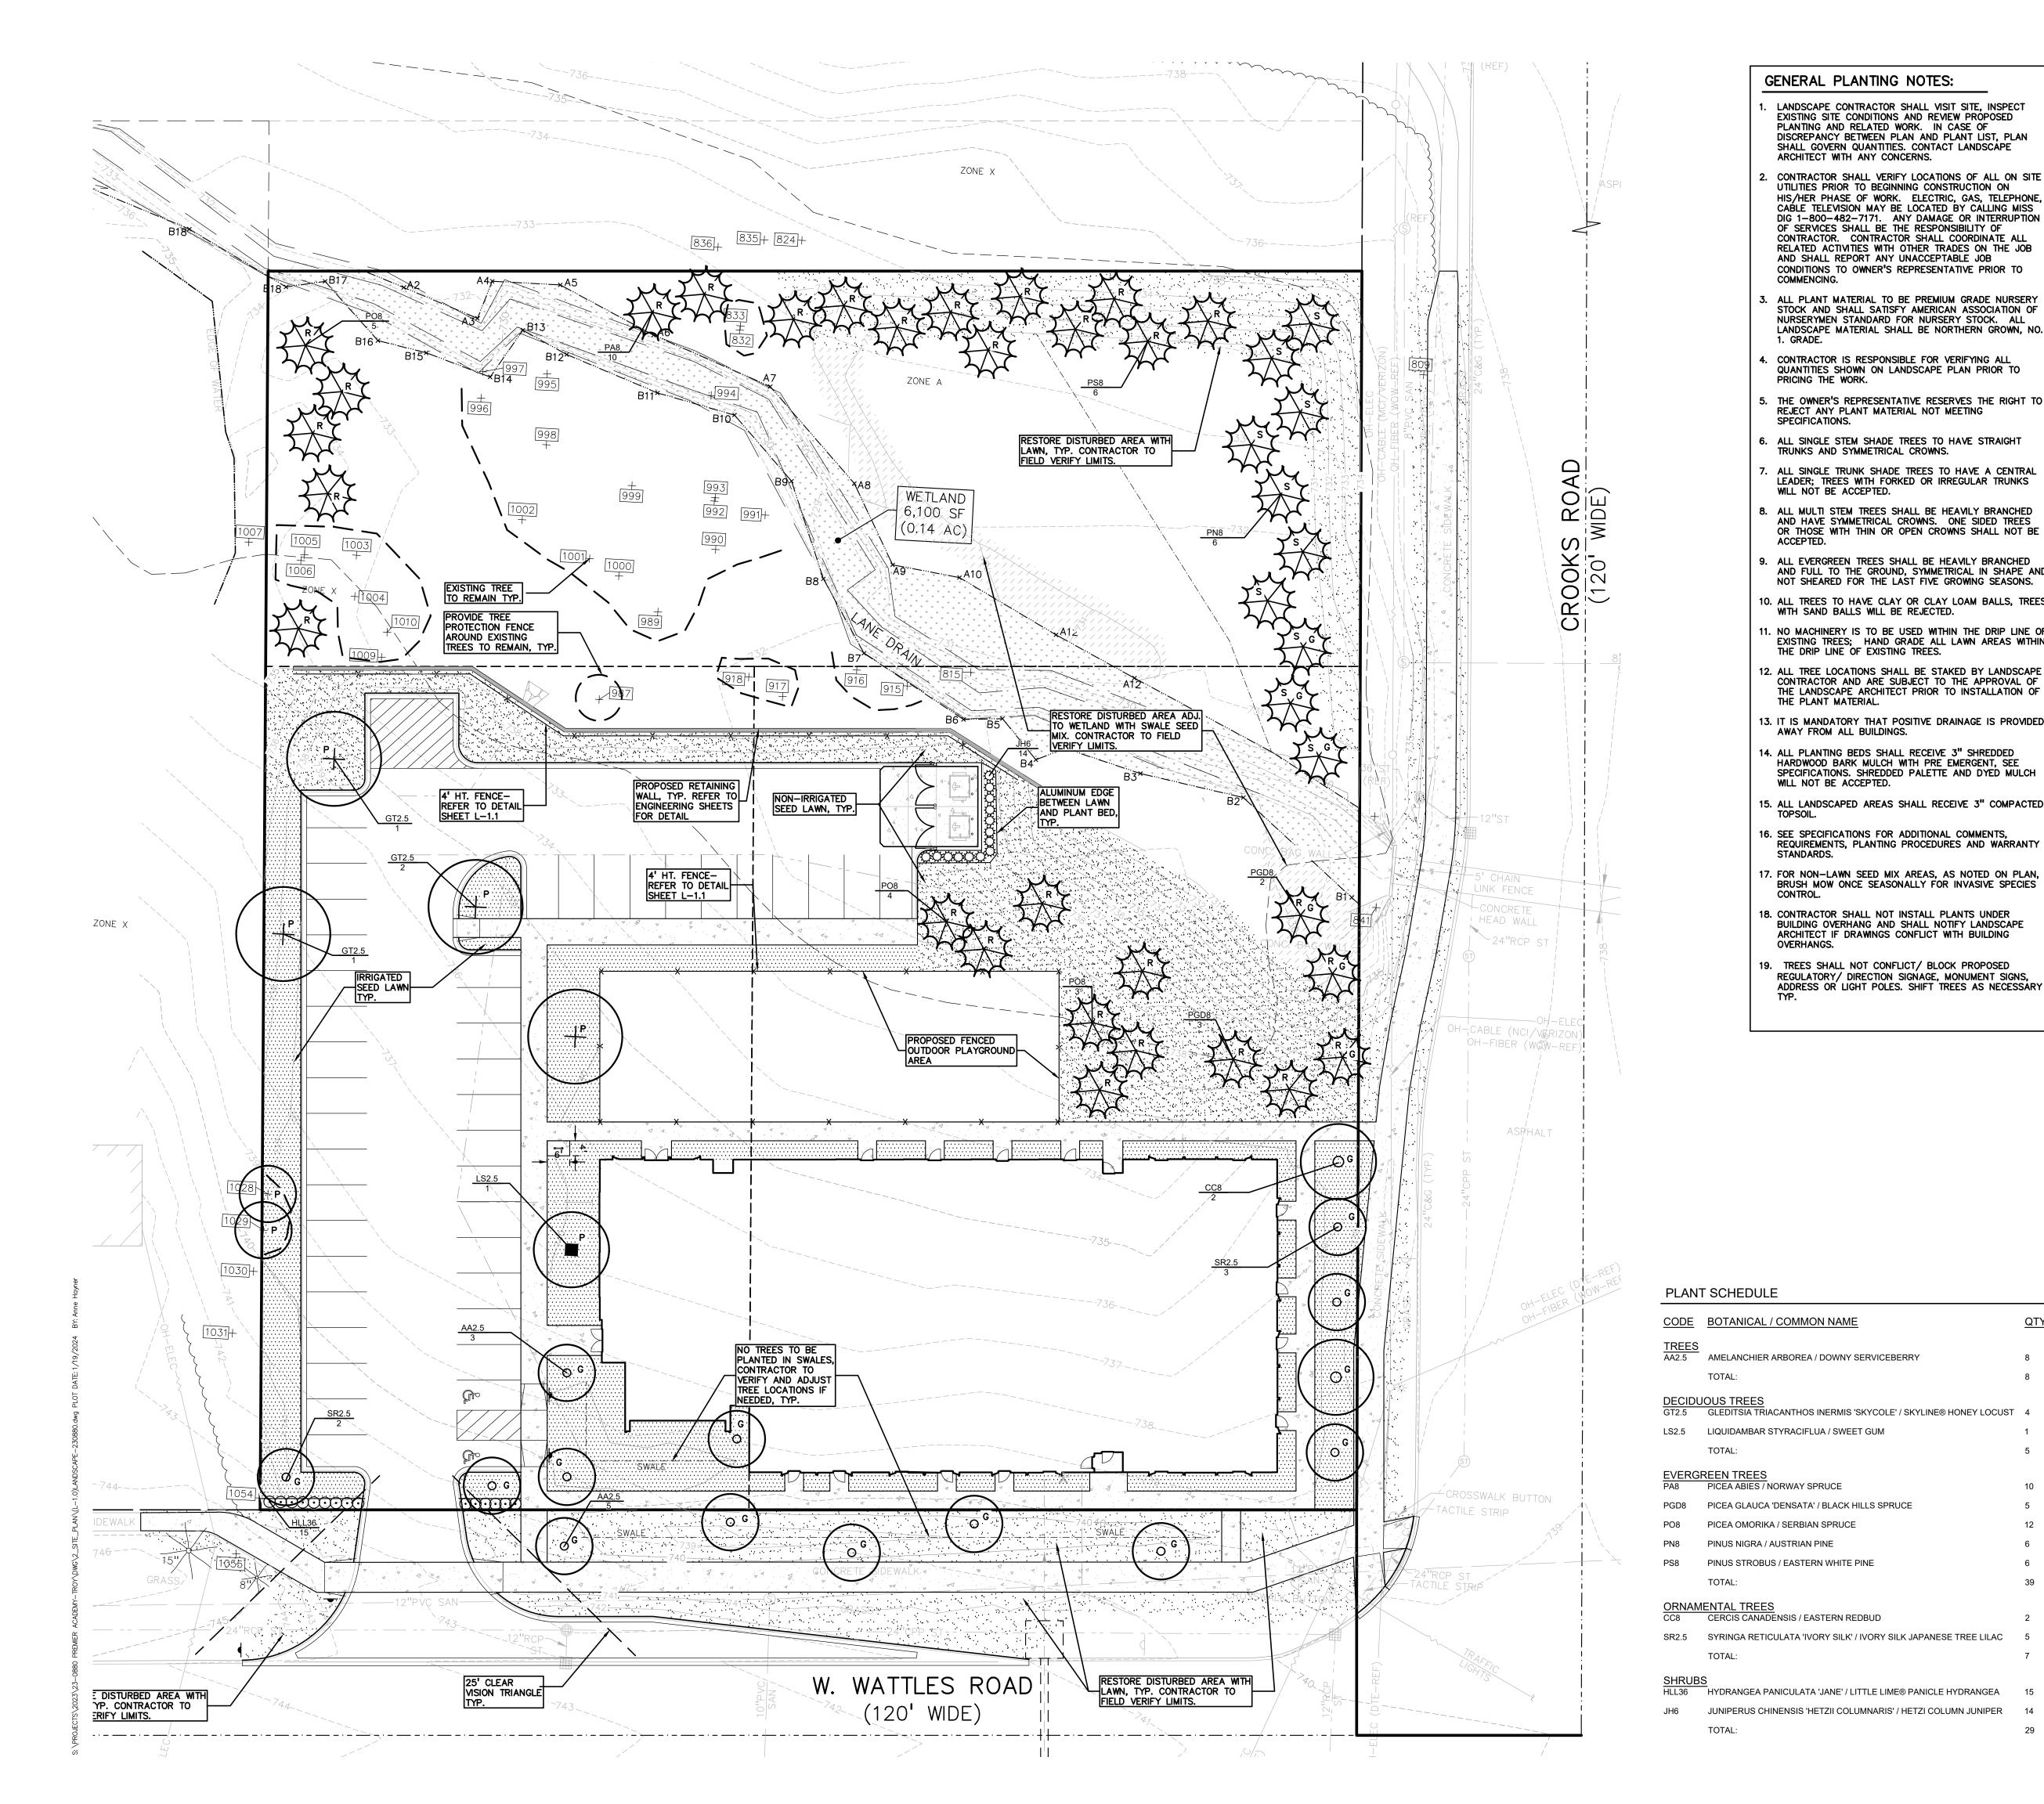


GENERAL PLANTING NOTES:

LANDSCAPE CONTRACTOR SHALL VISIT SITE, INSPECT EXISTING SITE CONDITIONS AND REVIEW PROPOSED PLANTING AND RELATED WORK. IN CASE OF DISCREPANCY BETWEEN PLAN AND PLANT LIST, PLAN SHALL GOVERN QUANTITIES. CONTACT LANDSCAPE ARCHITECT WITH ANY CONCERNS.

- . ALL SINGLE STEM SHADE TREES TO HAVE STRAIGHT TRUNKS AND SYMMETRICAL CROWNS.
- . ALL SINGLE TRUNK SHADE TREES TO HAVE A CENTRAL LEADER; TREES WITH FORKED OR IRREGULAR TRUNKS WILL NOT BE ACCEPTED.
- B. ALL MULTI STEM TREES SHALL BE HEAVILY BRANCHED AND HAVE SYMMETRICAL CROWNS. ONE SIDED TREES OR THOSE WITH THIN OR OPEN CROWNS SHALL NOT BE
- 9. ALL EVERGREEN TREES SHALL BE HEAVILY BRANCHED AND FULL TO THE GROUND, SYMMETRICAL IN SHAPE AND NOT SHEARED FOR THE LAST FIVE GROWING SEASONS.
- 10. ALL TREES TO HAVE CLAY OR CLAY LOAM BALLS, TREES WITH SAND BALLS WILL BE REJECTED. 11. NO MACHINERY IS TO BE USED WITHIN THE DRIP LINE OF EXISTING TREES; HAND GRADE ALL LAWN AREAS WITHIN THE DRIP LINE OF EXISTING TREES.
- 12. ALL TREE LOCATIONS SHALL BE STAKED BY LANDSCAPE CONTRACTOR AND ARE SUBJECT TO THE APPROVAL OF THE LANDSCAPE ARCHITECT PRIOR TO INSTALLATION OF
- 13. IT IS MANDATORY THAT POSITIVE DRAINAGE IS PROVIDED AWAY FROM ALL BUILDINGS.
- WILL NOT BE ACCEPTED.


- 18. CONTRACTOR SHALL NOT INSTALL PLANTS UNDER ARCHITECT IF DRAWINGS CONFLICT WITH BUILDING OVERHANGS.
- 19. TREES SHALL NOT CONFLICT/ BLOCK PROPOSED REGULATORY/ DIRECTION SIGNAGE, MONUMENT SIGNS, ADDRESS OR LIGHT POLES. SHIFT TREES AS NECESSARY

- - 2. CONTRACTOR SHALL VERIFY LOCATIONS OF ALL ON SITE UTILITIES PRIOR TO BEGINNING CONSTRUCTION ON HIS/HER PHASE OF WORK. ELECTRIC, GAS, TELEPHONE, CABLE TELEVISION MAY BE LOCATED BY CALLING MISS DIG 1-800-482-7171. ANY DAMAGE OR INTERRUPTION OF SERVICES SHALL BE THE RESPONSIBILITY OF CONTRACTOR. CONTRACTOR SHALL COORDINATE ALL RELATED ACTIVITIES WITH OTHER TRADES ON THE JOB AND SHALL REPORT ANY UNACCEPTABLE JOB CONDITIONS TO OWNER'S REPRESENTATIVE PRIOR TO
 - ALL PLANT MATERIAL TO BE PREMIUM GRADE NURSERY STOCK AND SHALL SATISFY AMERICAN ASSOCIATION OF NURSERYMEN STANDARD FOR NURSERY STOCK. ALL LANDSCAPE MATERIAL SHALL BE NORTHERN GROWN, NO.
 - CONTRACTOR IS RESPONSIBLE FOR VERIFYING ALL QUANTITIES SHOWN ON LANDSCAPE PLAN PRIOR TO PRICING THE WORK.
 - THE OWNER'S REPRESENTATIVE RESERVES THE RIGHT TO REJECT ANY PLANT MATERIAL NOT MEETING SPECIFICATIONS.
- 14. ALL PLANTING BEDS SHALL RECEIVE 3" SHREDDED HARDWOOD BARK MULCH WITH PRE EMERGENT, SEE SPECIFICATIONS. SEPTED PALETTE AND DYED MULCH
- 15. ALL LANDSCAPED AREAS SHALL RECEIVE 3" COMPACTED TOPSOIL.
- 16. SEE SPECIFICATIONS FOR ADDITIONAL COMMENTS, REQUIREMENTS, PLANTING PROCEDURES AND WARRANTY STANDARDS.
- 17. FOR NON-LAWN SEED MIX AREAS, AS NOTED ON PLAN, BRUSH MOW ONCE SEASONALLY FOR INVASIVE SPECIES
- BUILDING OVERHANG AND SHALL NOTIFY LANDSCAPE

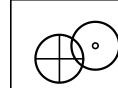

KEY:

= PROPOSED DECIDUOUS TREES

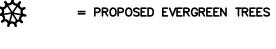




= IRRIGATED SEED LAWN



= NON- IRRIGATED SEED LAWN

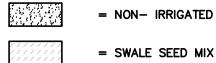

LETTER DESIGNATION FOR ORDINANCE REQUIRED MATERIAL

G = GREENBELT TREES P = PARKING LOT TREES

LANDSCAPE CALCULATIONS:
PER CITY OF TROY ZONING ORDINANCE

W. WATTLES ROAD 292 LF/30 = 10 TREESCROOKS ROAD 330 LF/30 = 11 TREES

R = REPLACEMENT TREES S = TREES SCREENING BETWEEN LAND USES



NEIGHBORHOOD NODE

PARKING LOT SCREENING

PARKING LOT LANDSCAPE

COMMENTS 1-11-24)

SITE AREA LANDSCAPE

TREE REPLACEMENT

1' HT EVG = 0.5" DBH

10, 8' HT EVERGREENS

CONTAINER SPACING

REQUIRED

PROVIDED:

PROVIDED:

QTY SIZE

8 2.5" CAL. B&B

2.5" CAL. B&B

2.5" CAL. B&B

PROVIDED: 36" HT. SHRUB HEDGE

44 PARKING SPACES/8 = 6 TREES

REQUIRED: 1 TREE / 8 PARKING SPACES

96,016 SF * 0.2 = 19,203 SF REQUIRED

312" DBH WOODLAND TREES REMOVED, 156" DBH REPLACEMENT REQUIRED

12" DBH LANDMARK TREE REMOVED 12" REPLACEMENT REQUIRED

SCREENING BETWEEN LAND USES

ALL LANDSCAPE TO BE 3' FROM BACK OF CURB

PROVIDED: 2 EXISTING TREES TO REMAIN,
5 PROPOSED DECIDUOUS TREES (1 EXTRA PER REVIEW

REQUIRED: 20% OF TOTAL SITE AREA TO BE LANDSCAPED

EXISTING LANDSCAPE AREA TO REMAIN TO NORTH OF SITE

27" DBH WOODLAND TREES PRESERVED X 2 = 54" CREDIT

156" - 54" = 102" WOODLAND TREE REPLACEMENT

102" + 12" = 114" DBH REPLACEMENT REQUIRED

29, 8' HT. EVERGREENS, EQUIVALENT TO 114" DBH

ROAD; $\frac{98}{10}$ = 10 LG EVERGREENS REQUIRED

1 LG EVG/10 LF (SCREENING ALT 2) REQUIRED BETWEEN DAYCARE AND RESIDENTIAL USES

98 LF SHARED WITH RESIDENTIAL USE ACROSS CROOKS

PROVIDED: 58,021 SF PROVIDED IN AREA INCLUDING


ABUTS PUBLIC ROAD

= EXISTING TREES TO REMAIN WITH TREE PROTECTION FENCE

REQUIRED: 1 DEC TREE/30 LF ALONG PUBLIC STREETS

W. WATTLES ROAD: 10 DEC TREES
CROOKS: 5 DEC TREES AND 6 SCREENING OR REPLACEMENT
TREES COUNTING AS GREENBELT TREES

REQUIRED: 3' LANDSCAPE PLANTINGS WHERE PARKING LOT

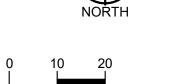


GROUP

t: 844.813.2949 www.peagroup.com

LANDSCAP

ARCHITE

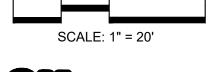



CAUTION!! UTILITIES AS SHOWN ON THIS DRAWING ARE ONLY APPROXIMATE. NO GUARANTEE IS EITHER EXPRESSED OR MPLIED AS TO THE COMPLETENESS OR ACCURACY THEREOI HE CONTRACTOR SHALL BE EXCLUSIVELY RESPONSIBLE FOR DETERMINING THE EXACT UTILITY LOCATIONS AND ELEVATIONS PRIOR TO THE START OF CONSTRUCTION.

JS CAPITOL GROUP

ROCHESTER, MICHIGAN 48307

PROJECT TITLE **PREMIER**

ACADEMY & WATTLES ROAD
CITY OF TROY, OAKLAND COUNTY, MICHIGAN

REVISIONS CITY COMMENTS

ORIGINAL ISSUE DATE:

DECEMBER 08, 2023 DRAWING TITLE **PRELIMINARY** LANDSCAPE **PLAN**

PEA JOB NO. 23-0880 DRAWING NUMBER:

NOT FOR CONSTRUCTION

NATIVE SEED MIX, BY STANTEC NATIVE PLANT NURSERY, 574-586-2412, OR EQUAL SPECIES TO BE NATIVE TO COUNTY, NO INVASIVE SPECIES ALLOWED FOR ALL SEED MIXES, PROVIDE EROSION MAT ON SLOPES AND AREAS OF WASH OUT TYP INSTALL AND PREP PER MANUFACTURES SPECIFICATIONS. Swale Seed Mix Stantec Native Plant Nursery 574-586-2412 stantec.com/native-plant-nursery Common Name **Botanical Name** Permanent Grasses/Sedges: Andropogon gerardii Big Bluestem Carex comosa Bristly Sedge Carex cristatella Crested Oval Sedge Bottlebrush Sedge Carex lurida Carex spp. Prairie Sedge Mix Brown Fox Sedge Carex vulpinoidea Elymus virginicus Virginia Wild Rye Glyceria striata Fowl Manna Grass Panicum virgatum Switch Grass Dark Green Rush Scirpus atrovirens Scirpus cyperinus Wool Grass Spartina pectinata Prairie Cord Grass Temporary Cover: Common Oat Avena sativa Lolium multiflorum Annual Rye Alisma spp. Water Plantain (Various Mix) Asclepias incarnata Swamp Milkweed Coreopsis tripteris Tall Coreopsis Spotted Joe-Pye Weed Eutrochium maculatum Blue Flag lris virginica Liatris spicata Marsh Blazing Star Lobelia cardinalis Cardinal Flower Great Blue Lobelia Lobelia siphilitica Common Water Horehound Lycopus americanus Pycnanthemum virginianum Common Mountian Mint Rudbeckia triloba Brown-Eyed Susan Sagittaria latifolia Common Arrowhead Senna hebecarpa Wild Senna Silphium terebinthinaceum Prairie Dock Symphyotrichum novae-anglia New England Aster Verbena hastata Blue Vervain Zizia aurea Golden Alexanders

- BED MEDIA - COMPACTED SUBGRADE SPECIFICATIONS FOR LANDSCAPE BED EDGING: LANDSCAPE BED EDGING SHALL BE ALUMINUM AS MANUFACTURED BY PERMALOC 1.800.356.9660 8' OR 16' SECTIONS SHALL BE USED WITH ONE STAKE PER 38" OF EDGING SHALL BE 稿" THICK X 4" DEPTH WHEN ADJ. TO MULCH AND THICK X 5 1" DEPTH WHEN ADJ. TO ROCK, FINISH: BLACK DURAFLEX MEETING AAMA 2603 STAKE SHALL SECURELY ENGAGE EDGING AND SHALL BE ENTIRELY BELOW TOP SURFACE OF EDGING EDGING SHALL HAVE A MINIMUM OF 2" OF INTERLOCKING OVERLAP BETWEEN SECTIONS

INSTALL AS PER MANUFACTURER'S SPECIFICATIONS WITH TOP OF EDGING $\frac{1}{4}$ " ABOVE COMPACTED FINISH GRADE. FINISH GRADE TO BE COMPACTED ON BOTH SIDES OF EDGING TO MAINTAIN STABILITY

PERMALOC ALUMINUM EDGING OR APPROVED

EQUAL WITH BLACK FINISH

LUMINUM EDGE DETAIL SCALE: 1/2'' = 1'-0''

-1 1/2" HORIZONTAL RAILS

−2 ½" SQ. 16 GA. POST

- 3/4" SQ. 18 GA. PICKETS

-FINISH GRADE

POURED-IN-PLACE CONCRETE FOOTING

COMPACTED SUBGRADE TO 95% MOD PROCTOR

PLANT SO THAT TOP OF ROOT BALL IS FLUSH TO GRADE OR 1-2" HIGHER IF IN POORLY DRAINED SOILS DO NOT COVER TOP OF ROOTBALL WITH SOIL FORM SAUCER WITH 4" HIGH CONTINUOUS RIM SHREDDED HARDWOOD BARK MULCH 3" _DEEP AND LEAVE 3" CIRCLE OF BARE SOIL AROUND TRUNK. DO NOT PLACE MULCH IN CONTACT WITH TRUNK - FINISH GRADE SPECIFIED PLANTING MIX. WATER AND TAMP TO REMOVE AIR POCKETS REMOVE ALL BURLAP FROM TOP 1 OF ROOTBALL. DISCARD ALL NON-BIODEGRADABLE MATERIAL OFF SITE

SHRUB PLANTING DETAIL

TREE PROTECTION WILL BE ERECTED PRIOR TO START OF CONSTRUCTION ACTIVITIES AND SHALL REMAIN IN PLACE UNTIL CONSTRUCTION IS COMPLETE NO PERSON MAY CONDUCT ANY ACTIVITY WITHIN THE DRIP LINE OF ANY TREE DESIGNATED TO REMAIN;

INCLUDING, BUT NOT LIMITED TO PLACING SOLVENTS, BUILDING MATERIAL, CONSTRUCTION EQUIPMENT OR SOIL DEPOSITS WITHIN DRIP LINES

GRADE CHANGES MAY NOT OCCUR WITHIN THE DRIP LINE OF PROTECTED TREES

DURING CONSTRUCTION, NO PERSON SHALL ATTACH ANY DEVICE OR WIRE TO ANY REMAINING TREE

ALL UTILITY SERVICE REQUESTS MUST INCLUDE NOTIFICATION TO THE INSTALLER THAT PROTECTED TREES MUST BE AVOIDED. ALL TRENCHING SHALL OCCUR OUTSIDE OF THE PROTECTIVE FENCING

TREES LOCATED ON ADJACENT PROPERTY THAT MAY BE AFFECTED BY CONSTRUCTION ACTIVITIES MUST BE

TREES TO BE PRESERVED SHALL BE IDENTIFIED WITH FLAGGING PRIOR TO THE TREE CLEARING OPERATIONS

PROVIDE FENCE AROUND CRITICAL ROOT ZONE OF

FENCE SHALL BE PLACED IN A CIRCLE WITH A MINIMUM RADIUS OF 1' PER 1" DIAMETER OF THE TREE MEASURED AT 4.5' ABOVE GROUND

4'HIGH PROTECTIVE FENCING WITH STEEL POSTS - 10' O.C. - EXISTING SOIL

TREE PROTECTION DETAIL

SCALE: 1'' = 3'-0''

STAKING/GUYING

<u>LOCATION</u>

MIN. TYP.

SCALE: 1'' = 3'-0''

EVERGREEN TREE PLANTING DETAIL

CAUTION!! THE LOCATIONS AND ELEVATIONS OF EXISTING UNDERGROUND UTILITIES AS SHOWN ON THIS DRAWING ARE ONLY APPROXIMATE. NO GUARANTEE IS EITHER EXPRESSED OR IMPLIED AS TO THE COMPLETENESS OR ACCURACY THEREOF. THE CONTRACTOR SHALL BE EXCLUSIVELY RESPONSIBLE FOR DETERMINING THE EXACT UTILITY LOCATIONS AND ELEVATIONS PRIOR TO THE START OF CONSTRUCTION.

GROUP

t: 844.813.2949

www.peagroup.com

WHIPPLE

LANDSCAPE

ARCHITECT

FIRMLY INTO SUBGRADE PRIOR TO SHREDDED HARDWOOD BARK MULCH TO DRIPLINE. 3" DEEP AND LEAVE 3" CIRCLE OF CLIENT BARE SOIL AROUND TREE TRUNK. DO NOT IS CAPITOL PLACE MULCH IN CONTACT WITH TREE TRUNK. FORM SAUCER WITH 4" HIGH **GROUP**

CONTINUOUS RIM - FINISH GRADE

BACKFILLING

SPECIFIED PLANTING MIX, WATER & TAMP TO — REMOVE AIR POCKETS, AMEND SOIL PER SITE CONDITIONS & TREE REQUIREMENTS EXPOSE ROOT FLARE OF TREE. CONTRACTOR MAY HAVE TO REMOVE EXCESS SOIL FROM -TOP OF ROOTBALL. REMOVE ALL BURLAP FROM TOP 1 OF ROOTBALL. DISCARD ALL NON-BIODEGRADABLE MATERIAL OFF SITE

PLANT SO THAT THE TREE'S ROOT FLARE (TRUNK FLARE) IS FLUSH WITH GRADE OR 1-2" HIGHER IN POORLY DRAIN SOIL.

STAKE JUST BELOW BRANCHES WITH 2"-3"

WIDE NYLON OR PLASTIC STRAPS. CONNECT

THREE 2"X2" HARDWOOD STAKES OR STEEL

T-POSTS DRIVEN A MIN. OF 18" DEEP

FROM TREE TO STAKE AND ALLOW FOR FLEXIBILITY. REMOVE AFTER (1) ONE YEAR.

(DO NOT USE WIRE & HOSE)

PLACE ROOTBALL ON UNEXCAVATED OR

PROJECT TITLE **PREMIER ACADEMY** NORTHWEST CORNER CROOKS ROAD & WATTLES ROAD CITY OF TROY, OAKLAND COUNTY, MICHIGAN

155 ROMEO ROAD, SUITE 300

ROCHESTER, MICHIGAN 48307

PLANT SO THAT THE TREE'S ROOT FLARE (TRUNK FLARE) IS FLUSH WITH GRADE OR 1-2" HIGHER IN POORLY DRAIN SOIL. SECURE TREE WRAP WITH BIODEGRADABLE MATERIAL AT TOP & BOTTOM, REMOVE AFTER FIRST WINTER DO NOT PRUNE TERMINAL LEADER PRUNE ONLY DEAD, BROKEN BRANCHES AS DIRECTED BY LANDSCAPE ARCHITECT STAKE JUST BELOW BRANCHES WITH 2"-3" WIDE NYLON OR PLASTIC STRAPS. CONNECT - FROM TREE TO STAKE AND ALLOW FOR FLEXIBILITY. REMOVE AFTER (1) ONE YEAR. (DO NOT USE WIRE & HOSE) (3) THREE 2"X2" HARDWOOD STAKES DRIVEN A MIN. OF 18" DEEP FIRMLY INTO SUBGRADE PRIOR TO BACKFILLING SHREDDED HARDWOOD BARK MULCH TO 120° -DRIPLINE. 3" DEEP AND LEAVE 3" CIRCLE OF BARE SOIL AROUND TREE TRUNK. DO NOT STAKING/GUYING PLACE MULCH IN CONTACT WITH TREE TRUNK. FORM SAUCER WITH 4" HIGH CONTINUOUS RIM CONDITIONS & TREE REQUIREMENTS EXPOSE ROOT FLARE OF TREE. CONTRACTOR MAY HAVE TO REMOVE EXCESS SOIL FROM - TOP OF ROOTBALL. REMOVE ALL BURLAP FROM TOP 1 OF ROOTBALL. DISCARD ALL NON-BIODEGRADABLE MATERIAL OFF SITE PLACE ROOTBALL ON UNEXCAVATED OR

REVISIONS CITY COMMENTS ORIGINAL ISSUE DATE: DECEMBER 08, 2023 DRAWING TITLE **LANDSCAPE DETAILS** PEA JOB NO. P.M.

VARIES ON CONTAINER OR BALL SIZE PLACE ROOTBALL ON UNEXCAVATED OR

SCALE: 1'' = 2'-0''

NOT FOR CONSTRUCTION

ORNAMENTAL FENCE DETAIL SCALE: 1'' = 2'-0''

1.) FENCE

MANUFACTURER: AMERISTAR (OR

FINISH: POWDER COAT/BLACK

2.) FENCING TO MEET STATE & LOCAL

3.) INSTALLATION PER MANUFACTURER'S

4.) SUBMIT SHOP DRAWINGS PRIOR TO

INSTALLATION FOR APPROVAL

**

PRODUCT: MONTAGE PLUS MAJESTIC

APPROVED EQUAL)

3 RAIL COMMERCIAL

RECOMMENDATION

PHONE #: 888.333.3422

LOCATION


DECIDUOUS TREE PLANTING DETAIL

SCALE: 1'' = 3'-0''

SPECIFIED PLANTING MIX, WATER & TAMP TO - REMOVE AIR POCKETS, AMEND SOIL PER SITE

23-0880

DN. AEH DES. LW DRAWING NUMBER:

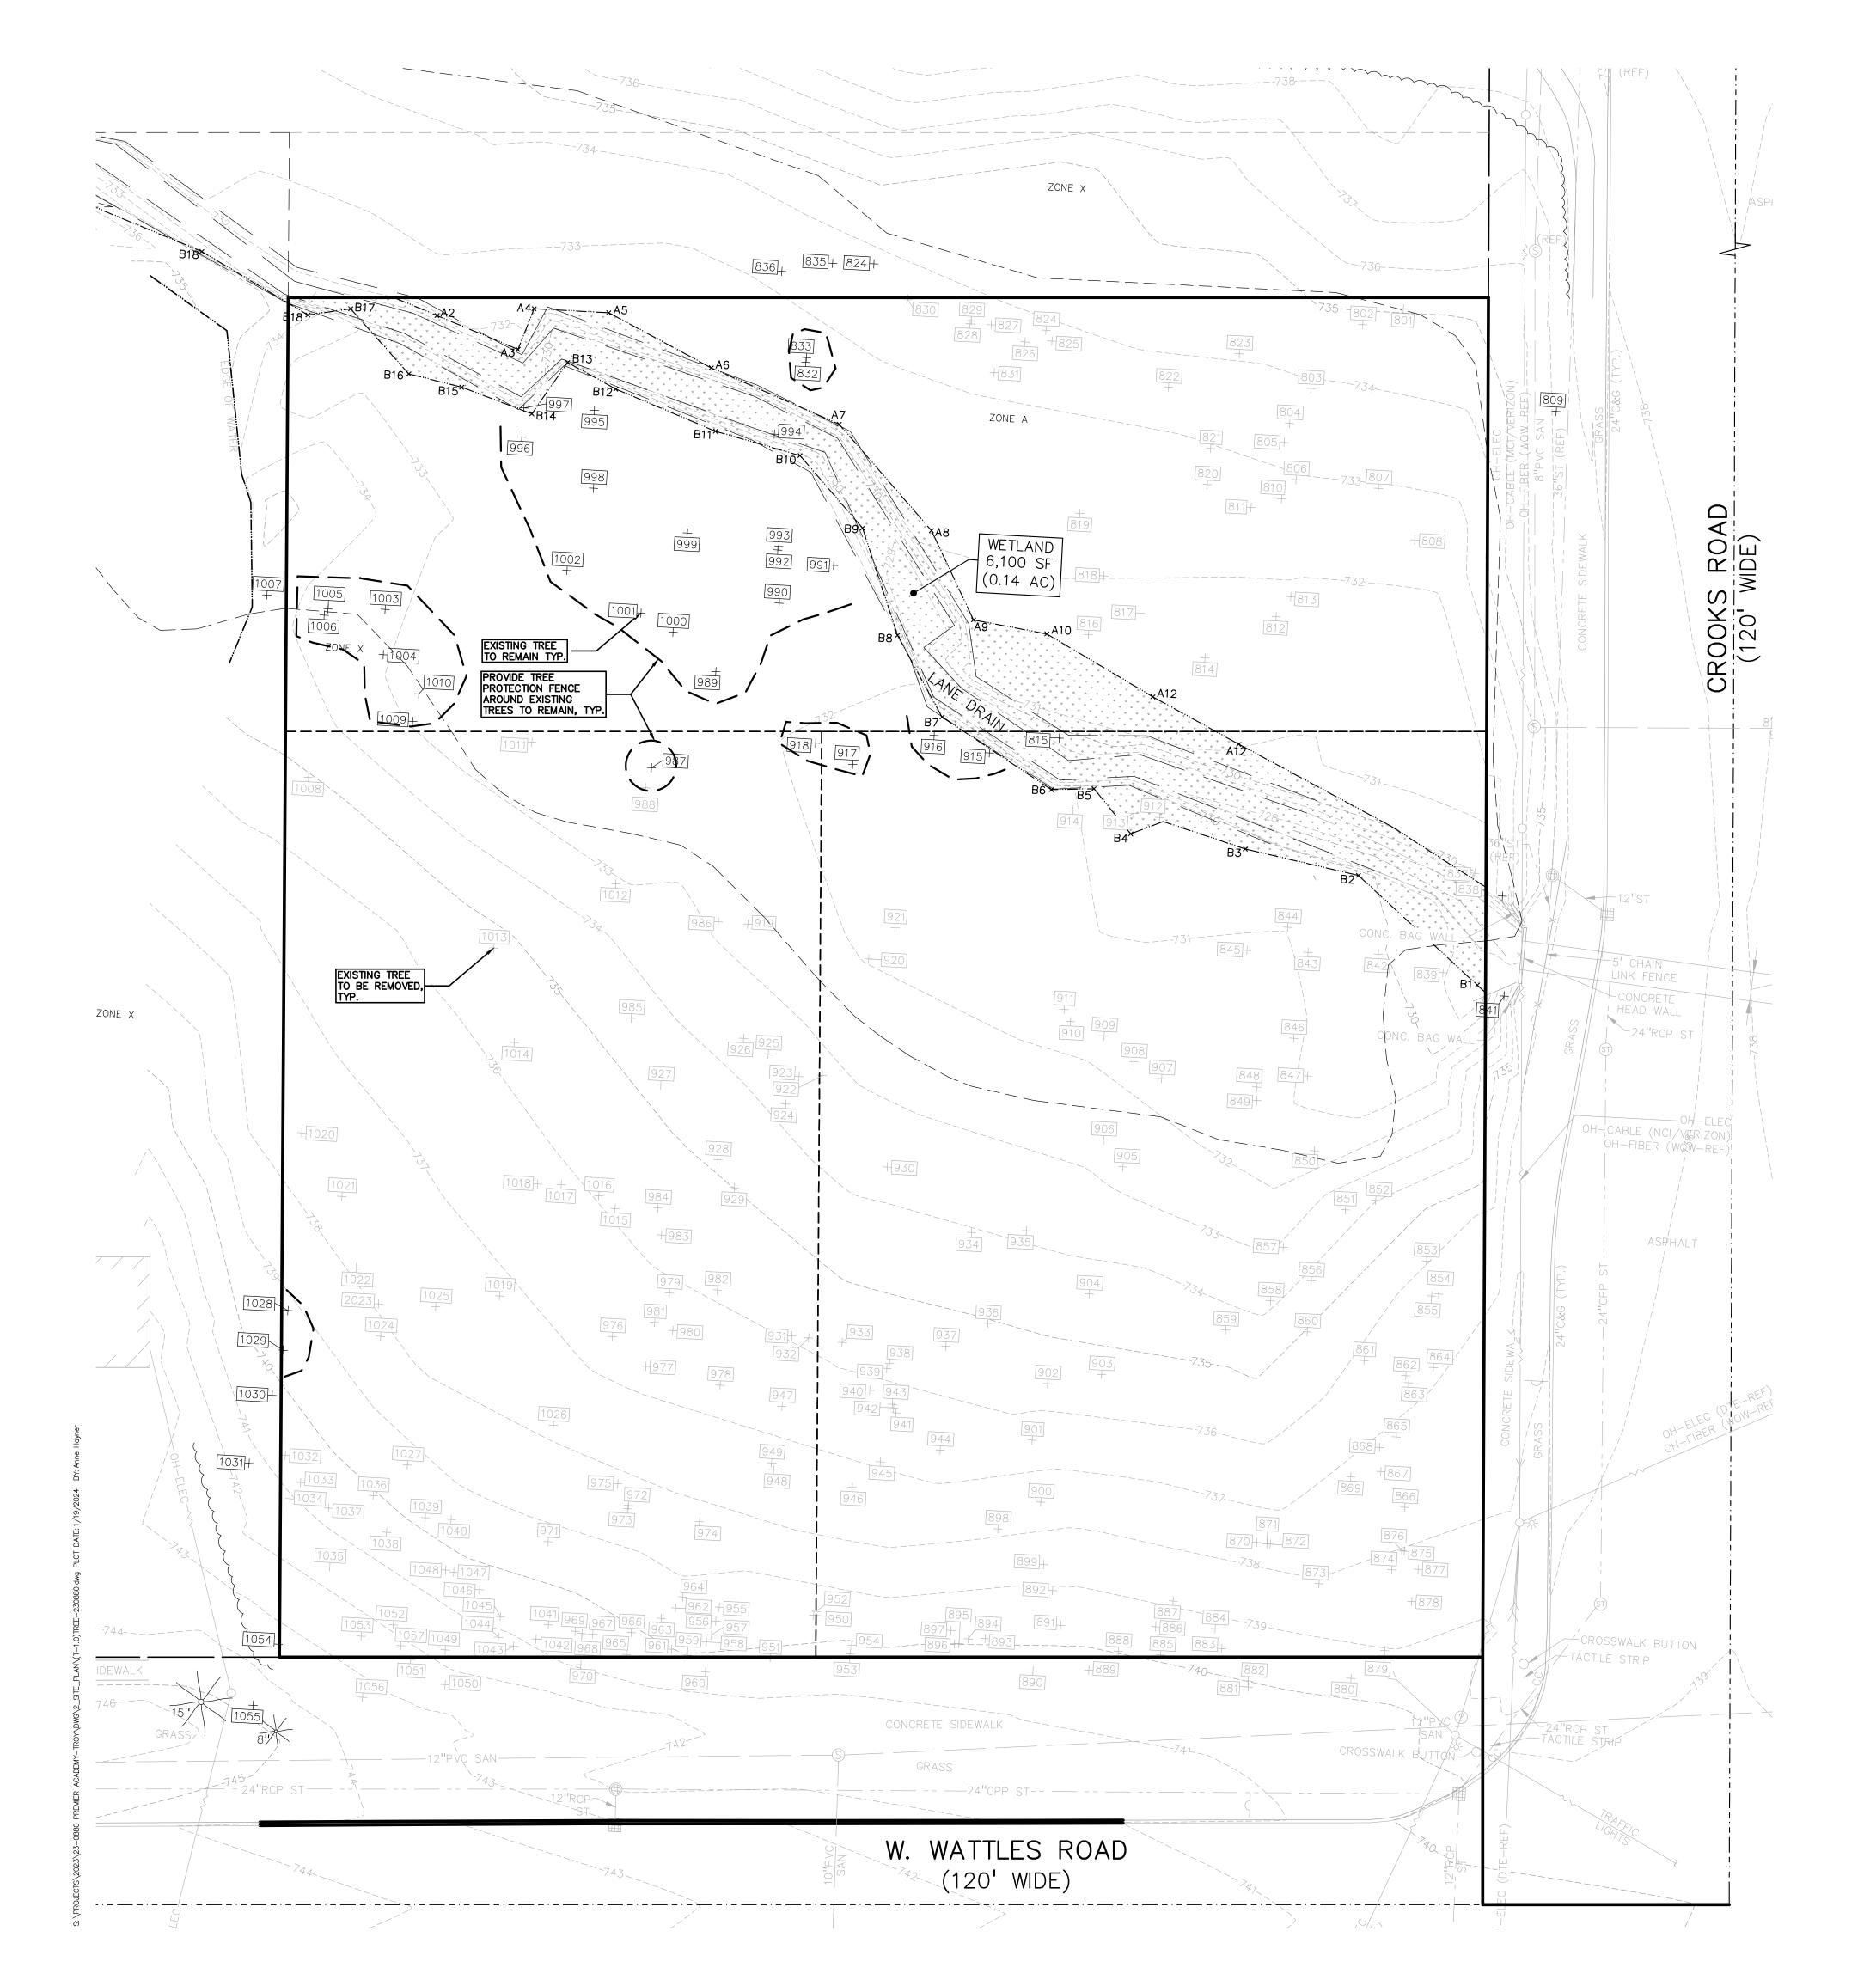



= EXISTING TREES TO REMAIN +724



= EXISTING TREES TO REMAIN WITH TREE PROTECTION FENCE

GROUP www.peagroup.com

TREE INVENTORY/PRESERVATION CALCULATIONS

WOODL	AND TR	EES REMOVED:	32	(REPLA	CE AT 50% OF F	REMOVED DBI
	312''	DBH x 0.5 =		156''	REPLACEMEN	Т
WOODL	AND TR	EES SAVED:	3	(CREDI	Γ OF 2X DBH)	
	27''	DBH x 2 =		54''	CREDIT	
		156 -	54	=	102	
102"	DBH	REQUIRED FOR V	WOODL	AND REPL	ACEMENT	
LANDM/	RK TR	FES				


LANDMARK TREES		
LANDMARK TREES REMOVED:	1	(REPLACE AT 100% OF REMOVED DBH)
12'' DBH x 1 =		12" REPLACEMENT
LANDMARK TREES SAVED:	0	(CREDIT OF 2X DBH)
" DBH x 2 =		" CREDIT
12 -	0	= 12
114" TOTAL DBH REQUIRED	FOR	REPLACEMENT


(NO REPLACEMENT REQUIRE	D FOR EX	EMPT TREE	<u>S)</u>	
SAVED EXEMPT TREES:	27	Trees		
EXEMPT TREES ON SITE:	196	Trees		
TOTAL SAVED TREES 6" AND A	ADOVE ON	OITE.	30	Trees

TOTAL TREE CREDITS 0 -----TREE CREDITS





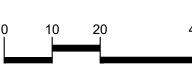

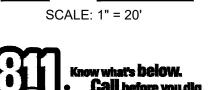

CAUTION!! THE LOCATIONS AND ELEVATIONS OF EXISTING UNDERGROUND UTILITIES AS SHOWN ON THIS DRAWING ARE ONLY APPROXIMATE. NO GUARANTEE IS EITHER EXPRESSED OR IMPLIED AS TO THE COMPLETENESS OR ACCURACY THEREOF. THE CONTRACTOR SHALL BE EXCLUSIVELY RESPONSIBLE FOR DETERMINING THE EXACT UTILITY LOCATIONS AND ELEVATIONS PRIOR TO THE START OF CONSTRUCTION.



PROJECT TITLE PREMIER
ACADEMY
NORTHWEST CORNER CROOKS ROAD
& WATTLES ROAD
CITY OF TROY, OAKLAND COUNTY, MICHIGAN

REVISIONS	
CITY COMMENTS	1/19/24
-	

DRAWING TITLE

TREE

PRESERVATION

PLAN

ORIGINAL ISSUE DATE: DECEMBER 08, 2023

_		
	PEA JOB NO.	23-0880
	P.M.	JH
	DN.	AH
	DES.	LW
•	DRAWING NUMBER:	

TAG	l	l	COMMON NAME		COND	NOTES	CLASS	SAVE / REMOVE		REPLACE
801 802	₽W E	8 40	Black Walnut American Em	Juglans nigra Ulmus americana	Dead Fair	x3	WOODLAND INVASIVE	R R	Υ Υ	-
803 804	BW BW	8 11	Black Walnut Black Walnut	Juglans nigra Juglans nigra	Fair Fair		WOODLAND WOODLAND	R R	¥ ¥	REPLACE REPLACE
805	BW	7	Black Walnut	Juglans nigra	Fair		WOODLAND	R	¥	REPLACE
806 807	€ BW	7 6	American ⊟m Black Walnut	Ulmus americana Juglans nigra	Good Fair	×2	WOODLAND	R R	¥	- REPLA CE
808	ŦĦ		Thornapple/Haw thorne	Cragaegus spp.	Fair		LANDMARK	R	¥	REPLACE
809 810	BL BW	8 6	Black Locust Black Walnut	Robinia pseudoacacia Juglans nigra	Good Fair		INVASIVE WOODLAND	S R	N ¥	- REPLACE
811	E	7	American ⊟m	Ulmus americana	Fair		INVASIVE	R	¥	-
812 813	₽N	43 40	American ⊟m Pin Cherry	Ulmus americana Prunus pennsylvanica	Dead Fair		WOODLAND	R R	¥	- REPLACE
814	BX	8	Box elder	Acer negundo	Fair		INVASIVE	R	¥	-
815 816	E BX	8 7	American ⊟m Box elder	Ulmus americana Acer negundo	Fair Fair		INVASIVE INVASIVE	S R	Y Y	-
817	PN	8 7	Pin Cherry	Prunus pennsylvanica	Fair		WOODLAND	R	¥	REPLA CE
818 819	BX BW	+ 12	Box elder Black Walnut	Acer negundo Juglans nigra	Fair Good		WOODLAND	R R	¥ ¥	- REPLACE
820 821	B₩ E	8	Black Walnut American Elm	Juglans nigra Ulmus americana	Fair Fair	x1	WOODLAND INVASIVE	R R	¥	REPLACE
822	E	6	American 🖽	Ulmus americana	Fair	X I	INVASIVE	R	¥	-
823	₽N	6	American ⊟m	Ulmus americana	Very poor		INVASIVE	R	¥	- REPLACE
824 825	PN	6	Pin Cherry Pin Cherry	Prunus pennsylvanica Prunus pennsylvanica	Fair Fair		WOODLAND WOODLAND	R R	H ¥	REPLACE
826	PN BX	7 8	Pin Cherry	Prunus pennsylvanica	Fair		WOODLAND	R	¥	REPLA CE
827 828	E	6	Box elder American Em	Acer negundo Ulmus americana	Fair Fair		INVASIVE INVASIVE	R R	¥	-
829	E	6 9	American ⊟m	Ulmus americana	Fair Fair		INVASIVE	R R	¥	-
830 831	E	9	American ⊟m American ⊟m	Ulmus americana Ulmus americana	Very poor		INVASIVE	ĸ R	¥	-
832	E	7	American ⊟m	Ulmus americana	Fair		INVASIVE	S	Y	-
833 834	E E	14 10	American ⊟m American ⊟m	Ulmus americana Ulmus americana	Fair Fair		INVASIVE INVASIVE	S S	Y	-
835	E	7	American ⊟m	Ulmus americana	Fair		INVASIVE	S	N	-
836 837	SM €	18 11	Silver Maple American 目m	A cer saccharinum Ulmus americana	Fair Fair		INVASIVE INVASIVE	S R	N ¥	-
838	BW	11	Black Walnut	Juglans nigra	Good		WOODLAND	R	А	REPLACE
839 841	PN BW	11 9	Pin Cherry Black Walnut	Prunus pennsylvanica Juglans nigra	Fair Good		WOODLAND WOODLAND	R S	Y N	REPLACE -
842	E	14	American ⊟m	Ulmus americana	Good		INVASIVE	R	¥	-
843 844	E CT	9 41	American ⊟m Cottonw ood	Ulmus americana Populus deltoides	Fair Good		INVASIVE INVASIVE	R R	¥	-
845	E	7	American ⊟m	Ulmus americana	Fair		INVASIVE	R	¥	-
846 847	E	12 10	American ⊟m American ⊟m	Ulmus americana Ulmus americana	Fair Fair		INVASIVE INVASIVE	R R	Ż Ż	-
848 849	E	11 7	American ⊟m American ⊟m	Ulmus americana Ulmus americana	Fair Fair		INVASIVE INVASIVE	R R	¥	-
850	E	8	American 🖽	Ulmus americana	Fair		INVASIVE	R	¥	-
851 852	E	9	American ⊟m American ⊟m	Ulmus americana Ulmus americana	Fair Fair		INVASIVE	R R	¥	-
853	E	6	American ⊟m	Ulmus americana	Fair		INVASIVE	R	¥	-
854 855	€ SM	10 18	American ⊟m Silver Maple	Ulmus americana Acer saccharinum	Good Good		INVASIVE INVASIVE	R R	¥ ¥	-
856	E	6	American ⊟m	Ulmus americana	Good		INVASIVE	R	¥	-
857 858	E E	10 7	American ⊟m American ⊟m	Ulmus americana Ulmus americana	Good Fair		INVASIVE INVASIVE	R R	¥	-
859	E	9	American ⊟m	Ulmus americana	Fair		INVASIVE	R	¥	-
860 861	E	10 6	American ⊟m American ⊟m	Ulmus americana Ulmus americana	Fair Good		INVASIVE INVASIVE	R R	¥	-
862	E	6	American ⊟m	Ulmus americana	Fair		INVASIVE	R	¥	-
863 864	BL €	47 8	Black Locust American ⊟m	Robinia pseudoacacia Ulmus americana	Fair Good		INVASIVE INVASIVE	R R	¥	-
865	E	8	American ⊟m	Ulmus americana	Fair		INVASIVE	R	¥	-
866 867	E	7 6	American ⊟m American ⊟m	Ulmus americana Ulmus americana	Fair Fair		INVASIVE INVASIVE	R R	¥	-
868	E	8	American ⊟m	Ulmus americana	Very poor		INVASIVE	R	¥	-
869 870	₽ BL	9	American Elm Black Locust	Ulmus americana Robinia pseudoacacia	Good Fair		INVASIVE INVASIVE	R R	¥ ¥	-
871	E	7	American Em	Ulmus americana	Good		INVASIVE	R	¥	-
872 873	BL E	7 6	Black Locust American ⊟m	Robinia pseudoacacia Ulmus americana	Fair Good		INVASIVE INVASIVE	R R	¥	<u>-</u>
874 875	E	7 7	American ⊟m American ⊟m	Ulmus americana Ulmus americana	Good Fair		INVASIVE	R R	Ż Ż	-
875 876	E	7	American Em	Ulmus americana Ulmus americana	Good		INVASIVE INVASIVE	R R	¥	<u>-</u>
877 878	BL BL	8 12	Black Locust Black Locust	Robinia pseudoacacia Robinia pseudoacacia	Fair Fair		INVASIVE INVASIVE	R R	¥ ¥	-
879	BL	12	Black Locust	Robinia pseudoacacia	Fair		INVASIVE	R	¥	-
880 881	E	6	American ⊟m American ⊟m	Ulmus americana Ulmus americana	Fair Fair	x1 x1	INVASIVE INVASIVE	R R	И	-
882	Æ	6	American ⊟m	Ulmus americana	Fair	^1	INVASIVE	R	А	-
883 884	E	7 6	American ⊟m American ⊟m	Ulmus americana Ulmus americana	Good Fair		INVASIVE	R R	¥	-
885	BL	12	Black Locust	Robinia pseudoacacia	Fair		INVASIVE	R	¥	-
886 887	E	6 9	American ⊟m American ⊟m	Ulmus americana Ulmus americana	Very poor Fair		INVASIVE INVASIVE	R R	Ż Ż	-
888	E	8	American ⊟m	Ulmus americana	Fair		INVASIVE	R	¥	-
889 890	BL €	45 45	Black Locust American Em	Robinia pseudoacacia Ulmus americana	Fair Fair		INVASIVE	R R	H N	-
891	E	9	American ⊟m	Ulmus americana	Fair		INVASIVE	R	¥	-
892 893	BL BL	10 6	Black Locust Black Locust	Robinia pseudoacacia Robinia pseudoacacia	Fair Fair		INVASIVE INVASIVE	R R	¥	<u>-</u>
894	₿Ŀ	6	Black Locust	Robinia pseudoacacia	Fair		INVASIVE	R	¥	-
895 896	€ BL	9 17	American ⊟m Black Locust	Ulmus americana Robinia pseudoacacia	Fair Fair		INVASIVE INVASIVE	R R	¥	-
897	BL	13	Black Locust	Robinia pseudoacacia	Fair		INVASIVE	R	¥	
898 899	BW €	10 8	Black Walnut American 日m	Juglans nigra Ulmus americana	Good Fair		WOODLAND INVASIVE	R R	¥ ¥	REPLACE -
900	BW BW	10 g	Black Walnut	Juglans nigra	Good	× 1	WOODLAND	R	¥	REPLACE
901	BW	8	Black Walnut	Juglans nigra	Good		WOODLAND	R	¥	REPLACE

REPLACE REPLACE

TAG	CODE	DBH	COMMON NAME	LATIN NAME	COND	NOTES	CLASS	SAVE / REMOVE	ON-SITE	REPLACE
902	BW	10	Black Walnut	Juglans nigra	Good		WOODLAND	R	¥	REPLACE
903	BL	6	Black Locust	Robinia pseudoacacia	Fair		INVASIVE	R	¥	-
904	E	10	American ⊟m	Ulmus americana	Fair		INVASIVE	R	¥	-
905	E	7	American ⊟m	Ulmus americana	Fair		WOODLAND	R	¥	- REPLACE
906 907	BW E	10 11	Black Walnut American ⊟m	Juglans nigra Ulmus americana	Good Fair		INVASIVE	R R	¥	REPLACE -
908	₽₩	9	Black Walnut	Juglans nigra	Good		WOODLAND	R	¥	REPLA CE
909	E	8	American ⊟m	Ulmus americana	Fair		INVASIVE	R	¥	-
910	E	7	American ⊟m	Ulmus americana	Fair		INVASIVE	R	¥	-
911	E	10	American ⊟m	Ulmus americana	Fair		INVASIVE	R	¥	- DED 4.0E
912 913	BW €	10 14	Black Walnut American Em	Juglans nigra Ulmus americana	Good Fair		WOODLAND INVASIVE	R R	¥ ¥	REPLACE
914	BX	9	Box elder	Acer negundo	Fair		INVASIVE	R	¥	<u> </u>
915	SM	14	Silver Maple	Acer saccharinum	Good		INVASIVE	S	Y	-
916	BX	9	Box elder	Acer negundo	Fair		INVASIVE	S	Υ	-
917	BW	12	Black Walnut	Juglans nigra	Fair		WOODLAND	S	Υ	-
918	E	13	American ⊟m	Ulmus americana	Fair		INVASIVE	S	Y	-
919 920	– E B₩	12 7	American 目m Black Walnut	Ulmus americana Juglans nigra	Fair Fair		WOODLAND	R R	¥ ¥	
921	E	40	American 🗎m	Ulmus americana	Fair		INVASIVE	R	¥	-
922	₽W	16	Black Walnut	Juglans nigra	Good		WOODLAND	R	¥	REPLACE
923	₽₩	11	Black Walnut	Juglans nigra	Good		WOODLAND	R	¥	REPLA CE
924	₽₩	13	Black Walnut	Juglans nigra	Good		WOODLAND	R	¥	REPLACE
925 926	€ BW	6 15	American Em Black Walnut	Ulmus americana	Fair Good		WOODLAND	R R	¥ ¥	- REPLACE
927	B₩	10	A merican Em	Juglans nigra Ulmus americana	Fair		INVASIVE	R	¥	- REPLACE
928		6	American Em	Ulmus americana	Good		INVASIVE	R	¥	-
929	BL	12	Black Locust	Robinia pseudoacacia	Good		INVASIVE	R	¥	-
930	E	8	American ⊟m	Ulmus americana	Fair		INVASIVE	R	¥	-
931	E	6	American ⊟m	Ulmus americana	Fair	x 3	INVASIVE	R	¥	-
932	E	6	American ⊟m	Ulmus americana	Fair		INVASIVE	R	¥	-
933	BL	8	Black Locust	Robinia pseudoacacia	Fair Fair		INVASIVE	R	¥	-
934 935	E	10 13	American ⊟m American ⊟m	Ulmus americana Ulmus americana	Fair Good		INVASIVE INVASIVE	R R	¥ ¥	-
936	E	7	American lm	Ulmus americana	Fair		INVASIVE	R R	¥	-
937	E	6	American ⊟m	Ulmus americana	Fair		INVASIVE	R	¥	<u> </u>
938	₿L	6	Black Locust	Robinia pseudoacacia	Fair		INVASIVE	R	¥	-
939	₽L	8	Black Locust	Robinia pseudoacacia	Fair		INVASIVE	R	¥	-
940	BL	6	Black Locust	Robinia pseudoacacia	Fair		INVASIVE	R	¥	-
941 942	BL BL	6 7	Black Locust Black Locust	Robinia pseudoacacia Robinia pseudoacacia	Fair Fair		INVASIVE INVASIVE	R R	¥ ¥	-
943	BL	8	Black Locust	Robinia pseudoacacia	Fair		INVASIVE	R	¥	<u>-</u>
944	₽₩	12	Black Walnut	Juglans nigra	Good		WOODLAND	R	¥	REPLA CE
945	BL	8	Black Locust	Robinia pseudoacacia	Fair		INVASIVE	R	¥	-
946	BL	6	Black Locust	Robinia pseudoacacia	Fair		INVASIVE	R	¥	-
947	BL	7	Black Locust	Robinia pseudoacacia	Fair		INVASIVE	R	¥	-
948 949	BL BL	7 8	Black Locust	Robinia pseudoacacia Robinia pseudoacacia	Poor Fair		INVASIVE INVASIVE	R R	¥ ¥	<u>-</u>
950	E	6	American Em	Ulmus americana	Fair	x 1	INVASIVE	R	¥	_
951	₽L	10	Black Locust	Robinia pseudoacacia	Fair		INVASIVE	R	¥	-
952	E	7	American ⊟m	Ulmus americana	Good		INVASIVE	R	¥	-
953	BL	8	Black Locust	Robinia pseudoacacia	Fair		INVASIVE	R	¥	-
954	BL -	7	Black Locust	Robinia pseudoacacia	Fair		INVASIVE	R	¥	-
955 956	E BL	6 12	American 目m Black Locust	Ulmus americana Robinia pseudoacacia	Good Fair		INVASIVE INVASIVE	R R	¥ ¥	<u>-</u>
957	BL	16	Black Locust	Robinia pseudoacacia	Fair		INVASIVE	R	¥	
958	BL	9	Black Locust	Robinia pseudoacacia	Fair		INVASIVE	R	¥	-
959	₿L	15	Black Locust	Robinia pseudoacacia	Fair		INVASIVE	R	¥	-
960	₿L	14	Black Locust	Robinia pseudoacacia	Good		INVASIVE	R	И	-
961	BL	12	Black Locust	Robinia pseudoacacia	Fair		INVASIVE	R	¥	-
962 963	E BL	8 13	American Elm Black Locust	Ulmus americana Robinia pseudoacacia	Good Fair		INVASIVE INVASIVE	R R	¥ ¥	<u>-</u>
964	₽Ŀ	13	Black Locust	Robinia pseudoacacia	Good		INVASIVE	R	¥	<u>-</u>
965	BL	14	Black Locust	Robinia pseudoacacia	Fair		INVASIVE	R	¥	
966	E	9	American ⊟m	Ulmus americana	Fair		INVASIVE	R	¥	-
967	BL	13	Black Locust	Robinia pseudoacacia	Good		INVASIVE	R	¥	-
968	E	7	American ⊟m	Ulmus americana	Fair Fair		INVASIVE	R	¥	-
969 970	BL BL	13 12	Black Locust	Robinia pseudoacacia Robinia pseudoacacia	Fair Good		INVASIVE INVASIVE	R R	¥ N	-
970 971	BC	12 6	Wild Black Cherry	Prunus serotina	Good		WOODLAND	R R	¥	- REPLA CE
972	BL	14	Black Locust	Robinia pseudoacacia	Good		INVASIVE	R	¥	
973	BL	13	Black Locust	Robinia pseudoacacia	Fair		INVASIVE	R	¥	
974	E	6	American ⊟m	Ulmus americana	Good		INVASIVE	R -	¥	-
975 976	BL DI	45 o	Black Locust	Robinia pseudoacacia	Fair Fair		INVASIVE	R	¥	-
976 977	BL E	8 6	Black Locust American ⊟m	Robinia pseudoacacia Ulmus americana	Fair Fair		INVASIVE INVASIVE	R R	Υ Υ	-
978	E	6	American ⊟m	Ulmus americana	Good	x1	INVASIVE	R	¥	-
979	E	7	American ⊟m	Ulmus americana	Fair		INVASIVE	R	¥	-
980	E	6	American ⊟m	Ulmus americana	Fair		INVASIVE	R	¥	-
981	BL	8	Black Locust	Robinia pseudoacacia	Fair		INVASIVE	R	¥	-
982	BL	6	Black Locust	Robinia pseudoacacia	Good		INVASIVE	R	¥	-
983 984	BL SM	6 6	Silver Maple	Robinia pseudoacacia Acer saccharinum	Good Good		INVASIVE INVASIVE	R R	¥ ¥	-
985	SW BW	9	Black Walnut	Juglans nigra	Good		WOODLAND	R R	¥ ¥	- REPLA CE
986	E	8	American ⊟m	Ulmus americana	Fair		INVASIVE	R	¥	
987	E	6	American ⊟m	Ulmus americana	Fair		INVASIVE	S	Υ	-
988	E	9	American ⊟m	Ulmus americana	Fair		INVASIVE	R	¥	-
989	E	10	American ⊟m	Ulmus americana	Poor		INVASIVE	S	Y	-
990	BX	10 7	Box elder	Acer negundo	Fair		INVASIVE	S	Y	-
991 992	BX SM	7 12	Box elder Silver Maple	Acer negundo Acer saccharinum	Fair Good		INVASIVE INVASIVE	S S	Y	-
992	SM	12 10	Silver Maple American ⊟m	Acer saccharınum Ulmus americana	Good Fair		INVASIVE	S	Y	-
994	BX	7	Box elder	Acer negundo	Fair		INVASIVE	S	Y	-
995	BX	7	Box elder	Acer negundo	Fair		INVASIVE	S	Y	
996	E	14	American ⊟m	Ulmus americana	Fair		INVASIVE	S	Υ	-
997	E	17	American ⊟m	Ulmus americana	Fair		INVASIVE	S	Y	-
998	BX	6	Box elder	Acer negundo	Fair		INVASIVE	S	Y	-
999	E BX	15 8	American ⊟m Box elder	Ulmus americana Acer negundo	Fair Fair		INVASIVE INVASIVE	S S	Y	<u>-</u> -
₁₀₀₀		, , ,	הסע פומבו	Acci Hegundo	ıalı		1147 \QIV E		'	
1000 1001	BX	9	Box elder	Acer negundo	Fair		INVASIVE	S	Y	_

TAG	CODE	DBH	COMMON NAME	LATIN NAME	COND	NOTES	CLASS	SAVE / REMOVE	ON-SITE	REPLAC
1003	Е	12	American ⊟m	Ulmus americana	Good		INVASIVE	S	Υ	-
1004	SU	8	Sugar Maple	Acer saccharum	Poor		WOODLAND	S	Υ	=
1005	Ш	8	American⊟m	Ulmus americana	Fair		INVASIVE	s	Υ	ı
1006	Е	15	American⊟m	Ulmus americana	Good		INVASIVE	S	Υ	-
1007	СТ	32	Cottonw ood	Populus deltoides	Good		INVASIVE	S	N	-
1008	₽₩	15	Black Walnut	Juglans nigra	Fair		WOODLAND	R	¥	REPLAC
1009	Е	9	American⊟m	Ulmus americana	Fair		INVASIVE	S	Υ	-
1010	TH	8	Thornapple/Haw thorne	Cragaegus spp.	Fair		WOODLAND	S	Υ	-
1011	SM	12	Silver Maple	Acer saccharinum	Fair	x 1	INVASIVE	R	¥	-
1012	E	13	American ⊟m	Ulmus americana	Fair		INVASIVE	R	¥	-
1013	BW	13	Black Walnut	Juglans nigra	Good		WOODLAND	R	¥	REPLA C
1014	E	10	American ⊟m	Ulmus americana	Fair		INVASIVE	R	¥	_
1015	SM	8	Silver Maple	Acer saccharinum	Fair		INVASIVE	R	¥	-
1016	SM	10	Silver Maple	Acer saccharinum	Good		INVASIVE	R	¥	_
1017	E	9	A merican ⊟m	Ulmus americana	Fair		INVASIVE	R	¥	_
1018	SM	8	Silver Maple	Acer saccharinum	Fair		INVASIVE	R	¥	
1019	SM	- 19	·	Acer saccharinum	Good		INVASIVE	R	¥	-
1020	€ SW	19 20	Silver Maple American 目m	,,,,,,,,,,,,,,,,,,,,,,,,,,,,,,,,,,,,,,,	Good		INVASIVE		¥	-
1020	E	20 12	American ⊟m American ⊟m	Ulmus americana	Good		INVASIVE	R R	¥	-
				Ulmus americana					-	-
1022	CT	24	Cottonw ood	Populus deltoides	Good		INVASIVE	R	¥	-
1023	BW	7	Black Walnut	Juglans nigra	Good		WOODLAND	S	Y	-
1024	BX	9	Box elder	Acer negundo	Fair		INVASIVE	R _	¥	-
1025	SM	9	Silver Maple	Acer saccharinum	Good		INVASIVE	R	¥	-
1026	E	6	American ⊟m	Ulmus americana	Good	×2	INVASIVE	R	¥	-
1027	E	6	American ⊟m	Ulmus americana	Fair		INVASIVE	R	¥	-
1028	Е	10	American ⊟m	Ulmus americana	Fair		INVASIVE	S	Υ	-
1029	SM	8	Silver Maple	Acer saccharinum	Good		INVASIVE	S	Υ	-
1030	E	13	American ⊟m	Ulmus americana	Fair		INVASIVE	S	N	-
1031	SM	11	Silver Maple	Acer saccharinum	Fair	x1	INVASIVE	S	N	-
1032	Œ	16	Siberian ⊟m	Ulmus pumila	Fair		INVASIVE	R	¥	-
1033	E	2 8	American ⊟m	Ulmus americana	Fair		INVASIVE	R	¥	-
1034	Œ	13	Siberian ⊟m	Ulmus pumila	Fair		INVASIVE	R	¥	-
1035	BL	10	Black Locust	Robinia pseudoacacia	Fair		INVASIVE	R	¥	-
1036	BL	11	Black Locust	Robinia pseudoacacia	Fair		INVASIVE	R	¥	-
1037	BL	12	Black Locust	Robinia pseudoacacia	Fair		INVASIVE	R	¥	-
1038	BL	10	Black Locust	Robinia pseudoacacia	Fair		INVASIVE	R	¥	-
1039	BC	10	Wild Black Cherry	Prunus serotina	Fair		WOODLAND	R	¥	REPLAC
1040	BL	12	Black Locust	Robinia pseudoacacia	Fair		INVASIVE	R	¥	-
1041	BL	13	Black Locust	Robinia pseudoacacia	Fair		INVASIVE	R	¥	-
1042	BL	Ð	Black Locust	Robinia pseudoacacia	Fair		INVASIVE	R	¥	-
1043	BL	13	Black Locust	Robinia pseudoacacia	Fair		INVASIVE	R	¥	-
1044	BL	10	Black Locust	Robinia pseudoacacia	Fair		INVASIVE	R	¥	-
1045	BL	8	Black Locust	Robinia pseudoacacia	Fair		INVASIVE	R	¥	-
1046	BL	9	Black Locust	Robinia pseudoacacia	Fair		INVASIVE	R	¥	-
1047	BL	11	Black Locust	Robinia pseudoacacia	Fair		INVASIVE	R	¥	_
1048	BL	8	Black Locust	Robinia pseudoacacia	Fair		INVASIVE	R	¥	
1049	BL	14	Black Locust	Robinia pseudoacacia	Fair		INVASIVE	R	¥	
1050	BL BL	14 16	Black Locust Black Locust	•	Fair Fair		INVASIVE	R R	¥ N	
				Robinia pseudoacacia						-
1051	BL	14	Black Locust	Robinia pseudoacacia	Fair		INVASIVE	R	N V	-
1052	BL	14	Black Locust	Robinia pseudoacacia	Good		INVASIVE	R -	¥	-
1053	BX	6	Box elder	Acer negundo	Fair		INVASIVE	R -	¥	-
1054	BL	13	Black Locust	Robinia pseudoacacia	Good		INVASIVE	S	N	-
1055	DF	10	Douglas Fir	Pseudotsuga menziesii	Fair		WOODLAND	S	N	-
1056	BL	11	Black Locust	Robinia pseudoacacia	Good		INVASIVE	R	И	-
1057	₽L	16	Black Locust	Robinia pseudoacacia	Fair		INVASIVE	R	¥	-







CAUTION!!

THE LOCATIONS AND ELEVATIONS OF EXISTING UNDERGROUND UTILITIES AS SHOWN ON THIS DRAWING ARE ONLY APPROXIMATE. NO GUARANTEE IS EITHER EXPRESSED OR IMPLIED AS TO THE COMPLETENESS OR ACCURACY THEREOF. THE CONTRACTOR SHALL BE EXCLUSIVELY RESPONSIBLE FOR DETERMINING THE EXACT UTILITY LOCATIONS AND ELEVATIONS PRIOR TO THE START OF CONSTRUCTION.

JS CAPITOL GROUP
155 ROMEO ROAD, SUITE 300
ROCHESTER, MICHIGAN 48307

PROJECT TITLE PREMIER
ACADEMY
NORTHWEST CORNER CROOKS ROAD
& WATTLES ROAD
CITY OF TROY, OAKLAND COUNTY, MICHIGAN


REVISIONS	
CITY COMMENTS	1/19/24

DRAWING TITLE

TREE LIST

ORIGINAL ISSUE DATE: DECEMBER 08, 2023

PEA JOB NO.	23-0880
P.M.	JH
DN.	АН
DES.	LW
DRAWING NUMBER:	

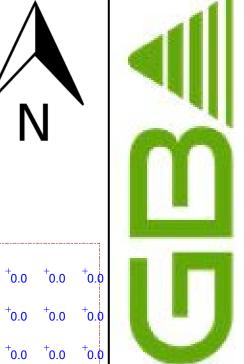




luminaire. The photometric performance results in sites with excellent uniformity, greater pole spacing and lower power density. D-Series outstanding photometry aids in reducing the number of poles required in area lighting applications with typical energy savings of 65% and expected service life of over 100,000 hours.

a high performance, high efficacy, long-life

DSX1 LED							
Series	LEDs	Color temperature?	Color Rendering Index ²	Distribution		Voltage	Mounting
DSX1 LED	Forward optics P1 P6 P2 P7 P3 P8 P4 P9 P5 Rotated optics P101 P121 P111 P131	(this section 70CRI only) 30K 3000K 40K 4000K 50K 5000K (this section 80CRI only, extended lead times apply) 27K 2700K 30K 3000K 35K 3500K 40K 4000K 50K 5000K	70CRI 70CRI 70CRI 80CRI 80CRI 80CRI 80CRI 80CRI	AFR Automotive front row T1S Type I short T2M Type II medium T3M Type II medium T3LG Type III low glare 1 T4M Type IV medium T4LG Type IV low glare 3 TFTM Forward throw medium	T5M Type V medium T5LG Type V low glare T5W Type V wide BLC3 Type II backlight control 1 BLC4 Type IV backlight control 2 LCCO Left corner cutoff 1 RCCO Right corner cutoff 3	MVOLT (120V-277V)* HVOLT (347V-480V)* XVOLT (277V - 480V)* 120 % % 208 % % 240 % 26 277 % 26 347 % 26 480 % 26	SPA Square pole mountin
Control optio	ins				Other options		Finish (required)
Shipped inst NLTAIR2 PIRH PIR PER PERS	IN nLight AIR gen. 2 of ambient sensor, 8 sensor enabled at High/low, motion, height, ambient se NEMA twist-lock separate) 14	enabled with bi-level motion / -40' mounting height, ambient 2fc. 11, 22, 22, 21 fambient sensor, 8-40' mounting insor enabled at 2fc. 12, 22, 22 receptacle only (controls ordered e only (controls ordered separate) 14, 11	FAO Field BL30 Bi-le: BL50 Bi-le: DMG 0-10 fixtur	n-pin receptacle only (controls ed separate) ^{14,25} adjustable output ^{15,21} red switched dimming, 30% ^{8,27} red switched dimming, 50% ^{8,27} or dimming wires pulled outside e (for use with an external ol, ordered separately) ¹⁷ switching ^{18,78,27}	Shipped installed SPD20KV 20KV surge protects HS Houseside shield (b L90 Left rotated optics ¹ R90 Right rotated optics ² CCE Coastal Construction HA 50°C ambient open BAA Buy America(n) Act SF Single fuse (120, 21 DF Double fuse (208, 2	lack finish standard) ¹² 11 12 11 11 11 17 17 17 17 17	DDBXD Dark Bronze DBLXD Black DNAXD Natural Aluminum DWHXD White DDBTXD Textured dark bronze DBLBXD Textured black DNATXD Textured white

One Lithonia Way • Conyers, Georgia 30012 • Phone: 1-800-705-SERV (7378) • www.lithonia.com

© 2011-2023 Acuity Brands Lighting, Inc. All rights reserved.

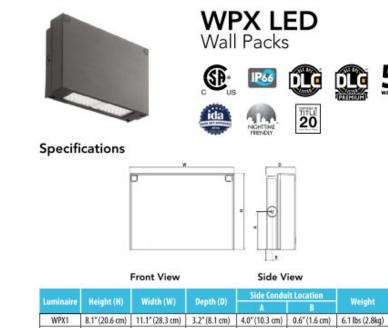

WPX2 9.1"(23.1 cm) 12.3"(31.1 cm) 4.1"(10.5 cm) 4.5"(11.5 cm) 0.7"(1.7 cm) 8.2 lbs (3.7kg) WPX3 9.5"(24.1 cm) 13.0"(33.0 cm) 5.5"(13.7 cm) 4.7"(12.0 cm) 0.7"(1.7 cm) 11.0 lbs (5.0kg)

Catalog Mumber		
Notes		
Type		

Introduction

The WPX LED wall packs are energy-efficient, costeffective, and aesthetically appealing solutions for both HID wall pack replacement and new construction opportunities. Available in three sizes, the WPX family delivers 1,550 to 9,200 lumens with a wide, uniform distribution.

The WPX full cut-off solutions fully cover the footprint of the HID glass wall packs that they replace, providing a neat installation and an upgraded appearance. Reliable IP66 construction and excellent LED lumen maintenance ensure a long service life. Photocell and emergency egress battery options make WPX ideal for every wall mounted lighting application.

Ordering	Information						EXAMPLE: WI	X2 LED	40K MVOLT DE
Series		ColorT	emperature	Voltage		Options		Finish	
WPX1 LED P2 WPX2 LED	1,550 Lumens, 11W ¹ 2,900 Lumens, 24W 6,000 Lumens, 47W 9,200 Lumens, 69W	30K 40K 50K	3000K 4000K 5000K	MVOLT 347	120V - 277V 347V ¹	(blank) E4WH E14WC	None Emergency battery backup, CEC compliant [4W, 0°C min) ² Emergency battery backup, CEC compliant [14W, -20°C min) ³ Photocell ³	DDBXD DWHXD DBLXD Note : For	Dark bronze White Black r other options, consult factory

FEATURES & SPECIFICATIONS

The WPX LED wall packs are designed to provide a cost-effective, energy-efficient solution for the one-for-one replacement of existing HID wall packs. The WPX1, WPX2 and WPX3 are ideal for replacing up to 150W, 250W, and 400W HID luminaires respectively. WPX luminaires deliver a uniform, wide distribution. WPX is rated for -40°C to 40°C.

representations of all configuration options. Specific values are available on request.

WPX feature a die-cast aluminum main body with optimal thermal management that both enhances LED efficacy and extends component life. The luminaires are IP66 rated, and sealed against moisture or environmental contaminants. ELECTRICAL

Light engine(s) configurations consist of high-efficacy LEDs and LED lumen maintenance of 190/100,000 hours. Color temperature (CCT) options of 3000K, 4000K and 5000K with minimum CRI of 70. Electronic drivers ensure system power factor >90% and THD <20%. All luminaires have 6kV surge protection (Note: WPX1 LED P1 package comes with a standard surge protection rating All photocell (PE) operate on MVOLT (120V - 277V) input Note: The standard WPX LED wall pack luminaires come with field-adjustable drive current eature. This feature allows tuning the output current of the LED drivers to adjust the lumen

on three sides allow for surface conduit wiring. A port on the back surface allows poke-through conduit wiring on surfaces that don't have an electrical junction box. Wiring can be made in the integral wiring compartment in all cases. WPX is only recommended for installations with LEDs

CSA Certified to meet U.S. and Canadian standards. Suitable for wet locations. IP66 Rated

All WPX wall packs come with 6kV surge protection standard, except WPX1 LED P1 package which comes with 2.5kV surge protection standard. Add SPD6KV option to get WPX1 LED P

with 6kV surge protection.
Sample nomenclature: WPX1 LED P1 40K MVOLT SPD6KV DDBXD

Battery pack options only available on WPX1 and WPX2.
 Battery pack options not available with 347V and PE options.

DesignLights Consortium® (DLC) qualified product. Not all versions of this product may be DLC qualified. Please check the DLC Qualified Products List at www.designlights.org/CPE, to confirm which versions are qualified. International Dark Sky Association (IDA) Fixture Seal of Approval (FSA) is available for all products on this page utilizing 3000K color temperature only.

Note: Actual performance may differ as a result of end-user environment and application All values are design or typical values, measured under laboratory conditions at 25°C. Specifications subject to change without notice.

LITHONIA LIGHTING COMMERCIAL OUTDOOR

DSX1-LED Rev. 09/05/23 Page 1 of 10

output (to dim the luminaire).

One Lithonia Way . Conyers, Georgia 30012 . Phone: 1-800-705-SERV (7378) . www.lithonia.com © 2020-2022 Acuity Brands Lighting, Inc. All rights reserved.

$^{+}0.0$ $^{+}$ $^{+}0.0$ $^{+}$ $\overbrace{}^{*}1.0$ $\overbrace{}^{*}1.0$ $\overbrace{}^{*}1.6$ $\overbrace{}^{*}2.4$ $\overbrace{}^{*}3.1$ $\overbrace{}^{*}3.5$ $\overbrace{}^{*}4.0$ $\overbrace{}^{*}4.6$ $\overbrace{}^{*}4.8$ $\overbrace{}^{*}4.8$ $\overbrace{}^{*}5.5$ $\overbrace{}^{*}5.3$ $\overbrace{}^{*}4.6$ $\overbrace{}^{*}3.6$ $\overbrace{}^{\dagger}0.4$ $\overbrace{}^{\dagger}0.1$ $\overbrace{}^{\dagger}0.1$ $\overbrace{}^{\dagger}0.1$ $\overbrace{}^{\dagger}0.0$ $\overbrace{}0.0$ $\overbrace{}0.0$ $\overbrace{}0.0$ $\overbrace{}0.0$ $\overbrace{}0.0$ $\overbrace{0$ $^{+}0.0$ $^{+}0.0$ $^{+}0.0$ $^{+}0.0$ $^{+}0.0$ $^{+}0.0$ $^{+}0.1$ $^{+}0.1$ $^{+}0.1$ $^{+}0.1$ $^{+}0.1$ $^{+}0.1$ $^{+}0.1$ $^{+}0.1$ $^{+}0.1$ $^{+}0.1$ $^{+}0.1$ $^{+}0.1$ $^{+}0.1$ $^{+}0.1$ $^{+}0.1$ $^{+}0.0$ $^{+}$ +0.0 +0.0 +0.0 +0.0 +0.0 +0.0 +0.0 +0.1 | 0.1 | 0.1 | W1 @ 15' $^{+}0.0$ $^{+}0.0$ $^{+}0.0$ $^{+}0.0$ $^{+}0.0$ $^{+}0.0$ $^{+}0.0$ $^{-}$ $| ^+ 0.0$ $| ^+ 0.0$ $| ^+ 0.0$ $| ^+ 0.0$ $| ^+ 0.0$ $| ^+ 0.0$ $| ^+ 0.0$ $| ^+ 0.0$ $| ^+ 0.0$ W1 @ 15' $^{+}0.0$ $^{+}0.0$ $^{+}0.0$ $^{+}0.0$ $^{+}0.0$ $^{+}0.0$ $^{+}0.0$ $^{+}0.0$ $^{+}0.0$ $^{*}0.0$ * $^{+}0.0$ $^{+}0.0$ $^{+}0.0$ $^{+}0.0$ $^{+}0.0$ $^{+}0.0$ $^{+}0.0$ $^{+}0.0$ $^{+}0.0$ $^{+}0.0$ $^{+}0.0$ $^{+}0.0$ $^{+}0.0$ $^{+}0.0$ $^{+}0.0$ $^{+}0.0$ $^{+}0.0$ $^{+}0.6$ $^{*}1.6$ $^{*}1.8$ $^{*}1.8$ $^{*}1.8$ $^{*}1.7$ $^{*}1.8$ $^{+}2.4$ $^{+}3.5$ $^{+}0.0$ $^{+}$ $^{+}0.0$ $^{+}0.0$ $^{+}0.0$ $^{+}0.0$ $^{+}0.0$ $^{+}0.0$ $^{+}0.0$ $^{+}0.0$ $^{+}0.0$ $^{+}0.0$ $^{+}0.0$ $^{+}0.0$ $^{+}0.0$ $^{+}0.0$ $^{+}0.0$ $^{+}0.8$ $\frac{*}{2.3}$ $\frac{*}{2.7}$ $\frac{*}{2.3}$ $\frac{*}{2.1}$ $\frac{*}{2.1}$ $\frac{1}{2.6}$ $\frac{+}{4.4}$ $^{+}0.0$ $^{+}$ † 0.0 † 0 † 0 † 0.0 $^{+}0.0$ $^{+}0.0$ $^{+}0.0$ $^{+}0.0$ $^{+}0.0$ $^{+}0.0$ $^{+}0.0$ $^{+}0.0$ $^{+}3.4$ $^{*}4.5$ $^{*}4.3$ $^{*}4.5$ $^{*}3.5$ $^{*}2.5$ $^{*}2.0$ $^{+}2.3$ $^{+}2.0$ $^{+}0.0$ $^{+}0.0$ $^{+}0.0$ $^{+}0.0$ $^{+}0.0$ $^{+}0.0$ $^{+}0.0$ $^{+}0.0$ $^{+}0.0$ $^{+}3.6$ $^{*}3.5$ $^{*}4.3$ $^{*}3.4$ $^{*}3.4$ $^{*}2.3$ $^{*}1.4$ $^{+}1.0$ $^{+}0.7$ $^{+}0.1$ $^{+}0.0$ $^{+}0.0$ $0.0^{+}0.0^{+}0.0^{-}0.0^{+}$ 0.2 +0.5 +0.6 +0.4 +0.3 +0.2 +0.2 +0.0 +0.0 +0.0 +0.0 +0.0 $^{\dagger}0.0$ † $\begin{smallmatrix} +0.0 & +0.0$ $\begin{picture}(1,0) \put(0,0) \put(0,0$ $^+$ 0.0 $^+$ 0 Plan View

General N	ote
-----------	-----

LITHONIA

COMMERCIAL OUTDOOR

LIGHTING.

1. SEE SCHEDULE FOR LUMINAIRE MOUNTING HEIGHT.

2. SEE LUMINAIRE SCHEDULE FOR LIGHT LOSS FACTOR. 3. CALCULATIONS ARE SHOWN IN FOOTCANDLES AT: 0' - 0"

THE ENGINEER AND/OR ARCHITECT MUST DETERMINE APPLICABILITY OF THE LAYOUT TO EXISTING / FUTURE FIELD CONDITIONS. THIS LIGHTING LAYOUT REPRESENTS ILLUMINATION LEVELS CALCULATED FROM LABORATORY DATA TAKEN UNDER CONTROLLED CONDITIONS IN ACCORDANCE WITH ILLUMINATING ENGINEERING SOCIETY APPROVED METHODS. ACTUAL PERFORMANCE OF ANY MANUFACTURER'S LUMINAIRE MAY VARY DUE TO VARIATION IN ELECTRICAL VOLTAGE, TOLERANCE IN LAMPS, AND OTHER VARIABLE FIELD CONDITIONS. MOUNTING HEIGHTS INDICATED ARE FROM GRADE AND/OR FLOOR UP.

EGSR External Glare Shield (reversible, field install required, matches housing finish)

BSDB Bird Spikes (field install required)

THESE LIGHTING CALCULATIONS ARE NOT A SUBSTITUTE FOR INDEPENDENT ENGINEERING ANALYSIS OF LIGHTING SYSTEM SUITABILITY AND SAFETY. THE ENGINEER AND/OR ARCHITECT IS RESPONSIBLE TO REVIEW FOR MICHIGAN ENERGY CODE AND LIGHTING QUALITY COMPLIANCE.

UNLESS EXEMPT, PROJECT MUST COMPLY WITH LIGHTING CONTROLS REQUIRMENTS DEFINED IN ASHRAE 90.1 2013. FOR SPECIFIC INFORMATION CONTACT GBA CONTROLS GROUP AT ASG@GASSERBUSH.COM OR 734-266-6705

Alternates Note

THE USE OF FIXTURE ALTERNATES MUST BE RESUBMITTED TO THE CITY FOR APPROVAL.

Drawing Note

THIS DRAWING WAS GENERATED FROM AN ELECTRONIC IMAGE FOR ESTIMATION PURPOSE ONLY. LAYOUT TO BE VERIFIED IN FIELD BY OTHERS.

Ordering Note

FOR INQUIRIES CONTACT GASSER BUSH AT QUOTES@GASSERBUSH.COM OR 734-266-6705.

Mounting Height Note

MOUNTING HEIGHT IS MEASURED FROM GRADE TO FACE OF FIXTURE. POLE HEIGHT SHOULD BE CALCULATED AS THE MOUNTING HEIGHT LESS BASE HEIGHT.

Schedule Symbol	e Label	Image	QTY	Manufacturer	Catalog	Description	Lamp	LLF	Input
	P1		2	Lithonia Lighting	DSX1 LED P8 40K 80CRI BLC3	D-Series Size 1 Area Luminaire P8 Performance Package 4000K CCT 80 CRI Type 3 Extreme Backlight Control	Output 18707	0.9	215.77
	P2		1	Lithonia Lighting	DSX1 LED P6 40K 80CRI RCCO	D-Series Size 1 Area Luminaire P6 Performance Package 4000K CCT 80 CRI Right Corner Cutoff Extreme Backlight Control	13831	0.9	165.25
	W1		5	Lithonia Lighting	WPX2 LED 40K Mvolt	WPX2 LED wallpack 6000lm 4000K color temperature 120-277 Volt	5896	0.9	47.77
	Р3		1	Lithonia Lighting	DSX1 LED P6 40K 80CRI LCCO	D-Series Size 1 Area Luminaire P6 Performance Package 4000K CCT 80 CRI Left Corner Cutoff Extreme Backlight Control	13831	0.9	165.25

Statistics						
Description	Symbol	Avg	Max	Min	Max/Min	Avg/Min
Parking & Drive Lanes	Ж	3.2 fc	5.5 fc	0.9 fc	6.1:1	3.6:1
Property Line	+	0.0 fc	0.1 fc	0.0 fc	N/A	N/A
Overall	+	0.5 fc	7.6 fc	0.0 fc	N/A	N/A

Designer Date 12/05/2023 REV. 01/15/24 Scale Not to Scale Drawing No. #23-23136 V2





A.200

Floor Plan

1/8" = 1'-0"

CHILD COUNT PER CLASSROOM (YOUNGER THAN 2.5 YEARS OLD)						
ROOM NAME	QUANTITY OF CHILDREN	QUANTITY OF TEACHERS				
INFANTS	12 CHILDREN	3 TEACHERS				
MOBILE INFANTS 1	12 CHILDREN	3 TEACHERS				
MOBILE INFANTS 2	12 CHILDREN	3 TEACHERS				
TODDLERS 1	12 CHILDREN	3 TEACHERS				
TODDLERS 2	12 CHILDREN	3 TEACHERS				
YOUNG PRESCHOOL 16 CHILDREN		2 TEACHERS				
TOTAL	76 CHILDREN < 2.5 YEARS	17 TEACHERS				
CHILD COUNT PER CLASSROOM (OLDER THAN 2.5 YEARS OLD)						
ROOM NAME	QUANTITY OF CHILDREN	QUANTITY OF TEACHERS				
MONTESSORI 1	20 CHILDREN	2 TEACHERS				
MONTESSORI 2	20 CHILDREN	2 TEACHERS				
MONTESSORI 3	20 CHILDREN	2 TEACHERS				
MONTESSORI 4	20 CHILDREN	2 TEACHERS				
PRE-K	20 CHILDREN	2 TEACHERS				
PRE-SCHOOL	20 CHILDREN	2 TEACHERS				
TOTAL	120 CHILDREN > 2.5 YEARS	12 TEACHERS				
GRAND TOTAL	196 CHILDREN	29 TEACHERS + 1 ADMIN. = 30 TOTA				

KRIEGER KLATT ARCHITECTS

2120 E. 11 Mile Rd. | Royal Oak, MI 48067 **P:** 248.414.9270 **F:** 248.414.9275 **www.kriegerklatt.com**

Client:

J.S. Capitol Group 155 Romeo Rd, Suite 300 Rochester, MI 48307

Project:

Premier Academy NW Corner of Crooks & Wattles Troy, MI 48098




Seal:



Note:

Do not scale drawings. Use calculated dimensions only. Verify existing conditions in field.

North Arrow:

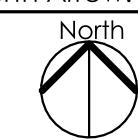

Sheet Title:

Floor Plan


Project Number:

23-101


Scale: As indicated

Sheet Number:



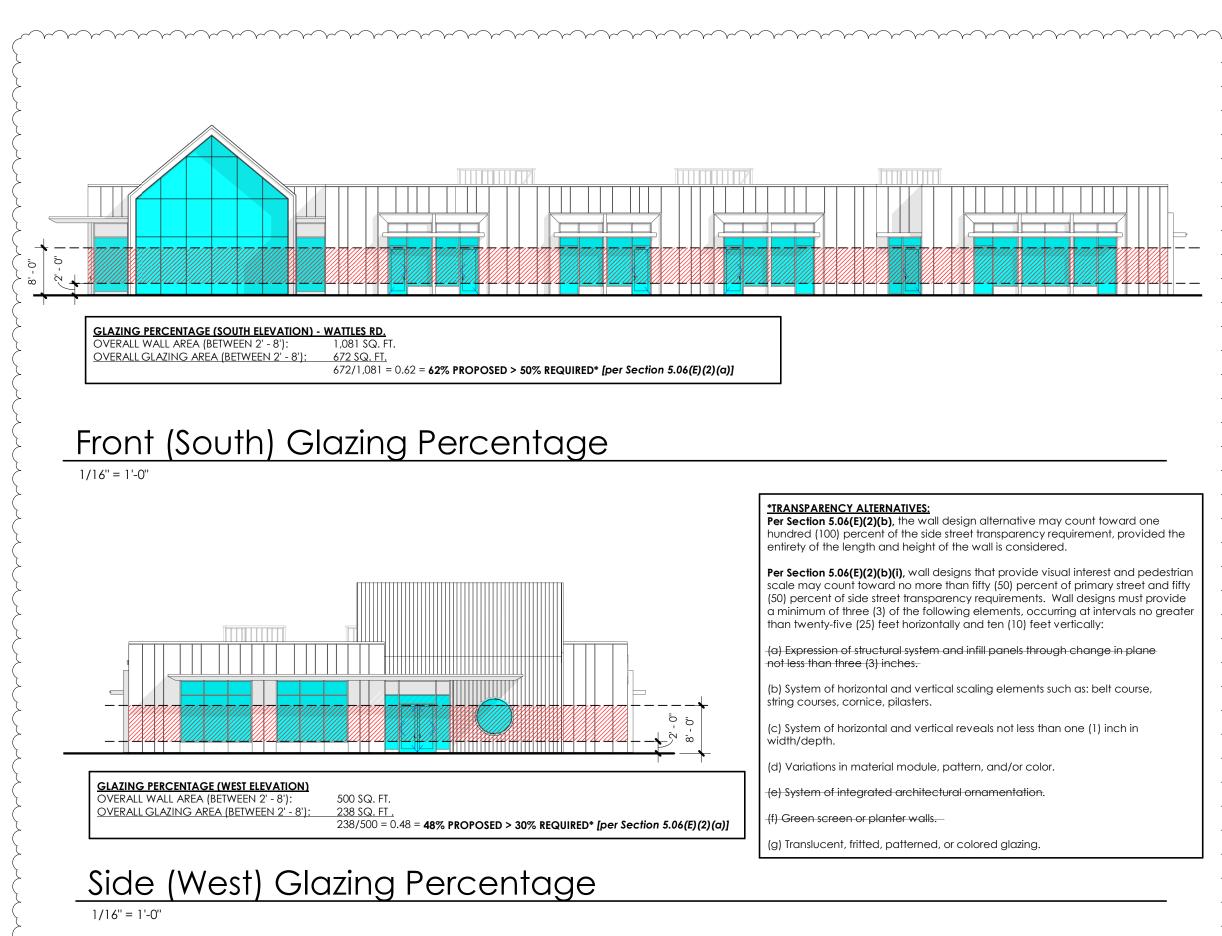



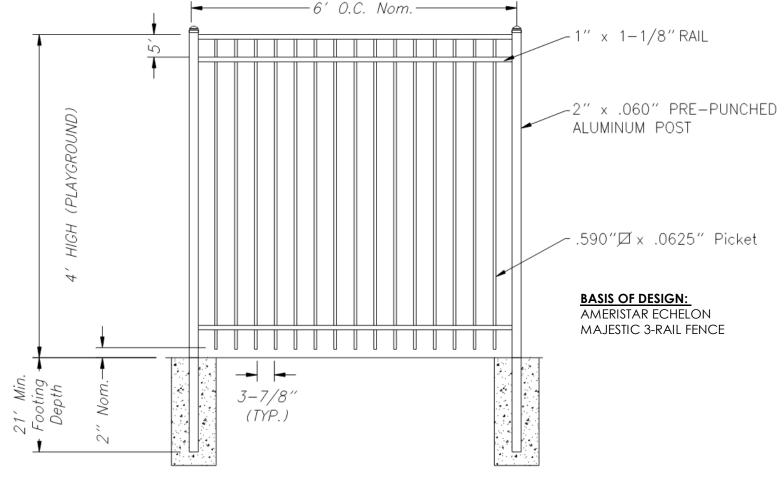

Playground Fence Detail


(REFERENCE IMAGE ONLY)



SCREENING TO COMPLY WITH THE FOLLOWING:
-ROOFTOP EQUIPMENT TO BE SCREENED WITH ARCHITECTURAL MATERIAL MATCHING OR HARMONIOUS WITH THE -SCREENS PROVIDED TO OBSCURE MECHANICAL EQUIPMENT TO BE AN OPAQUE BARRIER AT LEAST AS HIGH AS THE -ROOFTOP EQUIPMENT TO BE SITUATED SO THAT THEY DO NOT CAUSE EXCESSIVE NUISANCE OR OFFENSE TO OCCUPANTS

ROOF-MOUNTED EQUIPMENT, INCLUDING, BUT NOT LIMITED TO, GENERATORS, HEATING, VENTILATION AND AIR CONDITIONING UNITS ARE TO BE CONCEALED FROM VIEW BY OBSCURING SCREENING SO AS NOT TO BE VISIBLE FROM

EXACT ROOF TOP UNIT LOCATIONS ARE T.B.D. & WILL BE FINALIZED ONCE HVAC SYSTEM IS ENGINEERED. SCREENING LOCATIONS/QUANTITIES VISIBLE ON ELEVATIONS ARE PLACEHOLDERS **ONLY** & ARE SUBJECT TO CHANGE.

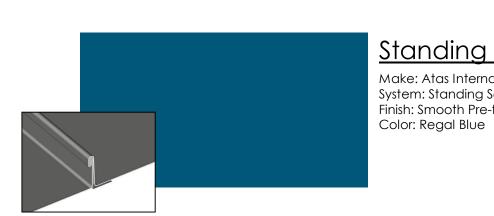

Standing Seam Metal "M-4" Make: Atas International, Inc. System: Standing Seam 1-1/2" Field Lock Finish: Smooth Pre-finish

Modular Metal Panel "M-2" Make: Atas International, Inc. Finish: Smooth Pre-finish

Modular Metal Panel "M-3" Make: Atas International, Inc. System: Omawall Finish: Smooth Pre-finish Color: Charcoal Grey

Modular Metal Panel "M-1"

Make: Atas International, Inc.


System: Omawall

Color: Bone White

System: Omawall

Color: Dove Grey

Finish: Smooth Pre-finish

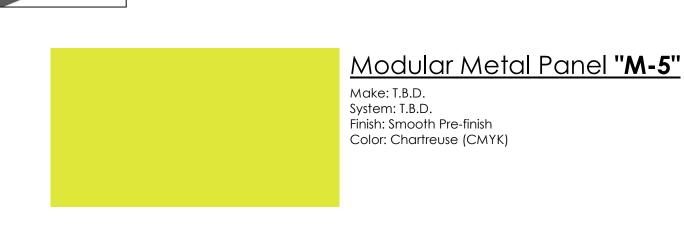

Corrugated Metal Panel "M-6" Make: Atas International, Inc. System: Grand C Finish: Smooth Pre-finish Color: Dove Grey

KRIEGER KLATT 2120 E. 11 Mile Rd. | Royal Oak, MI 48067

P: 248.414.9270 **F:** 248.414.9275 www.kriegerklatt.com


Client:

J.S. Capitol Group 155 Romeo Rd, Suite 300 Rochester, MI 48307

Project:

Premier Academy NW Corner of Crooks & Wattles Troy, MI 48098

Issued	Description	
12.08.2023	SPA	
01.19.2024	SPA Rev. 1	

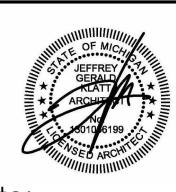

Note:

Do not scale drawings. Use calculated dimensions only. Verify existing conditions in

North Arrow:

Sheet Title:

Exterior Elevations


Project Number:


23-101

Scale:

As indicated

Sheet Number:

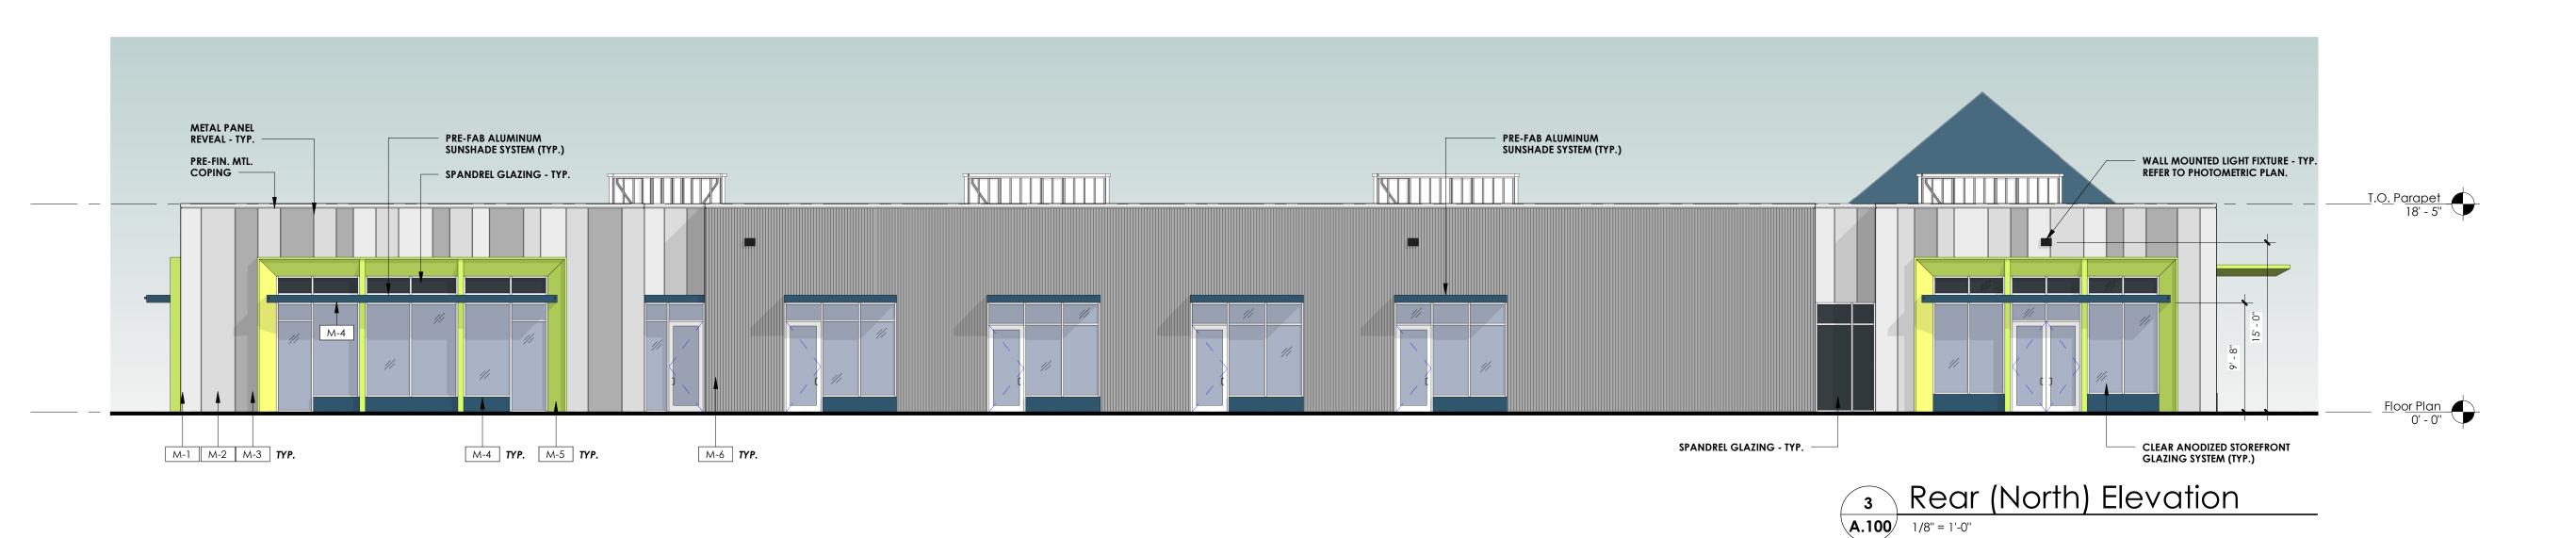


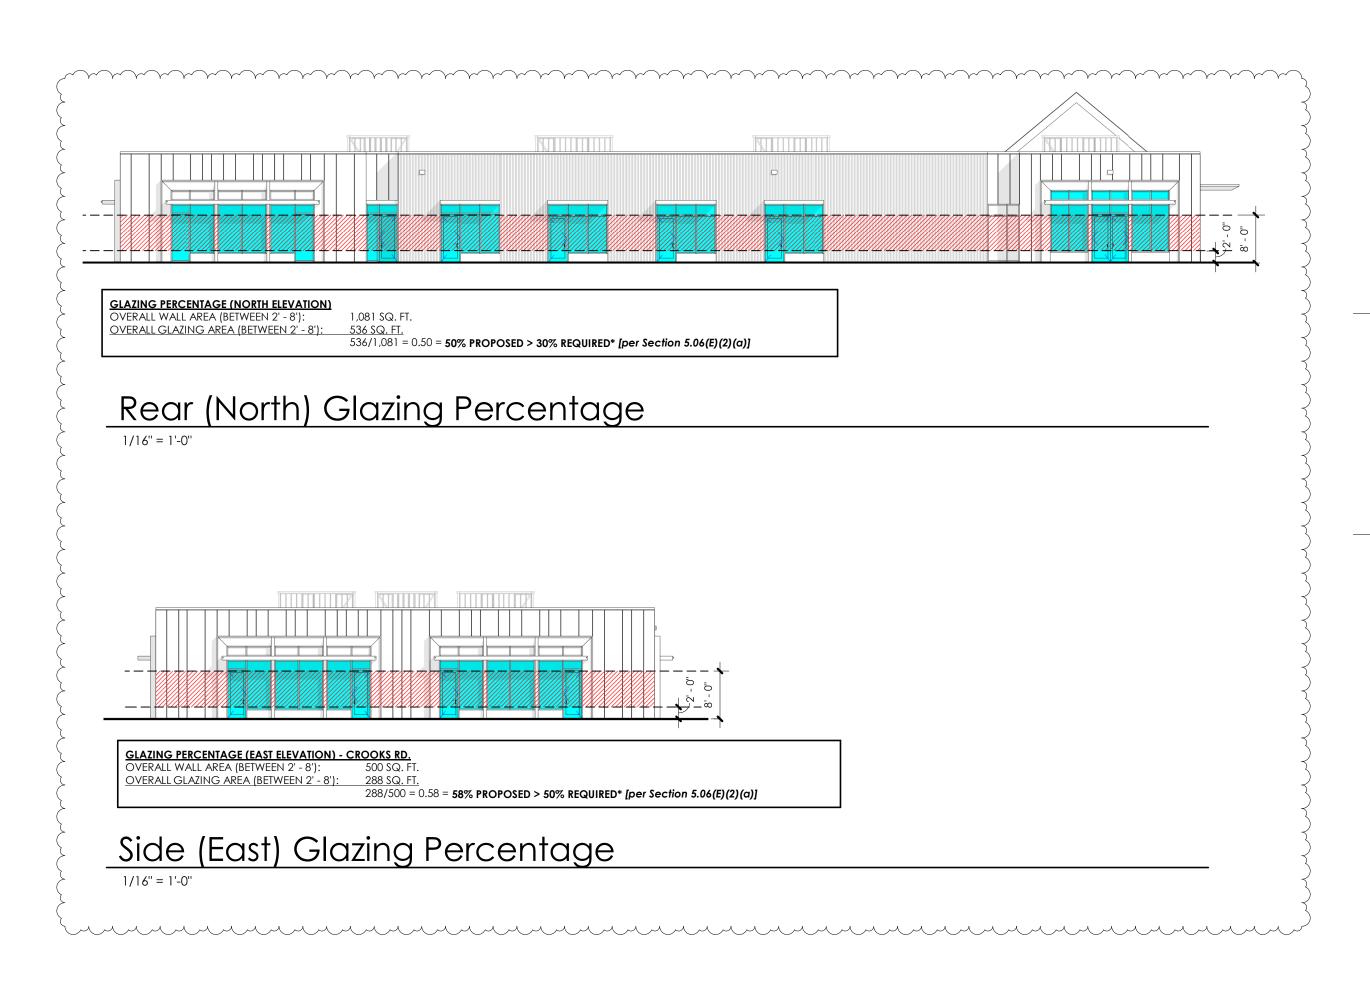








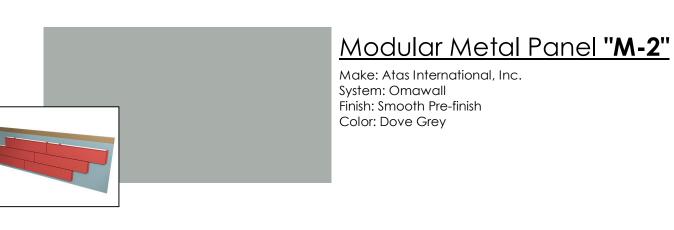

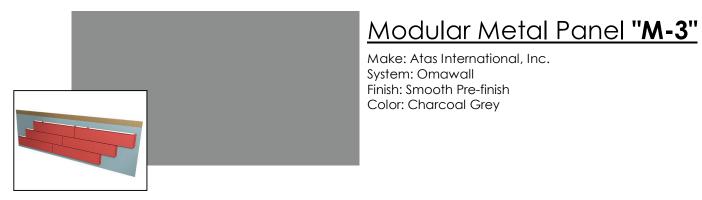



Modular Metal Panel "M-5" Make: T.B.D. System: T.B.D. Finish: Smooth Pre-finish Color: Chartreuse (CMYK)

Standing Seam Metal "M-4"

Make: Atas International, Inc.

Finish: Smooth Pre-finish

Color: Regal Blue

System: Standing Seam 1-1/2" Field Lock



Corrugated Metal Panel "M-6" Make: Atas International, Inc. System: Grand C Finish: Smooth Pre-finish

KRIEGER KLATT ARCHITECTS

2120 E. 11 Mile Rd. | Royal Oak, MI 48067 **P:** 248.414.9270 **F:** 248.414.9275 www.kriegerklatt.com

Client:

J.S. Capitol Group 155 Romeo Rd, Suite 300 Rochester, MI 48307

Project:

Premier Academy NW Corner of Crooks & Wattles Troy, MI 48098

Issued	Description	
12.08.2023	SPA	
01.19.2024	SPA Rev. 1	

seal:



Note:

Do not scale drawings. Use calculated dimensions only. Verify existing conditions in

North Arrow:

Sheet Title:

Exterior Elevations

Project Number:

23-101

Scale:

As indicated

Sheet Number:



View of front & side facade from intersection



View of side facade from Crooks Rd.

NOTE:
RENDERINGS ARE FOR GRAPHIC ILLUSTRATION PURPOSES ONLY.
REFER TO DRAWINGS FOR PROPOSED DESIGN ELEMENTS.



View of front facade from Wattles Rd.



View of main entrance approach from Wattles



View of playground area

KRIEGER KLATT ARCHITECTS

2120 E. 11 Mile Rd. | Royal Oak, MI 48067 P: 248.414.9270 F: 248.414.9275 www.kriegerklatt.com

Client:


J.S. Capitol Group 155 Romeo Rd, Suite 300 Rochester, MI 48307

Project:

Premier Academy
NW Corner of Crooks & Wattles
Troy, MI 48098

Issued	Description	В
12.08.2023	SPA	
	1	1

Seal:

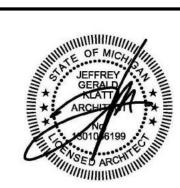

Note:

Do not scale drawings. Use calculated dimensions only. Verify existing conditions in field.

North Arrow:

Sheet Title:

Renderings

Project Number:

23-101

Scale:

Sheet Number:

A.300

01.19.2024



Parking Summary:

Our childcare facility has meticulously assessed the parking needs to ensure efficiency and sustainability. The allocation of 44 parking spaces is a carefully calculated decision aimed at optimizing the available space while avoiding unnecessary excess. This number strikes a balance that accommodates the expected number of staff and parents dropping off or picking up their children. Having fewer parking spaces would lead to congestion and inconvenience for parents, potentially affecting the smooth functioning of the childcare center. The allocation of 44 parking spaces reflects an adequate amount to allow for staff to park for the duration of their shift, lunch breakers to park for their mid-shift and to allow for enough spots for parents to have a smooth and safe pick up and drop off for their children. We are adamant in ensuring that our facility is both practical and considerate of the community of Troy.


Please refer to the following pages for supporting traffic data & existing Premier Academy parking lot sizes for reference.

<u>Drop-off / Pick-up Procedure:</u>

The operating hours at Premier Academy are 6:30am-6:30pm. Drop off takes place between 6:30am-9:30am. Pick-up times are scheduled between 3:00pm-6:30pm which helps avoid any congestion and additional traffic to the surrounding roads at any one given time. Our staggered pickup and drop off allow for a smooth and even flow of visitors throughout the day.

The designated drop-off area would be along the front of the facility with select parking spaces marked as reserved. This is where parents can safely pull in and load/unload their students. Due to the staggered nature of drop off and pick up, these reserved parking spaces would never be at capacity all at once.

This pickup and drop off procedure for Premier Academy - Troy would ensure the safety of our school community and additionally those driving by the facility.

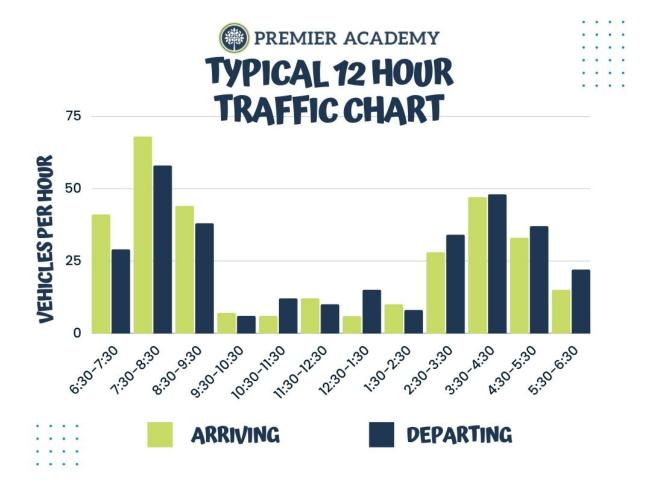



OAKLAND						
TIME	ARRIVING	DEPARTING				
6:30-7:30AM	41	29				
7:30-8:30AM	68	58				
8:30-9:30AM	44	38				
9:30-10:30AM	7	6				
10:30-11:30AM	6	12				
11:30-12:30PM	12	10				
12:30-1:30PM	6	15				
1:30-2:30PM	10	8				
2:30-3:30PM	28	34				
3:30-4:30PM	47	48				
4:30-5:30PM	33	37				
5:30-6:30PM	15	22				

ROCHESTER HILLS			
TIME	ARRIVING	DEPARTING	
6:30-7:30AM	37	30	
7:30-8:30AM	63	55	
8:30-9:30AM	38	36	
9:30-10:30AM	4	5	
10:30-11:30AM	4	7	
11:30-12:30PM	11	8	
12:30-1:30PM	4	9	
1:30-2:30PM	8	6	
2:30-3:30PM	25	27	
3:30-4:30PM	39	43	
4:30-5:30PM	29	31	
5:30-6:30PM	14	19	


NORTHVILLE			
TIME	ARRIVING	DEPARTING	
6:30-7:30AM	30	22	
7:30-8:30AM	58	52	
8:30-9:30AM	33	25	
9:30-10:30AM	9	7	
10:30-11:30AM	4	13	
11:30-12:30PM	11	8	
12:30-1:30PM	7	11	
1:30-2:30PM	8	6	
2:30-3:30PM	24	25	
3:30-4:30PM	37	42	
4:30-5:30PM	28	32	
5:30-6:30PM	11	17	

CAPACITY: 215


CAPACITY:210

CAPACITY: 155



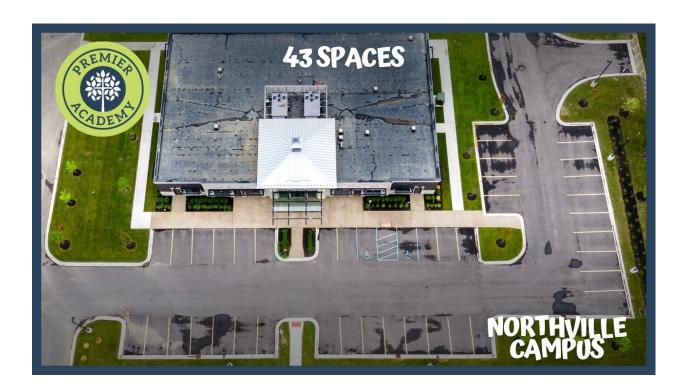



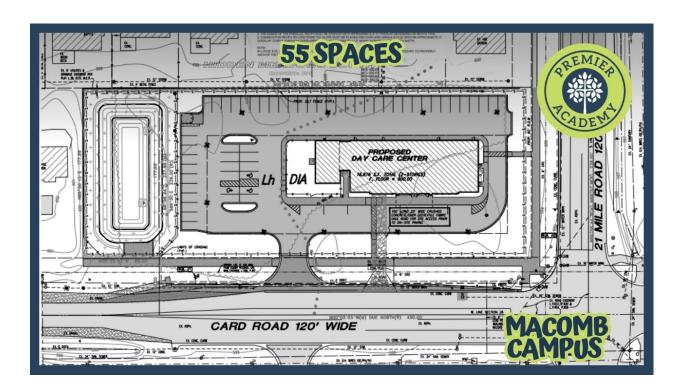



01.19.2024

Benjamin Carlisle, LEED AP, AICP Carlisle | Wortman Associates 117 North First Street, Suite 70 Ann Arbor, MI 48104

Re: Preliminary Site Plan Review

Northwest corner of Crooks & Wattles

Premier Academy (Proposed Child Care Facility)

Thank you for your review of the Premier Academy project. This letter is to address the following review comments below.

Natural Features

1. Consider removing parking to reduce impact upon floodplain and drain.

Proposed parking to be retained as shown. Further clarification explaining this request to maintain the proposed number of spaces is included within this resubmission.

2. Obtain LOMA prior to final site plan approval.

Will obtain LOMA permit, prior to final Engineering approvals.

3. Obtain EGLE wetland permit, if necessary, prior to final site plan approval.

If required, will obtain EGLE wetland permit, prior to final Engineering approvals.

Parking

1. Planning Commission to consider allowing parking to exceed greater than the 20% of the parking minimum. Applicant to provide written justification. As part of discussion, the Planning Commission should discuss with the applicant removing the 11 spaces on the north side of the building to reduce impact upon floodplain.

Proposed parking to be retained as shown. Further clarification explaining this request to maintain the proposed number of spaces is included within this resubmission.

2. Provide bicycle parking.

Bicycle parking is now provided. Refer to revised site plan.

<u>Parking Section Note:</u> A designated loading zone is not indicated on the site plan. Like all other Premier Academy facilities, operations do not require any kind of large deliveries therefore a loading zone is not necessary.



Traffic & Circulation

1. A right turn deceleration lane should be provided along Wattles Road at the proposed driveway.

A right turn deceleration lane has been provided along Wattles Road. Refer to revised the site plan.

2. The driveway throat width should be a minimum of 30 feet. It is currently shown as 25 feet.

The driveway throat has been increased to 30 feet. Refer to the revised site plan.

3. At the northeast corner of the parking lot, the last spot is adjacent to the grass paver drive. Pave a small stub to allow vehicles to back out of the space, then transition to the pavers.

A small paved stub has been included on the revised site plan to allow vehicles to back out of the last northeast corner parking space.

4. Increase sidewalk along Crooks and Wattles to 8-feet in width.

Sidewalk width has been increased along Crooks & Wattles to 8 feet.

Eliminate EVA

EVA has been removed.

Traffic and Circulation

1. Explain the drop-off and pickup operation to confirm that congestion on the site or within a public roadway will not be created.

Drop-off & pick-up operation summary is included within this resubmission.

Landscaping

1. Provide required landscape screening along east property line.

Required landscape screening is now provided along the east property line.

2. Increase parking lot landscaping and add trees internal to the parking lot

Landscaping plan has been revised to increase parking lot landscaping and added parking lot trees.

3. Provide a detail of retaining wall and fence.

A detail of the retaining wall and fence has been provided.



Photometrics

1. Consider increasing light intensity to between 3 to 4 footcandles throughout parking lot.

Refer to revised photometric plan. The average parking lot lighting now averages over 3FC throughout the lot.

<u>Design Standards & Site Plan Review Standards</u>

1. Recalculate transparency calculations.

Transparency calculations were recalculated & determined to be in compliance on each building elevation. It was clarified that transparency is calculated between 2' and 8' above grade in lieu of the full façade as was originally calculated. Refer to revised calculations on A.200 & A.201.

If you have any further comments, concerns, or questions; please do not hesitate to contact me.

Thank you,

Jeff Klatt, AIA

Krieger Klatt Architects, Inc.