

PLANNING COMMISSION MEETING AGENDA REGULAR MEETING

Marianna Perakis, Chair, Lakshmi Malalahalli, Vice Chair Toby Buechner, Carlton Faison, Tyler Fox, Michael W. Hutson, Tom Krent, Dave Lambert and John J. Tagle

May 14, 2024 7:00 P.M. Council Chambers

- 1. ROLL CALL
- 2. APPROVAL OF AGENDA
- 3. APPROVAL OF MINUTES April 23, 2024
- 4. PUBLIC COMMENT For Items Not on the Agenda

SPECIAL USE APPROVAL

- PUBLIC HEARING SPECIAL USE APPROVAL AND PRELIMINARY SITE PLAN REVIEW (SU JPLN2024-0010) – Proposed Motor City Church addition and site improvements, South side of Wattles, East of Coolidge (1349 W. Wattles), Section 20, Currently Zoned R-1B (One-Family Residential) Zoning District.
- 6. <u>PUBLIC HEARING SPECIAL USE AND PRELIMINARY SITE PLAN REVIEW (SU JPLN2021-024)</u> Proposed Starbucks with drive through, North side of Big Beaver, West of John R (1735 E. Big Beaver), Section 23, Currently Zoned CB (Community Business) Zoning District

PRELIMINARY SITE PLAN APPROVAL

7. PRELIMINARY SITE PLAN APPROVAL (JPLN2023-0028) — Proposed John R Commons Townhome Development, West side of John R, North of Big Beaver (PIN 88-20-23-476-017), Section 23, Zoned MF (Multi-Family Residential) Zoning District.

OTHER ITEMS

- 8. <u>PUBLIC COMMENT</u> For Items on the Agenda
- 9. PLANNING COMMISSION COMMENT
- 10. ADJOURN

NOTICE:People with disabilities needing accommodations for effective participation in this meeting should contact the City Clerk by e-mail at clerk@troymi.gov or by calling (248) 524-3317 at least two working days in advance of the meeting. An attempt will be made to make reasonable accommodations

Chair Perakis called the Regular meeting of the Troy City Planning Commission to order at 7:00 p.m. on April 23, 2024, in the Council Chamber of the Troy City Hall. Chair Perakis and Vice Chair Malalahalli presented opening remarks relative to the role of the Planning Commission and procedure of tonight's meeting.

1. ROLL CALL

Present:

Toby Buechner
Carlton M. Faison
Tyler Fox
Michael W. Hutson
Tom Krent
David Lambert
Lakshmi Malalahalli
Marianna Perakis
John J. Tagle

Also Present:

R. Brent Savidant, Community Development Director Salim Huerta Jr., Commercial Project Collaborator Julie Quinlan Dufrane, Assistant City Attorney Kathy L. Czarnecki, Recording Secretary

2. <u>APPROVAL OF AGENDA</u>

Resolution # PC-2024-04-019

Moved by: Faison Support by: Fox

RESOLVED, To approve the as prepared.

Yes: All present (9)

MOTION CARRIED

3. <u>APPROVAL OF MINUTES</u> – April 9, 2024

Resolution # PC-2024-04-020

Moved by: Buechner Support by: Lambert

RESOLVED, To approve the minutes of April 9, 2024 Regular meeting as submitted.

Yes: All present (9)

MOTION CARRIED

4. PUBLIC COMMENT – For Items Not on the Agenda

There was no one present who wished to speak.

PRELIMINARY SITE PLAN

 PRELIMINARY SITE PLAN APPROVAL (JPLN2023-0031) — Proposed Wattles Square Apartments, South side of Wattles and East of John R (PIN 88-20-24-100-039), Section 24, Zoned NN (Neighborhood Node "F") Zoning District

Mr. Savidant provided background information on the Preliminary Site Plan application for Wattles Square Apartments. He addressed the intent of the Neighborhood Node "F" zoning district, how the application relates to the Master Plan and specific site design and building design attributes. Mr. Savidant said the application proposes a first true 'garden style' building concept where a portion of the ground floor is below grade. He said there was extensive dialogue between the administration and the applicant on building height, what constitutes a story and the Zoning Ordinance definition of a basement.

Mr. Savidant asked to go on record with an apology to the Planning Commission and to the applicant for some errors in the Planning Consultant report dated April 12, 2024. He stated the application itself is more compliant than what the report narrates. Mr. Savidant noted the application meets all parking requirements with an exception of adding a bicycle rack. He reported the parking lot island trees and tree replacement are compliant. Mr. Savidant noted the one row of landscaping proposed on the north side of the site would have to be removed for future right of way purposes.

Mr. Savidant reported the application does not meet the transparency requirements on the Wattles frontage and east and south facades. He noted though transparency requirements relate more to commercial use than residential use. He said the applicant is seeking Planning Commission approval to incorporate transparency alternatives, and the Planning Commission has the authority to grant flexibility of the transparency requirements. Mr. Savidant also reported there are safety concerns with the head-clearance of the first floor balconies and the lower level units below grade.

Mr. Savidant asked the Planning Commission to consider in its deliberations the following:

- Does the Planning Commission support the proposed transparency alternatives?
- Does the proposed garden level apartment style meet the Neighborhood Node design requirements?
- Does the Planning Commission support the proposed floor plans (including the community building), elevations and balcony clearance?

In summary, Mr. Savidant asked any approval to be subject to the applicant providing the required bicycle rack and to confirm transparency requirements (30%) on the south and east sides of the buildings. He said the Planning Commission may approve the transparency alternatives for the north elevation.

Some of the comments during discussion among the administration related to:

- Transparency requirements on all facades.
- Design and transparency requirements of front elevation in relation to right of way.
- Horizontal mixed use complies with the Neighborhood Node zoning district.
- Neighborhood Node zoning requirements with future adoption of the Master Plan.
- Safety concerns of balcony head-clearance and lower level units below grade.
- Confirmation that a flat roof is proposed for both buildings.
- Compliance of landscape requirements on north side with removal of landscaping along right of way.

Chair Perakis called a recess at 7:30 p.m. to allow the Information Technology department to resolve audio issues. Chair Perakis called the meeting back in session at 7:40 p.m.

Richard Atto, property owner of subject site and Rite Aid property to the west, introduced family members in the audience and project team members business partner Brian Najor, Landscape Architect Stacee Hadeed and Project Engineer Greg Bono. Mr. Atto gave a brief history of his family background and real estate/development career. He identified several design aspects he feels would be desirous of a potential resident that are incorporated in the development.

Mr. Atto said his short-term goal is to obtain a tenant for the vacant Rite Aid store and a long-term goal would be to potentially expand the development given any future changes in the Neighborhood Node zoning district.

Ms. Hadeed distributed handouts to the Planning Commission and gave a brief history of her career path. She addressed in detail the proposed development as relates to living units, building height and stories, landscaping, parking, traffic circulation, three dimensional views from several directional perspectives, roof design, elevations, outdoor amenities, transparency calculations, site design attributes, building materials and color scheme.

There was discussion, some comments related to:

- Parking, as relates to Rite Aid existing spaces, designated spaces for residents, walking distance to residential units.
- Proposed garden style units as relates to creativity, urban look, massing, unique design, low profile.
- Examples of similar apartment styles in the City with below grade lower level units.
- Community center amenities, as relates to arrangement of work-out area and social gathering space.
- Options to mitigate safety concerns of below grade lower level units and head-clearance of balconies.
- Transparency requirements; measures applicant could apply to meet requirements, consideration of alternative options.

- Approval of application would be conditioned on applicant combining the parcels, as noted on the site plan.
- Nonconforming status of vacant Rite Aid building as relates to Neighborhood Node zoning district if demolished and/or renovated.

Mr. Hutson stated he does not support the application because of the proposed below grade lower level units and floor plans.

Chair Perakis opened the floor for public comment.

 Susan Kuhn, 2172 E Wattles; addressed existing swampy land near Wayfarer Street connection to new homes on John R, parking, management of apartment complex.

Chair Perakis closed the floor for public comment.

Discussion continued among Board members on options applicant could take to mitigate safety concerns of the balconies, to mitigate safety concerns and install egress windows on below grade lower level units, to reconfigure floor space in the community center and to meet transparency requirements.

Mr. Najor said finding a good tenant to lease the Rite Aid property is a step in the right direction. He addressed the subjectivity of transparency requirements for residential use compared to commercial use. Mr. Najor said they will work with the City to mitigate any concerns discussed this evening and meet all code requirements for the egress windows and balconies to assure compliance.

Resolution # PC-2024-04-021

Moved by: Lambert Seconded by: Faison

RESOLVED, That Preliminary Site Plan Approval, pursuant to Article 8 of the Zoning Ordinance, as requested for the proposed Wattles Square Apartments, located on the South side of Wattles, East of John R, Section 24, Zoned NN (Neighborhood Node "F") Zoning District be postponed, for the following reasons:

- 1. To increase transparency on all sides of the units.
- 2. To address appropriate concerns on the first level balconies and lower level egress areas.
- 3. Add a bicycle rack.

Yes: All present (9)

MOTION CARRIED

Mr. Savidant informed the applicant of the specific transparency requirements for each elevation.

OTHER ITEMS

6. <u>PUBLIC COMMENT</u> – For Items on the Agenda

There was no one present who wished to speak.

7. PLANNING COMMISSION COMMENT

There were general Planning Commission comments, some comments related to:

- Master Plan focus; parking, neighborhood node districts, North Troy zoning district.
- Potential future development of former K-Mart Headquarters site.
- Availability of Commissioners to attend May 28, 2024 Regular meeting.

8. ADJOURN

The Regular	meeting of t	he Planning (Commission a	djourned at 9:25	b.m.

Respectfully submitted,	
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Marianna J. Perakis, Chair	
Kathy L. Czarnecki, Recording Secretary	_

https://d.docs.live.net/2f7ed4fe5f664ea8/Documents/Kathy/COT Planning Commission Minutes/2024/2024 04 23 Draft.docx

ITEM #5

DATE: May 9, 2024

TO: Planning Commission

FROM: R. Brent Savidant, Community Development Director

SUBJECT: PUBLIC HEARING - SPECIAL USE APPROVAL AND PRELIMINARY SITE PLAN

<u>REVIEW (SU JPLN2024-0010)</u> – Proposed Motor City Church addition and site improvements, South side of Wattles, East of Coolidge (1349 W. Wattles), Section

20, Currently zoned R-1B (One-Family Residential) Zoning District.

The petitioner Pastor Dave Martin of Motor City Church submitted the above referenced Special Use Approval and Preliminary Site Plan Approval application for a church addition and other site improvements.

Places of worship are permitted in the R-1B district, subject to special use approval.

The attached report prepared by Carlisle/Wortman Associates, Inc. (CWA), the City's Planning Consultant, summarizes the application. CWA prepared the report with input from various City departments including Planning, Engineering, Public Works and Fire. City Management supports the findings of fact contained in the report and recommends approval of the project, as noted.

Attachments:

- 1. Maps
- 2. Report prepared by Carlisle/Wortman Associates, Inc.
- 3. Special Use/Preliminary Site Plan application

G:\SPECIAL USE\SU_JPLN2024-0010_MOTOR CITY CHURCH ADDITION RENDERING\PC Memo 05 14 2024.docx

PROPOSED RESOLUTION

<u>PUBLIC HEARING – SPECIAL USE APPROVAL AND PRELIMINARY SITE PLAN REVIEW (SU JPLN2024-0010)</u> – Proposed Motor City Church addition and site improvements, South side of Wattles, East of Coolidge (1349 W. Wattles), Section 20, Currently zoned R-1B (One-Family Residential) Zoning District.

Resolution # PC-2024-05-

Moved by: Seconded by:

RESOLVED, That Special Use Approval and Preliminary Site Plan Approval for the proposed church addition and other site improvements, South side of Wattles, East of Coolidge (1349 W. Wattles), Section 20, Currently Zoned R-1B (One Family Residential) District, be (granted, subject to the following conditions):

1.	Planning Commission review of excess parking.
2.	Planning Commission review of 1 parking lot tree along lot perimeter.


) or
(denied, for the following reasons:) oı
(postponed, for the following reasons:	
Yes: No:	

MOTION CARRIED / FAILED

Absent:

TROY

GIS Online

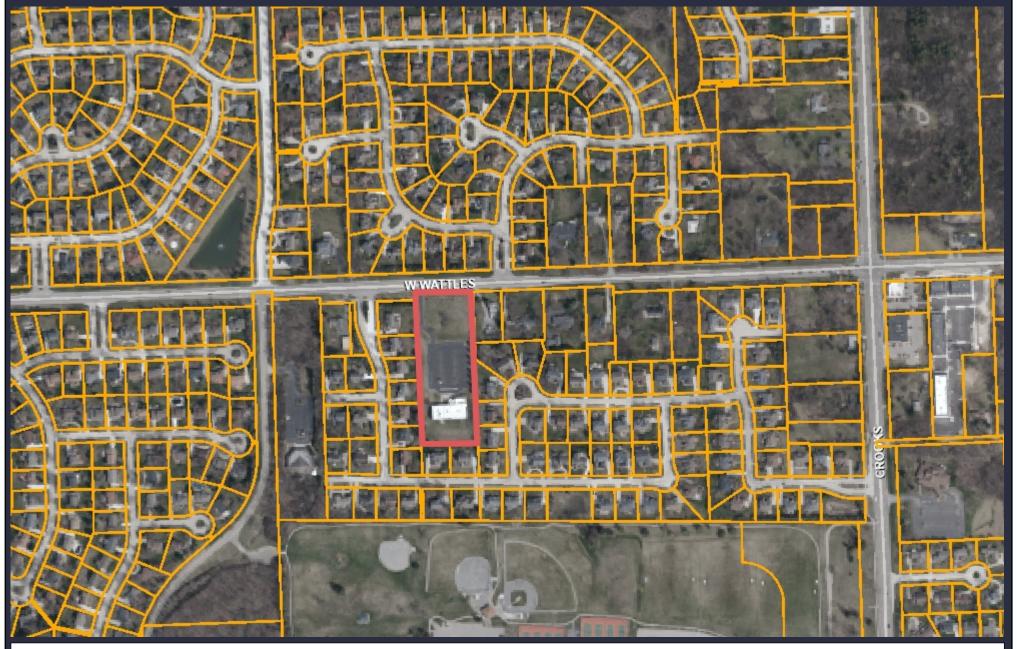

1,153 0 577 1,153 Feet



Note: The information provided by this application has been compiled from recorded deeds, plats, tax maps, surveys, and other public records and data. It is not a legally recorded map survey. Users of this data are hereby notified that the source information represented should be consulted for verification.

TROY

1,153

GIS Online



1,153Feet

577

Note: The information provided by this application has been compiled from recorded deeds, plats, tax maps, surveys, and other public records and data. It is not a legally recorded map survey. Users of this data are hereby notified that the source information represented should be consulted for verification.



117 NORTH FIRST STREET SUITE 70 ANN ARBOR, MI 48104 734.662.2200 734.662.1935 FAX

Date: April 30, 2024

May 7, 2024

Preliminary Site Plan and Special Use Review For City of Troy, Michigan

Applicant: John Tagle Associates, Inc.

Project Name: Motor City Church

Plan Date: April 16, 2024

Location: 1349 W Wattles Road

Zoning: R1-B, One-Family Residential


Action Requested: Preliminary Site Plan and Special Use Approval

PROJECT AND SITE DESCRIPTION

An application has been submitted to renovate and expand an existing church on Wattles Road. The subject site is 3.84 acres and currently contains a two-story church, parking lot, detention basin, and open space. Both the church and the parking lot shall expand north towards Wattles Road. The building footprint of the church will increase from an existing 11,260 square feet to 19,900 square feet. The total area of the new church is 32,545 square feet.

The site is currently zoned R1-B, One-Family Residential, in which Places of Worship require Special Use Approval.

Location of Subject Site:

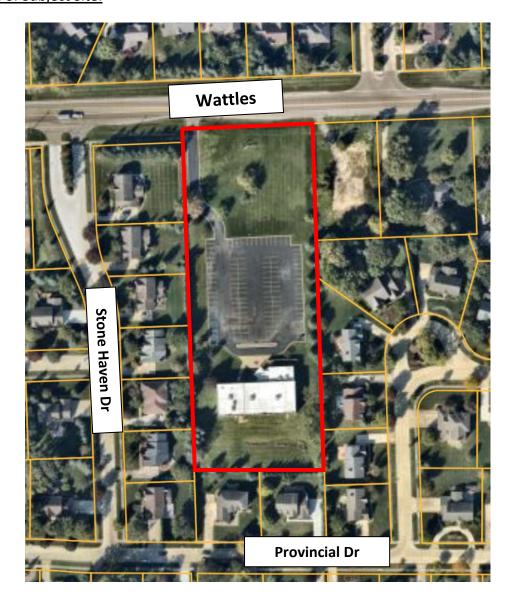

Size of Subject Site:

3.84 acres.

Proposed Uses of Subject Site:

Renovation and expansion of existing church.

Current Zoning:

R1-B, One-Family Residential.

Surrounding Property Details:

Direction	Zoning	Use	
North	R1-B, One-Family Residential	Single family residences	
South	R1-B, One-Family Residential Single family residences		
East	R1-B, One-Family Residential	Single family residences	
West	R1-B, One-Family Residential	Single family residences	

NATURAL FEATURES

Topography: Roughly half of the site has been graded for previous development and

impervious coverage is concentrated in the center of the site. The northern portion of the site is relatively flat, currently covered in grass and sparse trees. The southern portion of the site slopes roughly 10 feet lower in elevation than the northern portion. An existing detention basin lies in this

area.

Wetlands: No wetlands have been identified and the site does not lie in a floodplain.

Woodlands: A tree preservation plan provided by the applicant identifies thirty-one

(31) existing trees on site. Of those identified, 13 are Woodland trees and 7 are Landmark trees. The remainder are either invasive species or in poor condition, and shall be removed by the applicant. Tree replacement details

are outlined in the table below.

Replacement Details					
Protected Tree	Inches Removed	Replacement Required			
Landmark	12 inches	12 inches			
Woodland	26 inches	13 inches			
Preservation/Mitigation	Inches Preserved	Credit			
Landmark	55 inches	110 inches			
Woodland	153 inches	306 inches			
Total	None.				

Items to be Addressed: None.

SITE AND BUILDING ARRANGEMENT

The subject site is 3.84 acres with frontage on Wattles Road. As a vacant church currently exists on-site, the applicant intends to renovate/expand the church and extend the development north towards Wattles.

In its current state, the north end of the site is covered with grass and sparse trees. The existing parking lot and vacant church are located in the center, and a large detention basin is located in the site's rear (south end). The applicant proposes to expand the existing parking lot to the north to accommodate roughly forty-five (45) additional parking spaces. The vacant church shall expand from a footprint of 11,260 square feet to a footprint of 19,900 square feet. Most of the expansion will occur on the building's north elevation/front façade, while a smaller expansion will occur on the building's east elevation. The total area of the new church is 32,545 square feet.

The existing detention basin in the rear of the site shall remain. Although, an outdoor play area shall be erected between the building rear and the detention basin, and a new patio shall be erected along the front façade.

The applicant proposes to remove the existing driveway access in the far northwest corner and create a new driveway closer to the center of the front lot line. A pedestrian sidewalk is proposed along Wattles with direct connection onto the subject site and up to the church entrance. Landscaping is provided along Wattles, as well as within and around the parking lot.

Items to be Addressed: None.

AREA, WIDTH, HEIGHT, SETBACKS

The site is regulated by dimensional standards of the R-1B Zoning District:

	Required	Provided	Compliance	
Front (north)	40 feet	404 feet	Complies	
Side (east, west)	10 feet	10 feet 30 feet (east) 15 feet (west)		
Rear (south)	45 feet	100 feet	Complies	
Lot Area Covered By Buildings	30% Maximum	12%	Complies	
Building Height	2.5 stories, 30 feet	2 stories, 30 feet	Complies	

Items to be Addressed: None.

SITE ACCESS AND CIRCULATION

Vehicular Access and Circulation:

The applicant intends to expand the existing parking lot and relocate the driveway access point. In general, the arrangement of the parking lot remains largely the same and features two-way traffic. Driveway access shall be relocated from the northwest corner of the site to the center of

the north lot line. The new driveway shall contain an entrance lane, left exit lane, and right exit lane.

In addition, the applicant proposes to add a deceleration lane with corresponding restriping on Wattles Road. We note that Wattles is a road with local jurisdiction. The Engineering Department shall review the applicant's proposal to widen and restripe Wattles Road.

Pedestrian Access:

The applicant proposes an 8-foot wide sidewalk along the north lot line. It appears that this sidewalk will connect to an existing sidewalk to the west and conclude at the east end of the site, as there is no existing sidewalk to the east. An additional 6-foot wide sidewalk extends from the sidewalk along Wattles onto the subject site, providing pedestrian access to the main building.

Items to be Addressed: None.

PARKING

Places of Worship require the following types of parking:

	Required	Provided	Compliance
Places of Worship: 1 space for each 3 seats or 6 feet of pews in the main unit of worship	364 seats/3= 121 spaces	160 Spaces	Planning Commission Review
Barrier Free	6	6	Complies
Bicycle Parking	2	Bike Rack	Complies
Loading	1	0	See Below

Number of Parking Spaces:

The subject site is required to have 121 parking spaces; the applicant has exceeded this requirement with a total of 160 proposed parking spaces. The applicant explains that excess parking is intended to accommodate 35 additional occupants, such as volunteers, musicians, A/V staff, etc.

Section 13.06(F)(3) states that exceeding the minimum parking space requirements by more than 20% shall only be allowed with approval by the City. In granting such additional space, the City shall determine that such parking will be required, based on documented evidence, to accommodate the use on a typical day.

Items to be Addressed: Planning Commission review of excess parking.

LANDSCAPING

A Place of Worship at the subject site shall require the following types of landscaping:

	Required	Provided	Compliance	
Greenbelt (Wattles): One deciduous tree per 30 lineal feet, or fraction thereof, of frontage abutting a public road right-of-way.	251.7/30= 8 trees	8 trees	Complies	
Parking Lot: 1 tree per 8 parking spaces. Trees may be located along parking lot perimeter with Planning Commission approval.	160 spaces/8= 20 trees	20 trees: 19 trees within parking lot and 1 trees along lot perimeter	Pending Planning Commission Review	
Screening Between Uses:	East:	East:		
1 narrow evergreen tree per 3 lineal	138 LF/3=	138 LF/3=		
feet	46 narrow trees	46 narrow trees		
OR			Complies	
1 large evergreen tree per 10 lineal	West:	West:		
feet	120/10=	120/10=		
	12 large trees	12 large trees		
Overall Site: A minimum of 20% of the site area shall be comprised of landscape material.	20%	37.7%	Complies	

The Planning Commission may approve parking lot landscaping along the lot perimeter in situations where landscaping within parking lots would be impractical due to the size of the parking lot, detrimental to safe and efficient traffic flow, or would create an unreasonable burden for maintenance and snowplowing, provided all other landscaping requirements are met.

At the time of initial construction of the original church and parking lot, there was no screening requirement; however, the applicant is adding building and parking lot landscaping to soften the existing building and parking lot. Table 5.03-A-1 identifies Places of Worship as institutions under "Use Group 3" and the surrounding residential properties as "Use Group 1." Table 13.02-A outlines the two (2) options for screening between these use groups. The applicant has provided the required landscape screening along the new parking lot addition.

Mechanical Equipment:

Mechanical equipment is shown on the roof of the 2-story addition. The mechanical equipment shall be screened with architectural materials matching or harmonious with the building.

<u>Trash Enclosure:</u>

Materials for a trash enclosure have been provided and include wood panels, burnished masonry blocks, galvanized posts, and a limestone cap. The enclosure measures over 6 feet tall.

Items to be Addressed: Planning Commission review of 1 parking lot tree along lot perimeter.

PHOTOMETRICS

Proposed lighting levels and light fixtures are compliant with Ordinance standards.

Items to be Addressed: None.

FLOOR PLANS AND ELEVATIONS

Floor Plans:

First Floor

Existing Building Area

On the first floor, the existing building area shall be renovated with a new "sanctuary" room, which contains 362 seats on the main floor, plus a platform area, two (2) ramps, and a sound booth. Directly attached to the sanctuary room are the lobby, two (2) storage rooms, one (1) Usher's room, and a rear exit vestibule. The first floor of the existing building area also features one (1) greenroom, one (1) meeting room, one (1) break room, three (3) restrooms, one (1) elevator, and two (2) staircases.

North Addition

The first floor of the north addition features a new vestibule, lobby, room for belongings, and staircase upon entry. Near the entrance there is also a new coffee bar, janitor's room, and three (3) restrooms. Down the corridor, there is a kids check-in counter and separate rooms for children according to age group. There is one (1) nursery, one (1) room for kids aged 3-5, one (1) room for kids aged 6-11, and one (1) room for the "dream team." We note that the room for kids aged 6-11 features a movable wall that allows the room to split in half. Lastly, this area of the building includes three (3) storage rooms, one (1) restroom, and one (1) staircase.

East Addition

The east addition contains a storage area and a set of stairs. The stairs lead up to a 390 square foot mezzanine.

Second Floor

Existing Building Area

On the second floor, renovations of the existing building area include a new administration room, corridor, and janitor's closet. The existing mechanical and electrical room, storage room,

elevator, and two (2) staircases in this area shall remain. The second floor does not appear to extend above the sanctuary room.

North Addition

The second floor of the north addition features two (2) activity rooms, one (1) youth area, one (1) storage room, one (1) meeting room, two (2) restrooms, corridors, and two (2) staircases connecting to the first floor.

East Addition

The east addition does not extend to the second floor.

Exterior "Additions":

In addition to the interior renovation, the applicant proposes a couple of new elements to the building exterior. First, a new 1,300 square foot concrete patio is proposed on the northeast side of the front façade. Second, a new 1,200 square foot outdoor play area is proposed behind the building (south side). The play area shall be fenced in with a 4-foot high chainlink fence with privacy slats.

Elevations:

At its peak, the building measures 30 feet in height.

Building Materials:

The building exterior features metal panels and metal siding, including wood-pattern metal siding. Other materials include glass windows with aluminum frames, steel structural columns, EIFS, metal overhead doors, and metal canopies. Primary colors used for the building exterior are white, black, and orange. Colored renderings were provided and can be reviewed by the Planning Commission.

Items to be Addressed: None.

SPECIAL USE APPROVAL STANDARDS

Table 5.06.C-1 illustrates that auto/transportation uses are considered a special use for Neighborhood Nodes Site Type NN:A.

For any special use, according to Section 9.02.D, the Planning Commission shall "…review the request, supplementary materials either in support or opposition thereto, as well as the Planning Department's report, at a Public Hearing established for that purpose, and shall either grant or deny the request, table action on the request, or grant the request subject to specific conditions." Section 9.03 states that before approving any requests for Special Use Approval, the Planning Commission shall consider:

- 1. Compatibility with Adjacent Uses.
- 2. Compatibility with the Master Plan.
- 3. Traffic Impact.
- 4. Impact on Public Services.
- 5. Compliance with Zoning Ordinance Standards.
- 6. Impact on the Overall Environment. The proposed Special Use shall no
- 7. Special Use Approval Specific Requirements.

DESIGN STANDARDS AND SITE PLAN REVIEW STANDARDS

Section 8.06 outlines Site Plan Review Design Standards.

- 1. Development shall ensure compatibility with existing commercial districts and provide a transition between land uses.
 - a. Building design shall enhance the character of the surrounding area in relation to building and parking placement, landscape and streetscape features, and architectural design.
 - b. Street fronts shall provide a variety of architectural expression that is appropriate in its context and prevents monotony.
 - c. Building design shall achieve a compatible transition between areas with different height, massing, scale, and architectural style.
- 2. Development shall incorporate the recognized best architectural building design practices.
 - a. Foster a lasting impact on the community through the provision of high quality design, construction, and detailing.
 - b. Provide high quality, durable materials, such as but not limited to stone, brick, glass, and metal. E.I.F.S. or material equivalent shall only be used as an accent material.
 - c. Develop buildings with creativity that includes balanced compositions and forms.
 - d. Design roofs that are appropriate to the architectural style of the building and create an appropriate visual exterior mass of the building given the context of the site.
 - e. For commercial buildings, incorporate clearly defined, highly visible customer entrances using features such as canopies, porticos, arcades, arches, wing walls, ground plane elements, and/or landscape planters.
 - f. Include community amenities that add value to the development such as patio/ seating areas, water features, art work or sculpture, clock towers, pedestrian plazas with park benches or other features located in areas accessible to the public.
- 3. Enhance the character, environment and safety for pedestrians and motorists.
 - a. Provide elements that define the street and the pedestrian realm.
 - b. Create a connection between the public right of way and ground floor activities.

- c. Create a safe environment by employing design features to reduce vehicular and pedestrian conflict, while not sacrificing design excellence.
- d. Enhance the pedestrian realm by framing the sidewalk area with trees, awnings, and other features.
- e. Improve safety for pedestrians through site design measures.

RECOMMENDATION

The Planning Commission is asked to hold a public hearing and consider public testimony.

If the Planning Commission approves the Special Use and Preliminary Site Plan, we recommend the following conditions to be addressed as part of the final site plan:

- 1. Planning Commission review of excess parking.
- 2. Planning Commission review of 1 parking lot tree along lot perimeter.

Respectfully,

CARLISLE/WORTMAN ASSOC., INC. Benjamin R. Carlisle, AICP, LEED AP

President

CARLISLE/WORTMAN ASSOC., INC.

Shana Kot


Community Planner

MOTOR CITY CHURCH

JTAI

JOHN TAGLE ASSOCIATES, INC.

309 N Main Street, Suite 213 Royal Oak, Michigan 48067 248-542-0400

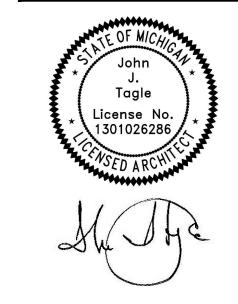

PEA, INC. CIVIL ENGINEERS

2430 ROCHESTER CT., STE. 100 TROY, MI 48083 Tel: 248 689-9090

T927 NEMCO WAY, STE. 115
BRIGHTON, MI 48116

Tel: 517 546-8583

PEA, INC.

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JTAI JOB NO. **23.37**

SPR/SU SUBMITTAL REV. 05/07/24

COVER SHEET

SITE PLAN REVIEW & SPECIAL USE

1349 W. WATTLES RD. TROY, MI 48098

DRAWING INDEX:

ARCHITECTURAL

COVER SHEET

A-060 ARCHITECTURAL SITE PLAN

A-200 MASTER PLAN FIRST FLOOR PLAN

A-201 MASTER PLAN LOWER LEVEL AND 2ND FLOOR PLANS

A-205 MASTER PLAN EXTERIOR ELEVATIONS

A-300 PHASE 1 FLOOR PLANS

A-305 PHASE 1 EXTERIOR ELEVATIONS

CIVIL

P-1 TOPOGRAPHIC SURVEY

P-2 PRELIMINARY SITE PLAN

P-2.1 PRELIMINARY WATTLES STRIPING PLAN

P-3 PRELIMINARY GRADING PLAN
P-4 PRELIMINARY UTILITY PLAN

LANDSCAPE


L-1 PRELIMINARY LANDSCAPE PLAN

L-2 LANDSCAPE DETAILS

T-1 TREE PRESERVATION PLAN


SUPPLEMENTAL INFORMATION

SITE LIGHTING PHOTOMETRIC PLAN MASTER PLAN RENDERINGS PHASE 1 RENDERINGS

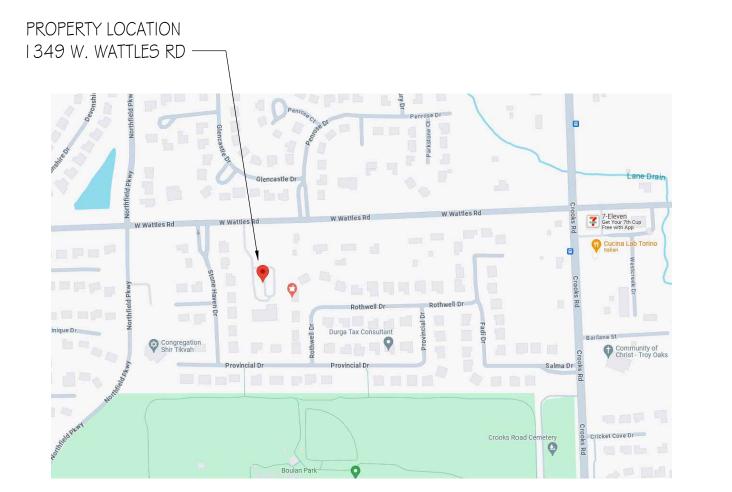

LOCATION MAP

NOT TO SCALE

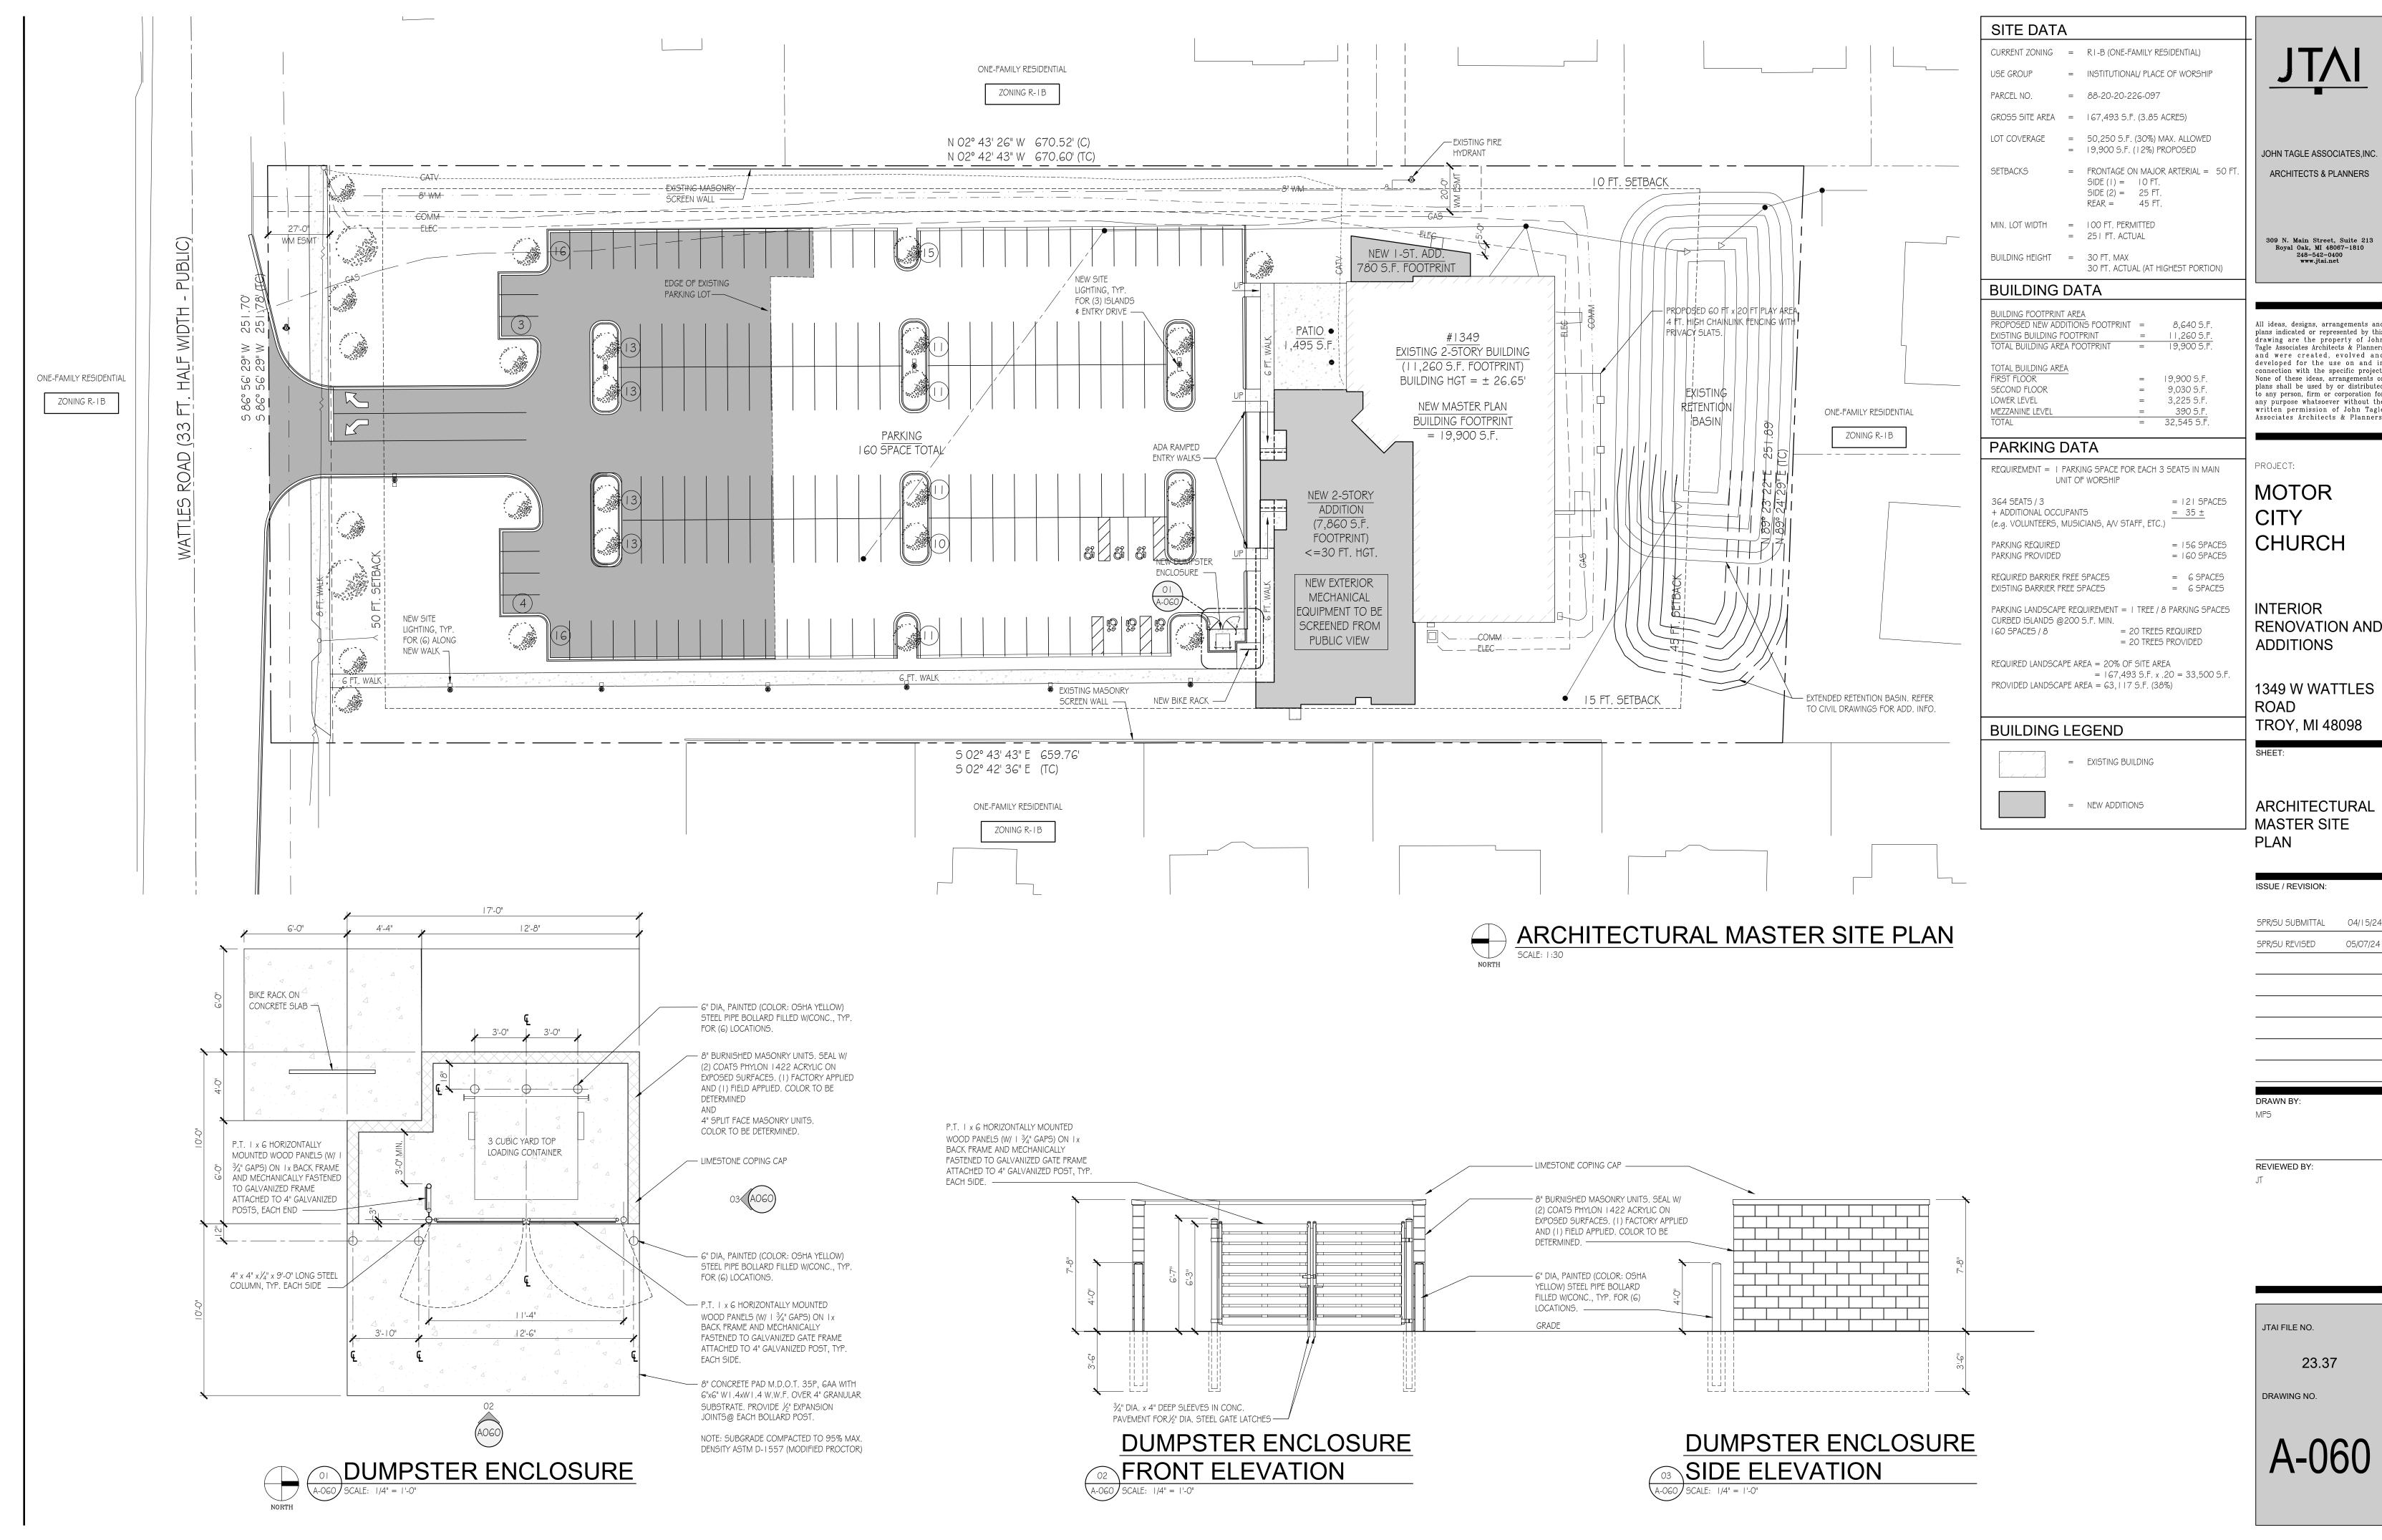


ARCHITECTS & PLANNERS

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RENOVATION AND

SPR/SU SUBMITTAL 04/15/24 05/07/24

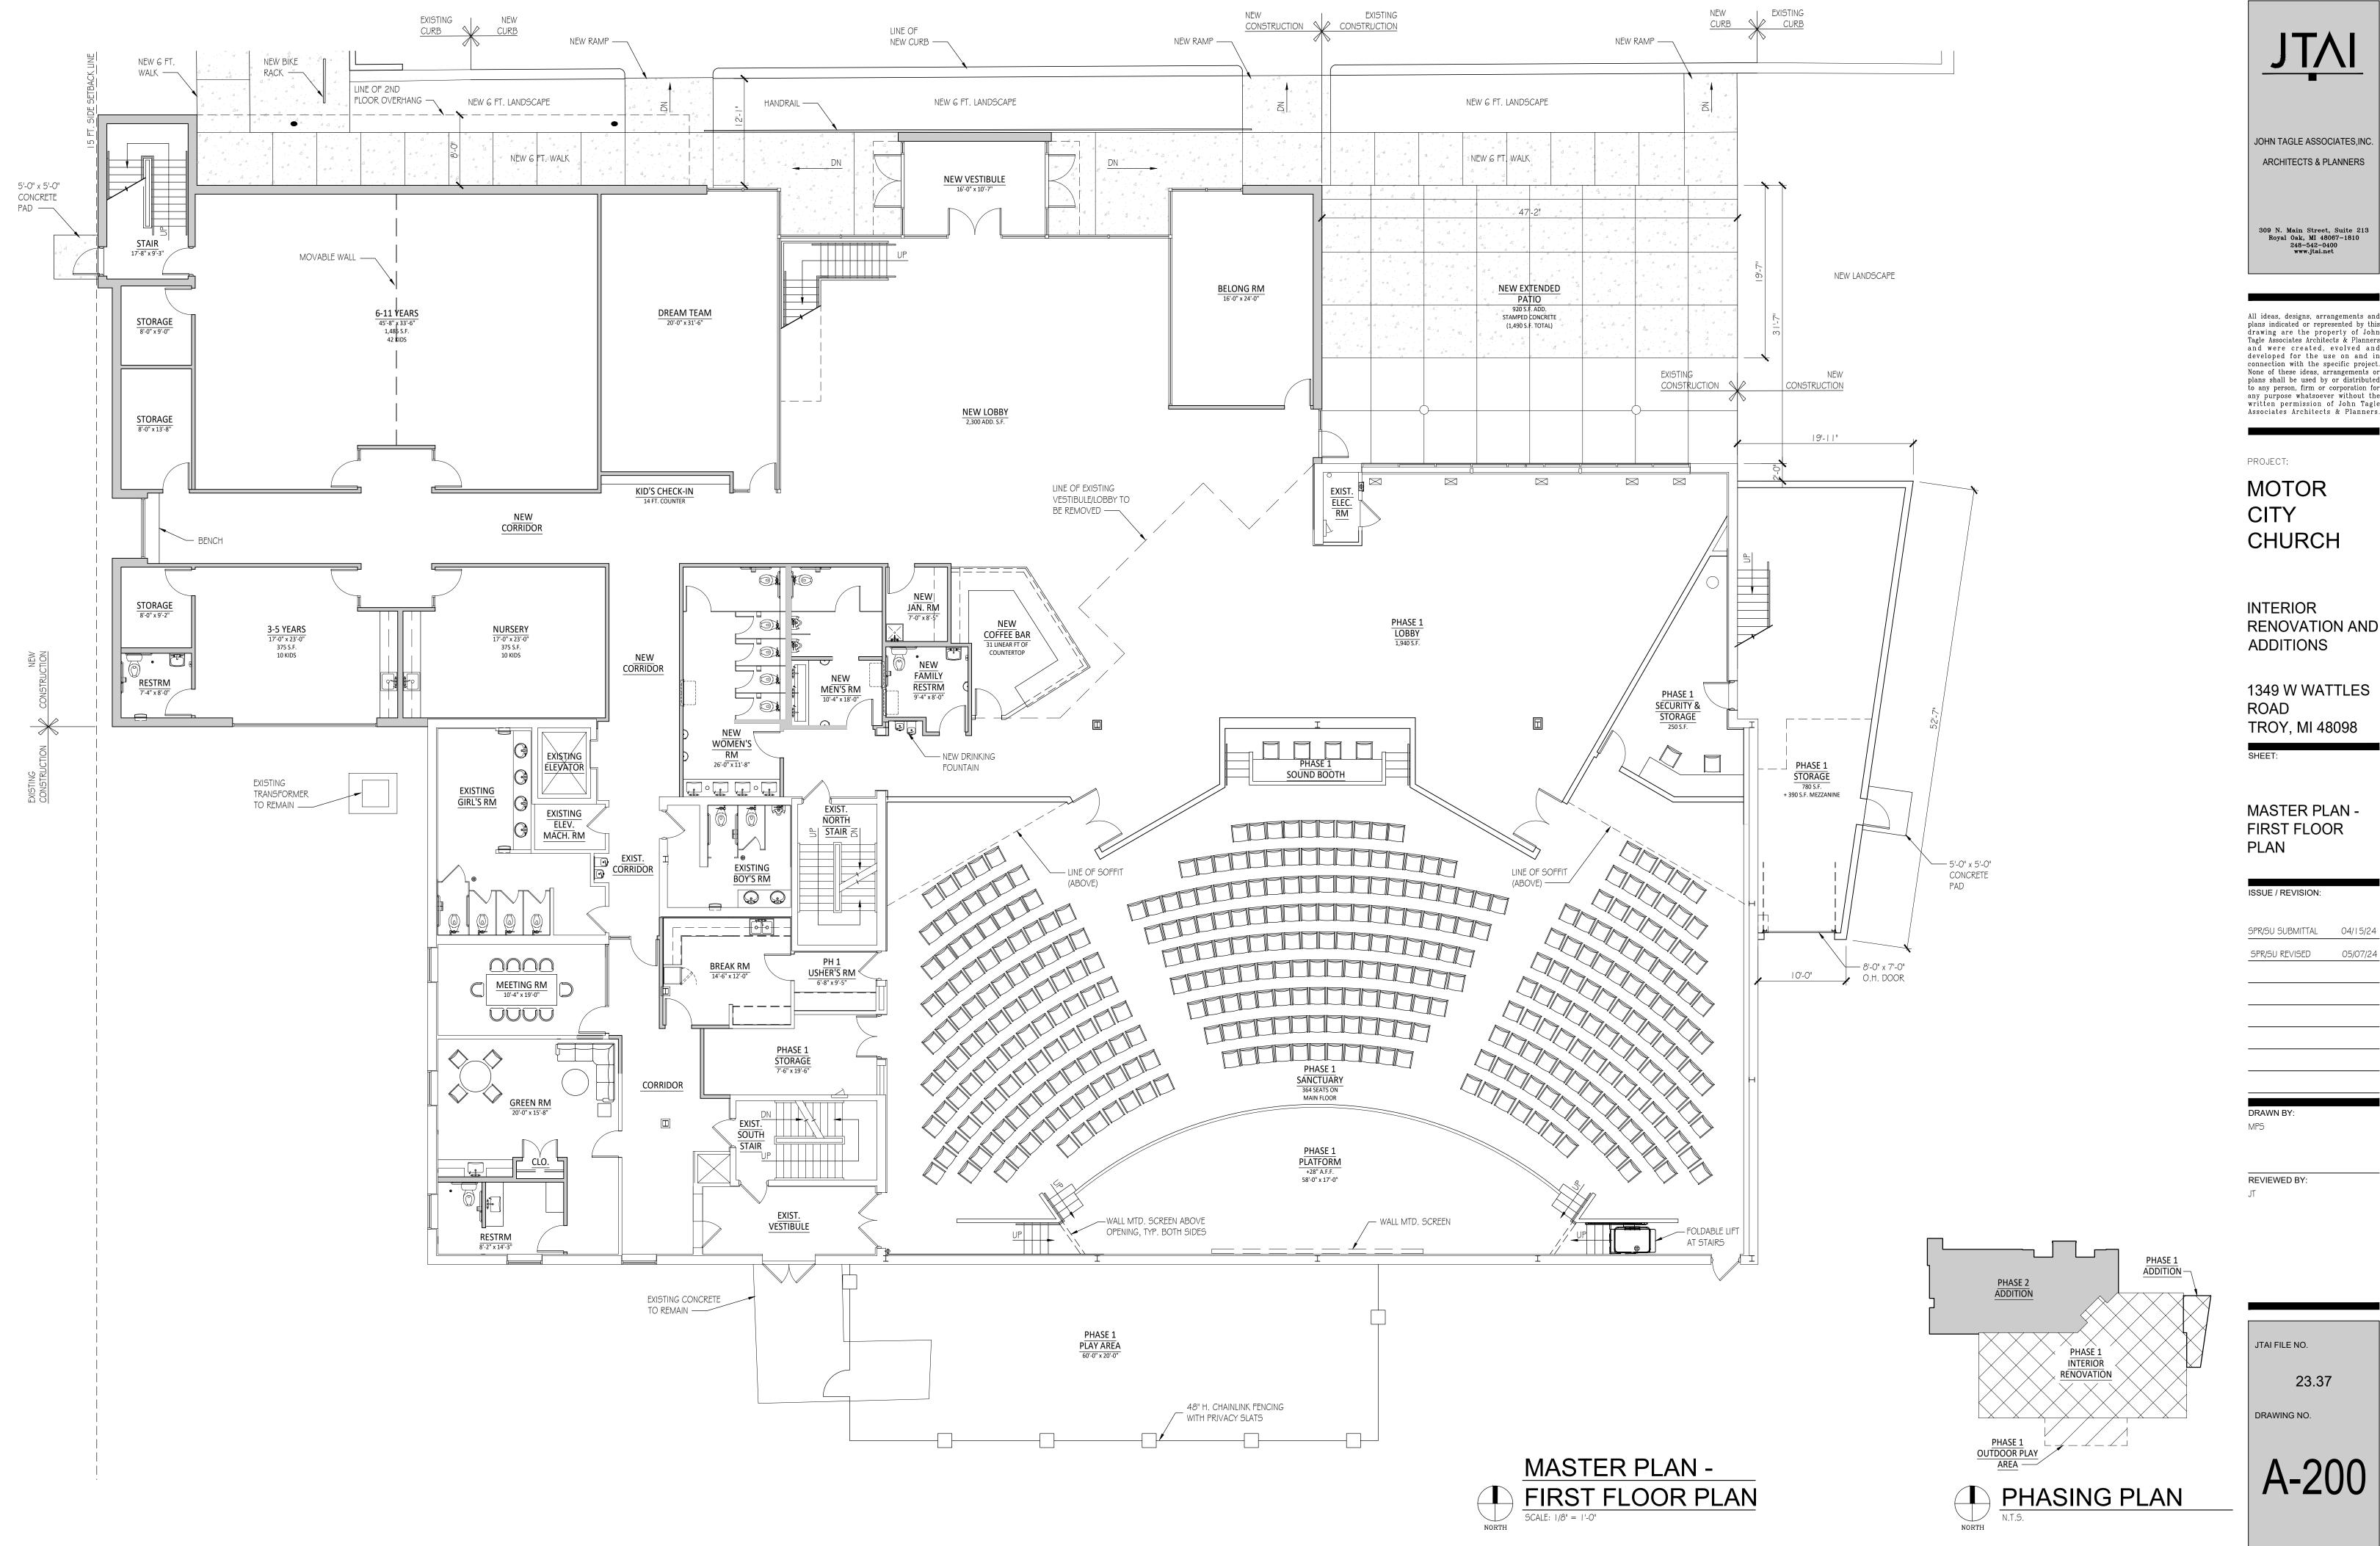

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MOTOR CHURCH

INTERIOR RENOVATION AND **ADDITIONS**

1349 W WATTLES TROY, MI 48098

MASTER PLAN -FIRST FLOOR


ISSUE / REVISION:

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REVIEWED BY:

JTAI FILE NO. 23.37

A-200

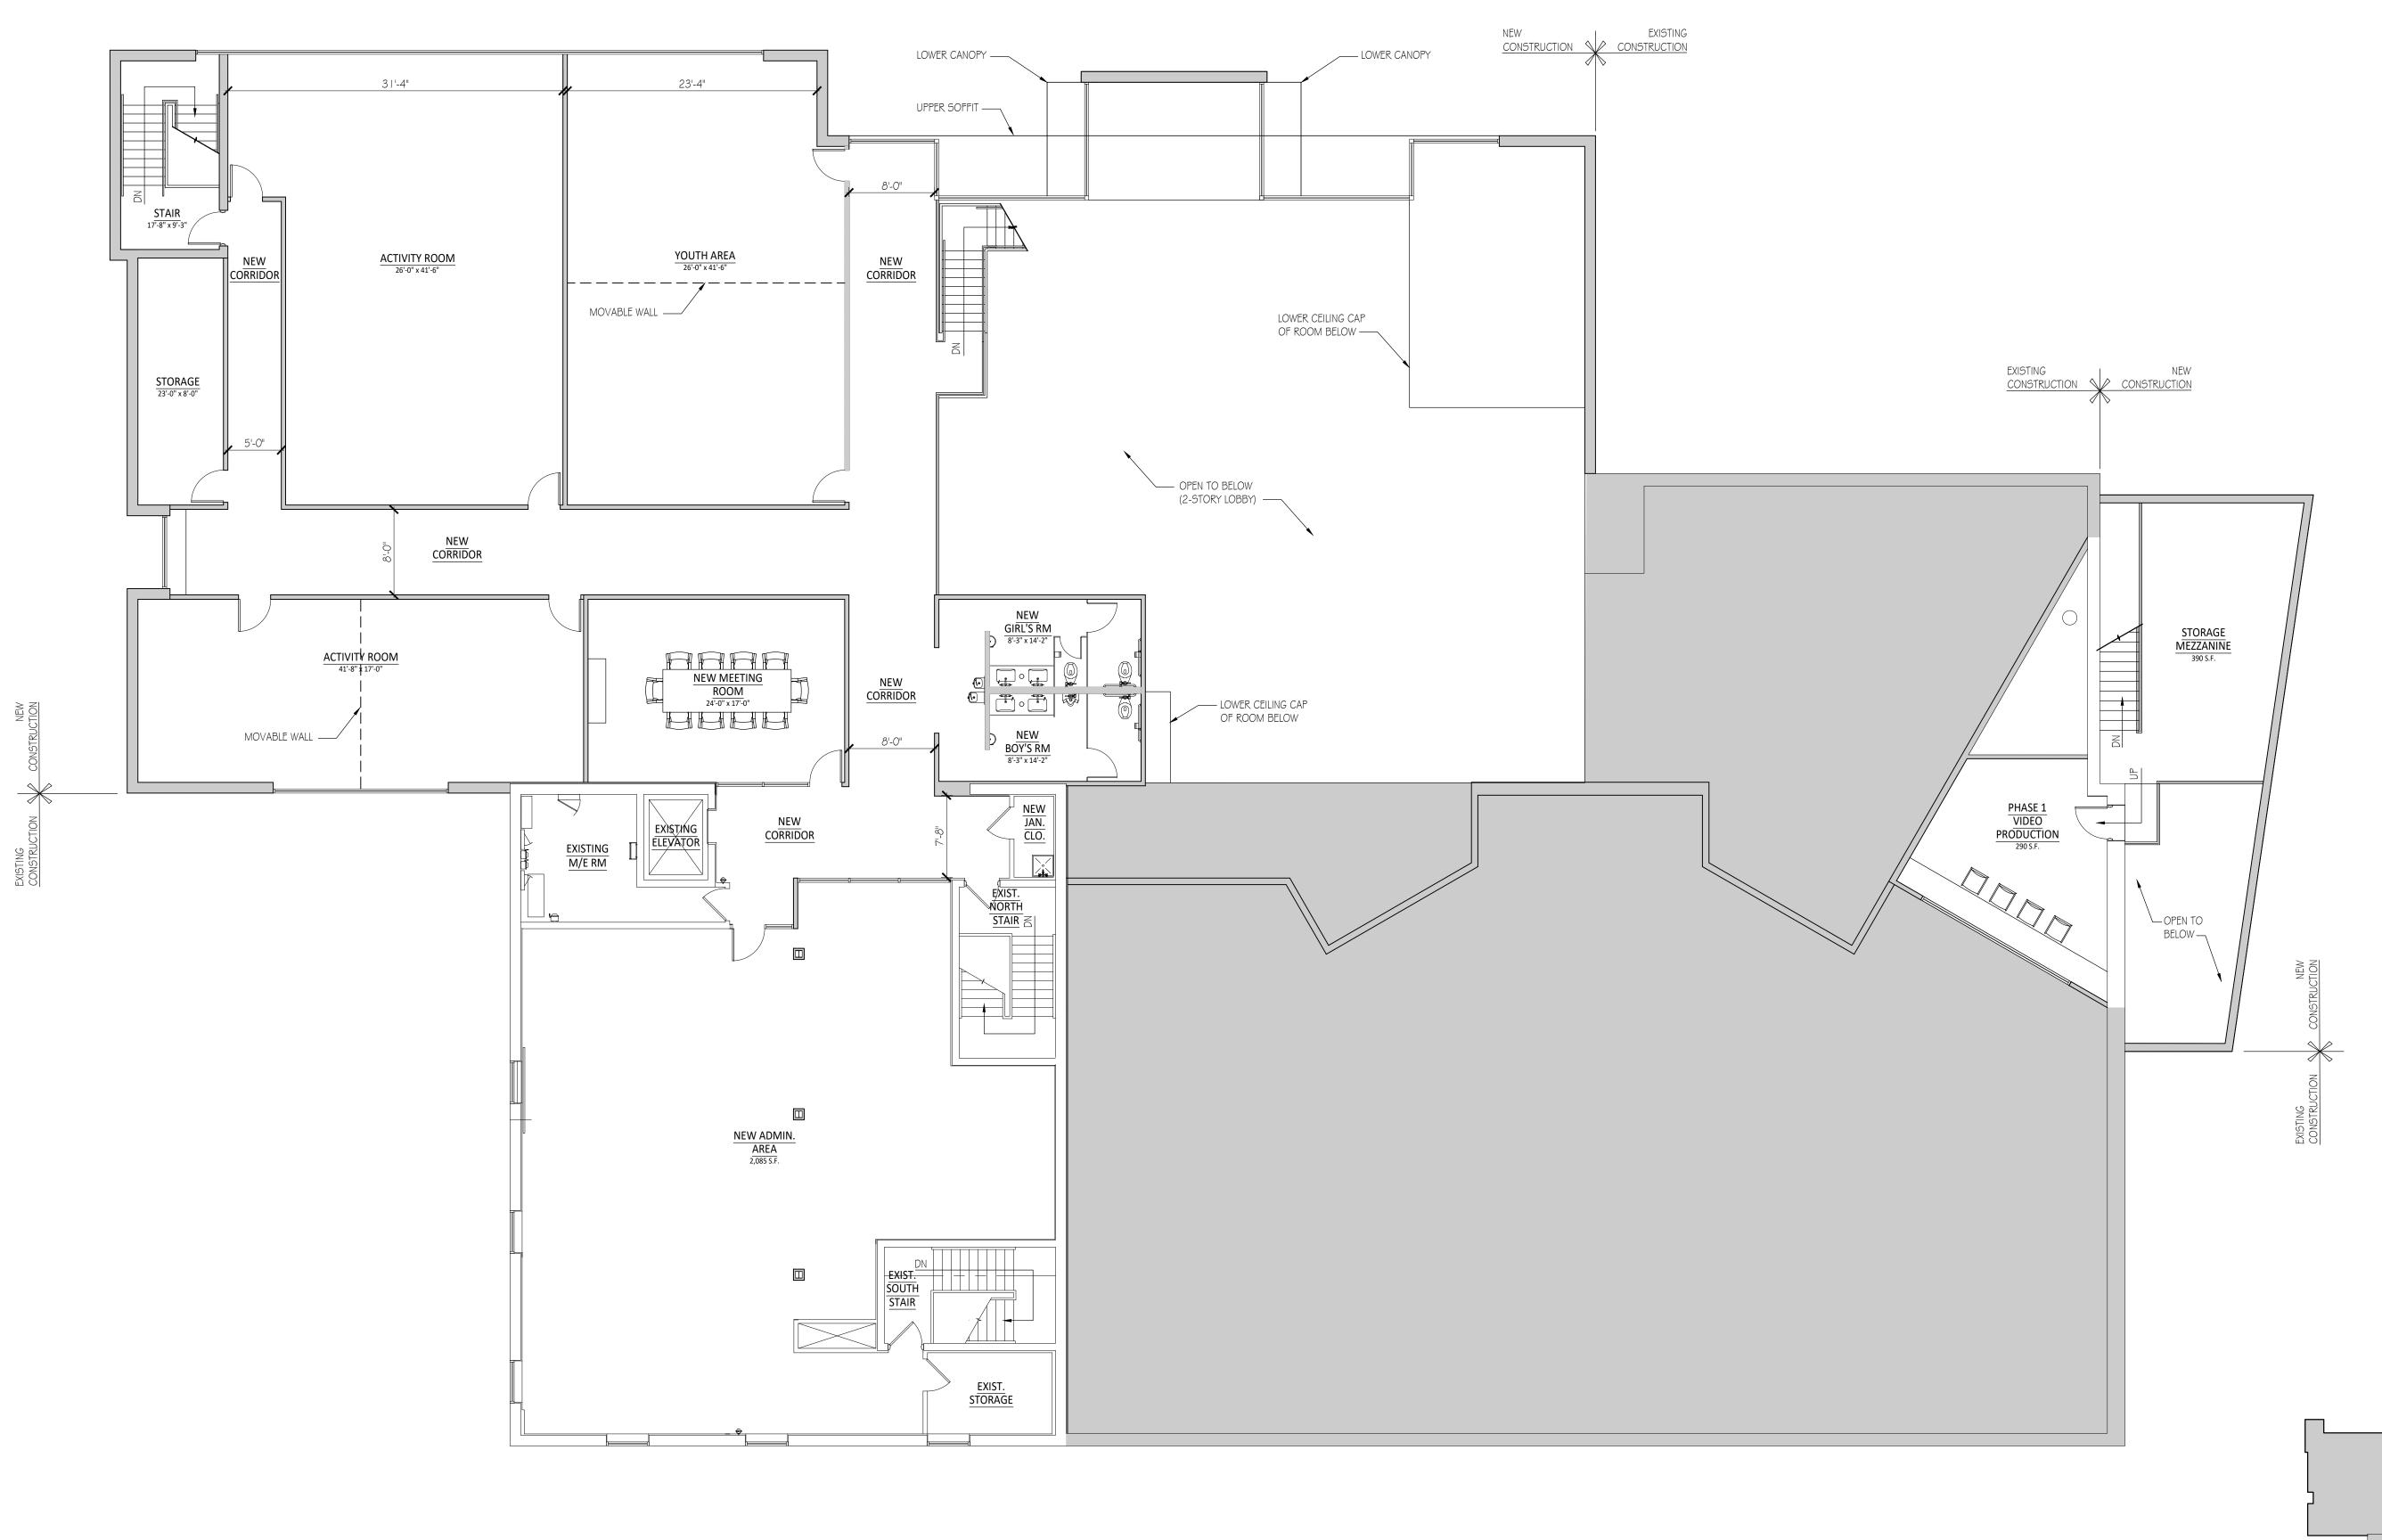

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PROJECT:

MOTOR CITY CHURCH

INTERIOR RENOVATION AND **ADDITIONS**

1349 W WATTLES ROAD TROY, MI 48098

MASTER PLAN -SECOND FLOOR PLAN

ISSUE / REVISION:

SPR/SU SUBMITTAL 04/15/24 SPR/SU REVISED 05/07/24


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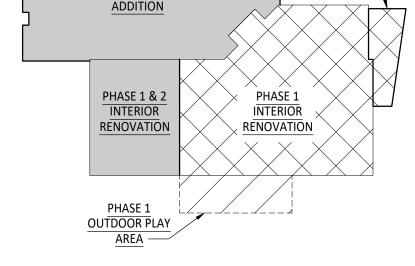
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DRAWING NO.

23.37


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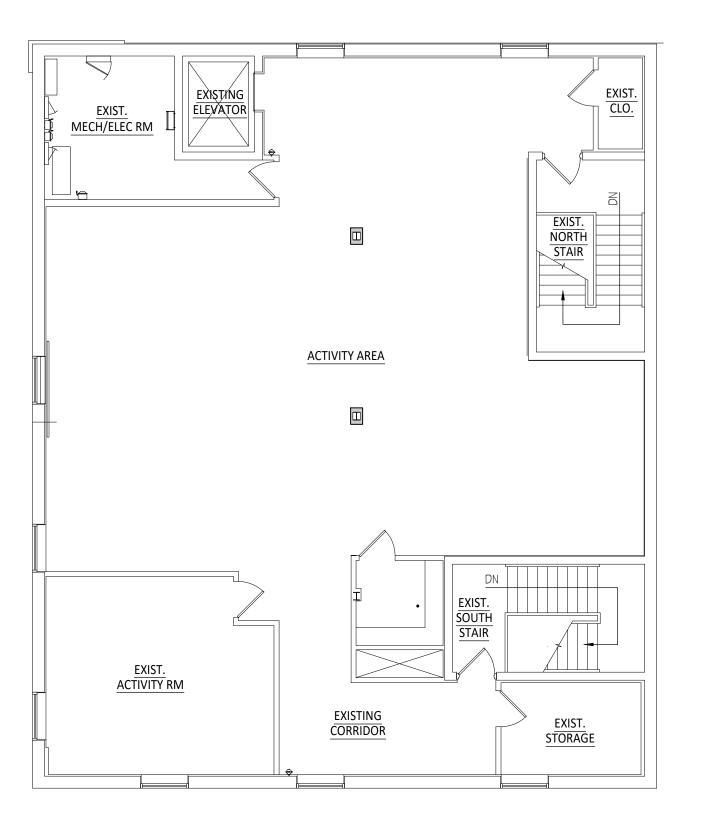




MASTER PLAN -SECOND FLOOR PLAN

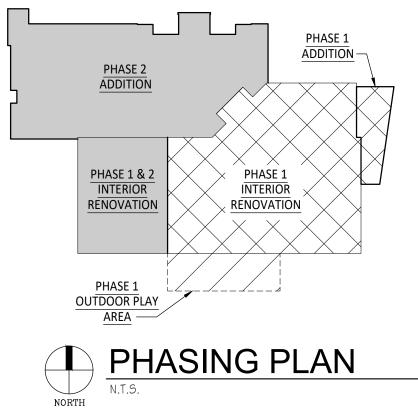
SCALE: 1/8" = 1'-0"



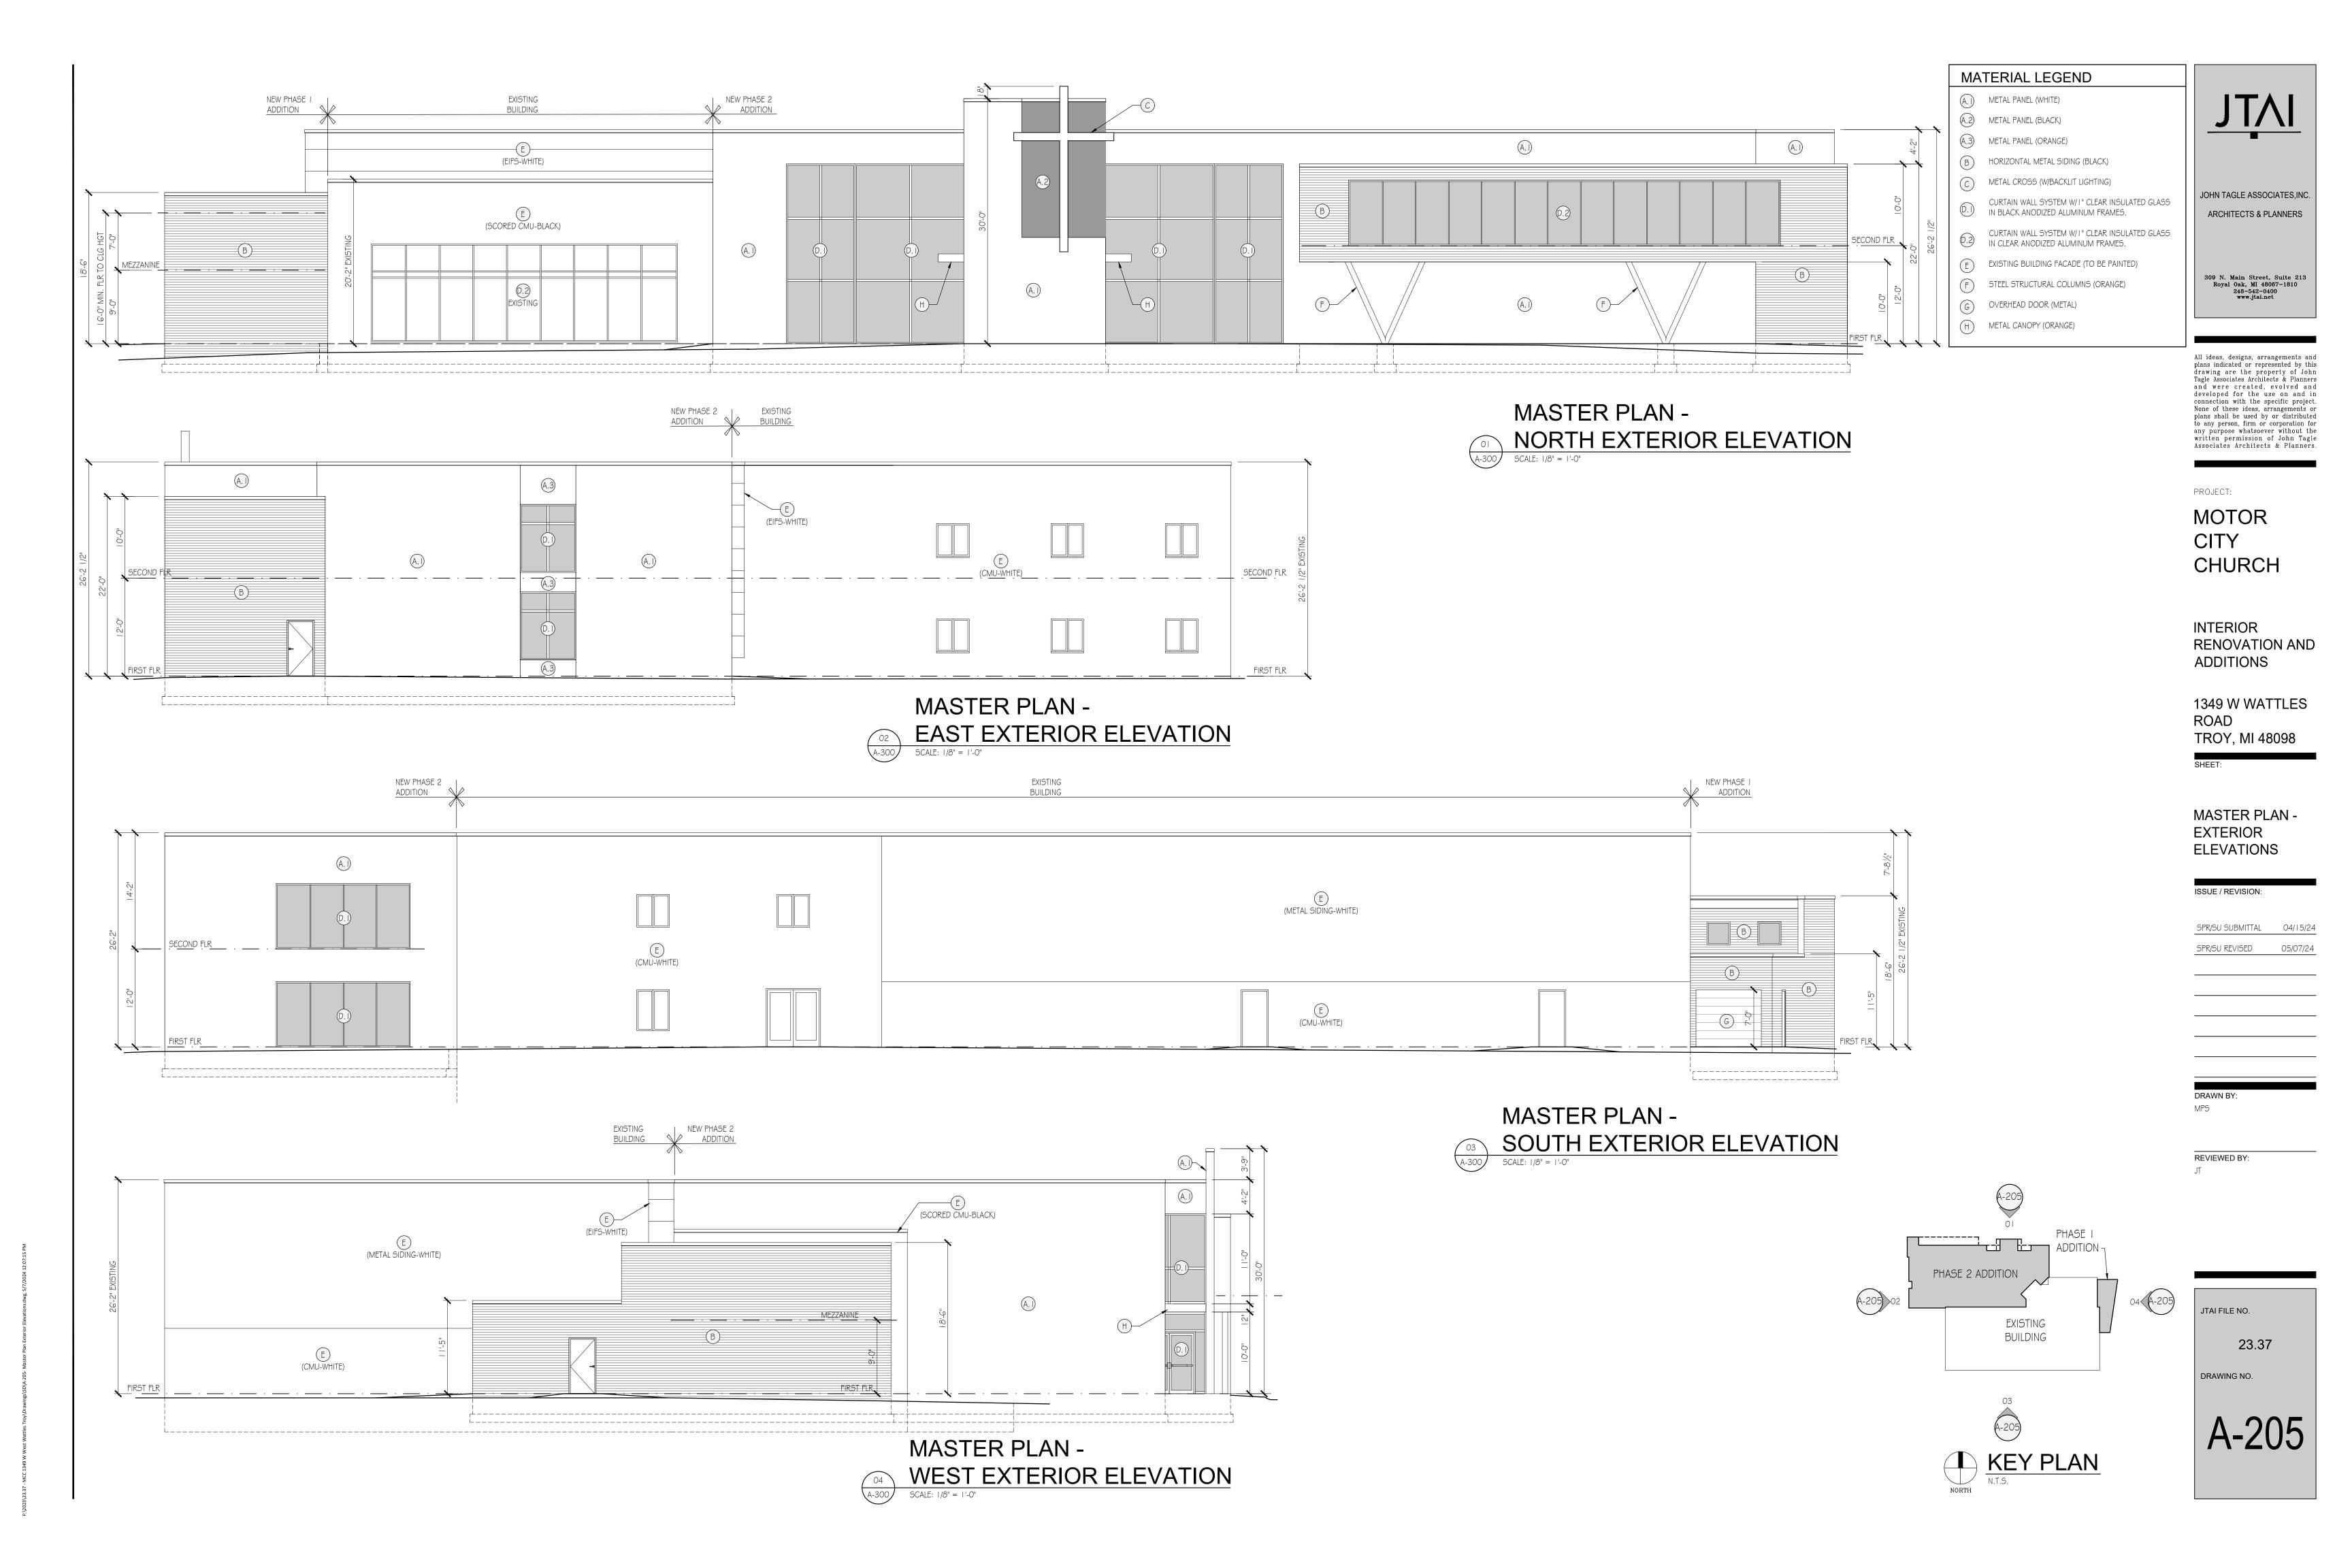

PHASE 1
SECOND FLOOR PLAN


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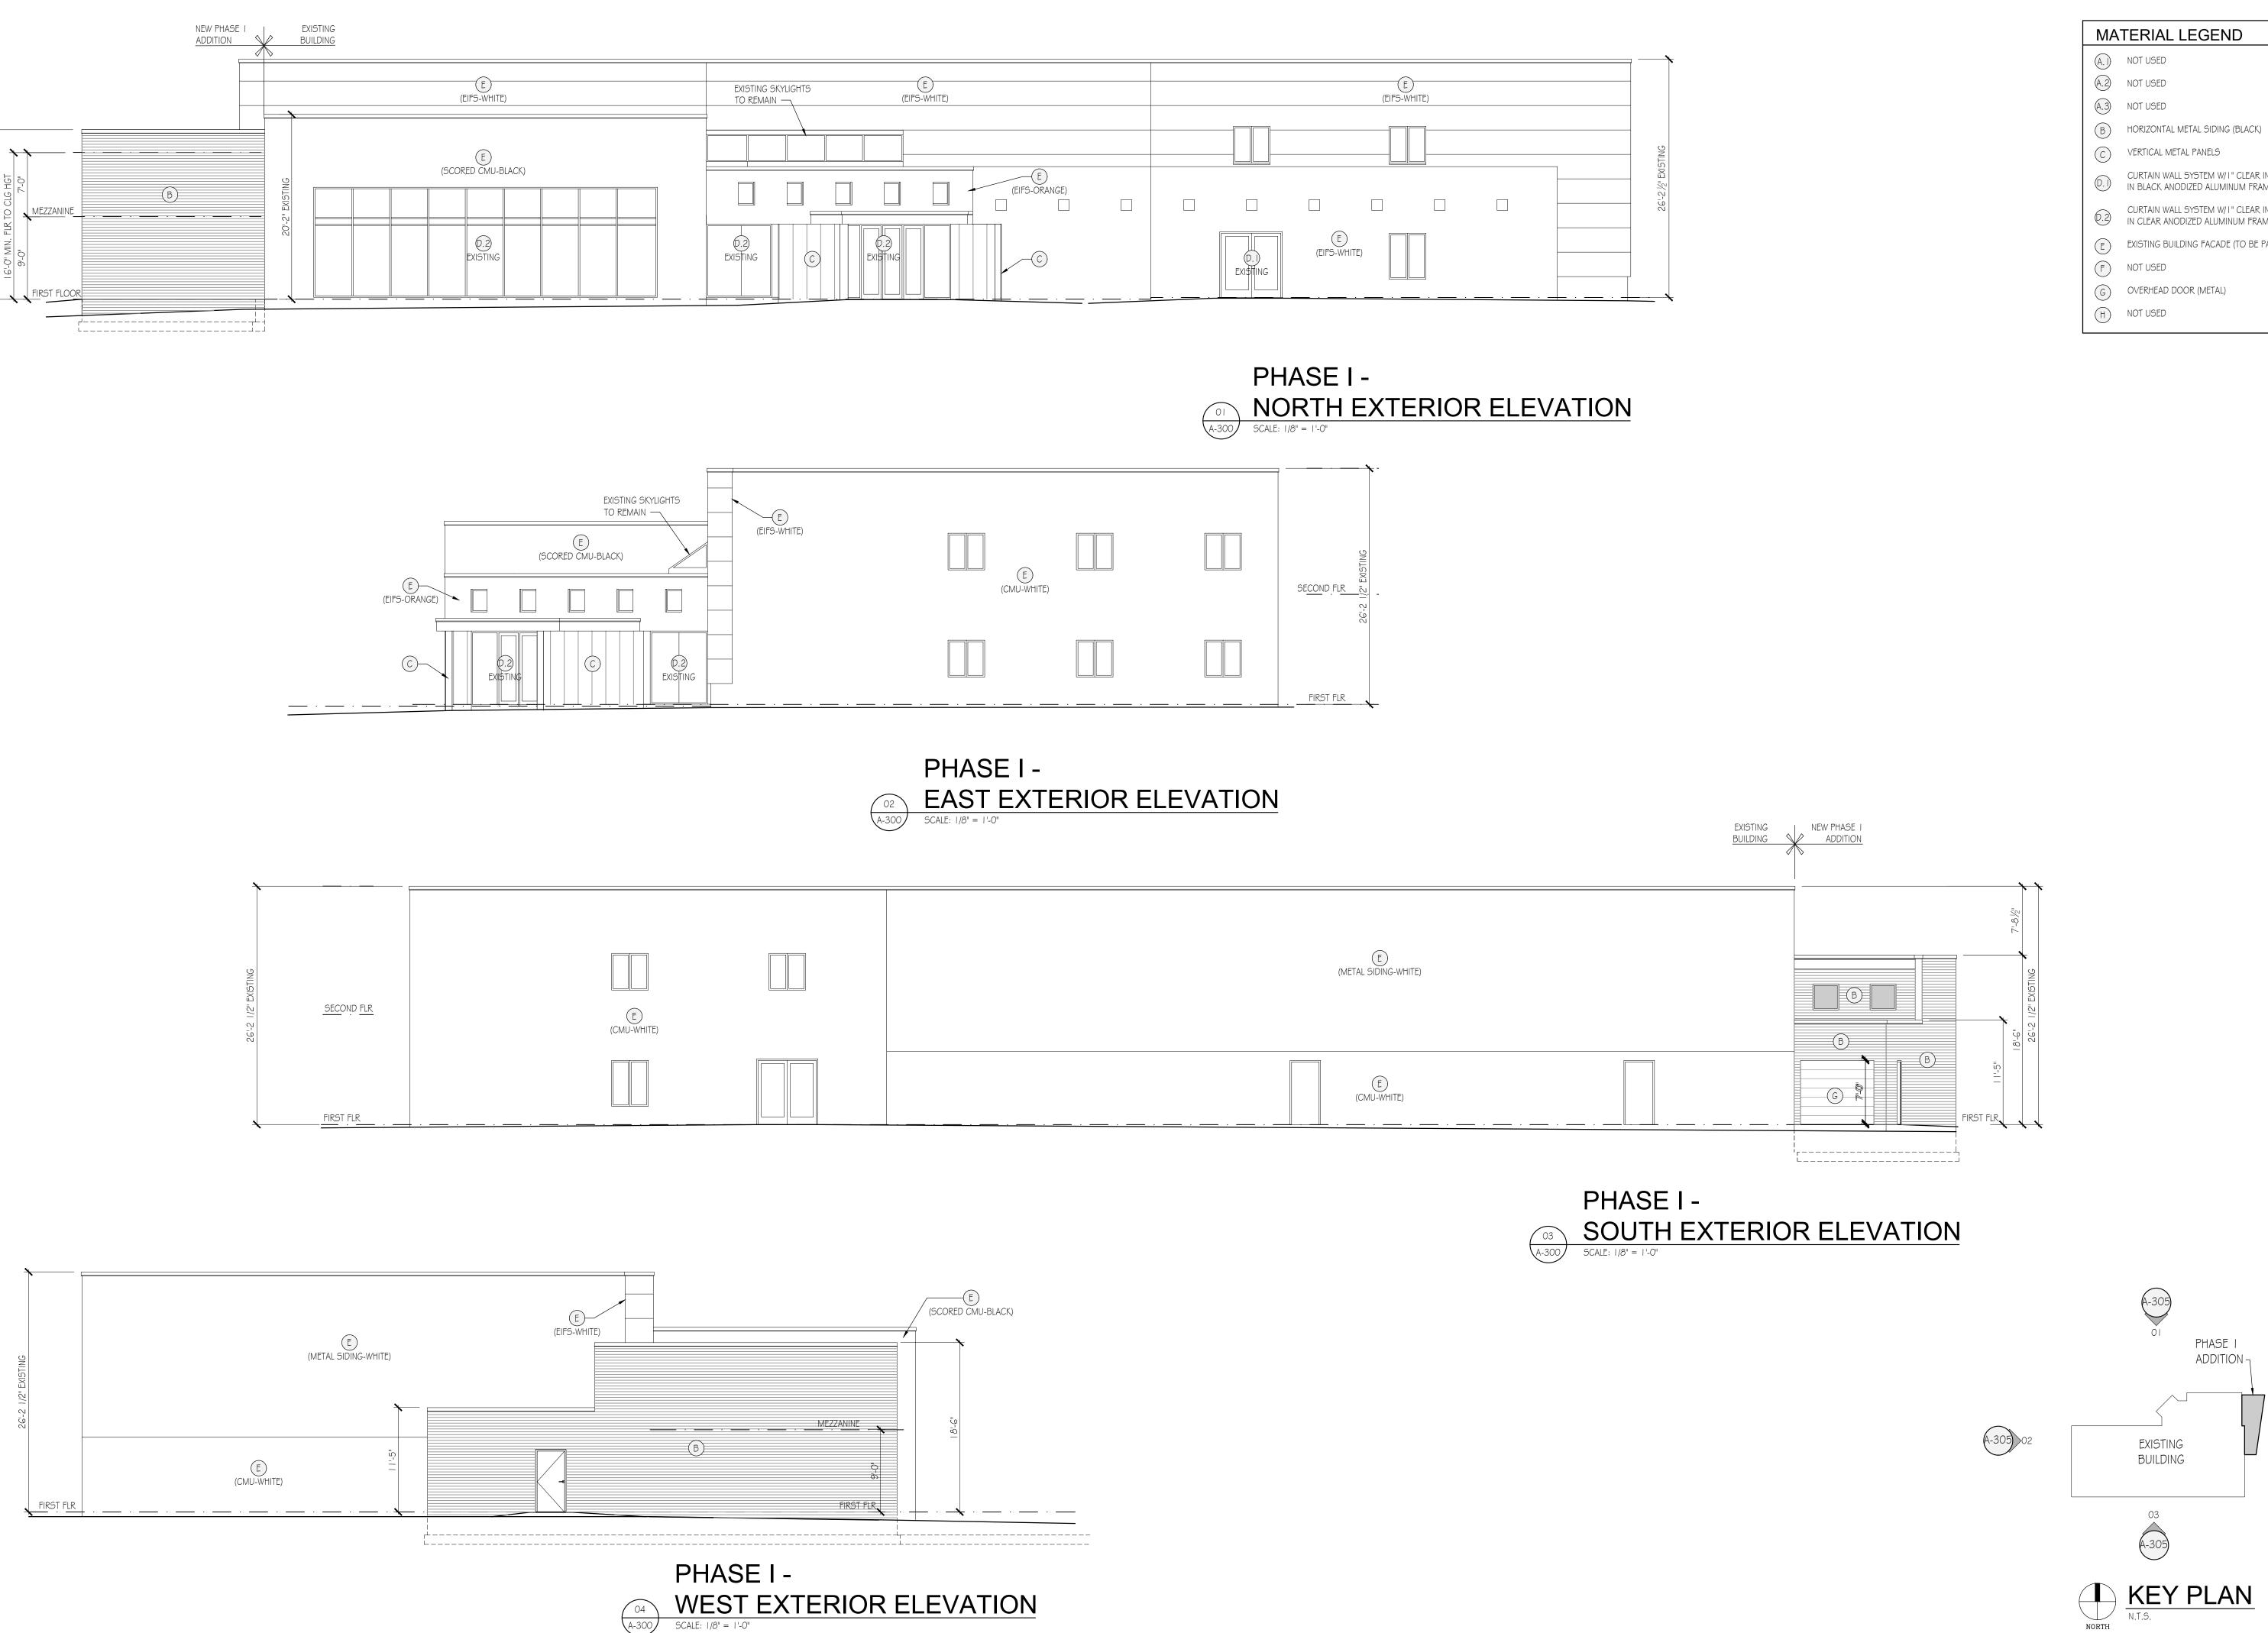


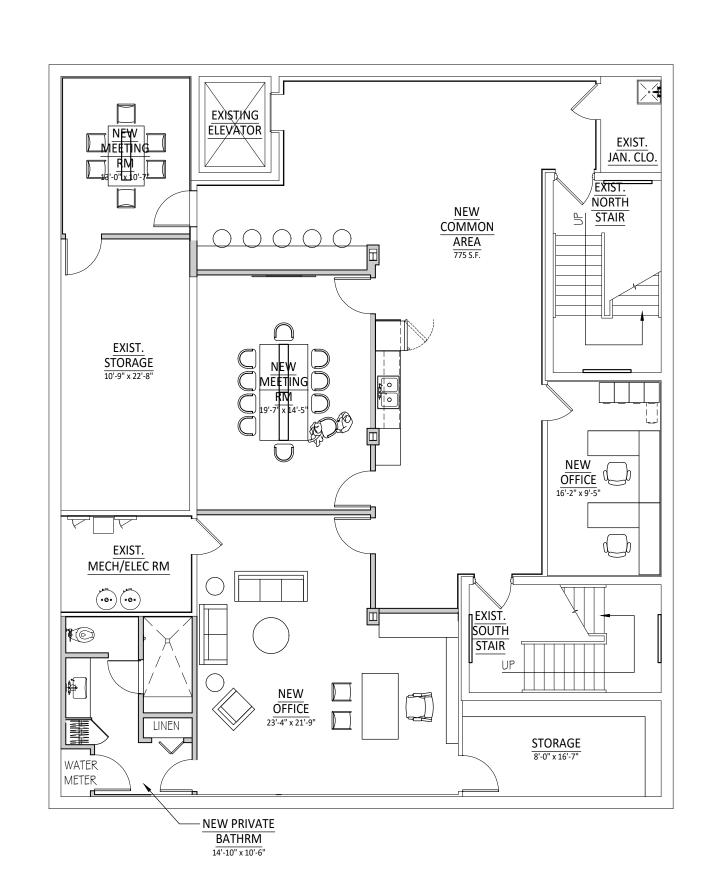PHASE 1

LOWER LEVEL FLOOR PLAN

SCALE: 1/8" = 1'-0"



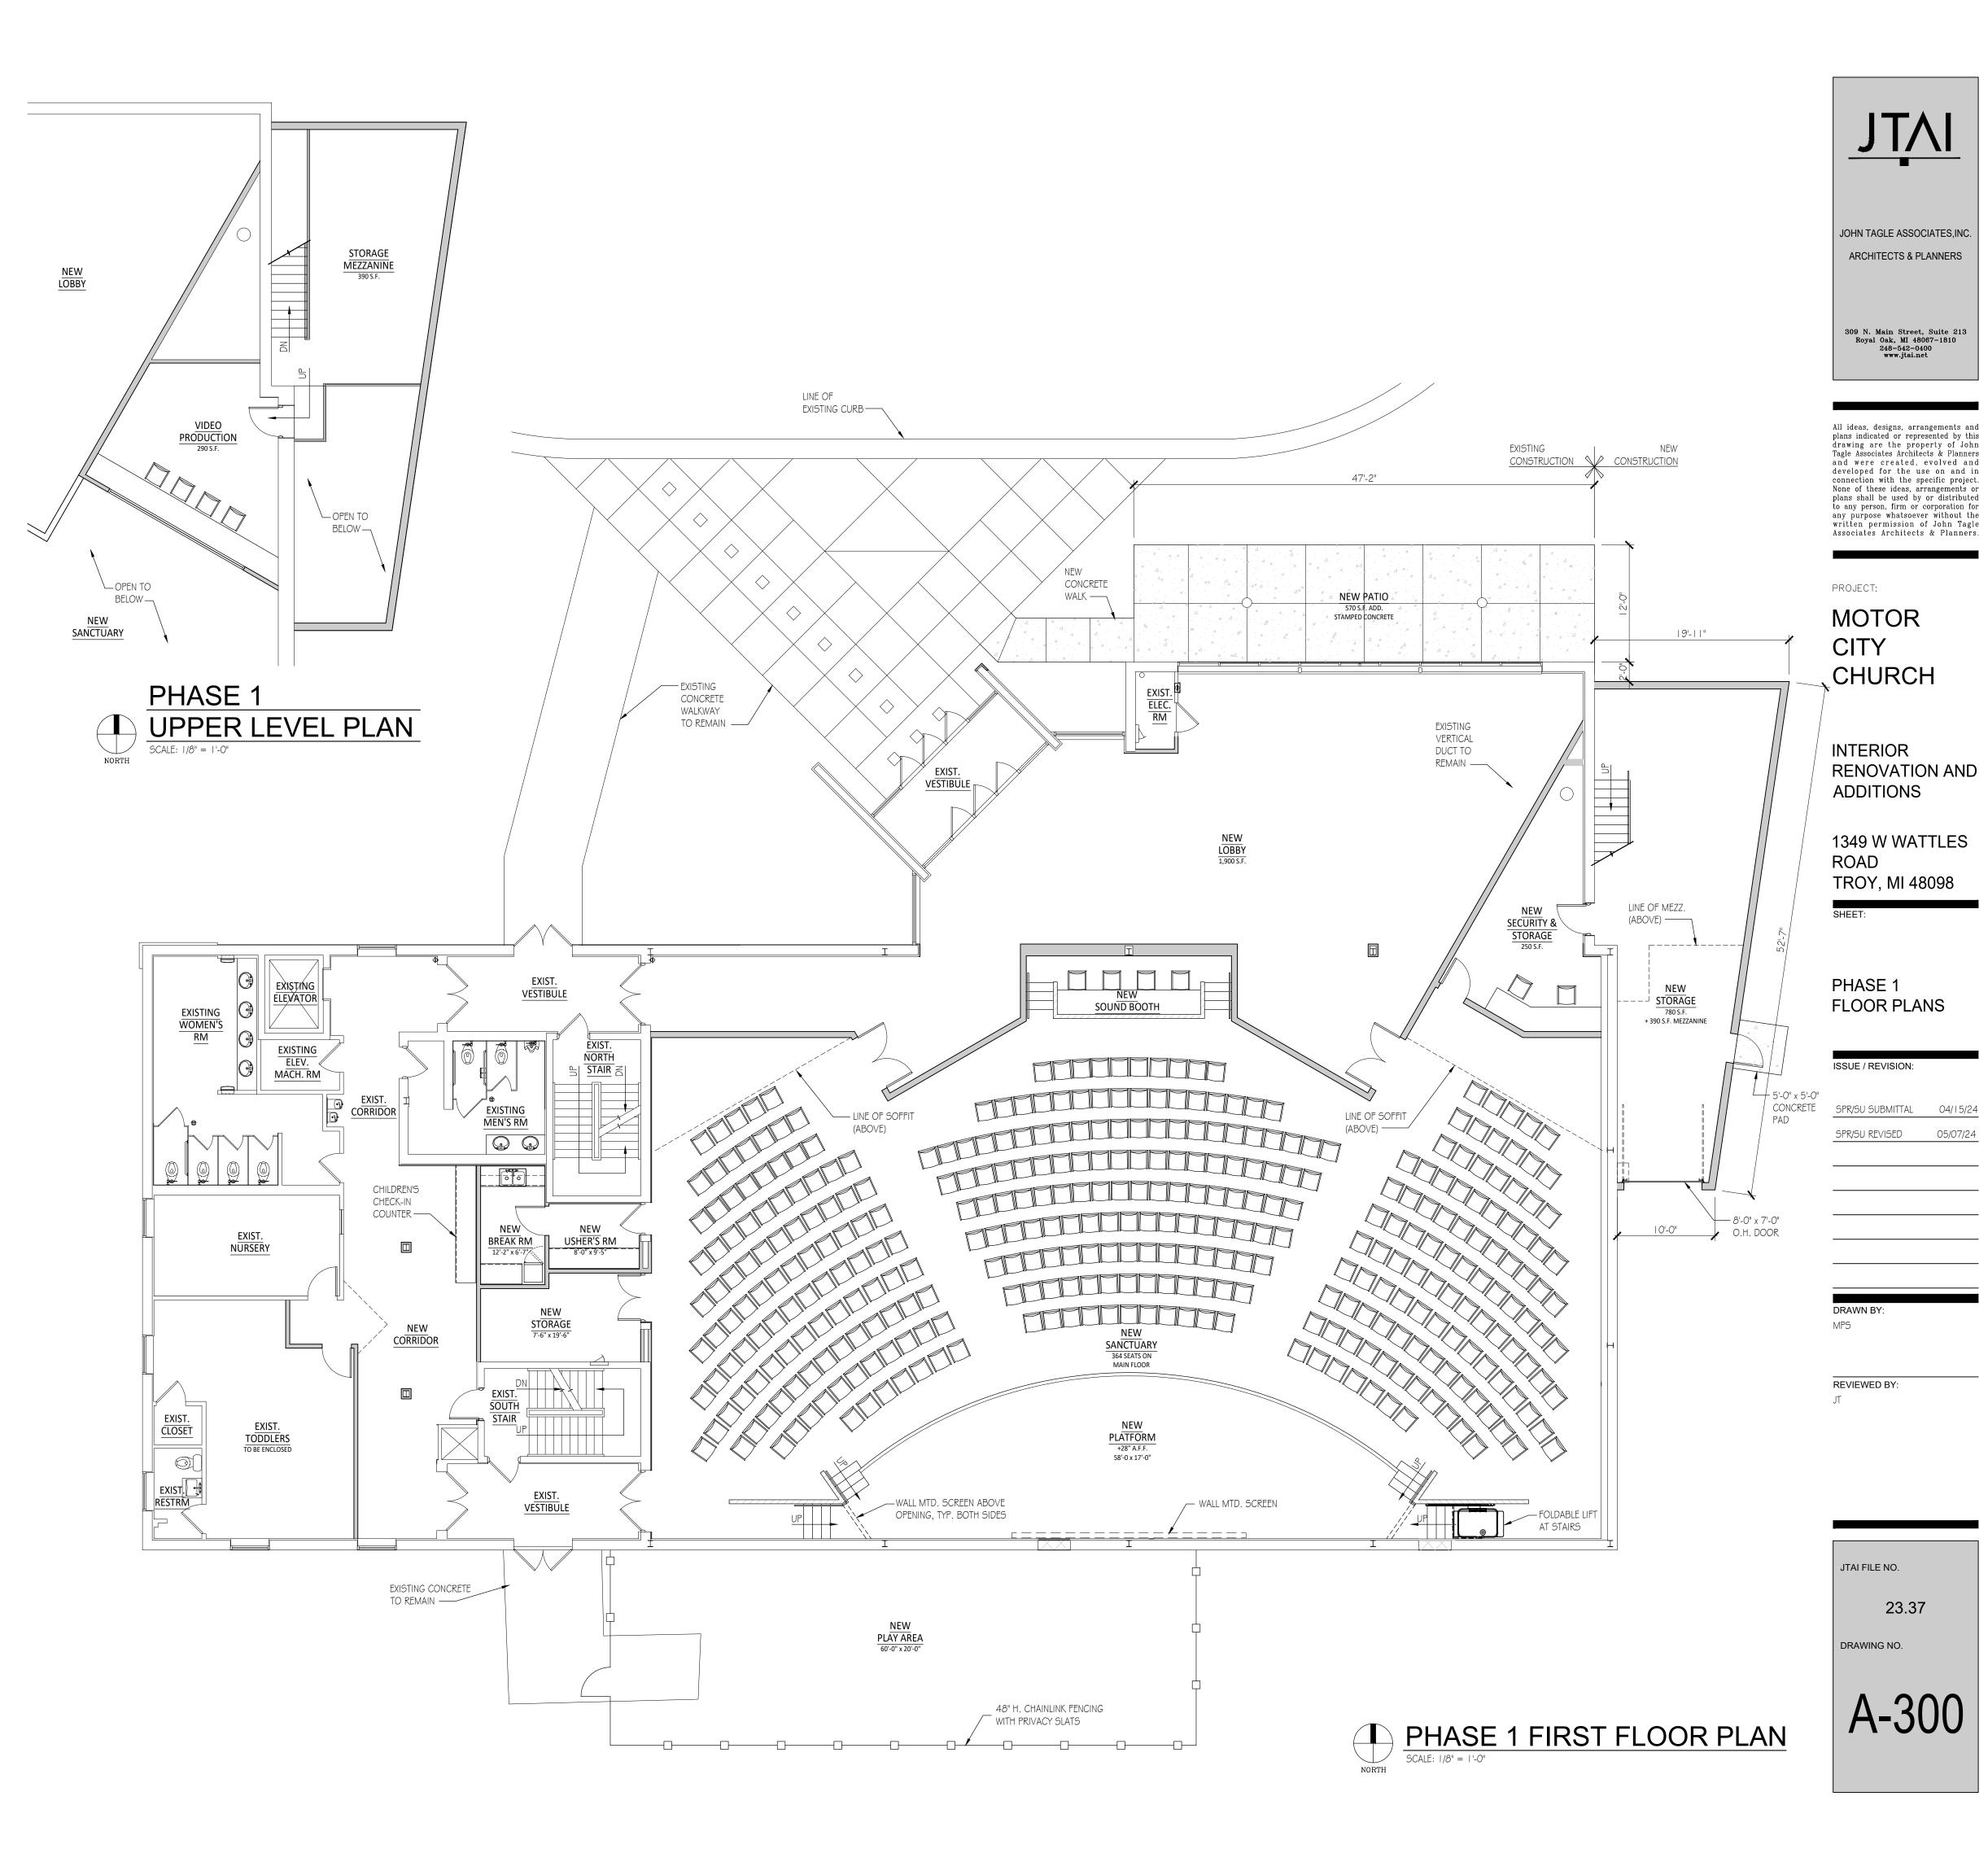

WEST EXTERIOR ELEVATION

SCALE: 1/8" = 1'-0"

MATERIAL LEGEND

C VERTICAL METAL PANELS

CURTAIN WALL SYSTEM W/I" CLEAR INSULATED GLASS IN BLACK ANODIZED ALUMINUM FRAMES.

CURTAIN WALL SYSTEM W/I" CLEAR INSULATED GLASS IN CLEAR ANODIZED ALUMINUM FRAMES.

E EXISTING BUILDING FACADE (TO BE PAINTED)

F NOT USED

G OVERHEAD DOOR (METAL)

JOHN TAGLE ASSOCIATES,INC.

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PROJECT:

MOTOR CITY CHURCH

INTERIOR RENOVATION AND **ADDITIONS**


1349 W WATTLES ROAD TROY, MI 48098

PHASE I EXTERIOR ELEVATIONS

ISSUE / REVISION:


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REVIEWED BY:

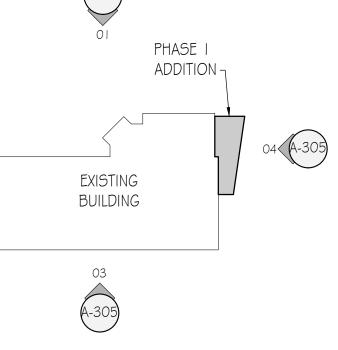

23.37 DRAWING NO.

A-305




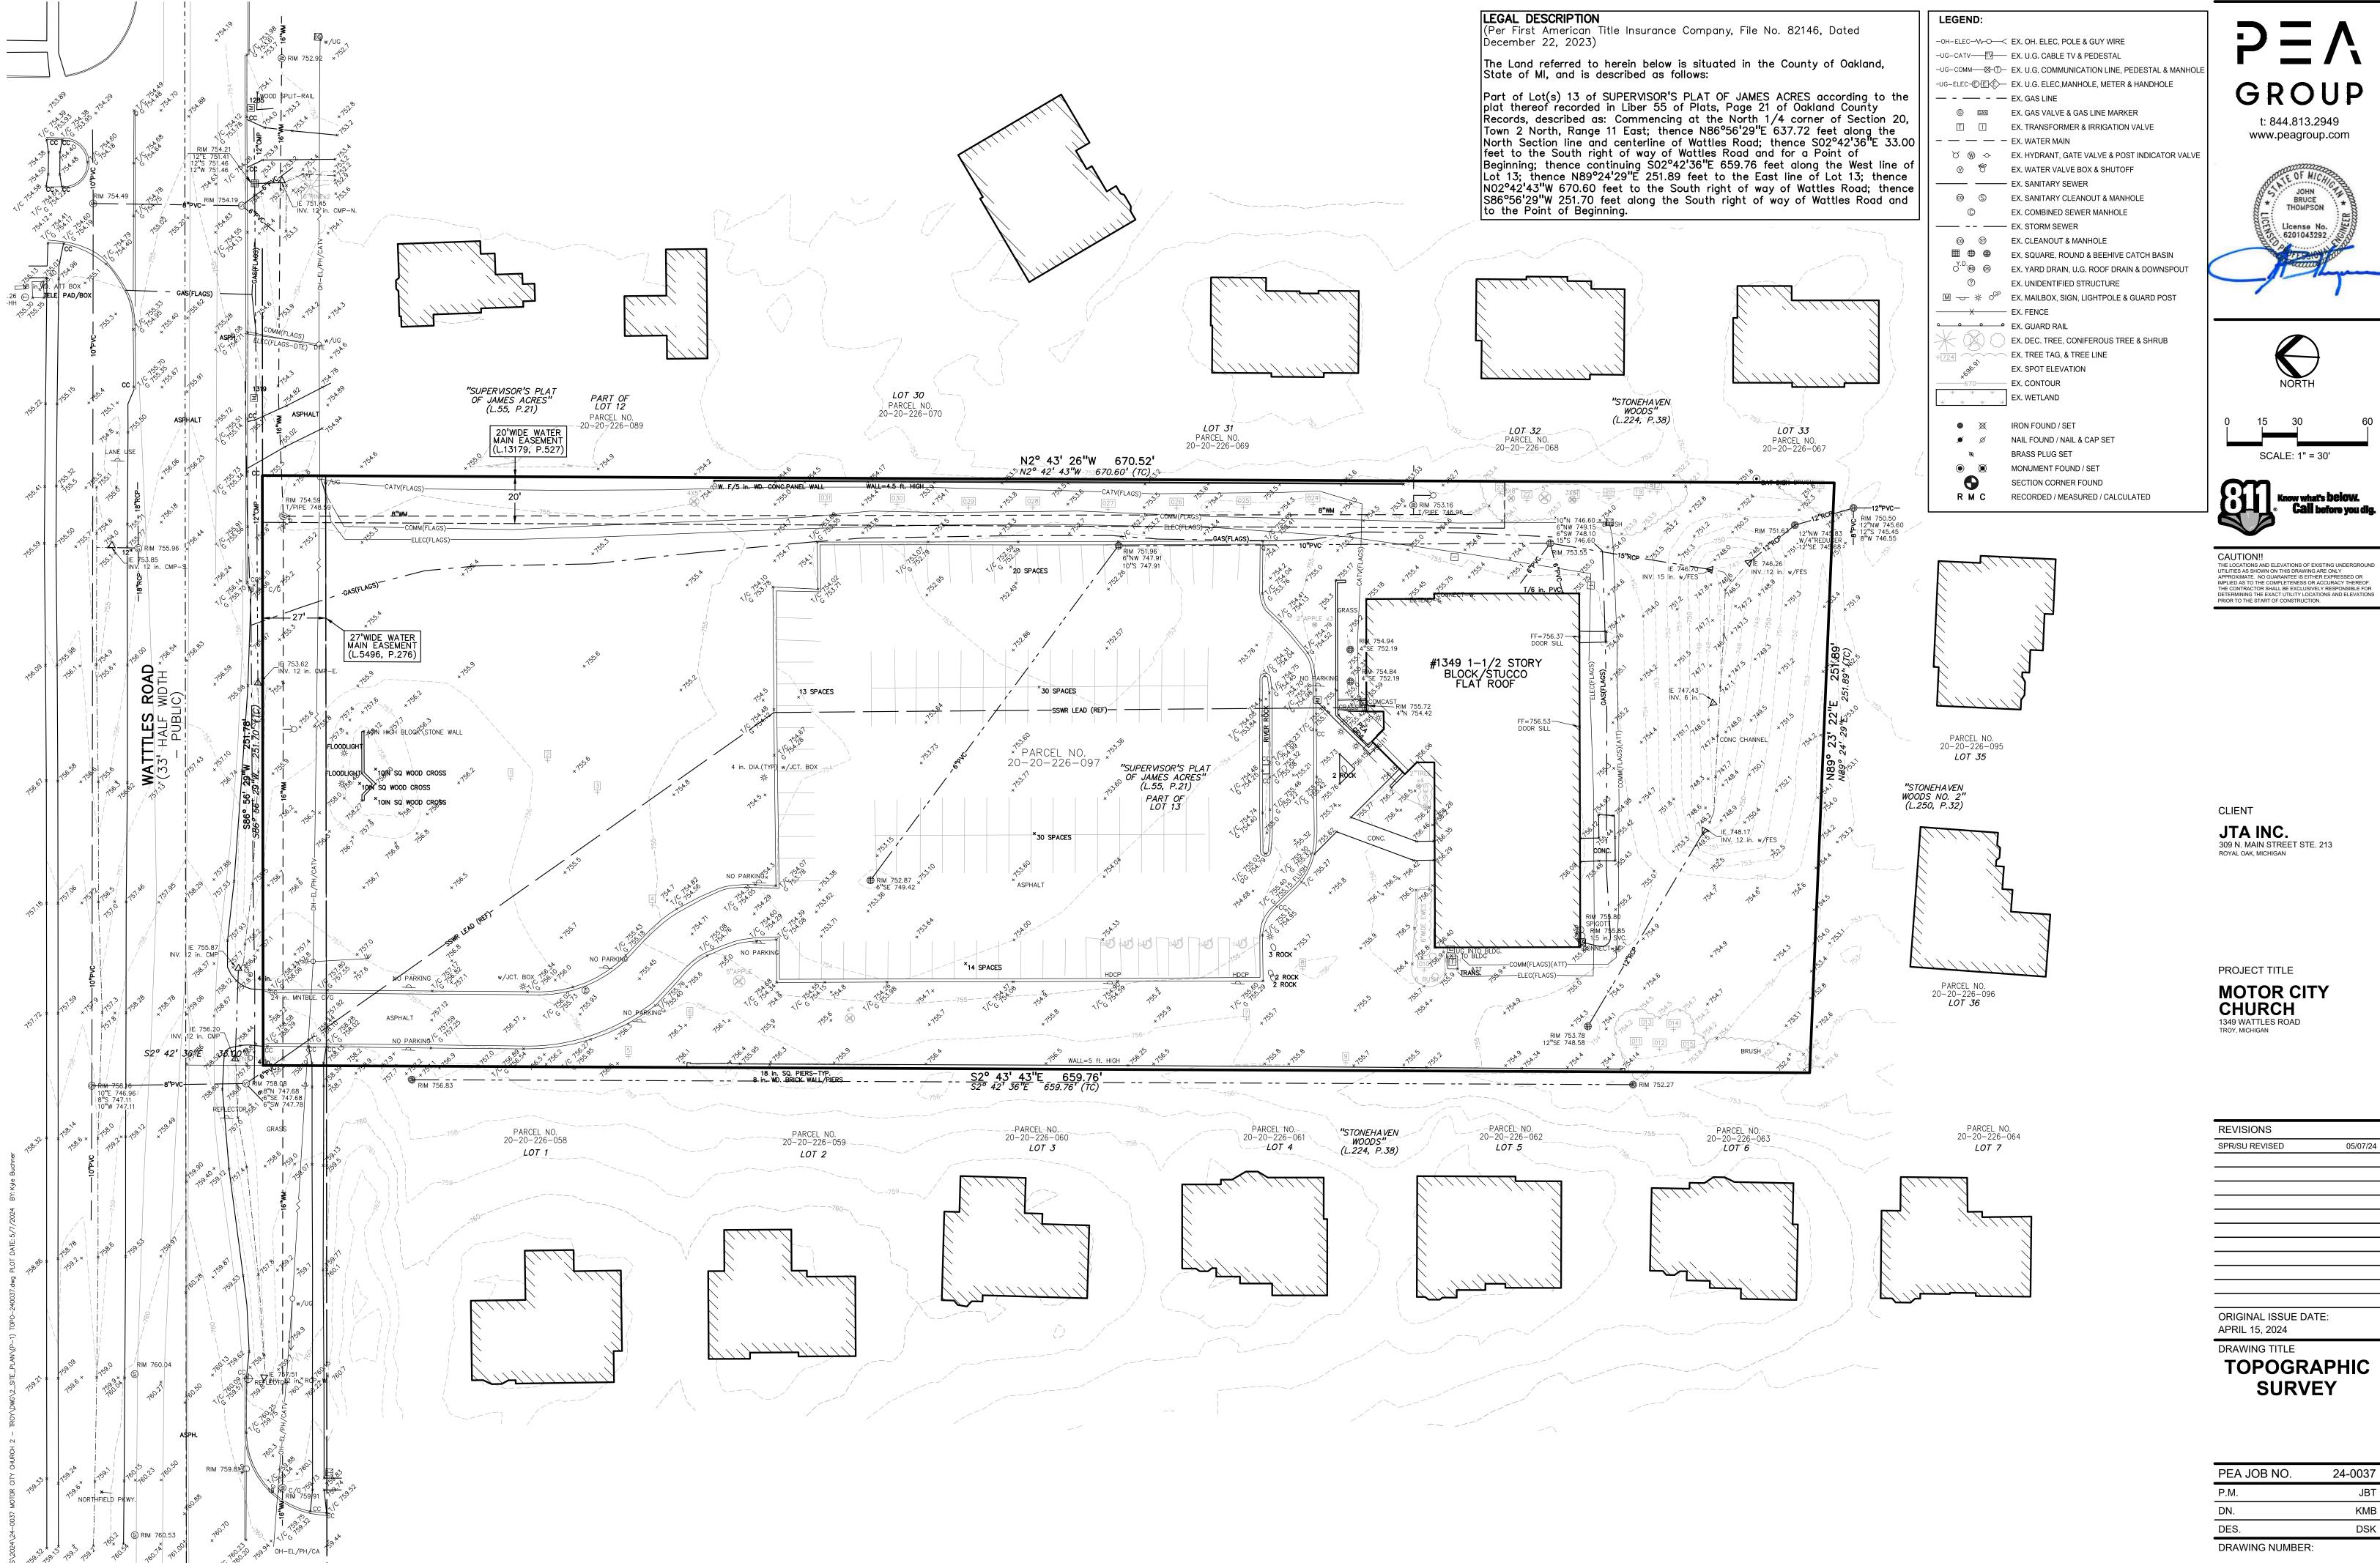





REVISIONS	
SPR/SU REVISED	05/07/24
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PEA JOB NO.	24-0037
P.M.	JBT
DN.	KMB
DES.	DSK
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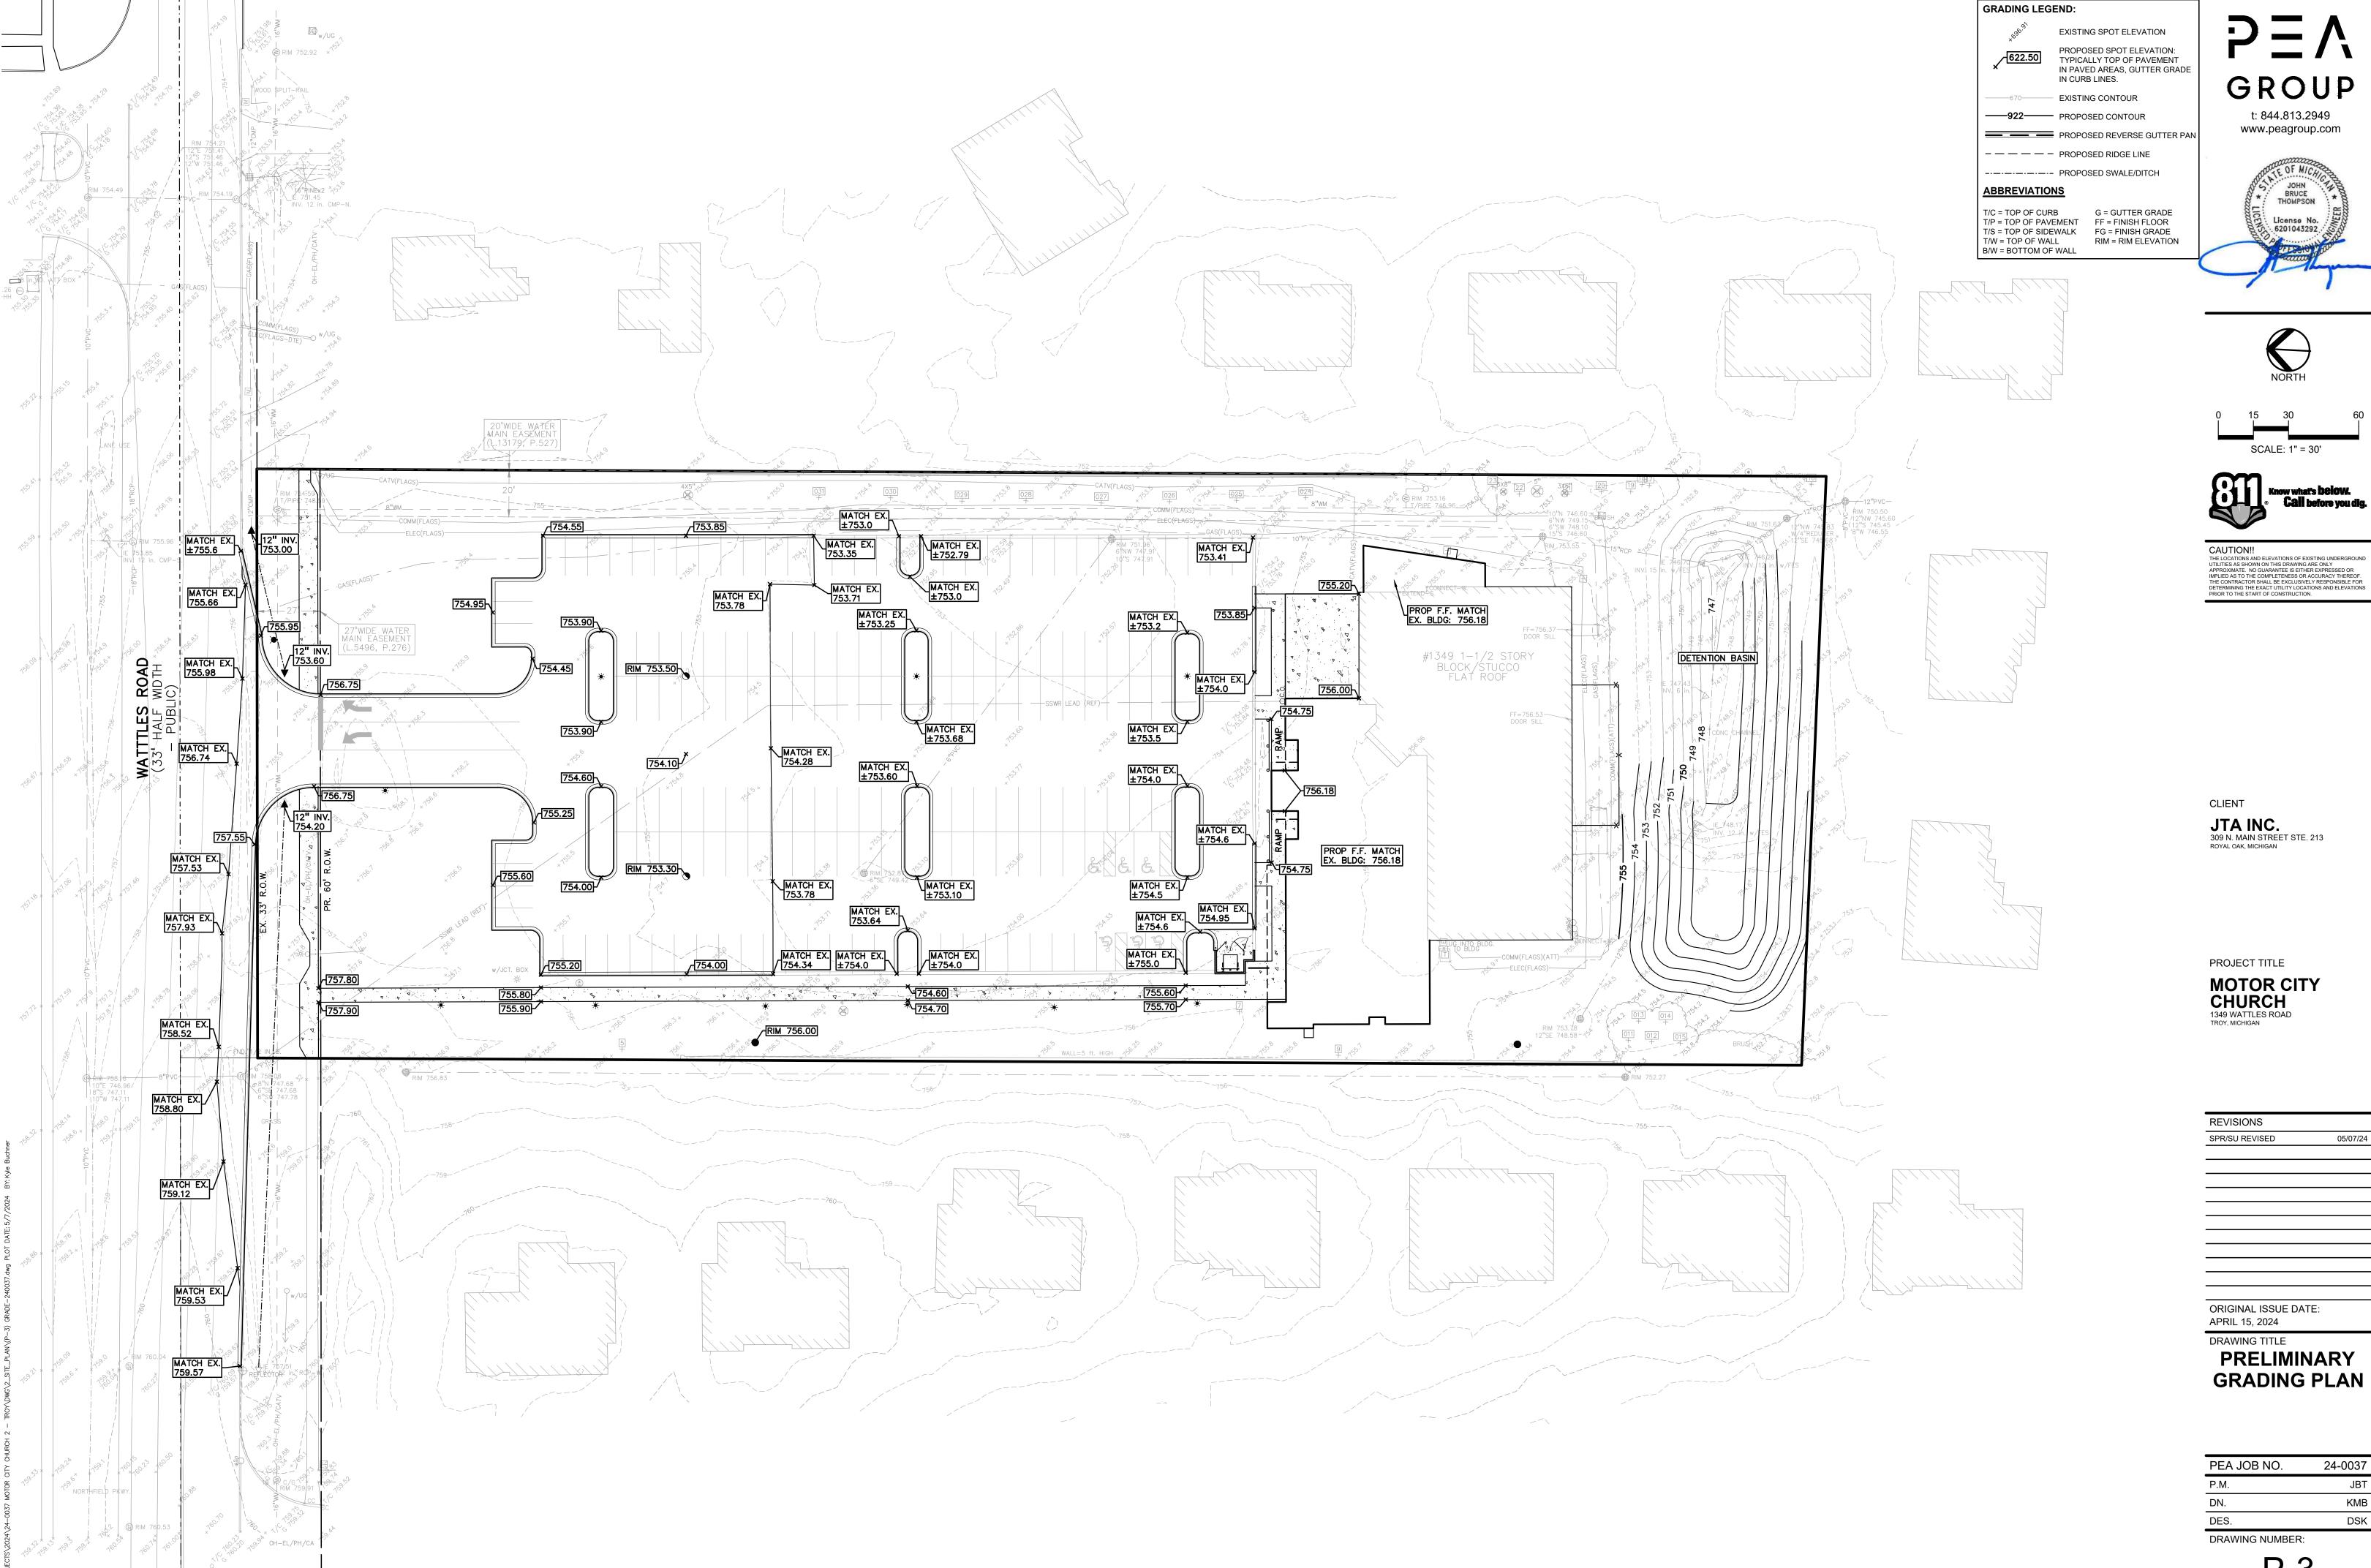
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P.M. JBT

DN. KMB

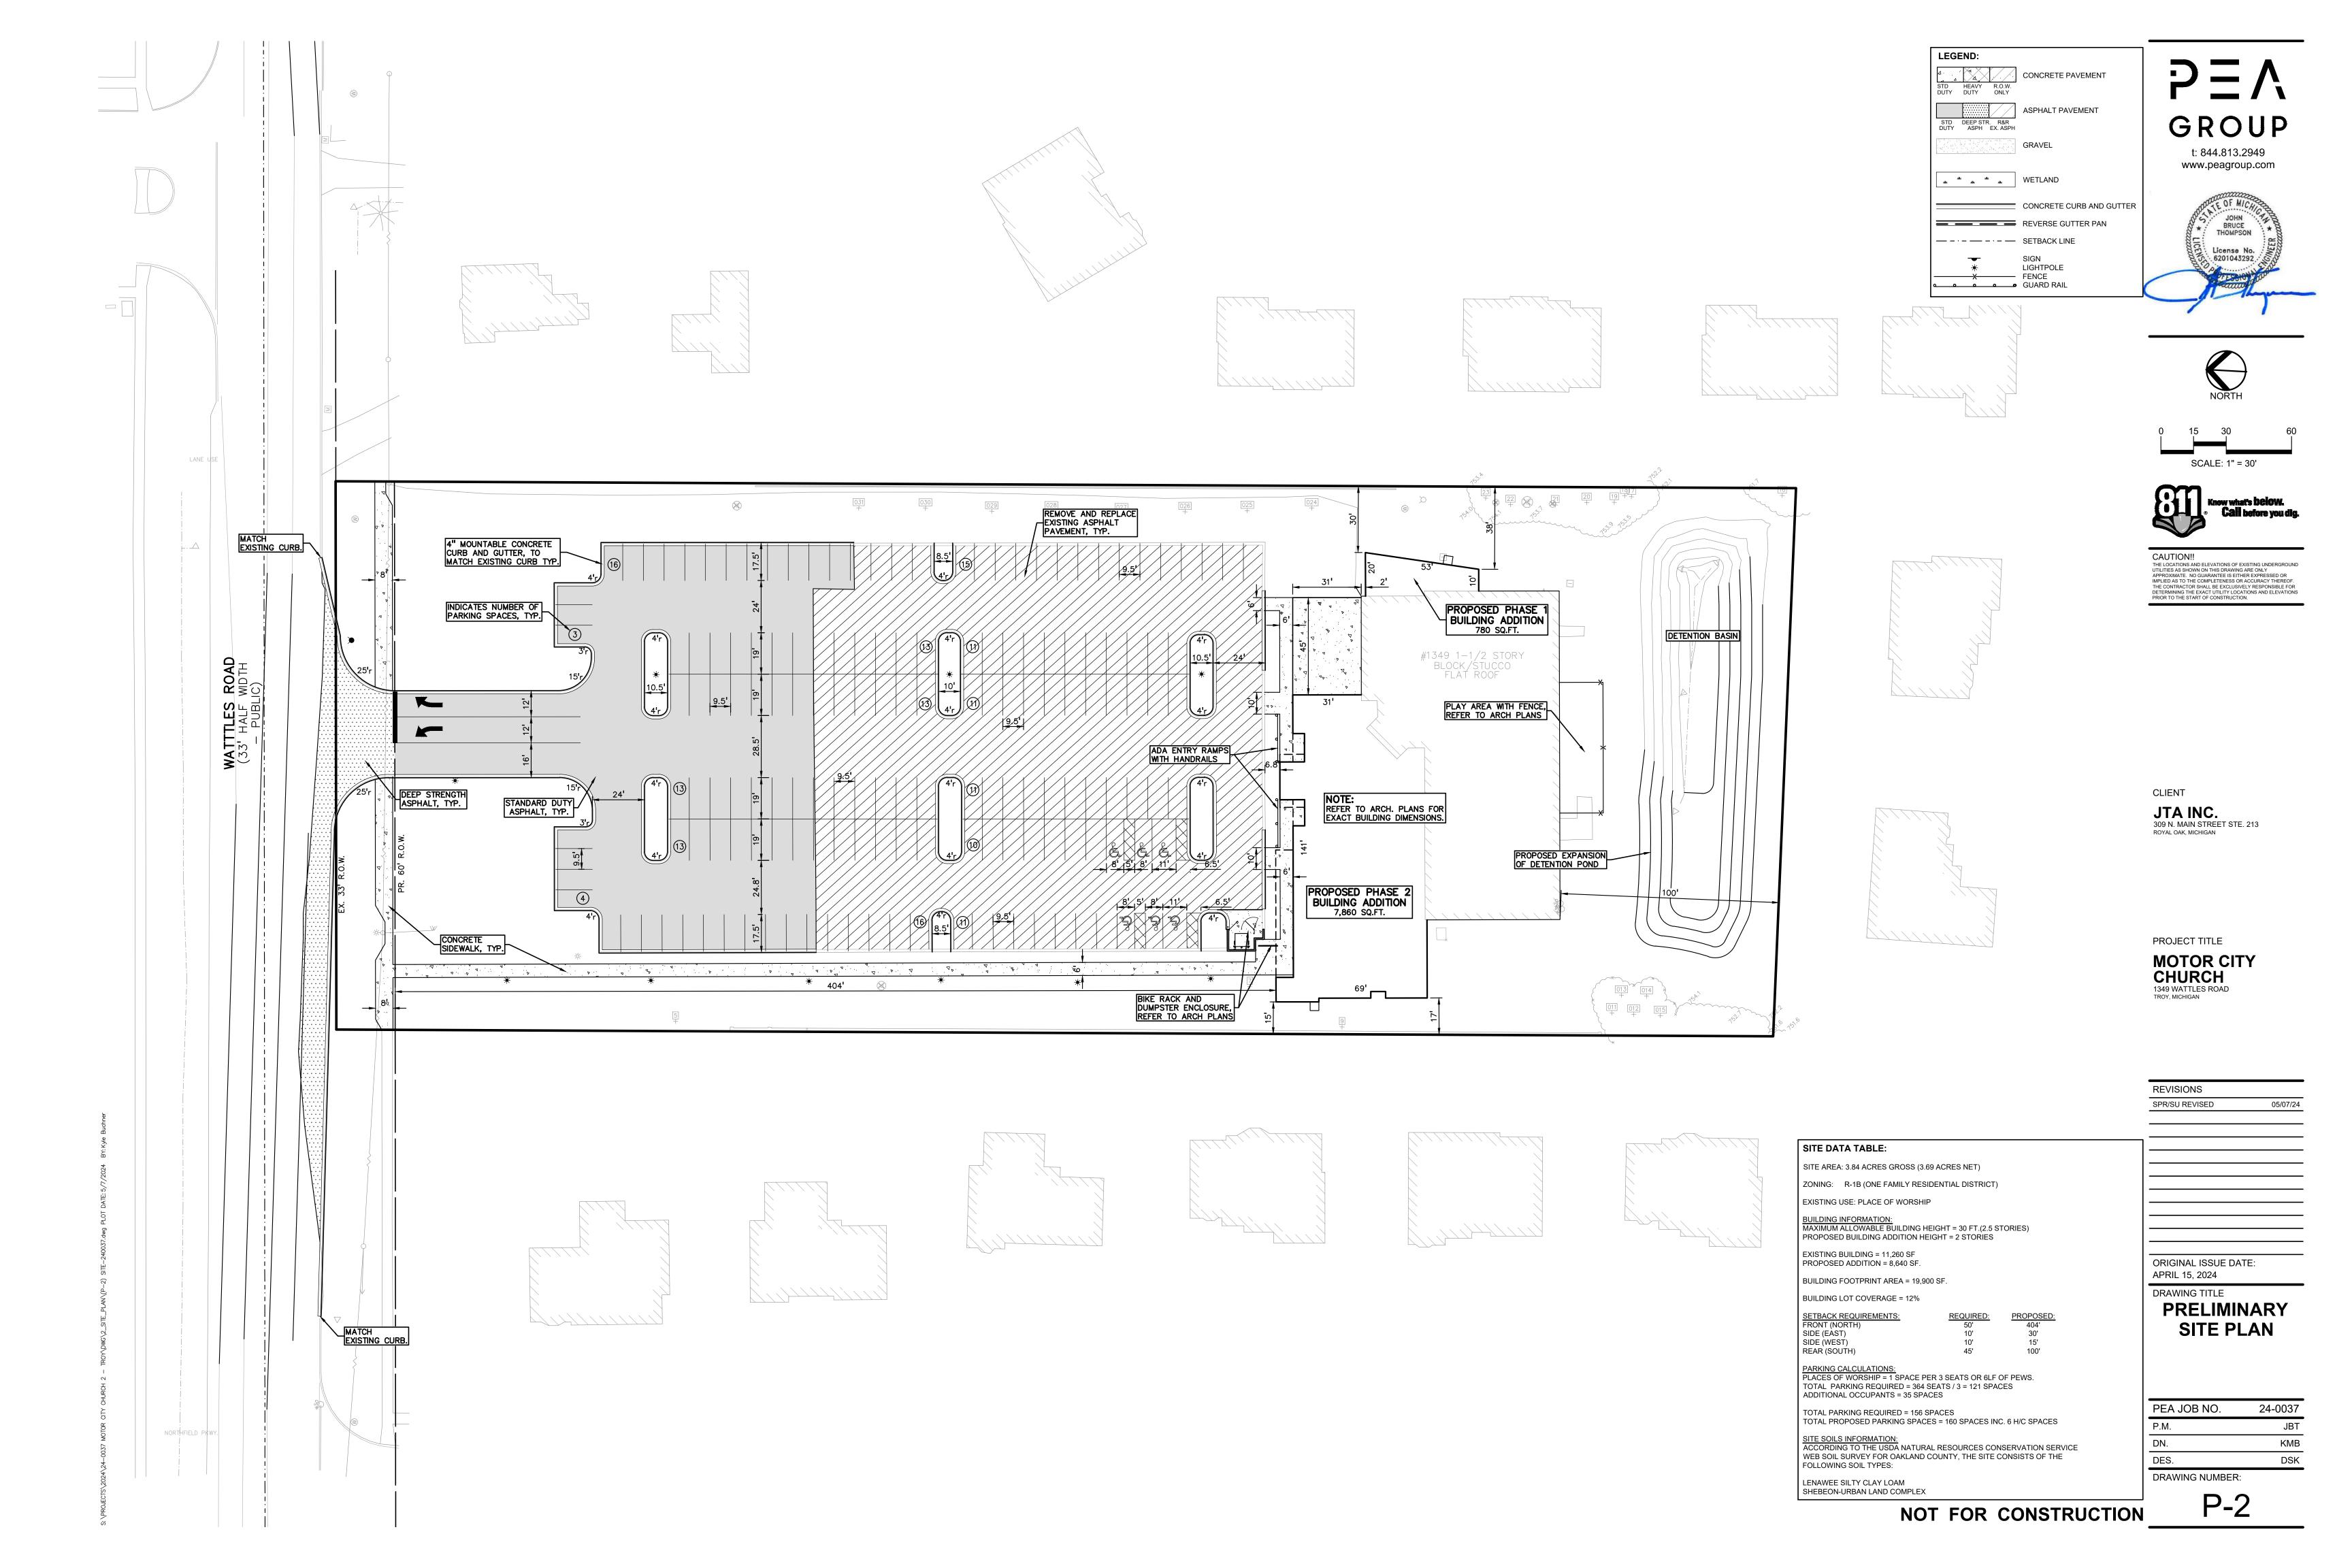DES. DSK

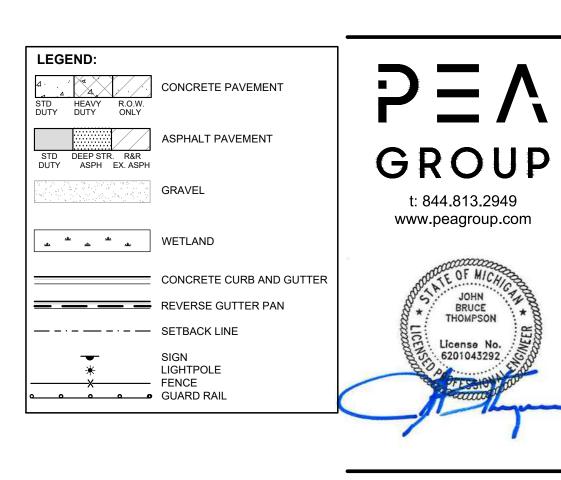DRAWING NUMBER:

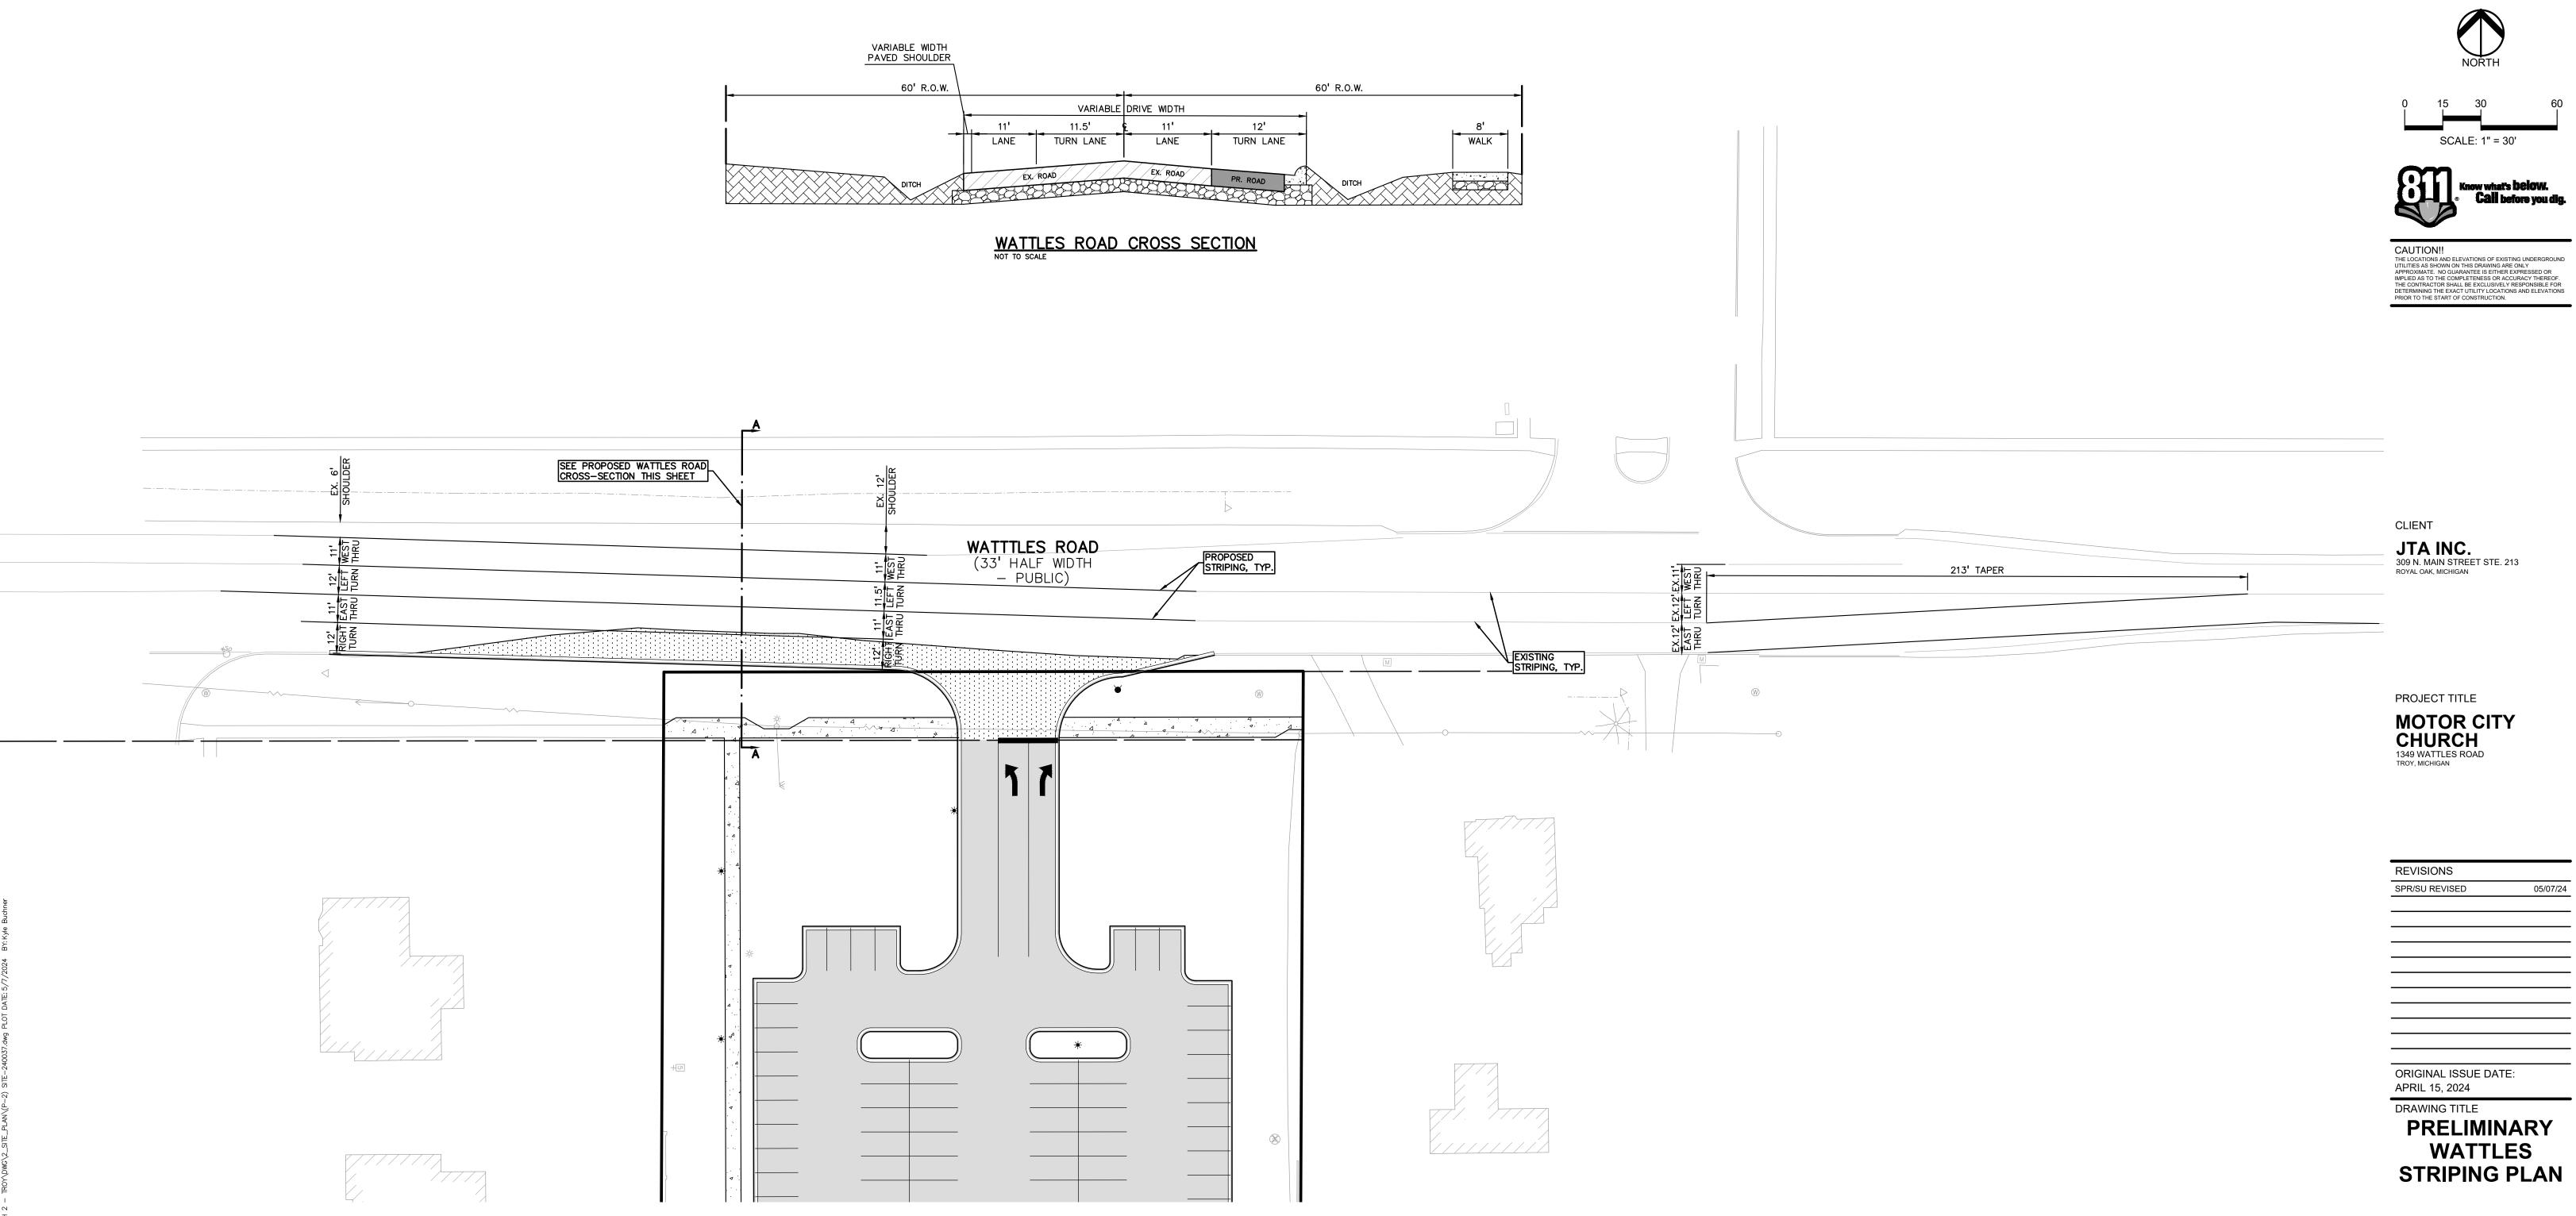









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PRELIMINARY

24-0037



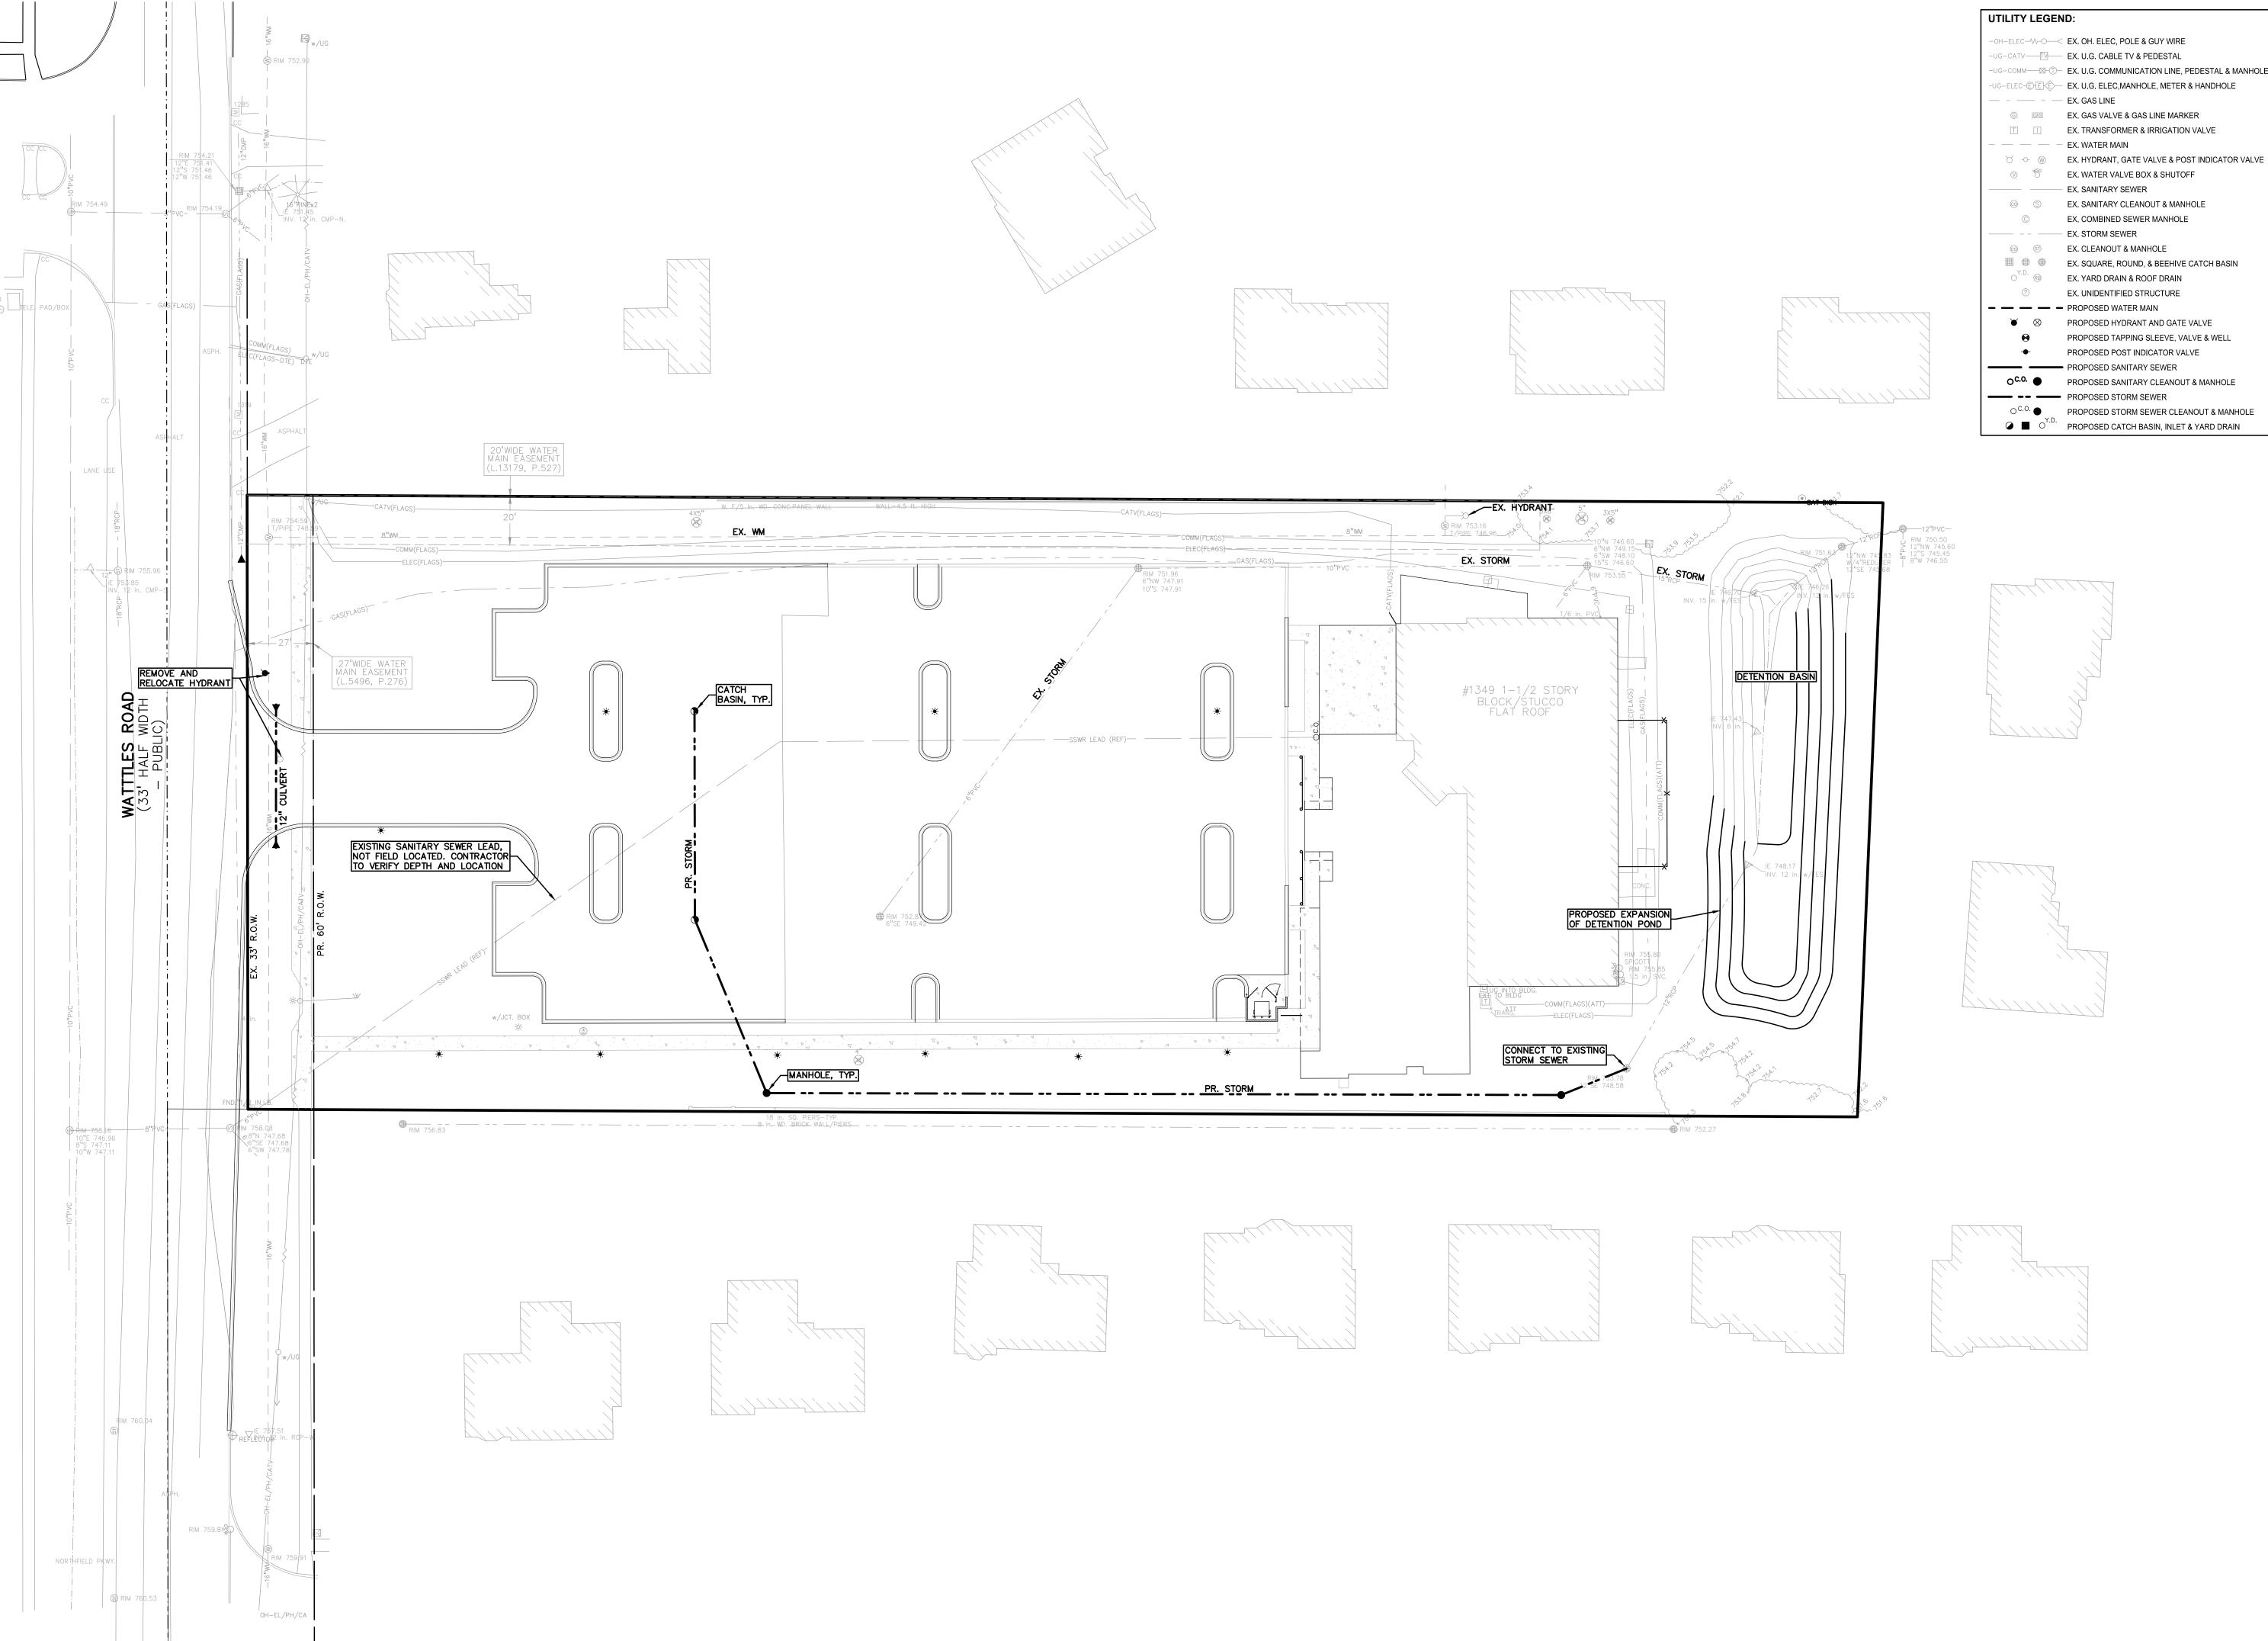

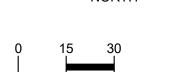GROUP

t: 844.813.2949

www.peagroup.com

SCALE: 1" = 30'



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CLIENT

JTA INC. 309 N. MAIN STREET STE. 213 ROYAL OAK, MICHIGAN

PROJECT TITLE

MOTOR CITY CHURCH 1349 WATTLES ROAD TROY, MICHIGAN


REVISIONS SPR/SU REVISED

ORIGINAL ISSUE DATE: APRIL 15, 2024

DRAWING TITLE

PRELIMINARY UTILITY PLAN

24-0037 PEA JOB NO. DSK DRAWING NUMBER:

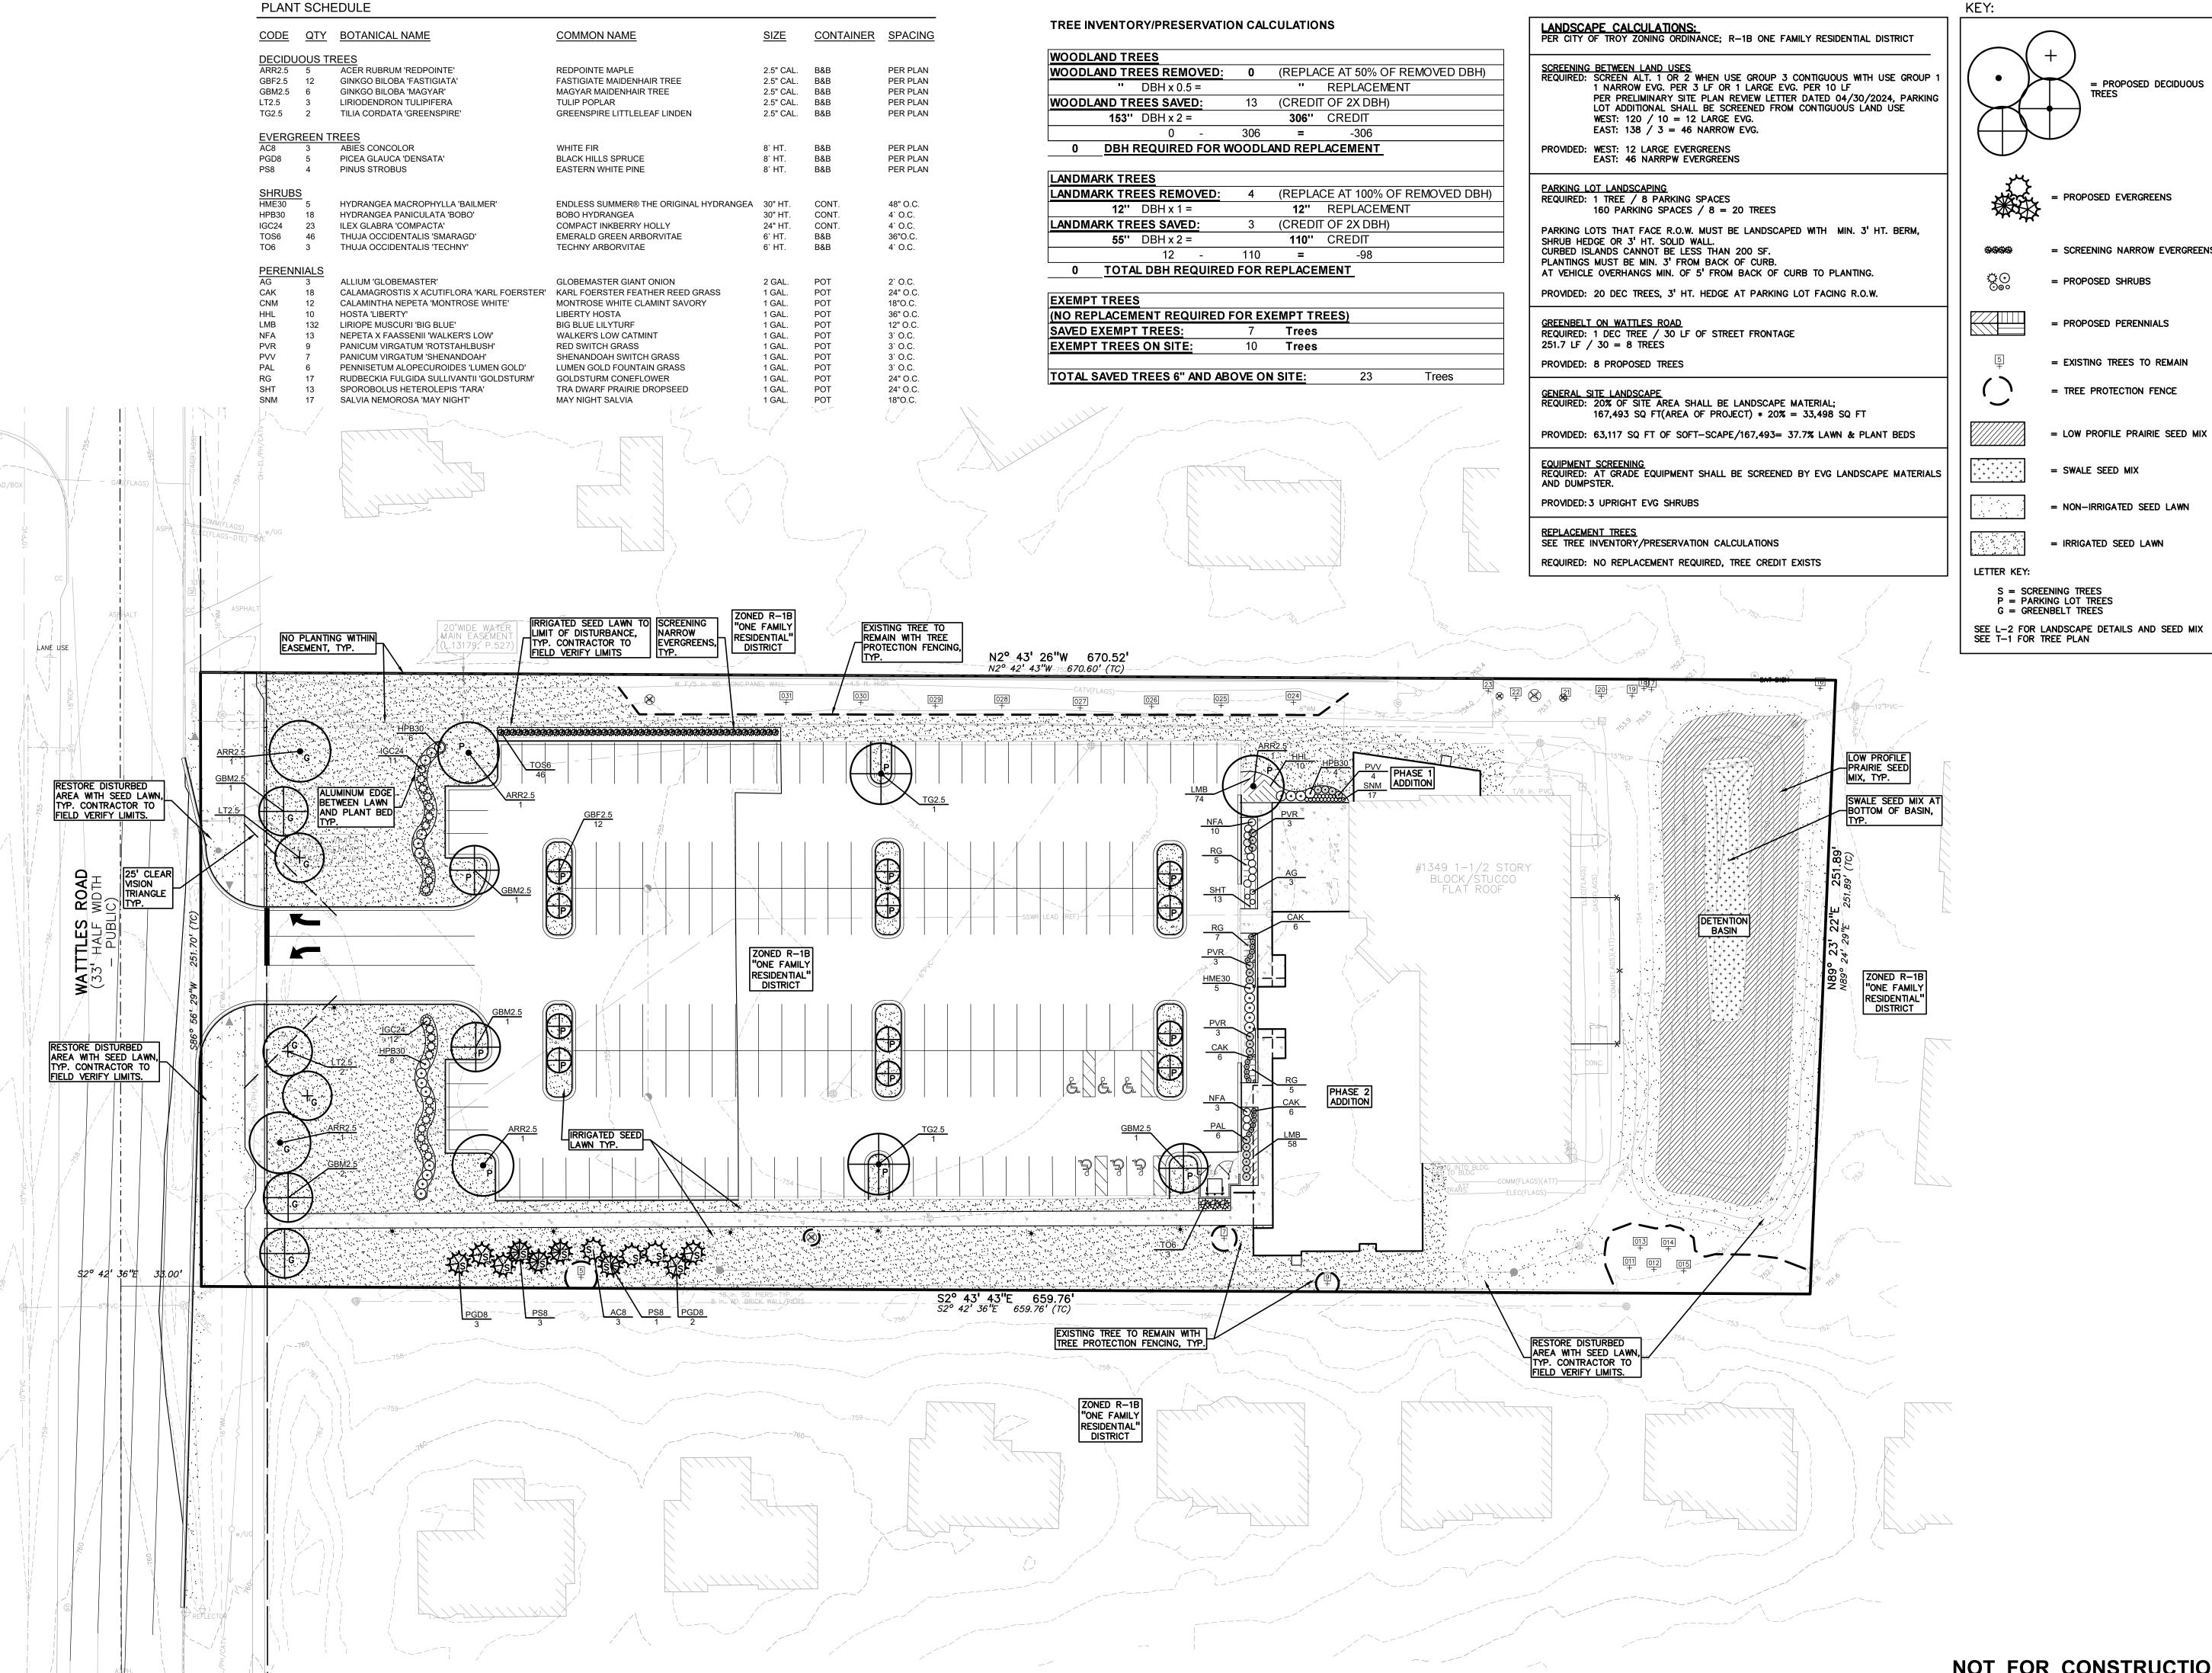

PLANT SCHEDULE

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= SCREENING NARROW EVERGREENS = PROPOSED SHRUBS

= PROPOSED PERENNIALS


= EXISTING TREES TO REMAIN = TREE PROTECTION FENCE


= SWALE SEED MIX

P = PARKING LOT TREES G = GREENBELT TREES

SEE L-2 FOR LANDSCAPE DETAILS AND SEED MIX SEE T-1 FOR TREE PLAN



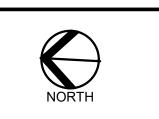

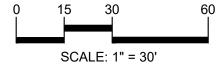



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CLIENT JTA INC. 309 N. MAIN STREET STE. 213 ROYAL OAK, MICHIGAN

PROJECT TITLE

MOTOR CITY CHURCH 1349 WATTLES ROAD TROY, MICHIGAN

REVISIONS SPR/SU REVISED

ORIGINAL ISSUE DATE:

APRIL 15, 2024 DRAWING TITLE

PRELIMINARY LANDSCAPE **PLAN**

24-0037 PEA JOB NO. DES. LAW DRAWING NUMBER:

NOT FOR CONSTRUCTION

PLAN FOR QUANTITY VARIES PER SPECIES SEE PLAN FOR QUANTITY PLANT PERENNIALS EQUAL DISTANCE IN ALL DIRECTIONS ALL SPACING IS TO BE TRIANGULAR UNLESS NOTED OR GRAPHICALLY SHOWN OTHERWISE PLAN VIEW 3" SHREDDED BARK MULCH. DO NOT PILE MULCH AGAINST PLANT STEMS SHOVEL CUT EDGE OR ALUMINUM EDGING AS INDICATED ON PLAN - SPECIFIED PLANTING MIX NOTE: REMOVE ALL CONTAINERS PRIOR TO PLANTING SECTION VIEW PERENNIAL PLANTING DETAIL

PLANT SO THAT TOP OF ROOT BALL IS

FLUSH TO GRADE OR 1-2" HIGHER IF

SHREDDED HARDWOOD BARK MULCH 3"

DEEP AND LEAVE 3" CIRCLE OF BARE

SPECIFIED PLANTING MIX. WATER AND

REMOVE ALL BURLAP FROM TOP $\frac{1}{3}$ OF

NON-BIODEGRADABLE MATERIAL OFF SITE

_ PLACE ROOTBALL ON UNEXCAVATED OR

FINISH GRADE

TAMP TO REMOVE AIR POCKETS

-ROOTBALL. DISCARD ALL

SOIL AROUND TRUNK DO NOT PLACE

MULCH IN CONTACT WITH TRUNK

DO NOT COVER TOP OF ROOTBALL

IN POORLY DRAINED SOILS

FORM SAUCER WITH 4" HIGH

WITH SOIL

- FINISH GRADE

CONTINUOUS RIM

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CLIENT JTA INC. 309 N. MAIN STREET STE. 213

ROYAL OAK, MICHIGAN

PROJECT TITLE **MOTOR CITY**

CHURCH

1349 WATTLES ROAD

REVISIONS SPR/SU REVISED 05/07/24

ORIGINAL ISSUE DATE: APRIL 15, 2024

DRAWING TITLE

LANDSCAPE

24-0037 PEA JOB NO. P.M. JBT ΒZ DN. DES. LAW DRAWING NUMBER:

Swale Seed Mix Stantec Native Plant Nursery 574-586-2412 stantec.com/native-plant-nursery Botanical Name Common Name

Permanent Grasses/Sedges: Andropogon gerardii Big Bluestem Carex comosa Bristly Sedge Carex cristatella Crested Oval Sedge Bottlebrush Sedge Carex lurida Prairie Sedge Mix Carex spp. Carex vulpinoidea Brown Fox Sedge Elymus virginicus Virginia Wild Rye Glyceria striata Fowl Manna Grass Switch Grass Panicum virgatum Dark Green Rush Scirpus atrovirens Wool Grass Scirpus cyperinus Spartina pectinata Prairie Cord Grass

Temporary Cover: Common Oat Avena sativa Lolium multiflorum Annual Rye

Forbs: Alisma spp. Water Plantain (Various Mix) Asclepias incarnata Swamp Milkweed Coreopsis tripteris Tall Coreopsis Eutrochium maculatum Spotted Joe-Pye Weed Iris virginica Blue Flag Marsh Blazing Star Liatris spicata Cardinal Flower Lobelia cardinalis Lobelia siphilitica Great Blue Lobelia Common Water Horehound Lycopus americanus Pycnanthemum virginianum Common Mountian Mint Rudbeckia triloba Brown-Eyed Susan Sagittaria latifolia Common Arrowhead Senna hebecarpa Wild Senna Silphium terebinthinaceum Prairie Dock Symphyotrichum novae-anglia New England Aster Verbena hastata Blue Vervain Zizia aurea Golden Alexanders

FOR ALL SEED MIXES, PROVIDE EROSION MAT ON SLOPES AND AREAS OF WASH OUT TYP. INSTALL AND PREP PER MANUFACTURES SPECIFICATIONS.

NATIVE SEED MIX, BY STANTEC NATIVE PLANT NURSERY, 574-586-2412, OR EQUAL SPECIES TO BE NATIVE TO COUNTY, NO INVASIVE SPECIES ALLOWED FOR ALL SEED MIXES, PROVIDE EROSION MAT ON SLOPES AND AREAS OF WASH OUT TYP. INSTALL AND PREP PER MANUFACTURES SPECIFICATIONS.

Low-profile Prairie Seed Mix Stantec Native Plant Nursery 574-586-2412 stantec.com/native-plant-nursery

Common Name

Prairie Carex Mix

Canada Wild Rye

June Grass

Switch Grass

Common Oat

Annual Rye

Lead Plant

ThimbleWeed

Common Milkweed

Botanical Name Permanent Grasses: Bouteloua curtipendula Carex spp.

Side Oats Grama Elymus canadensis Koeleria pyramidata Panicum virgatum Schizachyrium scoparium Little Bluestem

Temporary Cover: Avena sativa Lolium multiflorum

Amorpha canescens Anemone cylindrica Asclepias syriaca Asclepias tuberosa Baptisia alba Chamaecrista fasciculata Coreopsis lanceolata Coreopsis palmata Dalea candida Dalea purpurea Desmanthus illinoensis Echinacea purpurea Eryngium yuccifolium Lespedeza capitata Liatris aspera Lupinus perennis Monarda fistulosa Oligoneuron rigidum Parthenium integrifolium Penstemon digitalis Penstemon hirsutus Pycnanthemum virginianum

Ratibida pinnata

Rudbeckia hirta

Solidago speciosa

Symphyotrichum laeve

Tradescantia ohiensis

Veronicastrum virginicum

Verbena stricta

Vernonia spp.

Rudbeckia subtomentosa

Butterfly MilkWeed White Wild Indigo Partridge Pea Sand Coreopsis Prairie Coreopsis White Prairie Clover Purple Prairie Clover Illinois Sensitive Plant Broad-Leaved Purple Coneflower Rattlesnake Master Round-Head Bush Clover Rough Blazing Star Wild Lupine Wild Bergamot Stiff Goldenrod Wild Quinine Foxglove Beard Tongue Hairy Beard Tongue Common Mountain Mint Yellow Coneflower Black-Eyed Susan Sweet Black-Eyed Susan Silphium terebinthinaceum Prairie Dock Showy Goldenrod Symphyotrichum ericoides Heath Aster Smooth Blue Aster Symphyotrichum novae-angliae New England Aster Common Spiderwort Hoary Vervain Ironweed (Various Mix) Culvers Root

TREE PROTECTION WILL BE ERECTED PRIOR TO START OF CONSTRUCTION ACTIVITIES AND SHALL REMAIN IN PLACE UNTIL CONSTRUCTION IS COMPLETE NO PERSON MAY CONDUCT ANY ACTIVITY

WITHIN THE DRIP LINE OF ANY TREE CRITICAL DESIGNATED TO REMAIN; INCLUDING, BUT ROOT ZONE NOT LIMITED TO PLACING SOLVENTS, BUILDING MATERIAL, CONSTRUCTION EQUIPMENT OR SOIL DEPOSITS WITHIN DRIP GRADE CHANGES MAY NOT OCCUR WITHIN THE DRIP LINE OF PROTECTED TREES

FENCE

DURING CONSTRUCTION, NO PERSON SHALL ATTACH ANY DEVICE OR WIRE TO ANY REMAINING TREE ALL UTILITY SERVICE REQUESTS MUST INCLUDE NOTIFICATION TO THE INSTALLER THAT PROTECTED TREES MUST BE AVOIDED. ALL TRENCHING SHALL OCCUR OUTSIDE OF

PERMALOC ALUMINUM EDGING OR APPROVED

EQUAL WITH BLACK FINISH

- COMPACTED SUBGRADE

LANDSCAPE BED EDGING SHALL BE ALUMINUM AS MANUFACTURED BY

8' OR 16' SECTIONS SHALL BE USED WITH ONE STAKE PER 38" OF

EDGING SHALL BE 3" THICK X 4" DEPTH WHEN ADJ. TO MULCH AND

3" THICK X 5 3" DEPTH WHEN ADJ. TO ROCK, FINISH: BLACK

STAKE SHALL SECURELY ENGAGE EDGING AND SHALL BE ENTIRELY

EDGING SHALL HAVE A MINIMUM OF 2" OF INTERLOCKING OVERLAP

INSTALL AS PER MANUFACTURER'S SPECIFICATIONS WITH TOP OF

EDGING $\frac{1}{4}$ " - $\frac{1}{2}$ " ABOVE COMPACTED FINISH GRADE. FINISH GRADE TO

BE COMPACTED ON BOTH SIDES OF EDGING TO MAINTAIN STABILITY

-BED MEDIA

SPECIFICATIONS FOR LANDSCAPE BED EDGING:

PERMALOC 1.800.356.9660

DURAFLEX MEETING AAMA 2603

BELOW TOP SURFACE OF EDGING

BETWEEN SECTIONS

ALUMINUM EDGE DETAIL

SCALE: 1/2'' = 1'-0''

THE PROTECTIVE FENCING TREES LOCATED ON ADJACENT PROPERTY THAT MAY BE AFFECTED BY CONSTRUCTION ACTIVITIES MUST BE PROTECTED TREES TO BE PRESERVED SHALL BE IDENTIFIED WITH FLAGGING PRIOR TO THE

TREE CLEARING OPERATIONS PROVIDE FENCE AROUND CRITICAL ROOT ZONE OF TREE FENCE SHALL BE PLACED IN A CIRCLE WITH A MINIMUM RADIUS OF 1' PER 1" DIAMETER OF THE TREE MEASURED AT 4.5' ABOVE GROUND

4'HIGH PROTECTIVE FENCING WITH STEEL POSTS - 10' O.C. - EXISTING SOIL

TREE PROTECTION DETAIL SCALE: 1'' = 3'-0''

VARIES ON CONTAINER OR BALL SIZE SHRUB PLANTING DETAIL SCALE: 1'' = 2'-0''

SCALE: 1'' = 2' - 0''

PLANT SO THAT TOP OF ROOT BALL IS FLUSH TO GRADE OR 1-2" HIGHER IF IN POORLY DRAINED SOILS SECURE TREE WRAP WITH BIODEGRADABLE MATERIAL AT TOP & BOTTOM, REMOVE AFTER FIRST WINTER DO NOT PRUNE TERMINAL LEADER PRUNE ONLY DEAD, BROKEN BRANCHES AS DIRECTED BY LANDSCAPE ARCHITECT STAKE JUST BELOW BRANCHES WITH 2"-3" WIDE NYLON OR PLASTIC STRAPS. CONNECT FROM TREE TO STAKE AND ALLOW FOR FLEXIBILITY. REMOVE AFTER (1) ONE YEAR. (DO NOT USE WIRE & HOSE) (3) THREE 2"X2" HARDWOOD STAKES DRIVEN A MIN. OF 18" DEEP FIRMLY INTO

SUBGRADE PRIOR TO BACKFILLING 120 SHREDDED HARDWOOD BARK MULCH TO DRIPLINE. 3" DEEP AND LEAVE 3" CIRCLE OF BARE SOIL AROUND TREE TRUNK. DO NOT <u>STAKING/GUYING</u> PLACE MULCH IN CONTACT WITH TREE <u>LOCATION</u> TRUNK. FORM SAUCER WITH 4" HIGH CONTINUOUS RIM

SPECIFIED PLANTING MIX, WATER & TAMP TO -REMOVE AIR POCKETS, AMEND SOIL PER SITE CONDITIONS & TREE REQUIREMENTS

DECIDUOUS TREE PLANTING DETAIL

EXPOSE ROOT FLARE OF TREE. CONTRACTOR MAY HAVE TO REMOVE EXCESS SOIL FROM — TOP OF ROOTBALL. REMOVE ALL BURLAP FROM TOP 3 OF ROOTBALL. DISCARD ALL NON-BIODEGRADABLE MATERIAL OFF SITE PLACE ROOTBALL ON UNEXCAVATED OR MIN. TYP.

SCALE: 1'' = 3'-0''

NOT FOR CONSTRUCTION

AG	CODE	DBH	COMMON NAME	LATIN NAME	COND	COMMENTS	CLASS	SAVE / REMOVE	ON-SITE	REPLACE
4	ŦĦ	7X8	Thornapple/Hawthorne	Cragaegus spp.	₽		LANDMARK	R	¥	REPLA CE
2	ŦĦ	12	Thornapple/Hawthorne	Cragaegus spp.	G		LANDMARK	R	¥	REPLA CE
3	CA	10X3	Crab Apple	Malus caronaria	₽		LANDMARK	R	¥	REPLA CE
4	CA	9X4	Crab Apple	Malus caronaria	₽		LANDMARK	R	¥	REPLA CE
5	RM	30	Red Maple	Acer rubrum	F		LANDMARK	S	Υ	-
6	NM	8	Norway Maple	Acer platanoides	G		INVASIVE	R	¥	-
7	NM	7	Norway Maple	Acer platanoides	F		INVASIVE	S	Υ	-
8	NM	8	Norway Maple	Acer platanoides	G		INVASIVE	R	¥	-
9	В	25	Basswood	Tilia americana	Р		LANDMARK	S	Υ	-
10	MM	17	Norway Maple	Acer platanoides	G		INVASIVE	₽	¥	-
11	BS	11	Blue Spruce	Picea pungens	Р		WOODLAND	S	Υ	-
12	BS	8	Blue Spruce	Picea pungens	Р		WOODLAND	S	Υ	-
13	BS	10	Blue Spruce	Picea pungens	F		WOODLAND	S	Υ	-
14	NS	10	Norway Spruce	Picea Abies	F		WOODLAND	S	Υ	-
15	BS	9	Blue Spruce	Picea pungens	F		WOODLAND	S	Υ	-
16	TH	8X3	Thornapple/Hawthorne	Cragaegus spp.	F		LANDMARK	S	Υ	-
17	EB	7X6	European Buckthorn	Rhamnus cathartica	Р		INVASIVE	S	Υ	-
18	Е	21	American Elm	Ulmus americana	F		INVASIVE	S	Υ	-
19	Е	19	American Elm	Ulmus americana	G		INVASIVE	S	Υ	-
20	EB	7	European Buckthorn	Rhamnus cathartica	F		INVASIVE	S	Υ	-
21	Е	18	American Elm	Ulmus americana	G		INVASIVE	S	Υ	-
22	Е	10	American Elm	Ulmus americana	G		INVASIVE	S	Υ	-
23	Е	22	American Elm	Ulmus americana	G		INVASIVE	S	Υ	-
24	NS	14	Norway Spruce	Picea Abies	F		WOODLAND	S	Υ	-
25	BS	13	Blue Spruce	Picea pungens	G		WOODLAND	S	Υ	-
26	BS	14	Blue Spruce	Picea pungens	F		WOODLAND	S	Υ	-
27	BS	12	Blue Spruce	Picea pungens	G		WOODLAND	S	Υ	-
28	BS	13	Blue Spruce	Picea pungens	G		WOODLAND	S	Υ	-
29	NS	12	Norway Spruce	Picea Abies	G		WOODLAND	S	Υ	-
30	BS	13	Blue Spruce	Picea pungens	G		WOODLAND	S	Υ	-
31	BS	14	Blue Spruce	Picea pungens	G		WOODLAND	S	Υ	-

N2° 43' 26"W 670.52' N2° 42' 43"W-752670.60' (TC)

LANE USE

TREE INVENTORY/PRESERVATION CALCULATIONS


WOODLAND TREES				
WOODLAND TREES REMOVED:	0	(REPLACE AT 50% OF REMOVED DBH)		
" DBH x 0.5 =		" REPLACEMENT		
WOODLAND TREES SAVED:	13	(CREDIT OF 2X DBH)		
153'' DBH x 2 =		306" CREDIT		
0 -	306	= -306		
0 DBH REQUIRED FOR WOODLAND REPLACEMENT				

LANDMARK TREES		
LANDMARK TREES REMOVED:	4	(REPLACE AT 100% OF REMOVED DBH)
12" DBH x 1 =		12" REPLACEMENT
LANDMARK TREES SAVED:	3	(CREDIT OF 2X DBH)
55'' DBH x 2 =		110" CREDIT
12 -	110	= -98

0 TOTAL DBH REQUIRED FOR REPLACEMENT

EXEMPT TREES					
(NO REPLACEMENT REQUIRED FOR EXEMPT TREES)					
SAVED EXEMPT TREES:	7	Trees			
EXEMPT TREES ON SITE:	10	Trees			
TOTAL SAVED TREES 6" AND A	ABOVE ON	I SITE:	23	Trees	


KEY:

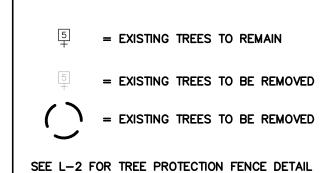







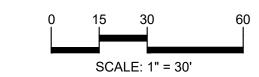



CAUTION!!

THE LOCATIONS AND ELEVATIONS OF EXISTING UNDERGROUND UTILITIES AS SHOWN ON THIS DRAWING ARE ONLY
APPROXIMATE. NO GUARANTEE IS EITHER EXPRESSED OR IMPLIED AS TO THE COMPLETENESS OR ACCURACY THEREOF. THE CONTRACTOR SHALL BE EXCLUSIVELY RESPONSIBLE FOR DETERMINING THE EXACT UTILITY LOCATIONS AND ELEVATIONS PRIOR TO THE START OF CONSTRUCTION.

CLIENT

JTA INC.
309 N. MAIN STREET STE. 213

ROYAL OAK, MICHIGAN

PROJECT TITLE

MOTOR CITY CHURCH 1349 WATTLES ROAD TROY, MICHIGAN

REVISIONS	
SPR/SU REVISED	05/07/24


ORIGINAL ISSUE DATE: APRIL 15, 2024 DRAWING TITLE

TREE PRESERVATION PLAN

PEA JOB NO.	24 0027
PEA JUB NU.	24-0037
P.M.	JBT
DN.	BZ
DES.	LAW
DRAWING NUMBER:	

WATTILES ROAD (33' HALF WIDTH - PUBLIC) - PUBLIC -	EXISTING TREE TO BE REMOVED, TYP. EXISTING TREE TO REMAIN WITH TREE PROTECTION FENCING, TYP.	#1349 1-1/2 STORY BLOCK/STUCCO FLAT ROOF #152 3, 25, 25, 25, 25, 25, 25, 25, 25, 25, 25	
S2° 42' 36"E 333.00' 4 in	754 754 755 756 756 757 758 759	TELEC(FLAGS) TOMM(FLAGS)(ATT) TELEC(FLAGS) TOMM FLAGS) TOMM FLAGS TOMM FLAGS) TOMM FLAGS T	
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<u>Plan View</u>

Scale - 1" = 30ft

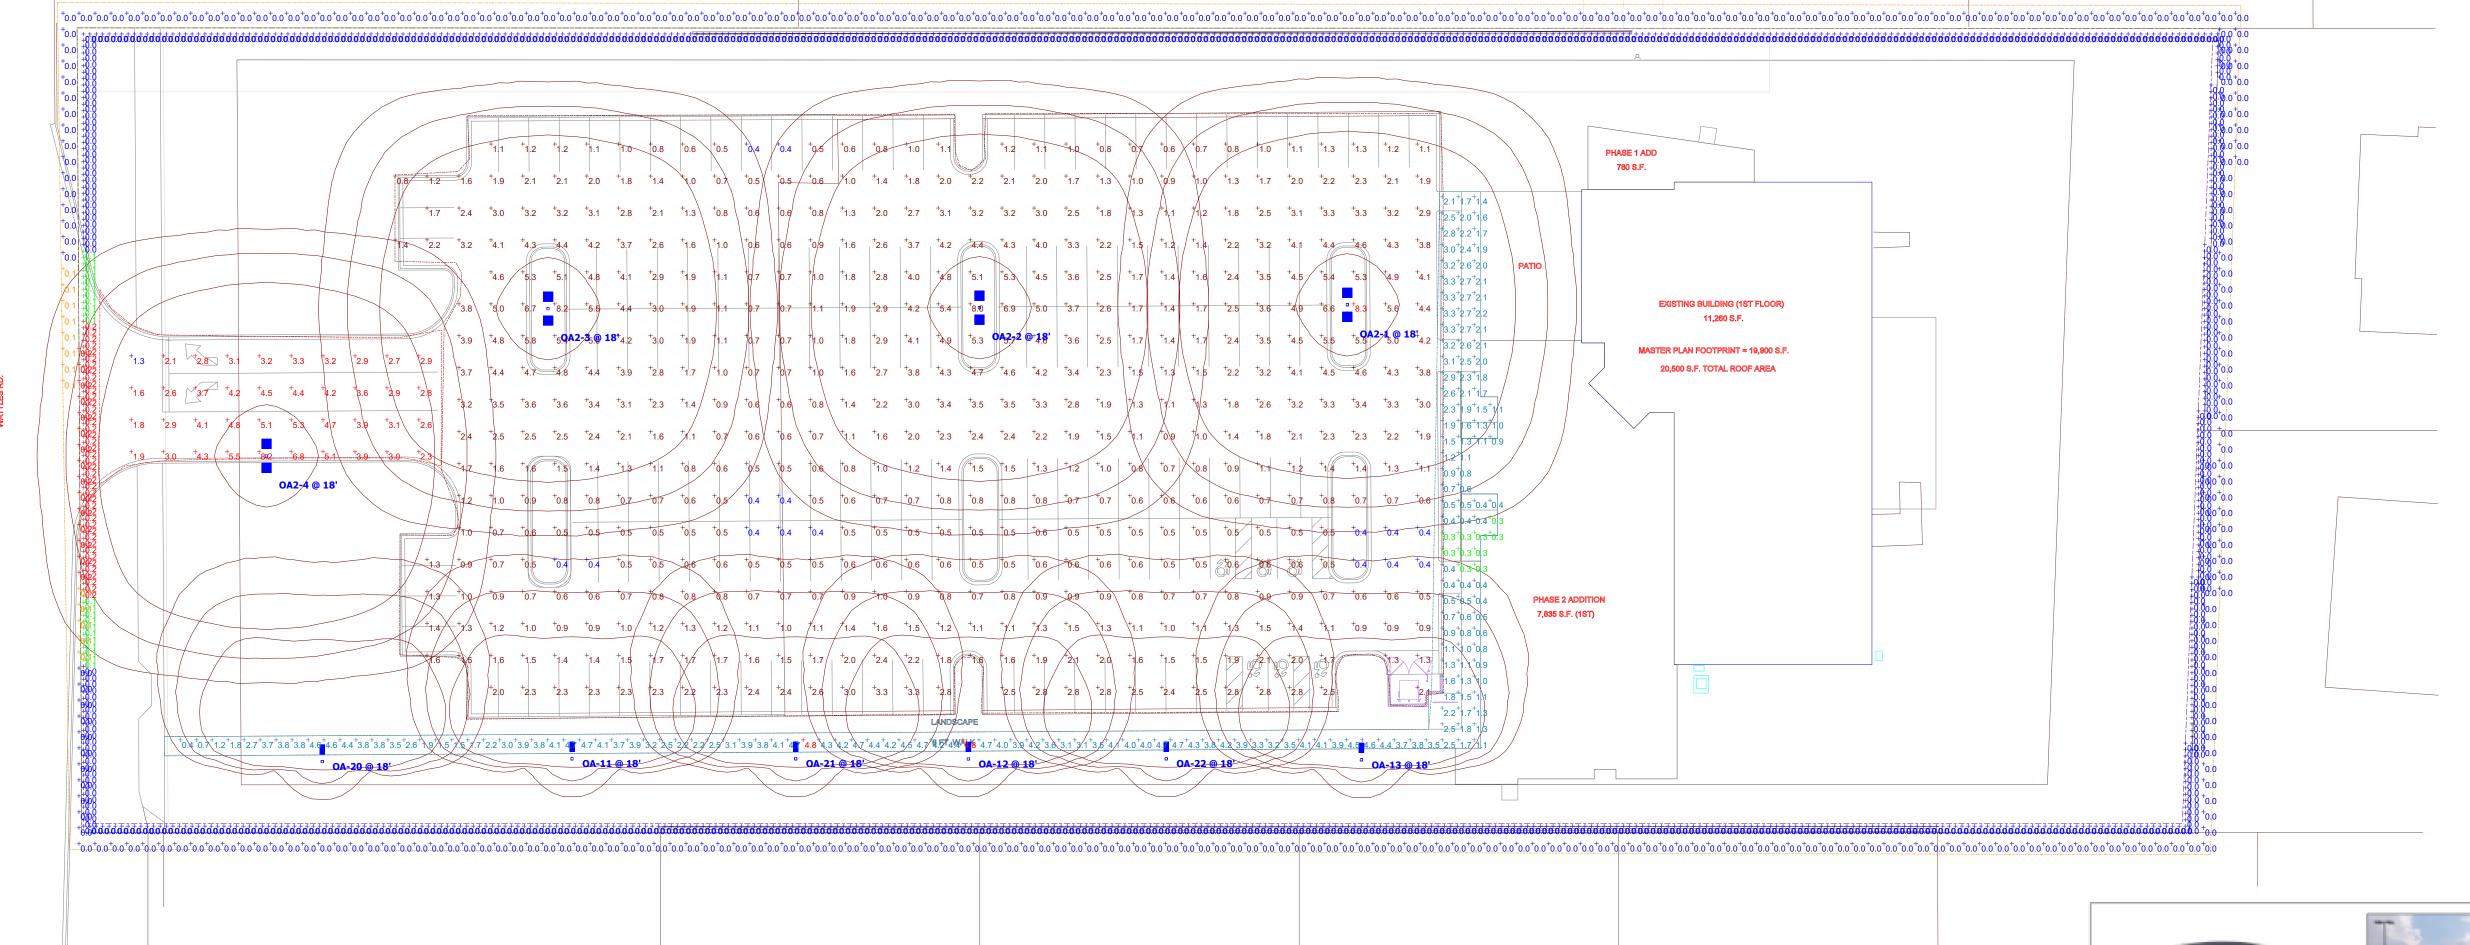Luminaire Locations

Max: 7340cd

Max: 7478cd

No. Label X Y Z MH Orientation Tilt X Y

OA2 842.72 412.26 18.00 18.00 180.00 0.00

OA2 727.55 411.35 18.00 18.00 180.00 0.00

 OA2
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 OA2
 504.40
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 180.00
 0.00

12 OA 724.09 270.10 18.00 18.00 0.47 0.00 724.10 271.35 0.00

13 OA 847.11 269.82 18.00 18.00 0.47 0.00 847.12 271.07 0.00

20 OA 521.85 269.30 18.00 18.00 0.47 0.00 521.86 270.55 0.00 1 OA 670.03 270.15 18.00 18.00 0.47 0.00 670.04 271.40 0.00

 OA2-1
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OA2-2 842.72 416.01 18.00 18.00 0.00 0.00 842.72 413.51 0.00

OA2-1 727.55 407.60 18.00 18.00 180.00 0.00 727.55 410.10 0.00 OA2-2 727.55 415.10 18.00 18.00 0.00 727.55 412.60 0.00

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+ 1.9 fc | 8.3 fc | 0.4 fc | 20.8:1 | 4.8:1

+ 0.0 fc 0.2 fc 0.0 fc N/A N/A

SOLUTIONS - McGRAW- HSS

EDISON (FORMERLY

SOLUTIONS - McGRAW-

EDISON (FORMERLY

4 COOPER LIGHTING

EATON)

COOPER LIGHTING GALN-SA2C-840-U-SL4- GALLEON AREA AND ROADWAY LUMINAIRE 32 306

(2) 80 CRI, 4000K, 1050mA

WITH HOUSE SIDE SHIELD

(3) 80 CRI, 4000K, 1050mA

TYPE V WIDE OPTICS

LIGHTSQUARES WITH 16 LEDS EACH AND

TYPE IV SPILL LIGHT ELIMINATOR OPTICS

LIGHTSQUARES WITH 16 LEDS EACH AND

GALN-SA3C-840-U-5WQ GALLEON AREA AND ROADWAY LUMINAIRE 48 385 0.9 320

 SITE
 +
 1.1 fc
 7.2 fc
 0.0 fc
 N/A
 N/A

 Walkway
 +
 2.4 fc
 4.8 fc
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 16.0:1
 8.0:1


 10' Beyond Property Line
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 0.0 fc
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 N/A
 N/A

Parking Lot

Property Line

OA

OA2

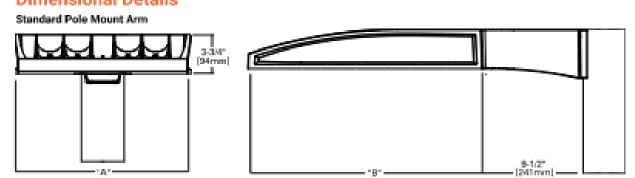

Number of Light Squares	Width 'A'	Housing Length '8'	Weight with Standard or QM Arm	EPA with Standard or QM Arm		
1-4	16"	22"	29 lb	0.95		
5-6	22"	22"	39 lb	0.96		
7-9	22*	28-1/8*	48 lb	1.1		
MOTES: The arm selection requirements and additional line art, see Mounting Details section.						

even u.e.

1. Well <u>Innov. News designificials are lowerful</u> to confirm qualification. Not all product variations are DUC qualified.

2. IDA Cart filed (I BOBS COT and warmer only, fixed mausting options)



Date 05/03/2024 Scale Not to Scale Drawing No. Summary

PS500052EN page 1 September 29, 2023 1:22 PM

1 of 1

Designer

McGraw-Edison GALN Galleon II Area / Site Luminaire Product Features Product Certifications Interactive Menu Ordering Information page 2 Mounting Details page 3 Optical Distributions page 5 • Product Specifications pages Energy and Performance Data page 6 Control Options page 11 Quick Facts P Connected Systems Lumen packages range from 3,300 - 73,500 (33W - 552W) WaveLinx Lite 17 optical distributions WaveLinx Efficacy up to 159 lumens per watt **Dimensional Details** Pole Drilling Pattern Type "N"

Motor City Church

Master Plan and Phase 1 Renderings











































ITEM #6

DATE: May 9, 2024

TO: Planning Commission

FROM: R. Brent Savidant, Community Development Director

SUBJECT: PUBLIC HEARING – SPECIAL USE AND PRELIMINARY SITE PLAN REVIEW

(SU JPLN2021-024) - Proposed Starbucks with drive through, North side of Big Beaver, West of John R (1735 E. Big Beaver), Section 23, Currently Zoned CB

(Community Business) Zoning District

The petitioner Jim Butler of PEA Group submitted the above referenced Special Use Approval and Preliminary Site Plan Approval application for a Starbucks restaurant with drive through within an existing retail building. Restaurant drive throughs are permitted in the CB district, subject to special use approval.

The attached report prepared by Carlisle/Wortman Associates, Inc. (CWA), the City's Planning Consultant, summarizes the application. CWA prepared the report with input from various City departments including Planning, Engineering, Public Works and Fire. City Management supports the findings of fact contained in the report and recommends approval of the project, as noted.

Attachments:

- 1. Maps
- 2. Report prepared by Carlisle/Wortman Associates, Inc.
- 3. Special Use/Preliminary Site Plan application

G:\SPECIAL USE\SU_JPLN2024-003_STARBUCKS\PC Memo 05 14 2024.docx

PROPOSED RESOLUTION

<u>PUBLIC HEARING – SPECIAL USE AND PRELIMINARY SITE PLAN REVIEW (SU JPLN2021-024)</u> - Proposed Starbucks with drive through, North side of Big Beaver, West of John R (1735 E. Big Beaver), Section 23, Currently Zoned CB (Community Business) Zoning District

Resolution # PC-2024-05-

MOTION CARRIED / FAILED

Moved by: Seconded by:


RESOLVED, That Special Use Approval and Preliminary Site Plan Approval for the proposed Starbucks with drive through, North side of Big Beaver, West of John R (1735 E. Big Beaver), Section 23, Currently Zoned CB (Community Business) District, be (granted, subject to the following conditions):

1. Provide photometric plans as described in Section 13.05, prior to Final Engineering

Approval.	
) or
(denied, for the following reasons:) or
(postponed, for the following reasons:)
Yes: No: Absent:	

TROY


GIS Online

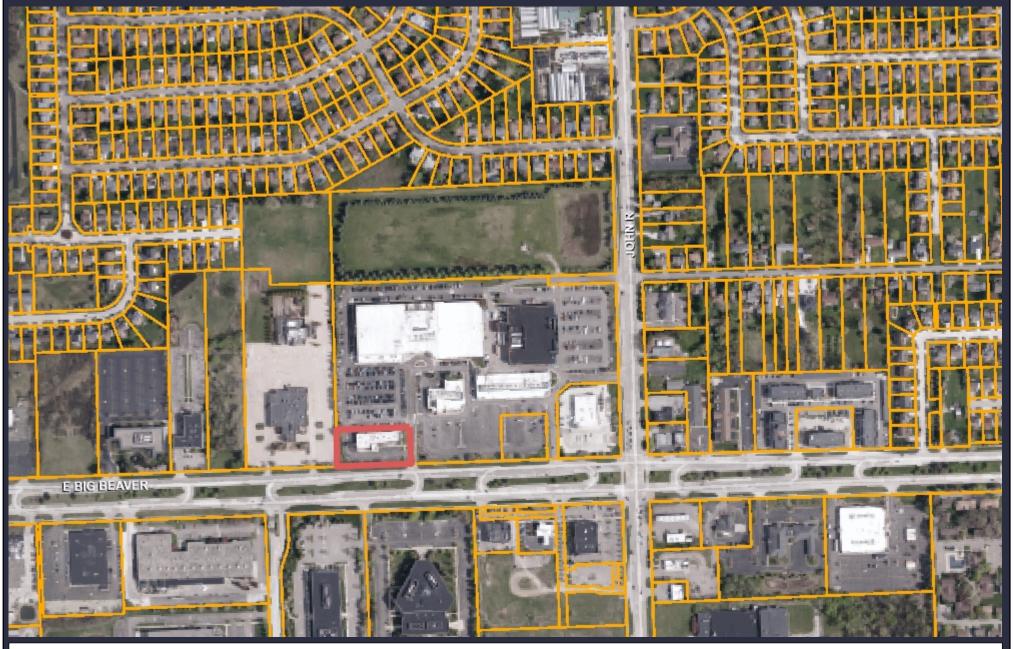

Note: The information provided by this application has been compiled from recorded deeds, plats, tax maps, surveys, and other public records and data. It is not a legally recorded map survey. Users of this data are hereby notified that the source information represented should be consulted for verification.

1,153

GIS Online

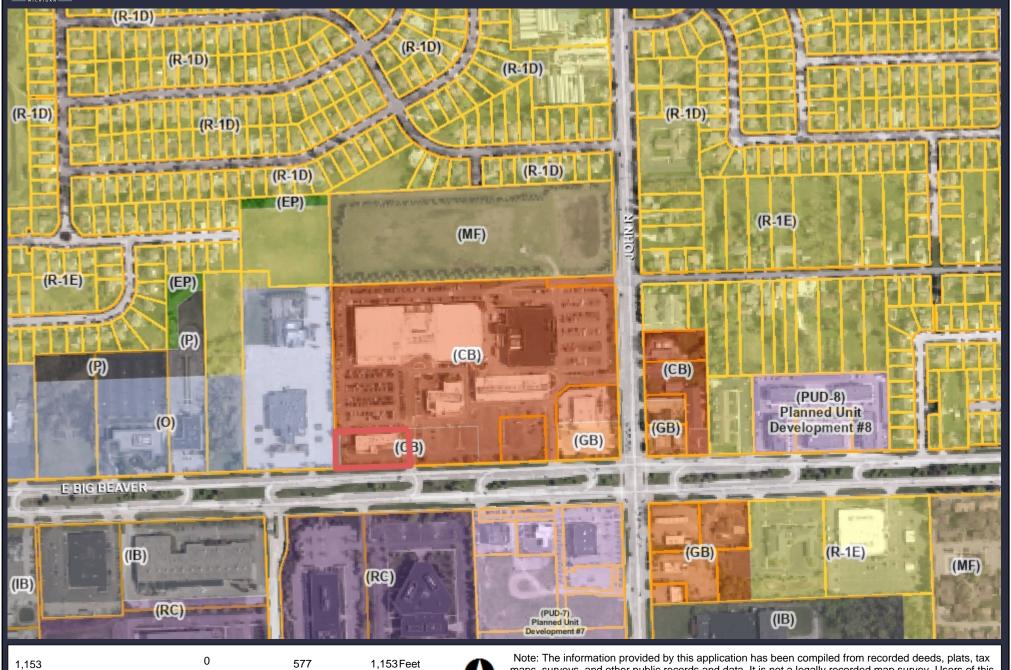



Note: The information provided by this application has been compiled from recorded deeds, plats, tax maps, surveys, and other public records and data. It is not a legally recorded map survey. Users of this data are hereby notified that the source information represented should be consulted for verification.



117 NORTH FIRST STREET SUITE 70 ANN ARBOR, MI 48104 734.662.2200 734.662.1935 FAX

Date:

March 27, 2024

May 8, 2024

For City of Troy, Michigan

Applicant: Troy Sport Center LLC

Project Name: Starbucks (Big Beaver)

Location: 1735 E Big Beaver Road

Plan Date: February 27, 2024

Zoning: CB, Community Business

Action Requested: Preliminary Site Plan and Special Use Approval

SITE DESCRIPTION

Starbucks has submitted an application to relocate from their existing space in the Troy Sports Center Shopping center to the former Chase Bank, which is an outlot on Big Beaver at the west end of an existing shopping plaza. The new Starbucks will replace the former Chase Bank. The proposed coffeehouse is 2,532 square feet. In addition to renovating the building and façade, the applicant proposes to erect a patio along the front façade (south side). Coffee shops are a permitted use in the CB Community Business zoning district; however, drive-throughs are a special use.

Site plan and special use approval would transfer Starbucks to a more visible location along E Big Beaver and allow the utilization of an existing drive-through at the former Chase Bank building.

Site Location:



Proposed Uses of Subject Parcel:

2,532 square foot coffeehouse with drive-through. The coffeehouse is at the west end of an existing shopping plaza.

Current Zoning:

The property is currently zoned CB, Community Business.

Surrounding Property Details:

Direction	Zoning	Use
North	CB, Community Business	Buffalo Wild Wings Arena
South	RC, Research Center	Schaeffler Group USA Inc. Altair
East	CB, Community Business	Smash Burger
West	O, Office	San Marino Club

NATURAL FEATURES

The site has been graded for previous development. The site has no natural features.

Items to be Addressed: None.

AREA, WIDTH, HEIGHT, SETBACKS

	Required / Maximum	Provided	Compliance
Front (South/Big Beaver)	10-foot minimum	N/A	Existing building. Applicant is making the site more compliant by adding the outdoor patio space.
Side (East)	N/A (shares wall with adjacent business)	N/A	Complies
Side (West)	20-foot minimum	83.65 feet	Complies
Rear (North)	30-foot minimum setback	21.15 feet	Existing non-conformity
Building Height	2 stories, 30 feet	20.5 feet	Complies
Parking Location	No more than 50% in front yard	Front yard parking shared with other tenants	Complies

Site plans show that the existing building does not comply with the 30-foot rear setback standard of the CB, Community Business District. We note that the entire shopping plaza is an existing non-conforming structure in regard to this standard.

Items to be Addressed: None.

PARKING

	Required	Provided	Compliance
Restaurant (fast food): 1 space per 70 square feet net floor area Retail: 1 space per 250 square feet gross floor area	Starbucks: 1,266 SF/70= 18 spaces SmashBurger: 1,300 SF/70= 19 spaces Tropical Smoothie: 900 SF/70= 13 spaces Vacant Retail: 4,525 SF/250= 18 spaces Total Required: 68 spaces	47 spaces	Does Not Comply on site. Applicant is proposing shared parking with Troy Sports Center site.
Restaurant drive-through window	10 stacking spaces	14	Complies
Barrier Free	3	3	Complies
Bicycle	2 spaces	2 spaces	Complies

For multiple tenant buildings with shared parking, the City requires parking calculations for all uses to ensure that all tenants retain required parking. Parking calculations provided by the applicant indicate that 47 out of 68 required parking spaces are being provided on this parcel. The applicant notes that parking for the retail development is shared with the adjacent Troy Sports Center.

Shared parking may be permitted provided that a signed agreement is provided by the property owner. We note that the applicant, Troy Sports Center LLC, owns the subject property and surrounding property to the north and east. Overall parking, when considering shared parking with the Troy Sports Center, is sufficient. If one property were to be sold, a future shared parking agreement would be required.

Furthermore, pedestrian access standards found in Section 13.11 require bike racks to be provided within fifty (50) feet of the building entrance. The proposed bike rack is located on the opposite end of the shopping plaza and does not meet this requirement.

Items to be Addressed: Provide bike rack no further than 50 feet away from building entrance.

SITE ACCESS AND CIRCULATION

There are no direct access points to the subject site from Big Beaver. This site and surrounding businesses of the Troy Sport Center are primarily accessed via an unnamed two-way road which runs through the center of the complex. This unnamed road is accessed via Big Beaver and there is an existing traffic light at the intersection.

From the unnamed road, there are two (2) existing access points to turn left onto the Starbucks site. The drive-through must be accessed via the north access point and drive-through patrons will then loop around and exit via the south access point. Throughout the parking lot, circulation features two-way traffic. The aisle width throughout the parking lot is exactly 24 feet.

Pedestrian Access:

We note that the addition of the drive-through around the side and rear of the building will greatly hinder pedestrian access to the building from the rear (north end). For example, the retail area has direct access from the rear parking lot, which will require any patron that uses that entrance to cross the drive-through. To address these concerns, the applicant has provided two (2) crosswalks within the drive-through lane. We note that these pedestrian crossings must be well-marked, using such measures as pavement treatments, signs, striping, signals, lighting, pedestrian safety islands, landscaping and other traffic calming techniques.

In addition, pedestrians parking in the new spaces along the western property line will also be required to cross the drive-through. For this reason, we had requested that the applicant improve pedestrian access from the west side of the parking lot. Two (2) short crosswalks have been provided in this area, although the general arrangement is unchanged. All crosswalks on-site shall be well-marked in the manner described above.

Items to be Addressed: Ensure safe pedestrian access as described in Section 13.11(C)(5).

LANDSCAPING

A landscaping plan has been provided on Sheet L-10. The following table discusses the development's compliance with the landscape requirements set forth in Section 13.02.

	Required	Provided	Compliance
Greenbelt			
Big Beaver: 1 tree per 30 feet of frontage	326.89/30= 11 trees	7 existing trees and 4 proposed trees	Complies
Parking Lot Landscaping			

1 tree per every 8 parking spaces	18/8= 2 trees	2 trees in lot perimeter	Pending Planning Commission Review
Screening Between Uses			
1 large evergreen tree per 10 lineal feet OR 1 narrow evergreen tree per 5 lineal feet West: 162 LF/10= 1 OR 162/5= 32		32 narrow evergreen trees	Complies
Overall			
General site landscaping: A minimum of 20% of the site area shall be comprised of landscape material	(52,937 SF * .2) 20%= 10,587.4 SF	17,253.96 SF= 32.59%	Complies

Plans indicate that two (2) parking lot trees have been provided as required; however, the proposed trees are situated along the perimeter of the parking lot, not within. We note that an equivalent amount of landscape plantings at the perimeter of parking lots may be approved where landscaping within lots would be impractical due to size of the parking lot, detrimental to safe and efficient traffic flow, or would create an unreasonable burden for maintenance and snowplowing, provided all other landscaping requirements are met. This is an existing parking lot and adding additional parking lot trees would require the removal of at least two parking spaces.

Trash Enclosure:

The trash enclosure is screened with a 6-foot masonry block wall matching the finish of the building.

Mechanical Equipment:

Mechanical equipment is screened with eight (8) Juniper shrubs. Access doors to the transformer shall not be blocked by plantings.

Stormwater Management:

A memo from PEA Group dated May 6, 2024 states: "We have discussed storm water management with the City's Engineering Department. As part of the final engineering submittal, we will add an in-line pretreatment structure to the existing storm sewer system."

Items to be Addressed: Planning Commission review of parking lot trees.

PHOTOMETRICS

The applicant has confirmed that a photometric plan is being developed and shall be provided upon completion. Photometric plans shall include cut sheets for each type of lighting, specific location of each light, and height of each light. All exterior lighting shall be a full cut-off fixture or a fully shielded fixture, downward directed with a flat lens to prevent glare.

Items to be Addressed: Provide photometric plans as described in Section 13.05.

FLOOR PLAN AND ELEVATIONS

Floor Plans:

The Starbucks building measures 2,532 square feet with 1,266 square feet of net floor space. There are two (2) entryways along the front façade: one (1) at the far east edge and one (1) near the center of the façade. Upon entry, open space is shown in the area straight ahead and to the left. No tables or other elements are shown as to what the layout of this area will look like.

The coffeehouse bar is situated along the west wall. In the northwest corner (behind the bar), there is an entryway into a large room called "back of house" where a rear entrance/exit door is located. Restrooms and an electrical/mechanical room are located on the east side of the building. In this area, there is another private rear entrance/exit door.

A new patio for outdoor seating is proposed in front of the building; no dimensions were provided.

In addition to the Starbucks floor plans, the applicant has provided floor plans for the adjacent business to the east where Smash Burger is currently located. A memo from PEA Group dated May 6, 2024 states: "Space B is for a future user that is unknown currently. This space has been included in the parking calculations."

Building Materials:

The applicant proposes several architectural modifications to the building exterior. Exterior walls feature a new stucco finish of white color. Ten (10) windows are proposed along the front façade, each measuring 10-feet in height and framed with prefinished aluminum of dark bronze color. Composite wood siding is proposed along the front façade and around the drive-through window. Other materials around the drive-through include a metal canopy and metal bollards. Colored renderings depict the exterior to feature a mix of white, dark bronze, and gray.

Elevations:

At its peak, the building is 20.5 feet in height.

Items to be Addressed: None.

SPECIAL USE

Drive-through facilities are considered a special use in the CB Community Business district.

For any special use, according to Section 9.02.D, the Planning Commission shall "...review the request, supplementary materials either in support or opposition thereto, as well as the Planning Department's report, at a Public Hearing established for that purpose, and shall either grant or deny the request, table action on the request, or grant the request subject to specific conditions."

Section 9.03 states that before approving any requests for Special Use Approval, the Planning Commission shall consider:

- 1. Compatibility with Adjacent Uses.
- 2. Compatibility with the Master Plan.
- 3. Traffic Impact.
- 4. Impact on Public Services.
- 5. Compliance with Zoning Ordinance Standards.
- 6. Impact on the Overall Environment. The proposed Special Use shall no
- 7. Special Use Approval Specific Requirements.

Items to be Addressed: Address items noted in report.

DESIGN STANDARDS AND SITE PLAN REVIEW STANDARDS

The Big Beaver Node design standards as well as Site Plan review standards provide the Planning Commission with direction when reviewing the proposed site plan and design features of this development.

Section 5.04.E. outlines Design Standards:

- 1. Building Orientation and Entrance
- 2. Ground Story Activation
- 3. Transitional Features
- 4. Site Access, Parking, and Loading

Please see Section 5.04.E for standard details.

Section 8.06 outlines Site Plan Review Design Standards.

1. Development shall ensure compatibility to existing commercial districts and provide a transition between land uses.

- a. Building design shall enhance the character of the surrounding area in relation to building and parking placement, landscape and streetscape features, and architectural design.
- b. Street fronts shall provide a variety of architectural expression that is appropriate in its context and prevents monotony.
- c. Building design shall achieve a compatible transition between areas with different height, massing, scale, and architectural style.
- 2. Development shall incorporate the recognized best architectural building design practices.
 - a. Foster a lasting impact on the community through the provision of high quality design, construction, and detailing.
 - b. Provide high quality, durable materials, such as but not limited to stone, brick, glass, and metal. E.I.F.S. or material equivalent shall only be used as an accent material.
 - c. Develop buildings with creativity that includes balanced compositions and forms.
 - d. Design roofs that are appropriate to the architectural style of the building and create an appropriate visual exterior mass of the building given the context of the site.
 - e. For commercial buildings, incorporate clearly defined, highly visible customer entrances using features such as canopies, porticos, arcades, arches, wing walls, ground plane elements, and/or landscape planters.
 - f. Include community amenities that add value to the development such as patio/ seating areas, water features, art work or sculpture, clock towers, pedestrian plazas with park benches or other features located in areas accessible to the public.
- 3. Enhance the character, environment and safety for pedestrians and motorists.
 - a. Provide elements that define the street and the pedestrian realm.
 - b. Create a connection between the public right of way and ground floor activities.
 - c. Create a safe environment by employing design features to reduce vehicular and pedestrian conflict, while not sacrificing design excellence.
 - d. Enhance the pedestrian realm by framing the sidewalk area with trees, awnings, and other features.
 - e. Improve safety for pedestrians through site design measures.

SUMMARY

We support the relocation of the Starbucks, as it would provide a more visible location along Big Beaver and allow the utilization of an existing drive-through at the former Chase Bank building. As part of the discussion, Planning Commission should consider the following:

- 1. Compliance with Special Use standards set forth in section 9.03
- 2. Compliance with Big Beaver design standards set forth in section 5.04
- 3. Compliance with site plan review standards set forth in section 8.06
- 4. Compliance with Safe pedestrian access as described in Section 13.11(C)(5).
- 5. Parking lot tree location

If Planning Commission approves the Special Use and Preliminary Site Plan, we recommend the following condition:

1. Provide photometric plans as described in Section 13.05.

Sincerely,

CARLISLE/WORTMAN ASSOC., INC. Benjamin R. Carlisle, AICP, LEED AP

President

CARLISLE/WORTMAN ASSOC., INC.

Shana Kot

Community Planner

STARBUCKS

1735 EAST BIG BEAVER ROAD CITY OF TROY, OAKLAND COUNTY, MICHIGAN

PERMIT / APPROVAL SUMMARY

DATE SUBMITTED DATE APPROVED PERMIT / APPROVAL



INDEX OF DRAWINGS NUMBER TITLE **COVER SHEET** TOPOGRAPHIC SURVEY PRELIMINARY SITE PLAN PRELIMINARY GRADING PLAN NOTES AND DETAILS NOTES AND DETAILS LANDSCAPE PLAN LANDSCAPE SPECIFICATIONS LANDSCAPE SPECIFICATIONS **ARCHITECTURAL** PROPOSED FIRST FLOOR PLAN PROPOSED ELEVATIONS RENDERED ELEVATIONS PHOTOMETRIC PLAN


DESIGN TEAM

OWNER/APPLICANT/DEVELOPER CIVIL ENGINEER

TROY SPORT CENTER, LLC 803 W BIG BEAVER ROAD, SUITE 100 TROY, MICHIGAN 48084 CONTACT: DENNIS BOSTICK PHONE: 248.506.1287 EMAIL: DENNISBOSTICK@ATT.NET PEA GROUP
1849 POND RUN
AUBURN HILLS, MI 48326
CONTACT: JAMES P. BUTLER, PE
PHONE: 844.813.2949
EMAIL: JBUTLER@PEAGROUP.COM

ARCHITECT

BRIAN NEEPER ARCHITECTURE
630 NORTH OLD WOODWARD, SUITE 203
BIRMINGHAM, MICHIGAN 48009
CONTACT: BRIAN NEEPER
PHONE: 248.259.1784
EMAIL: BRIAN@BRIANNEEPER.COM

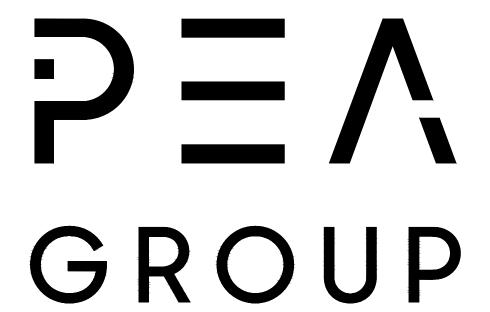

REVISIONS					
DESCRIPTION	DATE				
ORIGINAL ISSUE DATE					

REFERENCE DRAWINGS: PEA JOB NO. 2018-034

MORTGAGE SURVEY, NOWAK & FRAUS JOB NO. 8801-05, SHEET 1, DATED 08/15/2017

CITY OF TROY UTILITY MAP (FROM PEA JOB NO. 2018-034)

FLOODPLAIN NOTE:

BY GRAPHICAL PLOTTING, SITE IS WITHIN ZONE 'X', AREA DETERMINED TO BE OUTSIDE OF THE 0.2% ANNUAL CHANCE FLOODPLAIN PER FLOOD INSURANCE RATE MAP NUMBER 26125C0553G, DATED 01/16/2009.

BENCHMARKS:

(PER CITY OF TROY DATUM)

ARROW ON A HYDRANT LOCATED ON THE WEST SIDE OF THE PARKING LOT ACROSS FROM THE DUMPSTER BEHIND 1735 E. BIG BEAVER ROAD, NEAR THE CHASE BANK DRIVE-THRU. ELEV. - 649.41

TROY BM #1277

ARROW ON T/HYDRANT (#23-122) ON THE NORTH SIDE OF BIG BEAVER EAST OF THE WEST ENTRANCE TO TROY SPORTS CENTER ELEV. 648.728


TROY BM #1278

ARROW ON T/HYDRANT (#23-123) ON THE NORTH SIDE OF BIG BEAVER EAST OF THE ENTRANCE OF BUILDING 1685 ELEV. 648.184

LEGAL DESCRIPTION:


PARCEL ID 02-23-476-011 Land in the City of Troy, Oakland County, Michigan, described as follows:

T2N, R11E, SEC 23 LASIER GARDENS SUB LOTS 35 & 36 EXC S 49 FT TAKEN FOR BIG BEAVER RD, ALSO VAC BELLINGHAM ST ADJ TO SAME, ALSO W 1/2 OF VAC BRONX AVE ADJ TO SAME

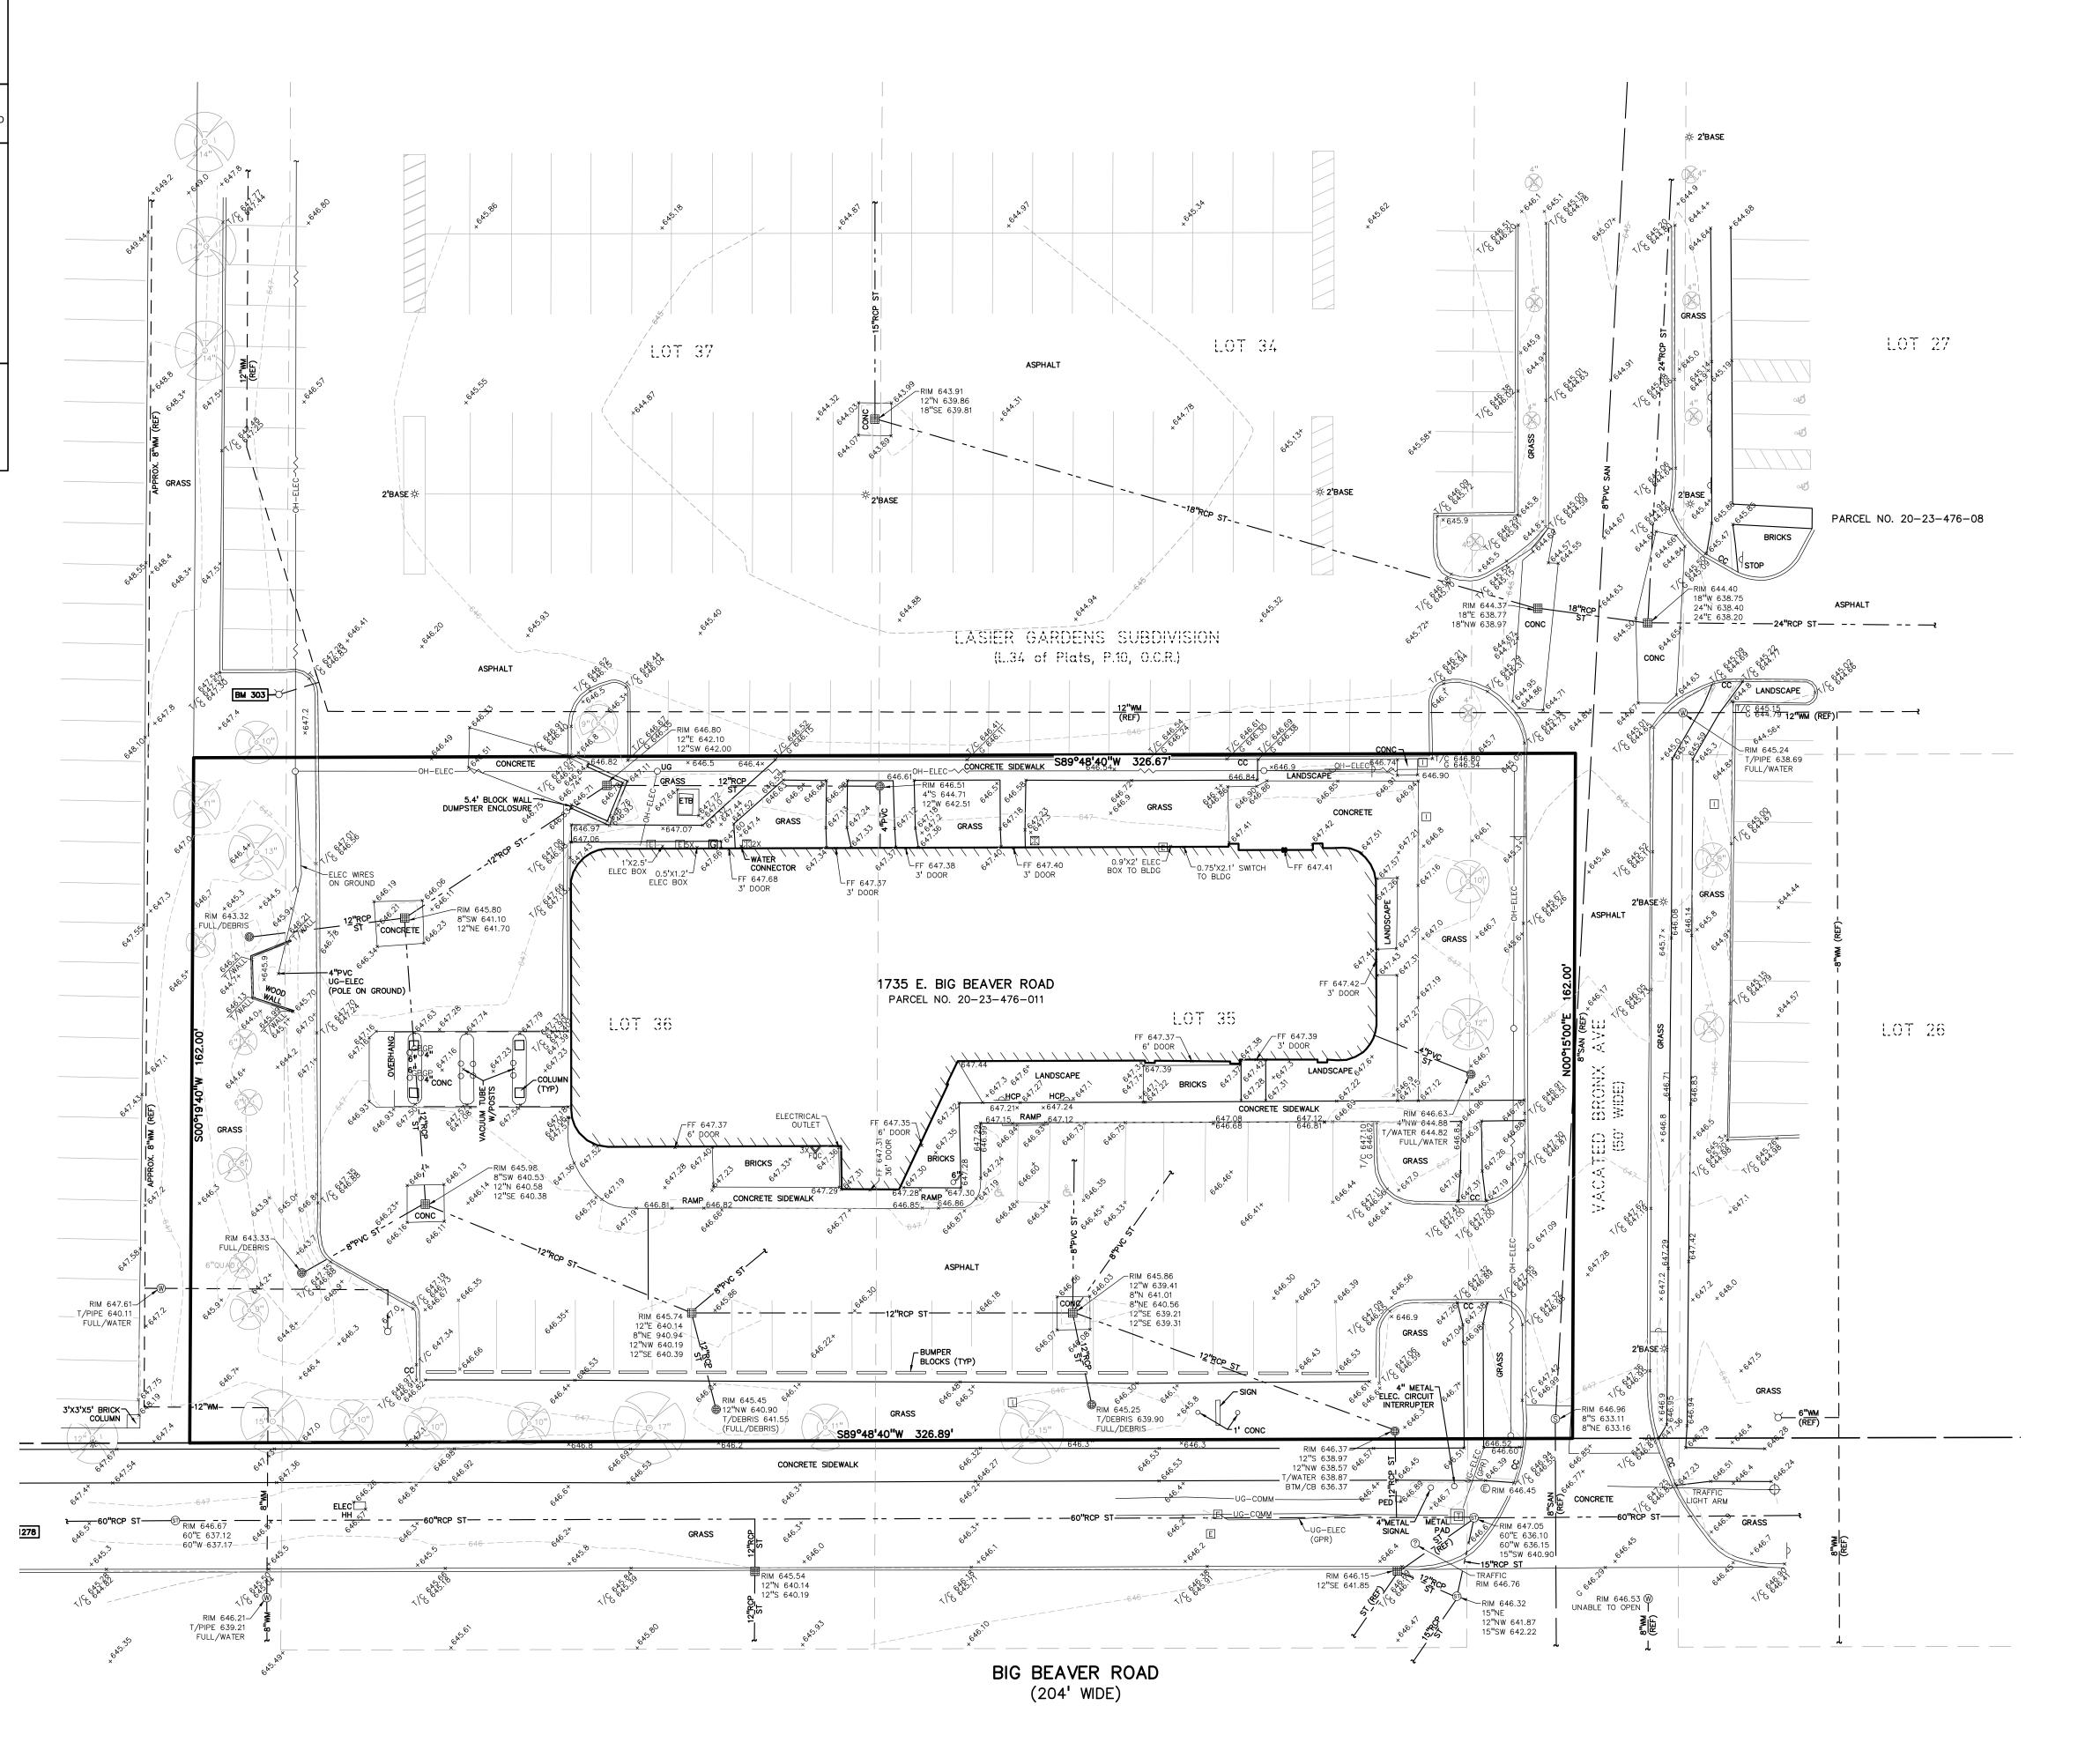






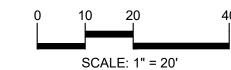



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LOCATION MAP

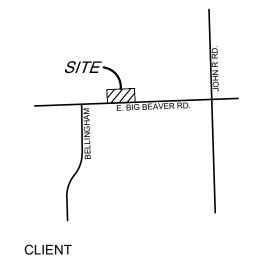

TROY SPORTS CENTER, LLC 803 W. BIG BEAVER ROAD, SUITE 100 TROY, MICHIGAN 48084

PROJECT TITLE

STARBUCKS
1735 E. BIG BEAVER ROAD
CITY OF TROY, OAKLAND COUNTY, MICHIGAN

REVISIONS

ORIGINAL ISSUE DATE: FEBRUARY 05, 2024 DRAWING TITLE

TOPOGRAPHIC PLAN

PEA JOB NO. 23-0922 DRAWING NUMBER:

REFERENCE DRAWINGS: PEA JOB NO. 2018-034

MORTGAGE SURVEY, NOWAK & FRAUS JOB NO. 8801-05, SHEET 1, DATED 08/15/2017

CITY OF TROY UTILITY MAP (FROM PEA JOB NO. 2018-034)

FLOODPLAIN NOTE:

BY GRAPHICAL PLOTTING, SITE IS WITHIN ZONE 'X', AREA DETERMINED TO BE OUTSIDE OF THE 0.2% ANNUAL CHANCE FLOODPLAIN PER FLOOD INSURANCE RATE MAP NUMBER 26125C0553G, DATED 01/16/2009.

BENCHMARKS:

(PER CITY OF TROY DATUM)

ARROW ON A HYDRANT LOCATED ON THE WEST SIDE OF THE PARKING LOT ACROSS FROM THE DUMPSTER BEHIND 1735 E. BIG BEAVER ROAD, NEAR THE CHASE BANK DRIVE-THRU. ELEV. - 649.41

TROY BM #1277

ARROW ON T/HYDRANT (#23-122) ON THE NORTH SIDE OF BIG BEAVER EAST OF THE WEST ENTRANCE TO TROY SPORTS CENTER ELEV. 648.728


TROY BM #1278

ARROW ON T/HYDRANT (#23-123) ON THE NORTH SIDE OF BIG BEAVER EAST OF THE ENTRANCE OF BUILDING 1685 ELEV. 648.184

LEGAL DESCRIPTION:

PARCEL ID 02-23-476-011
Land in the City of Troy, Oakland County, Michigan, described as follows:

T2N, R11E, SEC 23 LASIER GARDENS SUB LOTS 35 & 36 EXC S 49 FT TAKEN FOR BIG BEAVER RD, ALSO VAC BELLINGHAM ST ADJ TO SAME, ALSO W 1/2 OF VAC BRONX AVE ADJ TO SAME

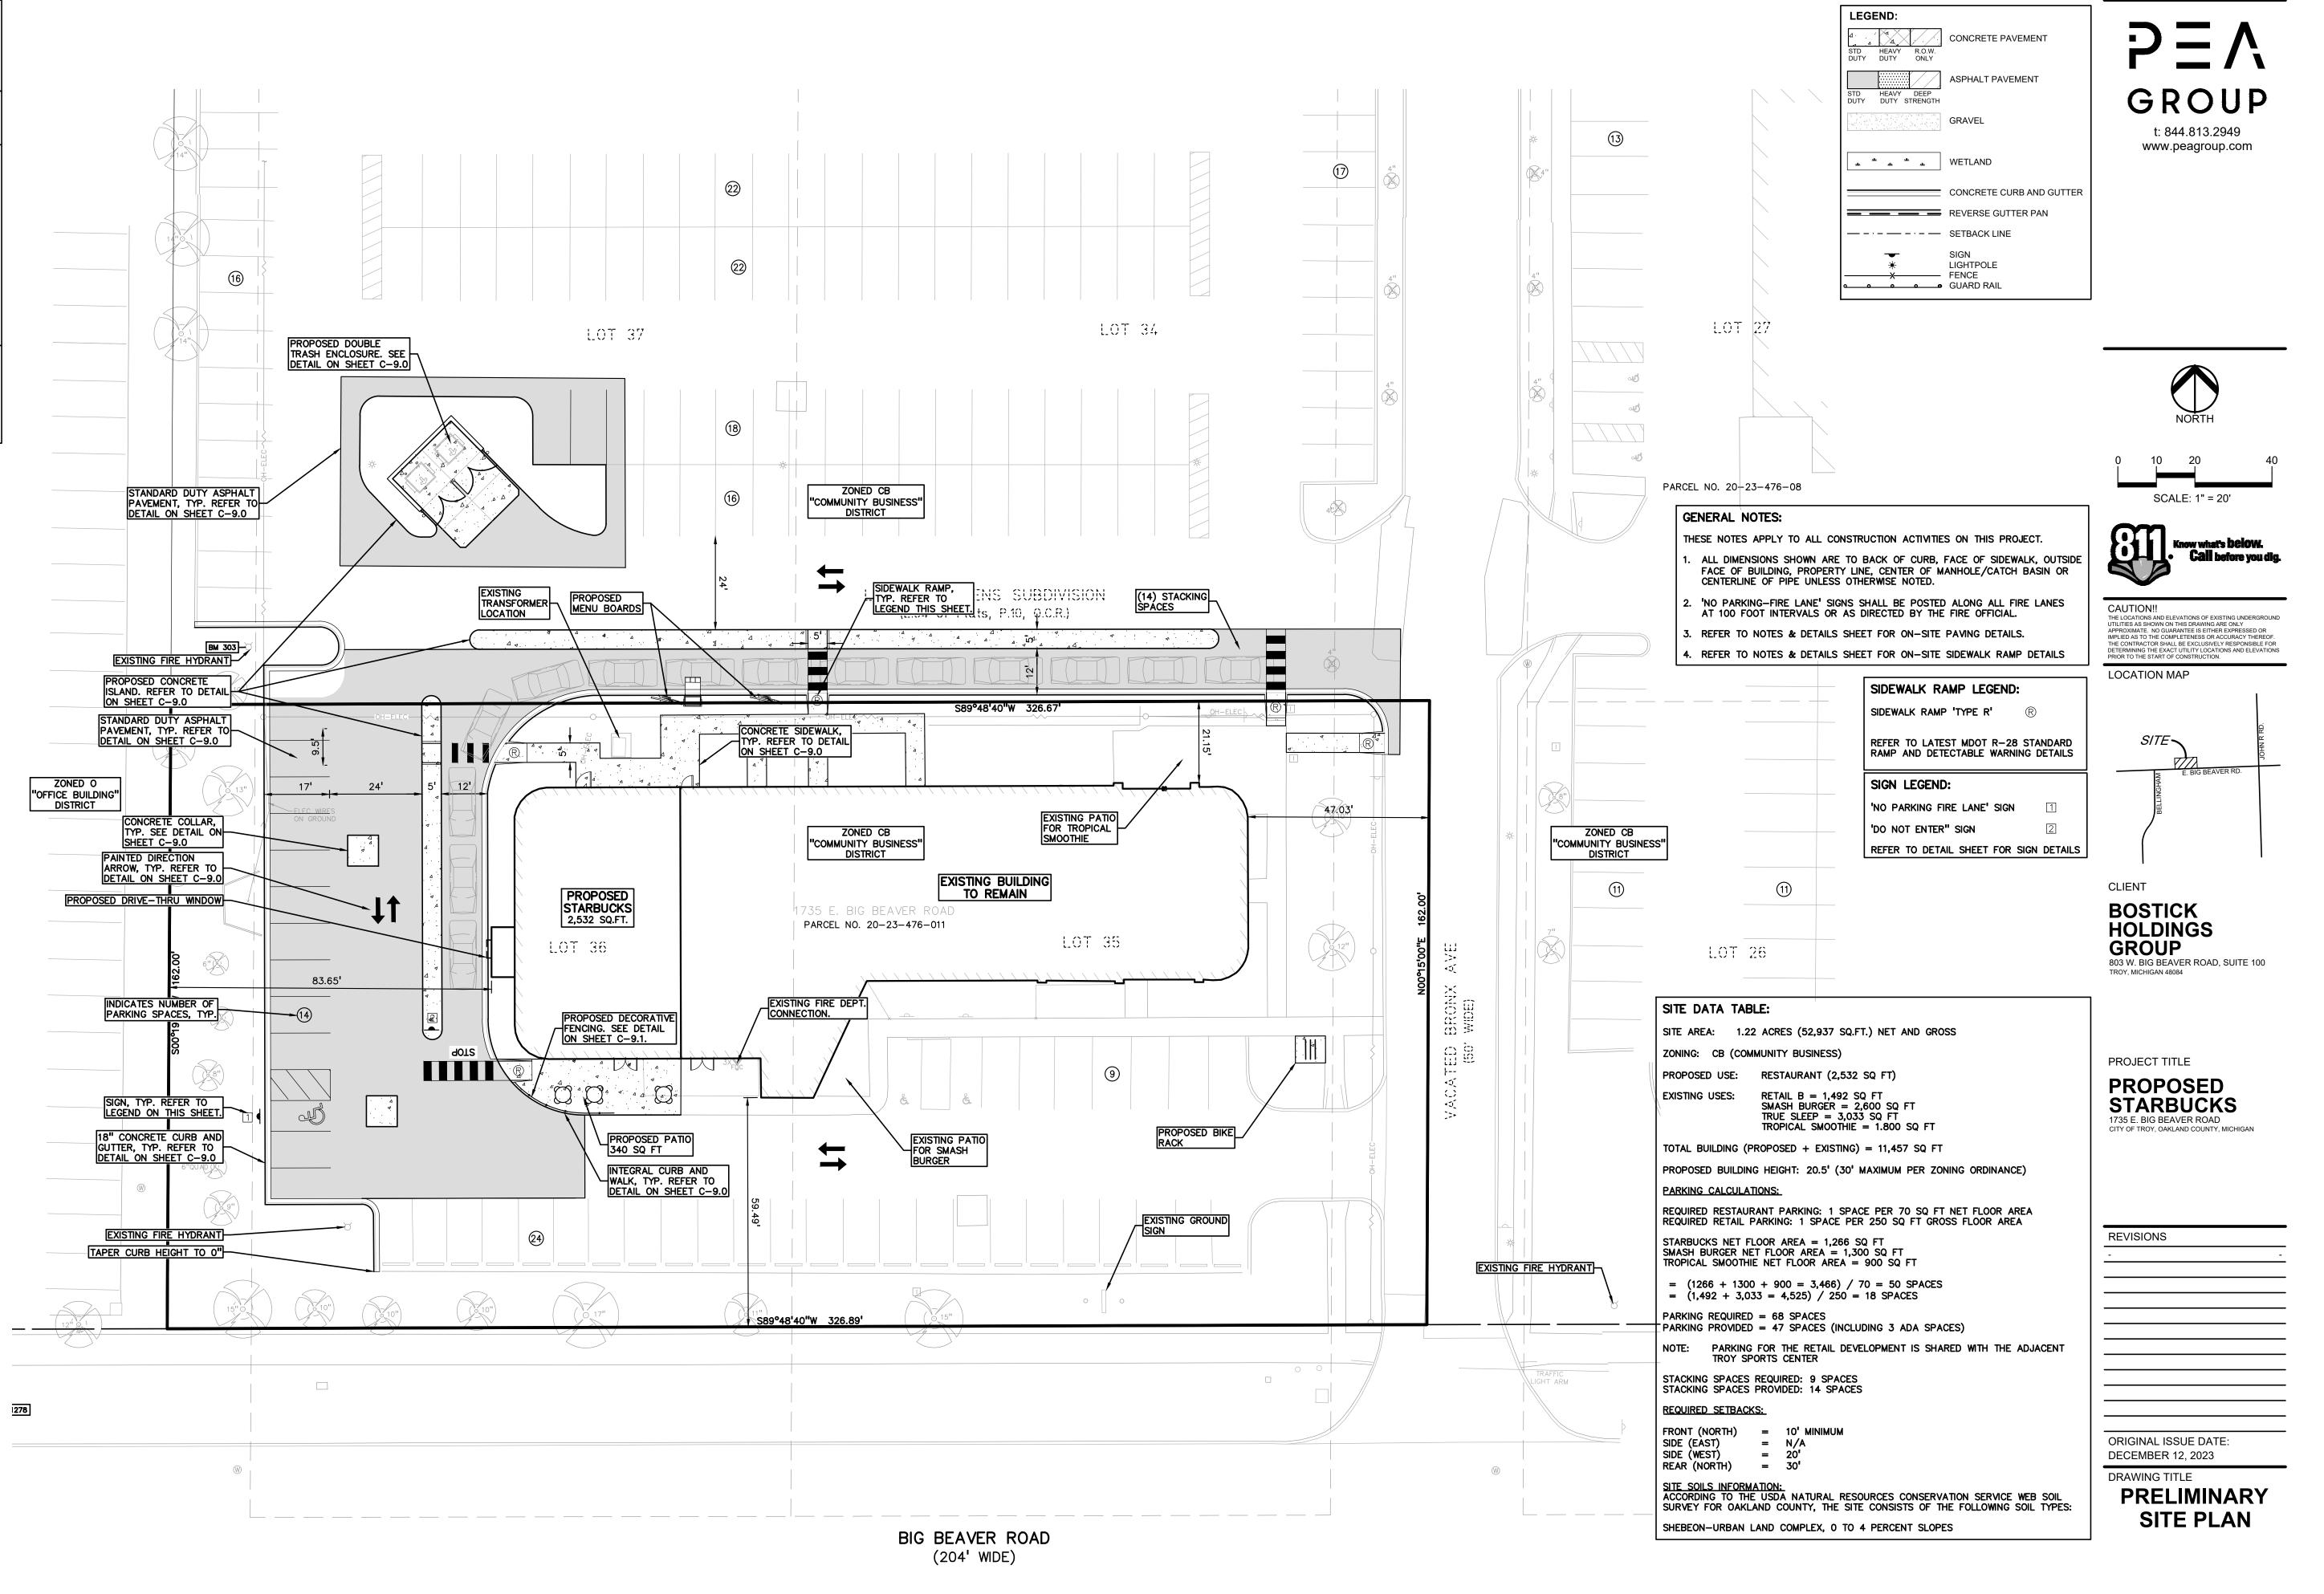

PEA JOB NO. 23-0922
P.M. JPB
DN. KS
DES. JPB
DRAWING NUMBER:

REFERENCE DRAWINGS: PEA JOB NO. 2018-034

MORTGAGE SURVEY, NOWAK & FRAUS JOB NO. 8801-05, SHEET 1, DATED 08/15/2017

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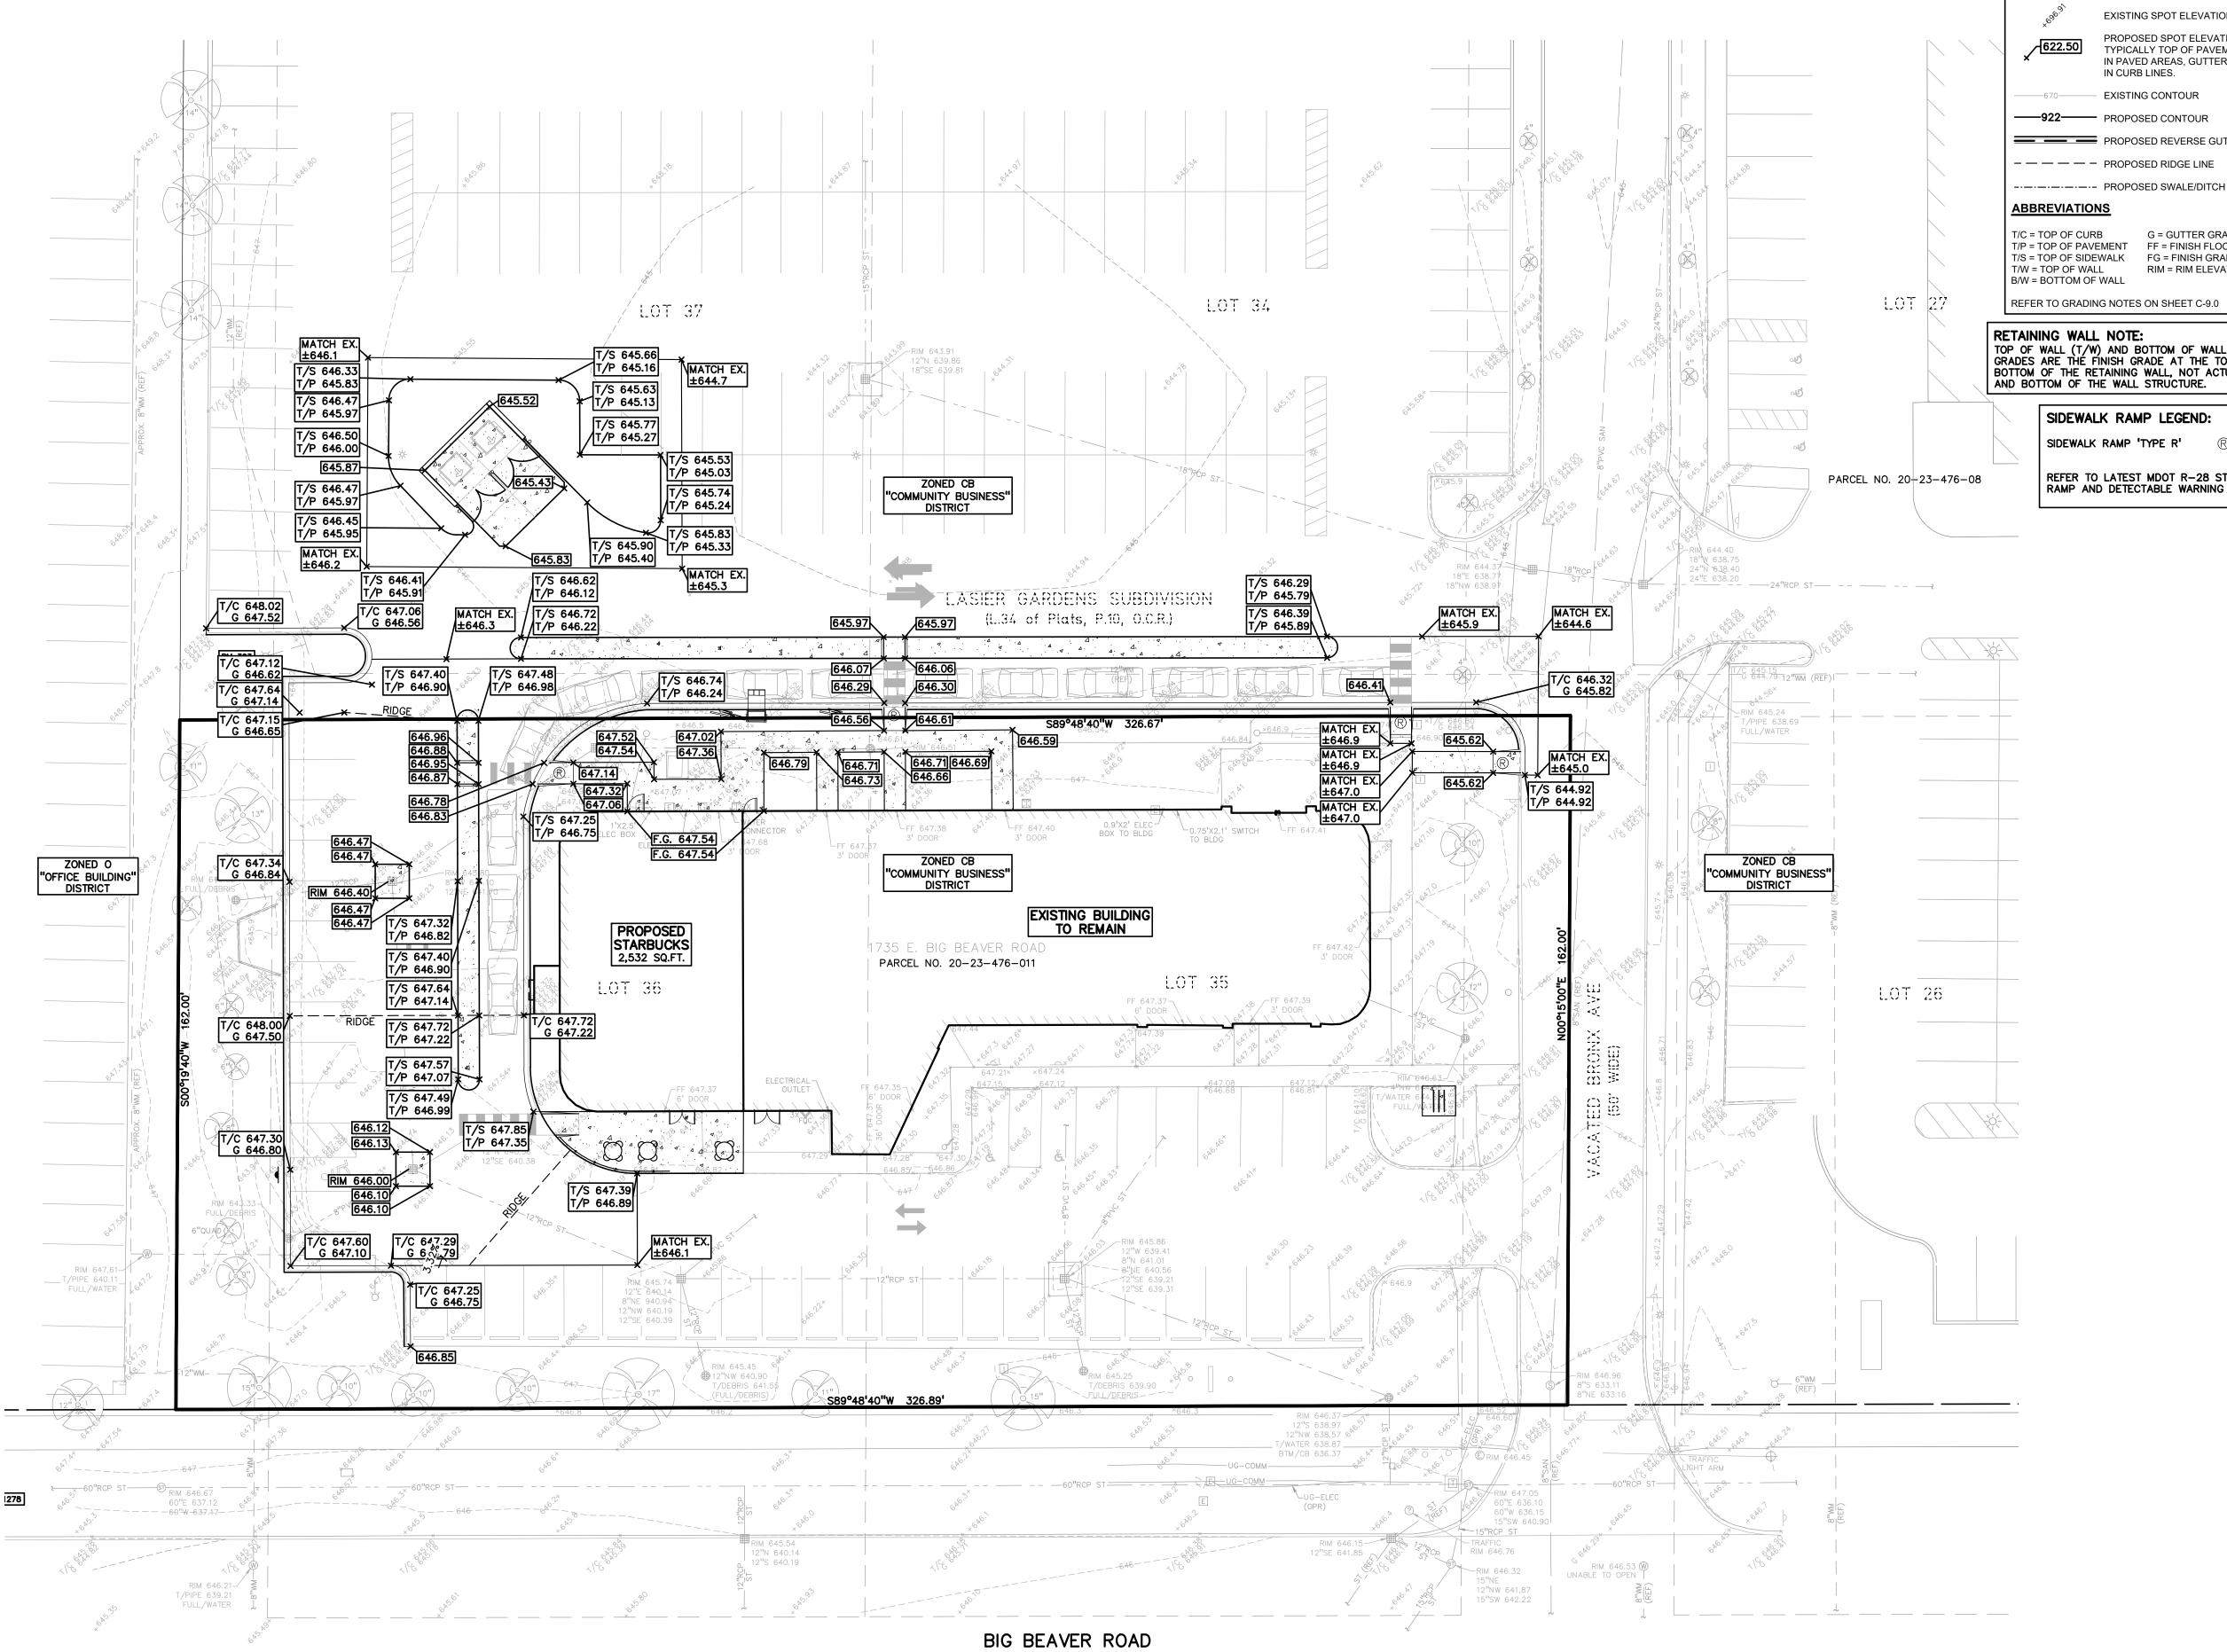
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(204' WIDE)

GRADING LEGEND: EXISTING SPOT ELEVATION PROPOSED SPOT ELEVATION: TYPICALLY TOP OF PAVEMENT IN PAVED AREAS, GUTTER GRADE IN CURB LINES. 670——670——EXISTING CONTOUR ——922—— PROPOSED CONTOUR PROPOSED REVERSE GUTTER PAN ---- PROPOSED RIDGE LINE ----- PROPOSED SWALE/DITCH **ABBREVIATIONS** T/C = TOP OF CURB G = GUTTER GRADE T/P = TOP OF PAVEMENT FF = FINISH FLOOR T/S = TOP OF SIDEWALK FG = FINISH GRADE RIM = RIM ELEVATION

TOP OF WALL (T/W) AND BOTTOM OF WALL (B/W) GRADES ARE THE FINISH GRADE AT THE TOP AND BOTTOM OF THE RETAINING WALL, NOT ACTUAL TOP AND BOTTOM OF THE WALL STRUCTURE.

SIDEWALK RAMP LEGEND: SIDEWALK RAMP 'TYPE R'

REFER TO LATEST MDOT R-28 STANDARD RAMP AND DETECTABLE WARNING DETAILS

t: 844.813.2949

www.peagroup.com

SCALE: 1" = 20'



CAUTION!! THE LOCATIONS AND ELEVATIONS OF EXISTING UNDERGROUND UTILITIES AS SHOWN ON THIS DRAWING ARE ONLY UTILITIES AS SHOWN ON THIS DRAWING ARE ONLY APPROXIMATE. NO GUARANTEE IS EITHER EXPRESSED OR IMPLIED AS TO THE COMPLETENESS OR ACCURACY THEREOF. THE CONTRACTOR SHALL BE EXCLUSIVELY RESPONSIBLE FOR DETERMINING THE EXACT UTILITY LOCATIONS AND ELEVATIONS PRIOR TO THE START OF CONSTRUCTION. LOCATION MAP

CLIENT

BOSTICK HOLDINGS GROUP 803 W. BIG BEAVER ROAD, SUITE 100 TROY, MICHIGAN 48084

PROJECT TITLE

PROPOSED STARBUCKS 1735 E. BIG BEAVER ROAD CITY OF TROY, OAKLAND COUNTY, MICHIGAN

REVISIONS

ORIGINAL ISSUE DATE: DECEMBER 12, 2023 DRAWING TITLE

PRELIMINARY GRADING PLAN

23-0922 PEA JOB NO. JPB KS DRAWING NUMBER:

GENERAL NOTES:

THESE NOTES APPLY TO ALL CONSTRUCTION ACTIVITIES ON THIS PROJECT.

- ALL CONSTRUCTION, WORKMANSHIP AND MATERIALS SHALL BE IN ACCORDANCE WITH CURRENT OSHA, MDOT AND MUNICIPALITY STANDARDS AND REGULATIONS.
- THE CONTRACTOR SHALL NOTIFY THE ENGINEER AND/OR THE AUTHORITY HAVING JURISDICTION 3 BUSINESS DAYS PRIOR TO THE BEGINNING OF CONSTRUCTION.
- THE CONTRACTOR SHALL CONTACT THE ENGINEER SHOULD THEY ENCOUNTER ANY DESIGN ISSUES DURING CONSTRUCTION. IF THE CONTRACTOR MAKES DESIGN MODIFICATIONS WITHOUT THE WRITTEN DIRECTION OF THE DESIGN ENGINEER, THE CONTRACTOR DOES SO
- ALL NECESSARY PERMITS, TESTING, BONDS AND INSURANCES ETC., SHALL BE PAID FOR BY THE CONTRACTOR. THE OWNER SHALL PAY FOR ALL CITY INSPECTION FEES.
- THE CONTRACTOR SHALL NOTIFY THE APPROPRIATE 811/ONE CALL UTILITY LOCATING CENTER, THE CITY ENGINEER AND/OR THE AUTHORITY HAVING JURISDICTION 3 BUSINESS DAYS PRIOR TO THE BEGINNING OF CONSTRUCTION. IF NO NOTIFICATION IS GIVEN AND DAMAGE RESULTS, SAID DAMAGE WILL BE REPAIRED AT SOLE EXPENSE OF THE CONTRACTOR. IF EXISTING UTILITY LINES ARE ENCOUNTERED THAT CONFLICT IN LOCATION WITH NEW CONSTRUCTION, THE CONTRACTOR SHALL NOTIFY THE DESIGN ENGINEER SO THAT THE CONFLICT MAY BE RESOLVED.
- CONTRACTOR SHALL VERIFY THAT THE PLANS AND SPECIFICATIONS ARE THE VERY LATEST PLANS AND SPECIFICATIONS AND FURTHERMORE, VERIFY THAT THESE PLANS AND SPECIFICATIONS HAVE BEEN APPROVED. ALL ITEMS CONSTRUCTED BY THE CONTRACTOR PRIOR TO RECEIVING FINAL APPROVAL, HAVING TO BE ADJUSTED OR RE-DONE, SHALL BE AT THE CONTRACTORS EXPENSE. SHOULD THE CONTRACTOR ENCOUNTER A CONFLICT BETWEEN THESE PLANS AND/OR SPECIFICATIONS, THEY SHALL SEEK CLARIFICATION IN WRITING FROM THE ENGINEER BEFORE COMMENCEMENT OF CONSTRUCTION. FAILURE TO DO SO SHALL BE AT SOLE
- ANY WORK WITHIN THE STREET OR HIGHWAY RIGHTS-OF-WAY SHALL BE PERFORMED IN ACCORDANCE WITH THE REQUIREMENTS OF THE AGENCIES HAVING JURISDICTION AND SHALL NOT BEGIN UNTIL ALL NECESSARY PERMITS HAVE BEEN ISSUED FOR THE WORK.
- ALL PROPERTIES OR FACILITIES IN THE SURROUNDING AREAS, PUBLIC OR PRIVATE, DESTROYED OR OTHERWISE DISTURBED DUE TO CONSTRUCTION, SHALL BE REPLACED AND/OR RESTORED TO THE ORIGINAL CONDITION BY THE CONTRACTOR.
- THE CONTRACTOR SHALL PROVIDE ALL NECESSARY BARRICADING, SIGNAGE, LIGHTS AND TRAFFIC CONTROL DEVICES TO PROTECT THE WORK AND SAFELY MAINTAIN TRAFFIC IN ACCORDANCE WITH LOCAL REQUIREMENTS AND THE MANUAL OF UNIFORM TRAFFIC CONTROL DEVICES (LATEST EDITION). THE DESIGN ENGINEER, OWNER AND STATE SHALL NOT BE HELD LIABLE FOR ANY CLAIMS RESULTING FROM ACCIDENTS OR DAMAGES CAUSED BY THE CONTRACTOR'S FAILURE TO COMPLY WITH TRAFFIC AND PUBLIC SAFETY REGULATIONS
- O. THE USE OF CRUSHED CONCRETE IS PROHIBITED ON THE PROJECT WITHIN 100 FEET OF ANY WATER COURSE (STREAM, RIVER, COUNTY DRAIN, ETC.) AND LAKE, REGARDLESS OF THE APPLICATION OR LOCATION OF THE WATER COURSE OR LAKE RELATIVE TO THE
- . IT SHALL BE THE RESPONSIBILITY OF THE CONTRACTOR TO ADJUST THE TOP OF ALL EXISTING AND PROPOSED STRUCTURES (MANHOLES, CATCH BASINS, INLETS, GATE WELLS ETC.) WITHIN GRADED AND /OR PAVED AREAS TO FINAL GRADE SHOWN ON THE PLANS. ALL SUCH ADJUSTMENTS SHALL BE INCIDENTAL TO THE JOB AND WILL NOT BE PAID FOR SEPARATELY.

PAVING NOTES:

- IN AREAS WHERE NEW PAVEMENTS ARE BEING CONSTRUCTED, THE TOPSOIL AND SOIL CONTAINING ORGANIC MATTER SHALL BE REMOVED PRIOR TO PAVEMENT CONSTRUCTION.
- REFER TO ARCHITECTURAL PLANS FOR DETAILS OF FROST SLAB AT EXTERIOR BUILDING DOORS.
- CONSTRUCTION TRAFFIC SHOULD BE MINIMIZED ON THE NEW PAVEMENT. IF CONSTRUCTION TRAFFIC IS ANTICIPATED ON THE PAVEMENT STRUCTURE, THE INITIAL LIFT THICKNESS COULD BE INCREASED AND PLACEMENT OF THE FINAL LIFT COULD BE DELAYED UNTIL THE MAJORITY OF THE CONSTRUCTION ACTIVITIES HAVE BEEN COMPLETED. THIS ACTION WILL ALLOW REPAIR OF LOCALIZED FAILURE, IF ANY DOES OCCUR, AS WELL AS REDUCE LOAD DAMAGE ON THE PAVEMENT SYSTEM.
- ALL EXPANSION JOINTS AND CONCRETE PAVEMENT JOINTS TO BE SEALED.
- CONCRETE PAVEMENT JOINTING UNLESS SHOWN OTHERWISE IN THE PLANS OR REQUIRED BY THE AUTHORITY HAVING JURISDICTION; 5.1. WHERE PROPOSED CONCRETE ABUTS A STRUCTURE, PROVIDE A MINIMUM 1/2" EXPANSION JOINT. THE JOINT FILLER BOARD MUST
- BE AT LEAST THE FULL DEPTH OF THE CONCRETE AND HELD DOWN A 1/2" TO ALLOW FOR SEALING 5.2. WHERE PROPOSED CONCRETE ABUTS EXISTING CONCRETE OR IN BETWEEN POURS OF PROPOSED CONCRETE (CONSTRUCTION JOINT), PROVIDE 5/8" DOWELS EVERY 30" CENTER TO CENTER HALF WAY ALONG THE THICKNESS OF THE PROPOSED PAVEMENT. ALTERNATE DOWELS SIZES AND SPACING MUST BE APPROVED THE ENGINEER PRIOR TO COMMENCING WORK AND VIA THE
- WHERE PROPOSED CONCRETE ABUTS EXISTING OR PROPOSED SIDEWALK OR CURBING, PROVIDE A MINIMUM 1/2" EXPANSION JOINT. 5.4. CONTROL, LONGITUDINAL AND/OR TRANSVERSE JOINTS SHALL BE PLACED TO PROVIDE PANELS WITHIN THE PAVEMENT AS SQUARE AS POSSIBLE WITH THE FOLLOWING MAXIMUM SPACING PARAMETERS:
- 5.4.1. 6-INCH THICK CONCRETE PAVEMENT: 12' X 12' 5.4.2. 8-INCH THICK CONCRETE PAVEMENT: 15' X 15'
- 5.5. IRREGULAR-SHAPED PANELS MAY REQUIRE THE USE OF REINFORCING MESH OR FIBER MESH AS DETERMINED BY THE ENGINEER. THE USE OF MESH MUST BE APPROVED THE ENGINEER PRIOR TO COMMENCING WORK AND VIA THE SUBMITTAL PROCESS.
- 5.6. IF A JOINT PLAN IS NOT PROVIDED IN THE PLANS, THE CONTRACTOR SHALL SUBMIT ONE TO THE ENGINEER FOR REVIEW PRIOR TO
- 6. CONCRETE CURBING JOINTING UNLESS SHOWN OTHERWISE IN THE PLANS OR REQUIRED BY THE AUTHORITY HAVING JURISDICTION 6.1. JOINTS WHEN ADJACENT TO ASPHALT PAVEMENT 6.1.1. PLACE CONTRACTION JOINTS AT 10' INTERVALS
- 6.1.2. PLACE 1/2" EXPANSION JOINT AT CATCH BASINS, EXISTING AND PROPOSED SIDEWALK OR EXISTING CURBING.
- 6.1.3. PLACE 1" EXPANSION JOINT: 6.1.3.1. AT SPRING POINTS OF INTERSECTIONS OR ONE OF THE END OF RADIUS LOCATIONS IN A CURVE
- 6.1.3.2. AT 400' MAXIMUM INTERVALS ON STRAIGHT RUNS 6.1.3.3. AT THE END OF RADIUS AT OPPOSITE ENDS IN A CURBED LANDSCAPE ISLAND
- 6.2. JOINTS WHEN TIED TO CONCRETE PAVEMENT
- 6.2.1. PLACE CONTRACTION JOINTS OPPOSITE ALL TRANSVERSE CONTRACTION JOINTS IN PAVEMENT 6.2.2. PLACE 1/2" EXPANSION JOINT AT CATCH BASINS, EXISTING AND PROPOSED SIDEWALK OR EXISTING CURBING.
- 6.2.3. PLACE 1" EXPANSION JOINT OPPOSITE ALL TRANSVERSE EXPANSION JOINTS IN PAVEMENT
- 6.2.4. CURB AND GUTTER AND CONCRETE SHALL BE TIED TOGETHER SIMILAR TO A LONGITUDINAL LANE TIE JOINT (MDOT B1 JOINT) 6.3. IN BETWEEN POURS OF PROPOSED CONCRETE CURBING (CONSTRUCTION JOINT): 6.3.1. CARRY THE REBAR CONTINUOUSLY BETWEEN POURS
- 6.3.2. IF THE REBAR IS NOT LONG ENOUGH TO CARRY CONTINUOUSLY, THEN TIE TWO PIECES OF REBAR PER THE LATEST MDOT
- CONCRETE SIDEWALK JOINTING UNLESS SHOWN OTHERWISE IN THE PLANS OR REQUIRED BY THE AUTHORITY HAVING JURISDICTION 7.1. PLACE TRANSVERSE CONTRACTION JOINTS EQUAL TO THE WIDTH OF THE WALK WHEN WIDTH IS LESS THAN 8'
- 7.2. PLACE TRANSVERSE AND LONGITUDINAL CONTRACTION JOINTS EQUAL TO 1/2 THE WIDTH OF THE WALK WHEN WIDTH IS EQUAL TO OR GREATER THAN 8'
- 7.3. PLACE 1" EXPANSION JOINT WHERE ABUTTING SIDEWALK RAMP AND/OR RADIUS IN INTERSECTION 7.4. PLACE TRANSVERSE 1/2" EXPANSION JOINT AT MAXIMUM OF 100' SPACING
- 7.5. PLACE 1/2" EXPANSION JOINT WHEN ABUTTING A FIXED STRUCTURE, OTHER PAVEMENT (CONCRETE PAVEMENT AND DRIVE APPROACHES), UTILITY STRUCTURES, LIGHT POLE BASES AND COLUMNS


GENERAL GRADING AND EARTHWORK NOTES:

BLANKET PEGGED IN PLACE OVER SEED.

THESE NOTES APPLY TO ALL CONSTRUCTION ACTIVITIES ON THIS PROJECT

MINIMUM OF 3" OF TOPSOIL IN THESE AREAS UNLESS OTHERWISE NOTED.

- CONTRACTOR SHALL FIELD VERIFY ALL EXISTING TREES AND BRUSH AND REMOVE ALL THAT ARE NECESSARY TO GRADE SITE.
- 2. ALL GRADES ARE TO TOP OF PAVEMENT UNLESS OTHERWISE NOTED
- 3. THE STAGING OF CONSTRUCTION ACTIVITIES SHALL OCCUR ONLY WITHIN THE SITE BOUNDARIES. ANY CONSTRUCTION ACTIVITIES OUTSIDE OF THE SITE BOUNDARIES SHALL BE AT THE SOLE RESPONSIBILITY AND RISK OF THE CONTRACTOR.
- I. ALL SOIL EROSION AND SEDIMENTATION CONTROL MEASURES SHALL MEET THE REQUIREMENTS OF THE AUTHORIZED PUBLIC AGENCY OF JURISDICTION. AN EROSION CONTROL PERMIT MUST BE SECURED FROM THE XXXX PRIOR TO CONSTRUCTION.
- 5. ALL EARTHWORK AND GRADING OPERATIONS SHALL BE PERFORMED IN ACCORDANCE WITH THE SOILS INVESTIGATION AND REPORT
- 6. REFER TO SOIL EROSION CONTROL PLAN FOR ADDITIONAL SOIL EROSION AND SEDIMENTATION CONTROL MEASURES AND NOTES. 7. THE DETENTION BASIN SIDE SLOPES AND ALL SLOPE EXCEEDING 1:6 MUST BE STABILIZED BY SODDING OR BY PLACING A MULCH
- 8. ALL DISTURBED AREAS SHALL BE SEEDED AND MULCHED OR SODDED IN ACCORDANCE WITH THE LANDSCAPE PLANS. PROVIDE A
- 9. THE CONTRACTOR SHALL NOTE EXISTING UNDERGROUND UTILITIES WITHIN AND ADJACENT TO THE SITE. BACKFILL FOR EXISTING UTILITY TRENCHES SHALL BE EXAMINED CRITICALLY. ANY TRENCHES FOUND TO HAVE SOFT, UNSTABLE OR UNSUITABLE BACKFILL MATERIAL, IN THE OPINION OF THE THIRD PARTY TESTING COMPANY, THAT ARE TO BE WITHIN THE ZONE OF INFLUENCE OF PROPOSED BUILDINGS OR PAVEMENT SHALL BE COMPLETELY EXCAVATED AND BACKFILLED WITH SUITABLE MATERIAL.
- 10. ON-SITE FILL CAN BE USED IF THE SPECIFIED COMPACTION REQUIREMENTS CAN BE ACHIEVED. IF ON-SITE SOIL IS USED, IT SHOULD BE CLEAN AND FREE OF FROZEN SOIL, ORGANICS, OR OTHER DELETERIOUS MATERIALS.
- 1. THE FINAL SUBGRADE/EXISTING AGGREGATE BASE SHOULD BE THOROUGHLY PROOFROLLED USING A FULLY LOADED TANDEM AXLE TRUCK OR FRONT END LOADER UNDER THE OBSERVATION OF A GEOTECHNICAL/PAVEMENT ENGINEER. LOOSE OR YIELDING AREAS THAT CANNOT BE MECHANICALLY STABILIZED SHOULD BE REINFORCED USING GEOGRIDS OR REMOVED AND REPLACED WITH ENGINEERED FILL OR AS DICTATED BY FIELD CONDITIONS.
- 12. SUBGRADE UNDERCUTTING, INCLUDING BACKFILLING SHALL BE PERFORMED TO REPLACE MATERIALS SUSCEPTIBLE TO FROST HEAVING AND UNSTABLE SOIL CONDITIONS. ANY EXCAVATIONS THAT MAY BE REQUIRED BELOW THE TOPSOIL IN FILL AREAS OR BELOW PROPOSED SUBGRADE IN CUT AREAS WILL BE CLASSIFIED AS SUBGRADE UNDERCUTTING.
- 13. SUBGRADE UNDERCUTTING SHALL BE PERFORMED WHERE NECESSARY AND THE EXCAVATED MATERIAL SHALL BECOME THE PROPERTY OF THE CONTRACTOR. ANY SUBGRADE UNDERCUTTING SHALL BE BACKFILLED AS RECOMMENDED IN THE GEOTECHNICAL ENGINEERING REPORT FOR THE PROJECT.
- 14. ANY SUBGRADE WATERING REQUIRED TO ACHIEVE REQUIRED DENSITY SHALL BE CONSIDERED INCIDENTAL TO THE JOB.

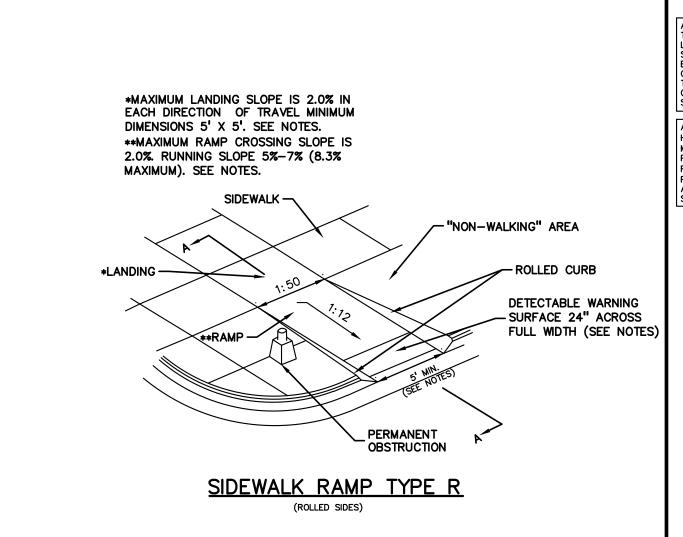

TOP OF CONCRETE
- COLLAR TO MATCH
PAVEMENT ELEVATION

CONCRETE COLLAR DETAIL

VARIES - SEE PLAN

<u>HEAVY DUTY CONCRETE PAD DETAIL</u>

6AA CONCRETE

- DECORATIVE STONE CAP

- #4 AT 16" O.C. VERT.

-12" MIN. OVERLAP W/FOOTING BARS., TYP.

PROVIDE FOOTING BARS EVERY 16" O.C.

WHEN NOT ADDRESSED IN THE
GEOTECHNICAL INVESTIGATION OR THE
ARCHITECTURAL PLAN PLACE ON
NATURAL SOILS OF AT LEAST 1500 PSF
NET ALLOWABLE BEARING CAPACITY OR

WHEN NOT ADDRESSED IN THE

DOCUMENTED ENGINEERED FILL

SEE PLAN FOR

/3 - #4 BARS CONT AT 12" C-C HORIZ.

DUMPSTER ENCLOSURE WALL CROSS SECTION

NOT TO SCALE

GATE LOCATION

ARCHITECTURAL MASONRY TO MATCH BUILDING

PROOF-ROLLED/COMPACTED SUBGRADE OR ENGINEERED FILL COMPACTED TO 95% C

MAX. DRY UNIT WEIGHT PER ASTM D-1557.

PROOF-ROLLED/COMPACTED SUBGRADE OR ENGINEERED

FILL COMPACTED TO 95% OF MAX. DRY UNIT WEIGHT PER ASTM D-1557.

6 MDOI #ZIAA CROSHEL LIMESTONE BASE COURSE COMPACTED TO 95% MAX DRY UNIT WEIGHT PER ASTM D-1557

8" MASONRY BLOCK —

PROVIDE 1/2"x8"
FIBER JOINT FILLER —
BETWEEN SLAB &

WALL ASTM (D1751

HEAVY DUTY CONCRETE PAD -

4 4 4 4 4

SLOPE TO PROVIDE POSITIVE DRAINAGE TOWARD CATCH BASIN,

FOR MANHOLE STRUCTURE)

(CONSTRUCT FLUSH WITH PAVEMENT

NOTE: ROUT A 1" X 3/4" RESERVOIR AROUND EDGES. POUR HOT RUBBER

- NON-SILICONE BASED SEALANT ALONG ALL EDGES OF CONCRETE COLLAR ADJACENT TO ASPHALT PAVEMENT.

NOTE:
COLLARS USED AT MANHOLES, GATE WELLS
ETC. CAN UTILIZE THIS SAME DETAIL,
EXCEPT THAT THE PAD GRADES SHOULD
CONFORM TO THE SURROUNDING PAVEMENT
GRADES, NOT PITCH TO THE STRUCTURE
CASTING AS SHOWN FOR CATCH BASINS

SECTION. REFER TO

SAWCUT CONTRACTION JOINTS

NOTE: ROUT A 1" X 3/4" RESERVOIR

NON-SILICONE BASED SEALANT ALONG ALL EDGES OF CONCRETE COLLAR ADJACENT TO ASPHALT PAVEMENT.

6" Ø STANDARD

PAVEMENT-

PAINT WITH REFLECTIVE YELLOW PAINT

1'-6" Ø CONC. BASE

BAR EACH WAY THRU


ARCHITECTURAL MASONRY TO MATCH FINISH OF BUILDING.

SIDE ELEVATION

6" DIA. GUARD POST DETAIL

DOUBLE TRASH ENCLOSURE DETAILS

DEPTH OF SLAB

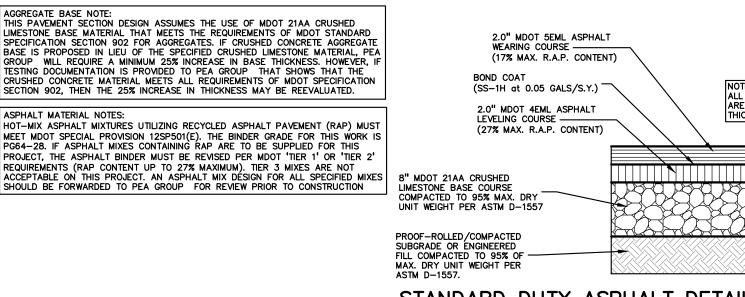

DIMENSION PER PLAN

COURSE COMPACTED TO 95%

SECTION A-A'

LENGTH PER PLAN

RAISED CONCRETE ISLAND DETAIL

23'-4"

1" x 6" PRESSURE TREATED

(ACQ) #2 CEDAR ON 2" x 6"

PRESSURE TREATED (ACQ) FRAME.
STAIN TO MATCH ARCHITECTURAL

FRONT ELEVATION

23'-4'

— 6" DIA. CONC. FILLED GUARD

POST SET IN CONCRETE FOOTING, TYP.

<u>DOUBLE DUMPSTER ENCLOSURE DETAIL</u>

BAR CONTINUOUS

SUBGRADE OR ENGINEEREI FILL COMPACTED TO 95% (

PROVIDE 6" INTEGRAL CURB REFER TO DETAIL ABOVE.

TOP HINGE, TYP

-4" CLEARANCE TO SLAB

SEE HEAVY-DUTY CONCRETE PAD DETAIL, THIS SHEET

MATCH FINISH OF BUILDING.

GUARD POST. W/CONC. FOOTING HEIGHT TO BE 6" ABOVE TOP HINGE, TYP.

GATES CONNECTED TO GUARD POSTS BY HEAVY

— MAXIMUM DRY UNIT WEIGHT


ASTM D-1557 (MODIFIED

ÍÓINT WITH SEALANT


PROVIDE CONTROL JOINTS AT INTERVALS EQUAL TO OR LESS THAN ISLAND WIDTH. REFER TO CONTROL JOINT DETAIL.

AVEMENT

CONCRETE

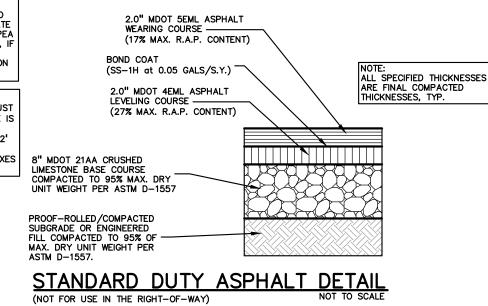

ASPHALT MIX DESIGN CHART					
COMMERCIAL ADT 0-300	COMMERCIAL ADT 301-1000	COMMERCIAL ADT 1001-3400	COMMERCIAL ADT ≥3401	APPLICATION RATE (LB/YD²), MINIMUM — MAXIMUM	COURSE APPLICATION
2EL	2EML	2EMH	2EH	435-550	BASE
3EL	3EML	ЗЕМН	3EH	330-410	BASE AND/OR LEVELING
4EL	4EML	4EMH	4EH	220-275	LEVELING AND/OR TOP
5EL	5EML	5EMH	5EH	165-220	TOP
PG 58-28	PG 64-28	PG 64-28	PG 70-28P		

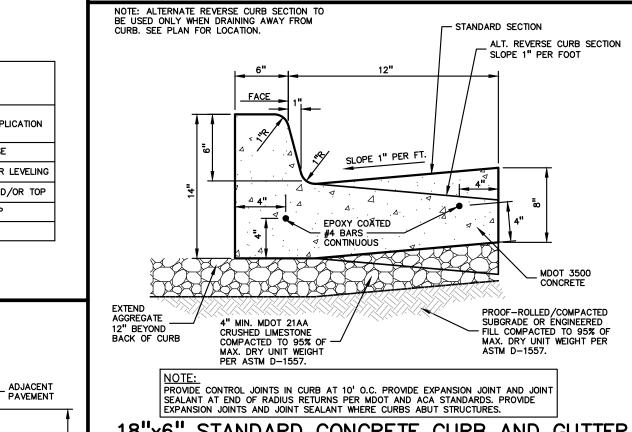

WIDTH VARIES - SEE PLAN


2% MAX. CROSS SLOPE

CONCRETE SIDEWAL

CROSS-SLOPE OF SIDEWALK MUST NOT EXCEED 2.0%, EXCEPT IN TRANSITION AREA MATCHING INTO EXISTING SIDEWALK

4" MDOT CLASS II SAND BASE

COURSE COMPACTED TO 95% _ MAXIMUM DRY UNIT WEIGHT PER ASTM D-1557

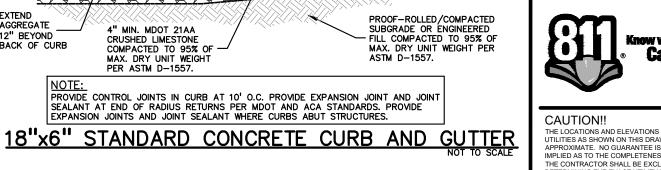

PROVIDE 1" DEPTH SAWCUT CONTROL JOINTS AT INTERVALS EQUAL TO THE WIDTH OF THE

CONCRETE


PROOF-ROLLED/COMPACTED


SUBGRADE OR ENGINEERED


FILL COMPACTED TO 95% OF


MAX. DRY UNIT WEIGHT PER ASTM D-1557.

SIDEWALK (NOT TO EXCEED 8' INTERVAL).

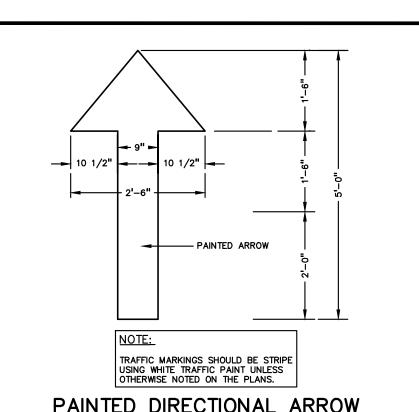


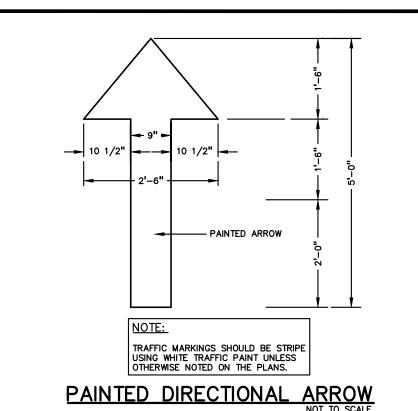


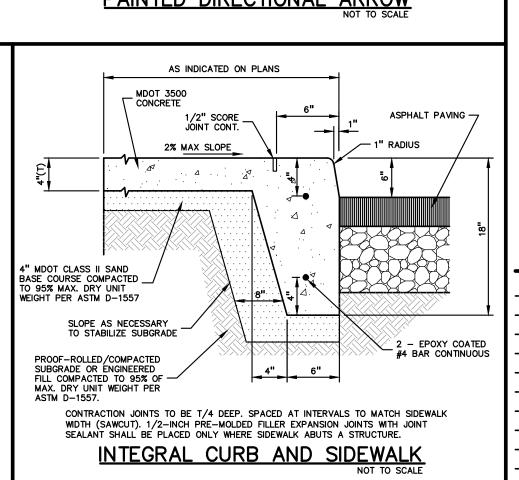

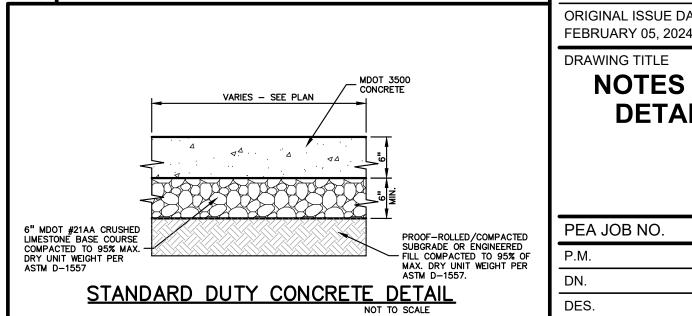



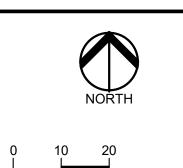

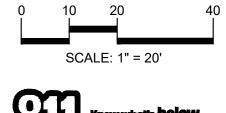



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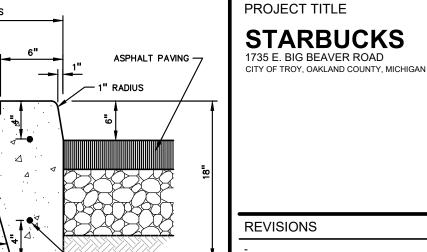
LOCATION MAP



TROY SPORTS CENTER, LLC

TROY, MICHIGAN 48084

803 W. BIG BEAVER ROAD, SUITE 100




ORIGINAL ISSUE DATE

DRAWING TITLE **NOTES AND DETAILS**


23-0922

PEA JOB NO. JPB KS DES. JPB DRAWING NUMBER:

NOT FOR CONSTRUCTION

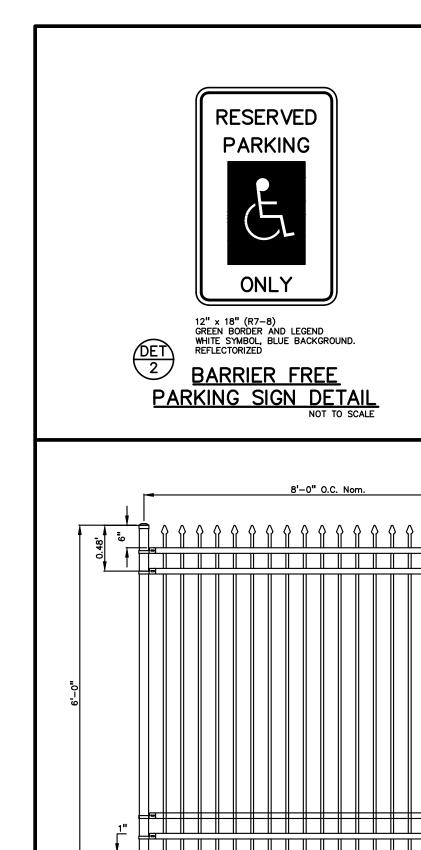



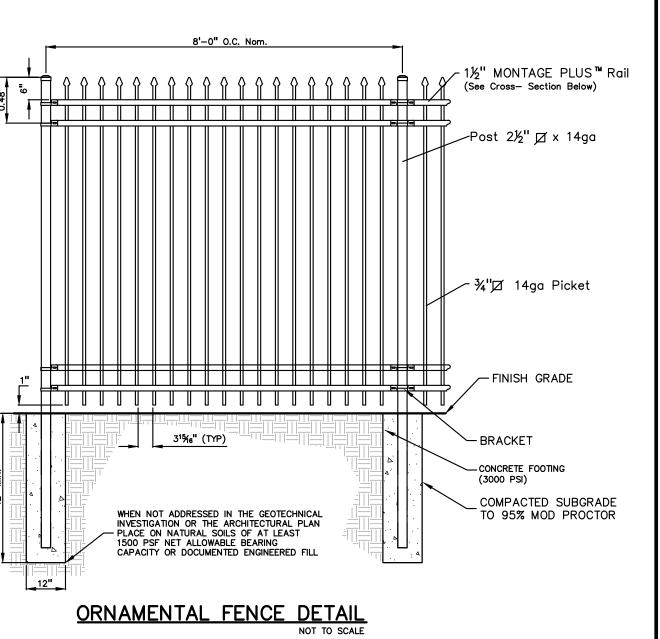



PROJECT TITLE

STARBUCKS
1735 E. BIG BEAVER ROAD
CITY OF TROY, OAKLAND COUNTY, MICHIGAN

TROY SPORTS CENTER, LLC 803 W. BIG BEAVER ROAD, SUITE 100 TROY, MICHIGAN 48084

REVISIONS

- -
ORIGINAL ISSUE DATE:

ORIGINAL ISSUE DATE: FEBRUARY 05, 2024 DRAWING TITLE


NOTES AND DETAILS

 PEA JOB NO.
 23-0922

 P.M.
 JPB

 DN.
 KS

DES.
DRAWING NUMBER:

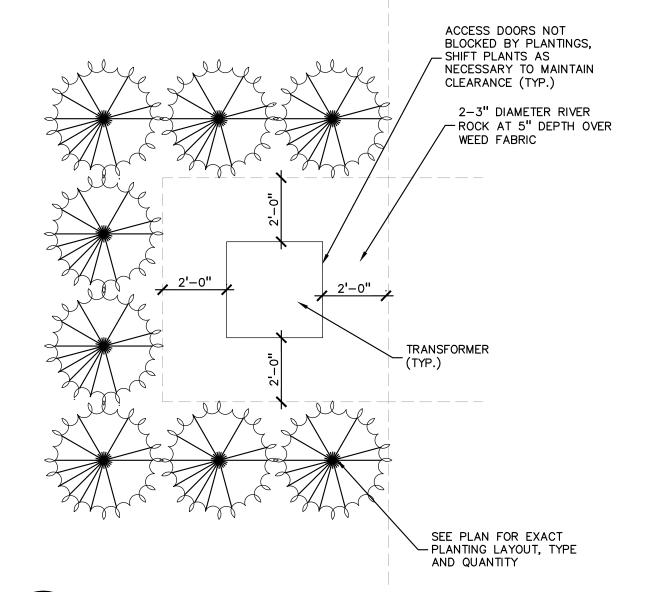

TRANSFORMER SCREENING DETAIL-FOR ACCESS REF. ONLY SCALE: 1'' = 3'-0''

TREE PROTECTION WILL BE ERECTED PRIOR TO START OF CONSTRUCTION ACTIVITIES AND SHALL REMAIN IN PLACE UNTIL CONSTRUCTION IS COMPLETE NO PERSON MAY CONDUCT ANY ACTIVITY WITHIN THE DRIP LINE OF ANY TREE DESIGNATED TO REMAIN; INCLUDING, BUT NOT LIMITED TO PLACING SOLVENTS, BUILDING MATERIAL, CONSTRUCTION EQUIPMENT OR SOIL DEPOSITS WITHIN DRIP LINES GRADE CHANGES MAY NOT OCCUR WITHIN THE DRIP


LINE OF PROTECTED TREES DURING CONSTRUCTION, NO PERSON SHALL ATTACH ANY DEVICE OR WIRE TO ANY REMAINING TREE

ALL UTILITY SERVICE REQUESTS MUST INCLUDE NOTIFICATION TO THE INSTALLER THAT PROTECTED TREES MUST BE AVOIDED. ALL TRENCHING SHALL OCCUR OUTSIDE OF THE PROTECTIVE FENCING

TREES LOCATED ON ADJACENT PROPERTY THAT MAY BE AFFECTED BY CONSTRUCTION ACTIVITIES MUST BE

TREES TO BE PRESERVED SHALL BE IDENTIFIED WITH FLAGGING PRIOR TO THE TREE CLEARING OPERATIONS PROVIDE FENCE AROUND CRITICAL ROOT ZONE OF

FENCE SHALL BE PLACED IN A CIRCLE WITH A MINIMUM RADIUS OF 1' PER 1" DIAMETER OF THE

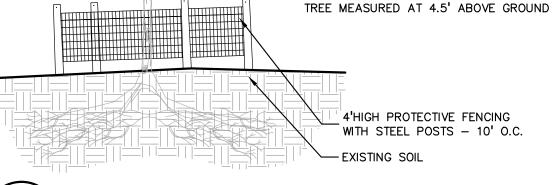


4'HIGH PROTECTIVE FENCING WITH STEEL POSTS - 10' O.C.

PLANT SO THAT TOP OF ROOT BALL IS

FLUSH TO GRADE OR 1-2" HIGHER IF

IN POORLY DRAINED SOILS

TREE PROTECTION DETAIL SCALE: 1'' = 3'-0''

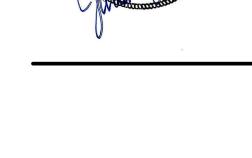

GROUP


t: 844.813.2949

www.peagroup.com

CAUTION!! THE LOCATIONS!

THE LOCATIONS AND ELEVATIONS OF EXISTING UNDERGROUND UTILITIES AS SHOWN ON THIS DRAWING ARE ONLY APPROXIMATE. NO GUARANTEE IS EITHER EXPRESSED OR IMPLIED AS TO THE COMPLETENESS OR ACCURACY THEREOF. THE CONTRACTOR SHALL BE EXCLUSIVELY RESPONSIBLE FOR DETERMINING THE EXACT UTILITY LOCATIONS AND ELEVATIONS PRIOR TO THE START OF CONSTRUCTION.

LOCATION MAP

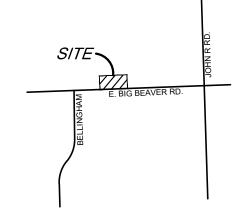

TROY SPORTS **CENTER, LLC** 803 W. BIG BEAVER ROAD, SUITE 100 TROY, MICHIGAN 48084

PROJECT TITLE

REVISIONS

STARBUCKS 1735 E. BIG BEAVER ROAD CITY OF TROY, OAKLAND COUNTY, MICHIGAN

DO NOT COVER TOP OF ROOTBALL WITH SOIL FORM SAUCER WITH 4" HIGH CONTINUOUS RIM SHREDDED HARDWOOD BARK MULCH 3" DEEP AND LEAVE 3" CIRCLE OF BARE SOIL AROUND TRUNK. DO NOT PLACE MULCH IN CONTACT WITH TRUNK — FINISH GRADE SPECIFIED PLANTING MIX. WATER AND TAMP TO REMOVE AIR POCKETS REMOVE ALL BURLAP FROM TOP 3 OF ROOTBALL. DISCARD ALL NON-BIODEGRADABLE MATERIAL OFF SITE VARIES ON CONTAINER OR BALL SIZE PLACE ROOTBALL ON UNEXCAVATED OR

SHRUB PLANTING DETAIL SCALE: 1'' = 2' - 0''

120° STAKING/GUYING LOCATION PLANT SO THAT TOP OF ROOT BALL IS FLUSH TO GRADE OR 1-2" HIGHER IF IN POORLY DRAINED SOILS SECURE TREE WRAP WITH BIODEGRADABLE

FIRST WINTER

DO NOT PRUNE TERMINAL LEADER PRUNE ONLY DEAD, BROKEN BRANCHES AS DIRECTED BY LANDSCAPE ARCHITECT

STAKE JUST BELOW BRANCHES WITH 2"-3" WIDE NYLON OR PLASTIC STRAPS. CONNECT FLEXIBILITY. REMOVE AFTER (1) ONE YEAR. (DO NOT USE WIRE & HOSE)

MATERIAL AT TOP & BOTTOM, REMOVE AFTER

(3) THREE 2"X2" HARDWOOD STAKES DRIVEN A MIN. OF 18" DEEP FIRMLY INTO SUBGRADE PRIOR TO BACKFILLING

SHREDDED HARDWOOD BARK MULCH TO DRIPLINE. 3" DEEP AND LEAVE 3" CIRCLE OF BARE SOIL AROUND TREE TRUNK. DO NOT PLACE MULCH IN CONTACT WITH TREE TRUNK. FORM SAUCER WITH 4" HIGH CONTINUOUS RIM

SPECIFIED PLANTING MIX, WATER & TAMP TO - REMOVE AIR POCKETS, AMEND SOIL PER SITE CONDITIONS & TREE REQUIREMENTS

-FINISH GRADE EXPOSE ROOT FLARE OF TREE. CONTRACTOR MAY HAVE TO REMOVE EXCESS SOIL FROM

FROM TOP 3 OF ROOTBALL. DISCARD ALL NON-BIODEGRADABLE MATERIAL OFF SITE _ PLACE ROOTBALL ON UNEXCAVATED OR TAMPED SOIL

- TOP OF ROOTBALL. REMOVE ALL BURLAP

DN. DES. DRAWING NUMBER:

ORIGINAL ISSUE DATE:

LANDSCAPE

DETAILS

23-0922

JPB

CAL


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FEBRUARY 05, 2024

DRAWING TITLE

PEA JOB NO.

P.M.

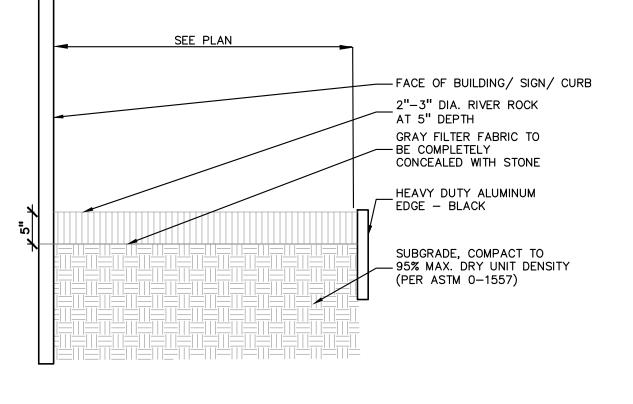

RIVER ROCK EDGE DETAIL SCALE: $1 \frac{1}{2}$ " = 1'-0"

> PERMALOC ALUMINUM EDGING OR APPROVED EQUAL WITH BLACK FINISH -BED MEDIA - COMPACTED SUBGRADE SPECIFICATIONS FOR LANDSCAPE BED EDGING: LANDSCAPE BED EDGING SHALL BE ALUMINUM AS MANUFACTURED BY PERMALOC 1.800.356.9660 8' OR 16' SECTIONS SHALL BE USED WITH ONE STAKE PER 38" OF EDGING SHALL BE 语" THICK X 4" DEPTH WHEN ADJ. TO MULCH AND គឺ" THICK X 5 ½" DEPTH WHEN ADJ. TO ROCK, FINISH: BLACK DURAFLEX MEETING AAMA 2603

> > STAKE SHALL SECURELY ENGAGE EDGING AND SHALL BE ENTIRELY BELOW TOP SURFACE OF EDGING EDGING SHALL HAVE A MINIMUM OF 2" OF INTERLOCKING OVERLAP BETWEEN SECTIONS

INSTALL AS PER MANUFACTURER'S SPECIFICATIONS WITH TOP OF EDGING $\frac{1}{4}$ " ABOVE COMPACTED FINISH GRADE. FINISH GRADE TO BE COMPACTED ON BOTH SIDES OF EDGING TO MAINTAIN STABILITY

ALUMINUM EDGE DETAIL SCALE: 1/2'' = 1'-0''

DECIDUOUS TREE PLANTING DETAIL SCALE: 1'' = 3'-0''


NOT FOR CONSTRUCTION


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PLANT	PLANT SCHEDULE						
CODE	<u>QTY</u>	BOTANICAL / COMMON NAME	SIZE	CONTAINER	SPACING	REMARKS	
DECIDU	OUS TE	REES					
CA2.5	2	CARPINUS CAROLINIANA / AMERICAN HORNBEAM	2.5" CAL.	B&B	PER PLAN		
GBM2.5	1	GINKGO BILOBA 'MAGYAR' / MAGYAR MAIDENHAIR TREE	2.5" CAL.	B&B			
QS2.5	3	QUERCUS ROBUR X ALBA 'JFS-KW1QX' / STREETSPIRE® OAK	2.5" CAL.	B&B	PER PLAN		
	6	SUBTOTAL:					
SHRUBS	3						
JH6	_ 10	JUNIPERUS CHINENSIS 'HETZII' / HETZI JUNIPER	6` HT.	B&B	5` O.C.		
TOS6	25	THUJA OCCIDENTALIS 'SMARAGD' / EMERALD GREEN ARBORVITAE	6` HT.	B&B	36"O.C.		
TO6	22	THUJA OCCIDENTALIS 'TECHNY' / TECHNY ARBORVITAE	6` HT.	B&B	5` O.C.		

SUBTOTAL:

EXISTING	TREES			TREE PROTECTION AND REMO	OVAL	
TAG#	CODE	DBH	COMMON NAME	LATIN NAME	COND	SAVE/REMOVE
200	ZS	10"	Japanese Zelkova	Zelkova serrata	Good	SAVE
201	ZS	11"	Japanese Zelkova	Zelkova serrata	Good	SAVE
202	ZS	13"	Japanese Zelkova	Zelkova serrata	Good	SAVE
203	WO	7''	White Oak	Quercus alba	DEAD	REMOVE
204	zs	6''	Japanese Zelkova	Zelkova serrata	Good	REMOVE
205	ZS	6''	Japanese Zelkova	Zelkova serrata	Good	SAVE
206	LL	8''	Littleleaf Linden	Tilia cordata	Good	SAVE
207	LL	6''	Littleleaf Linden	Tilia cordata	Good	SAVE
208	LL	9''	Littleleaf Linden	Tilia cordata	Good	SAVE
209	RM	15"	Red Maple	Acer rubrum	Good	SAVE
210	LL	10"	Littleleaf Linden	Tilia cordata	Good	SAVE
211	LL	10"	Littleleaf Linden	Tilia cordata	Good	SAVE
212	LL	10"	Littleleaf Linden	Tilia cordata	Good	SAVE
213	LL	17"	Littleleaf Linden	Tilia cordata	Good	SAVE
214	LL	11"	Littleleaf Linden	Tilia cordata	Good	SAVE
215	LL	15''	Littleleaf Linden	Tilia cordata	Good	SAVE
216	LL	12"	Littleleaf Linden	Tilia cordata	Good	SAVE
217	LL	10"	Littleleaf Linden	Tilia cordata	Good	SAVE
21 8	CM	4''	Crimson King Maple	Acer platanoides 'Crimson King"	Good	REMOVE



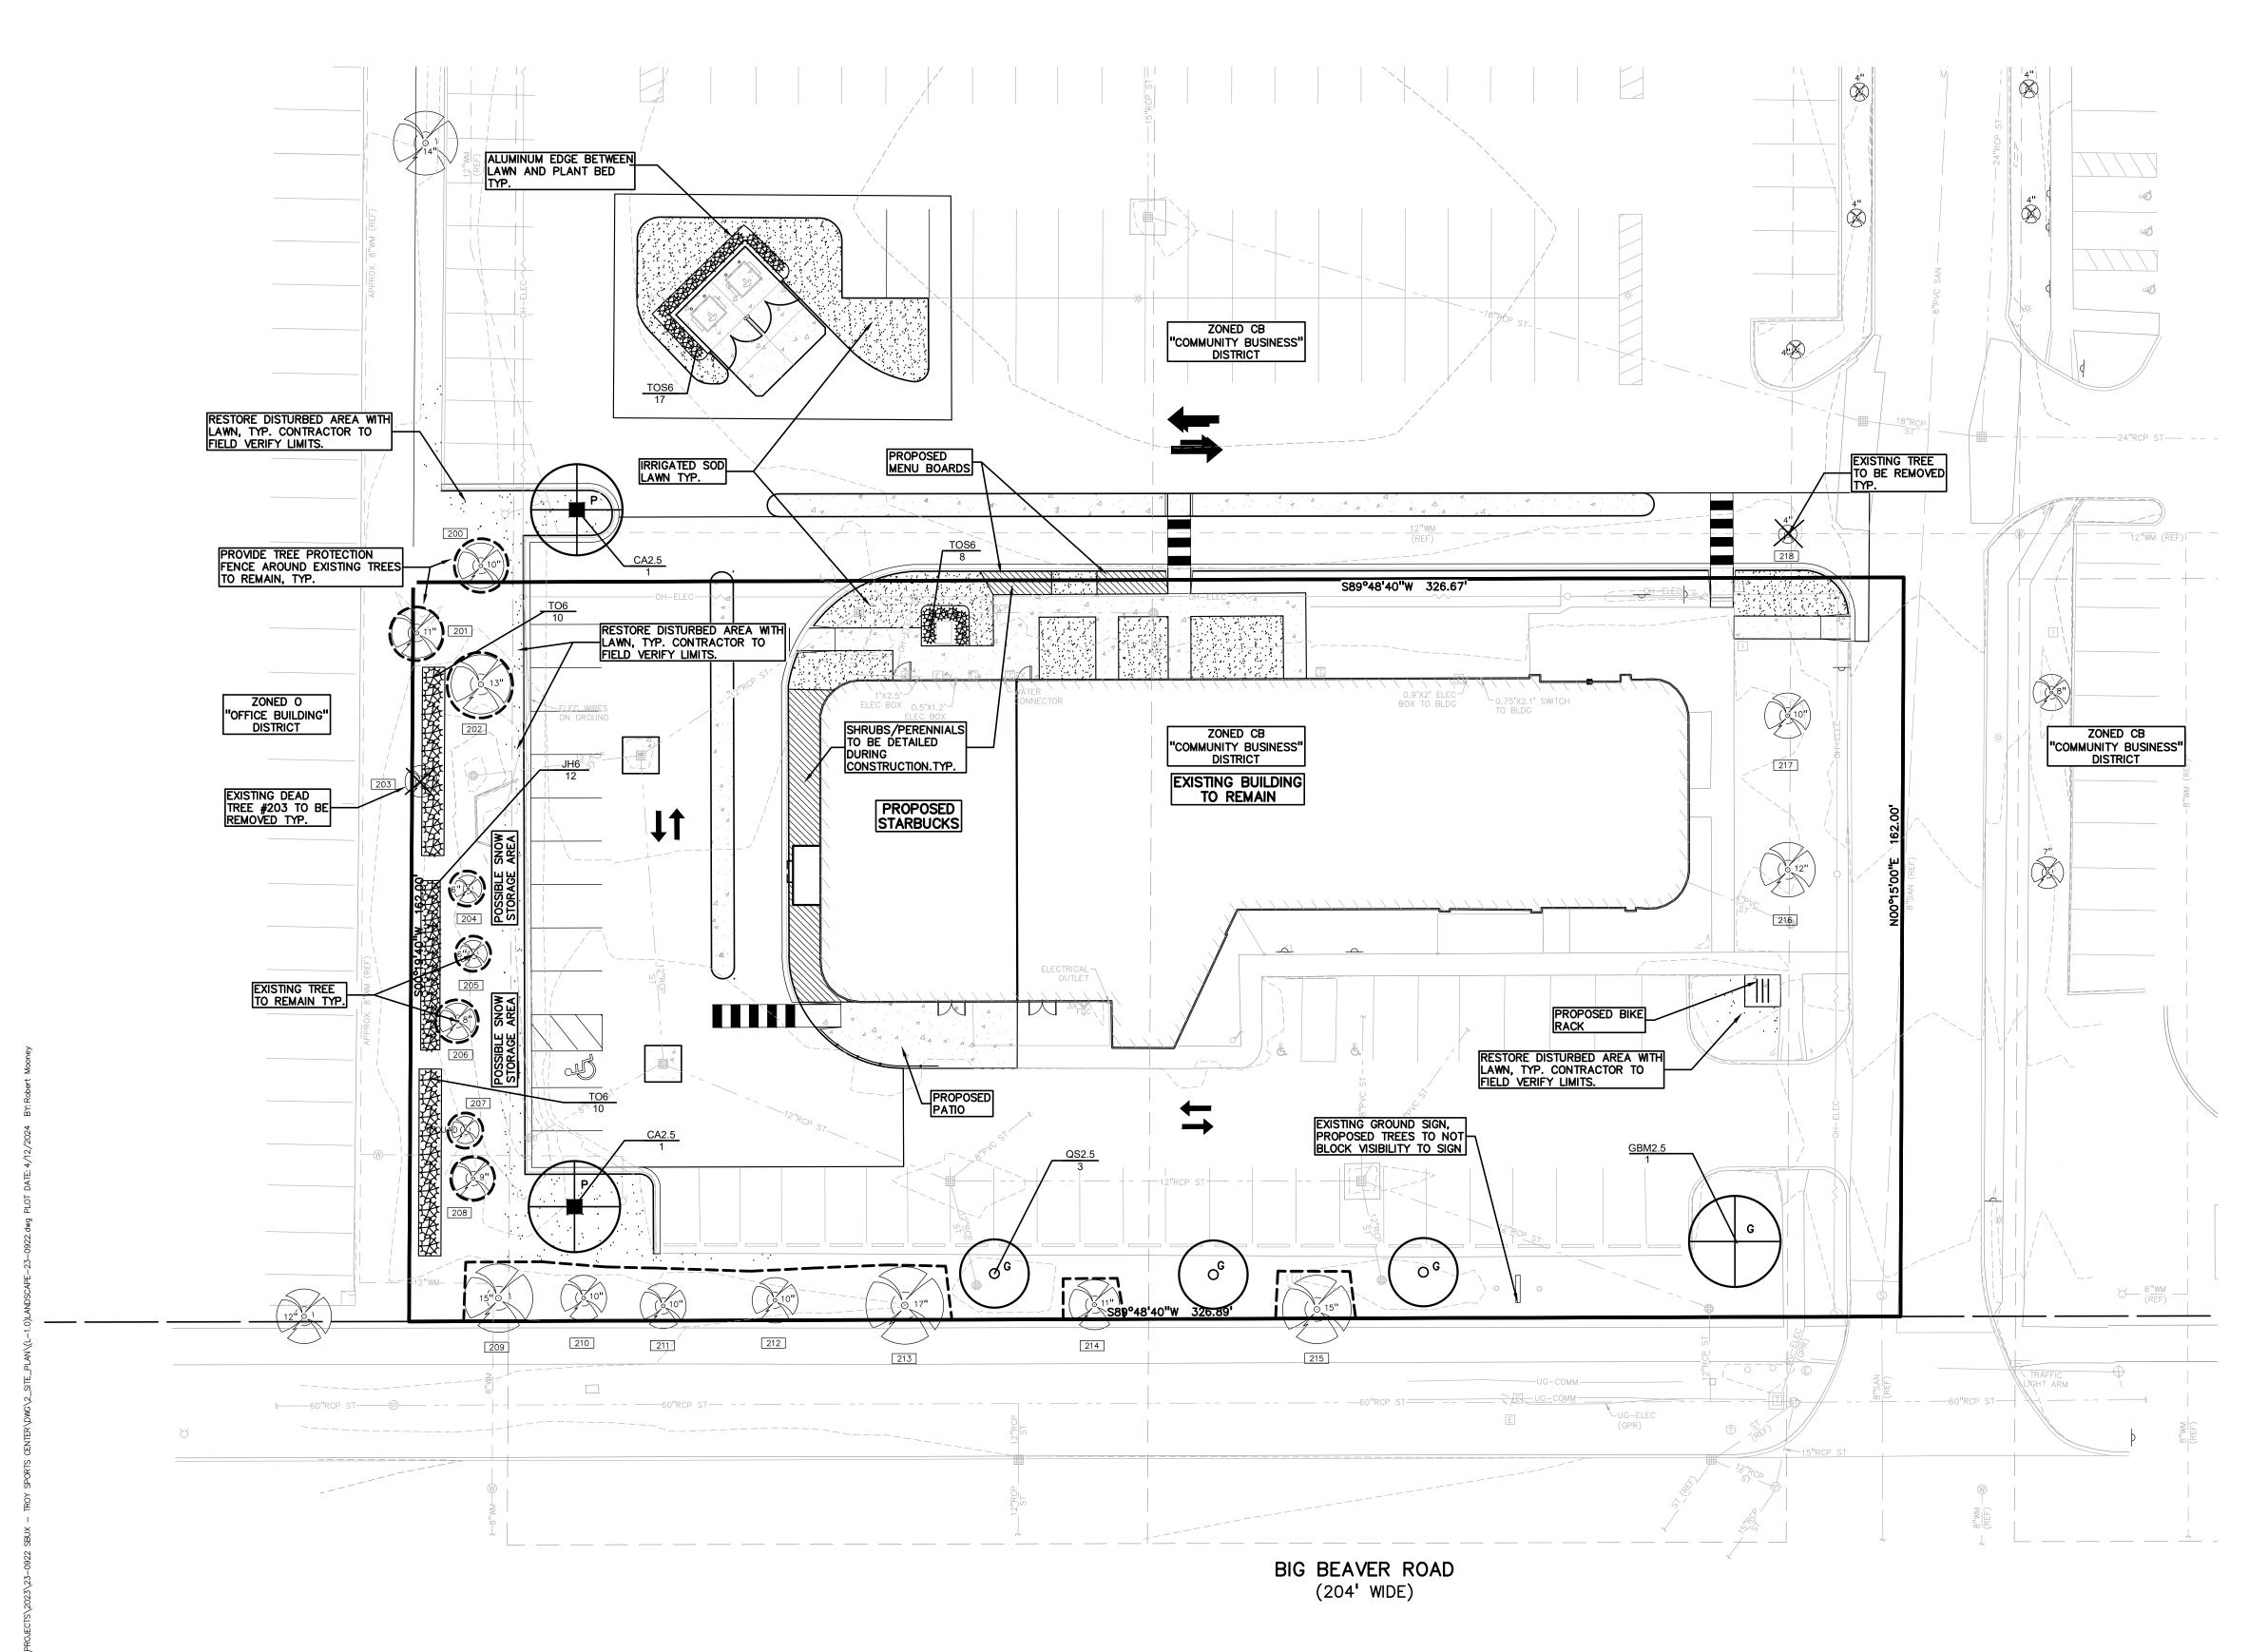

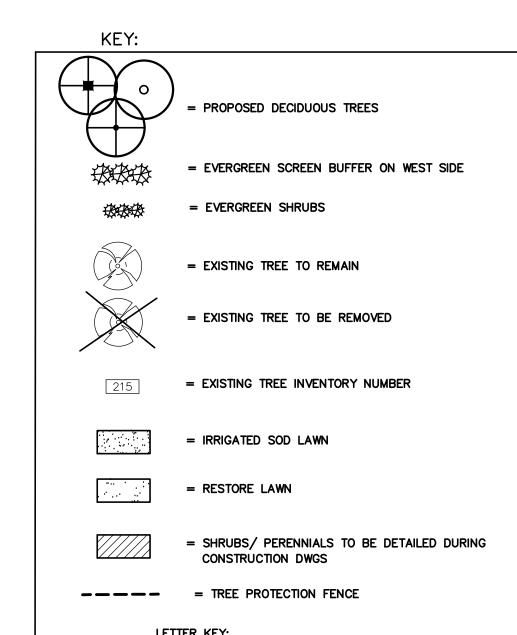LETTER KEY:

P = PARKING LOT TREE

G = GREENBELT TREE

SEE SHEET L-1.1 FOR LANDSCAPE DETAILS

LANDSCAPE CALCULATIONS:
PER CITY OF TROY ZONING ORDINANCE;
CB-COMMUNITY BUSINESS DISTRICT

PARKING LOT LANDSCAPING = P
REQUIRED: 1 TREE / 8 PARKING SPACES
18 PARKING SPACES / 8 = 2 TREES

PROVIDED: PROPOSED 2 DEC. TREES

GREENBELT ON BIG BEAVER ROAD RD = G
REQUIRED: 1 DEC TREE / 30 LF OF STREET FRONTAGE
BIG BEAVER RD: 326.89 LF / 30 = 11 TREES

PROVIDED: BIG BEAVER RD: 7 EXISTING TREES AND 4 PROPOSED TREES

GENERAL SITE LANDSCAPE
REQUIRED: 20% OF SITE AREA SHALL BE LANDSCAPE MATERIAL;
1.22 ACRES (52,937 SQ.FT.) * 20% = 10,587.4 SQ FT

PROVIDED: 17,253.96 SQ FT OF SOFT SCAPE (32.59% OF SITE AREA)

EQUIPMENT SCREENING
REQUIRED: AT GRADE EQUIPMENT SHALL BE SCREENED BY EVG
LANDSCAPE MATERIALS AND DUMPSTER.
PROVIDED: EVERGREEN SHRUBS AROUND TRASH AND UTILITIES

SCREENING BETWEEN CONFLICTING USES

REQUIRED: 1 LG EVERGREEN /10 LF OR 1 NARROW EVERGREEN /5 LF WEST SIDE, 162 LF /10 = 16 LG EVG OR 162 LF/5 = 32 NARROW EVG.


PROVIDED: 32 NARROW EVERGREEN WEST SIDE


GENERAL PLANTING NOTES:

- 1. LANDSCAPE CONTRACTOR SHALL VISIT SITE, INSPECT EXISTING SITE CONDITIONS AND REVIEW PROPOSED PLANTING AND RELATED WORK. IN CASE OF DISCREPANCY BETWEEN PLAN AND PLANT LIST, PLAN SHALL GOVERN QUANTITIES. CONTACT LANDSCAPE ARCHITECT WITH ANY CONCERNS.
- 2. CONTRACTOR SHALL VERIFY LOCATIONS OF ALL ON SITE UTILITIES PRIOR TO BEGINNING CONSTRUCTION ON HIS/HER PHASE OF WORK. ELECTRIC, GAS, TELEPHONE, CABLE TELEVISION MAY BE LOCATED BY CALLING MISS DIG 1-800-482-7171. ANY DAMAGE OR INTERRUPTION OF SERVICES SHALL BE THE RESPONSIBILITY OF CONTRACTOR. CONTRACTOR SHALL COORDINATE ALL RELATED ACTIVITIES WITH OTHER TRADES ON THE JOB AND SHALL REPORT ANY UNACCEPTABLE JOB CONDITIONS TO OWNER'S REPRESENTATIVE PRIOR TO
- ALL PLANT MATERIAL TO BE PREMIUM GRADE NURSERY STOCK AND SHALL SATISFY AMERICAN ASSOCIATION OF NURSERYMEN STANDARD FOR NURSERY STOCK. ALL LANDSCAPE MATERIAL SHALL BE NORTHERN GROWN, NO. 1. GRADE.
- 4. CONTRACTOR IS RESPONSIBLE FOR VERIFYING ALL QUANTITIES SHOWN ON LANDSCAPE PLAN PRIOR TO PRICING THE WORK.
- 5. THE OWNER'S REPRESENTATIVE RESERVES THE RIGHT TO REJECT ANY PLANT MATERIAL NOT MEETING SPECIFICATIONS.
- ALL SINGLE STEM SHADE TREES TO HAVE STRAIGHT TRUNKS AND SYMMETRICAL CROWNS.
- 7. ALL SINGLE TRUNK SHADE TREES TO HAVE A CENTRAL LEADER; TREES WITH FORKED OR IRREGULAR TRUNKS WILL NOT BE ACCEPTED.
- 3. ALL MULTI STEM TREES SHALL BE HEAVILY BRANCHED AND HAVE SYMMETRICAL CROWNS. ONE SIDED TREES OR THOSE WITH THIN OR OPEN CROWNS SHALL NOT BE ACCEPTED.
- . ALL EVERGREEN TREES SHALL BE HEAVILY BRANCHED AND FULL TO THE GROUND, SYMMETRICAL IN SHAPE AND NOT SHEARED FOR THE LAST FIVE GROWING SEASONS.
- 10. ALL TREES TO HAVE CLAY OR CLAY LOAM BALLS, TREES WITH SAND BALLS WILL BE REJECTED.
- 11. NO MACHINERY IS TO BE USED WITHIN THE DRIP LINE OF EXISTING TREES; HAND GRADE ALL LAWN AREAS WITHIN THE DRIP LINE OF EXISTING TREES.
- 12. ALL TREE LOCATIONS SHALL BE STAKED BY LANDSCAPE CONTRACTOR AND ARE SUBJECT TO THE APPROVAL OF THE LANDSCAPE ARCHITECT PRIOR TO INSTALLATION OF THE PLANT MATERIAL.
- 3. IT IS MANDATORY THAT POSITIVE DRAINAGE IS PROVIDED AWAY FROM ALL BUILDINGS
- 4. ALL PLANTING BEDS SHALL RECEIVE 3" SHREDDED HARDWOOD BARK MULCH WITH PRE EMERGENT, SEE SPECIFICATIONS. SHREDDED PALETTE AND DYED MULCH WILL NOT BE ACCEPTED.
- 15. ALL LANDSCAPED AREAS SHALL RECEIVE 3" COMPACTED TOPSOIL.
- 16. SEE SPECIFICATIONS FOR ADDITIONAL COMMENTS, REQUIREMENTS, PLANTING PROCEDURES AND WARRANTY STANDARDS.
- 7. FOR NON-LAWN SEED MIX AREAS, AS NOTED ON PLAN, BRUSH MOW ONCE SEASONALLY FOR INVASIVE SPECIES CONTROL.
- B. CONTRACTOR SHALL NOT INSTALL PLANTS UNDER BUILDING OVERHANG AND SHALL NOTIFY LANDSCAPE ARCHITECT IF DRAWINGS CONFLICT WITH BUILDING OVERHANGS.
- . TREES SHALL NOT CONFLICT/ BLOCK PROPOSED REGULATORY/ DIRECTION SIGNAGE, MONUMENT SIGNS, ADDRESS OR LIGHT POLES. SHIFT TREES AS

PEA GROUP t: 844.813.2949 www.peagroup.com



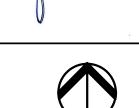

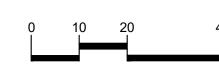




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LOCATION MAP



CLIENT

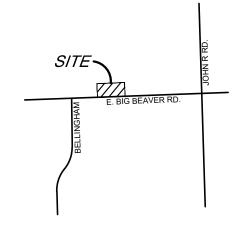TROY SPORTS CENTER, LLC 803 W. BIG BEAVER ROAD, SUITE 100 TROY, MICHIGAN 48084

PROJECT TITLE

STARBUCKS


1735 E. BIG BEAVER ROAD
CITY OF TROY, OAKLAND COUNTY, MICHIGAN


ORIGINAL ISSUE DATE: FEBRUARY 05, 2024 DRAWING TITLE

PRELIMINARY LANDSCAPE PLAN

PEA JOB NO.	23-0922
P.M.	JPE
DN.	CAL
DES.	JLE
DRAWING NUMBER:	


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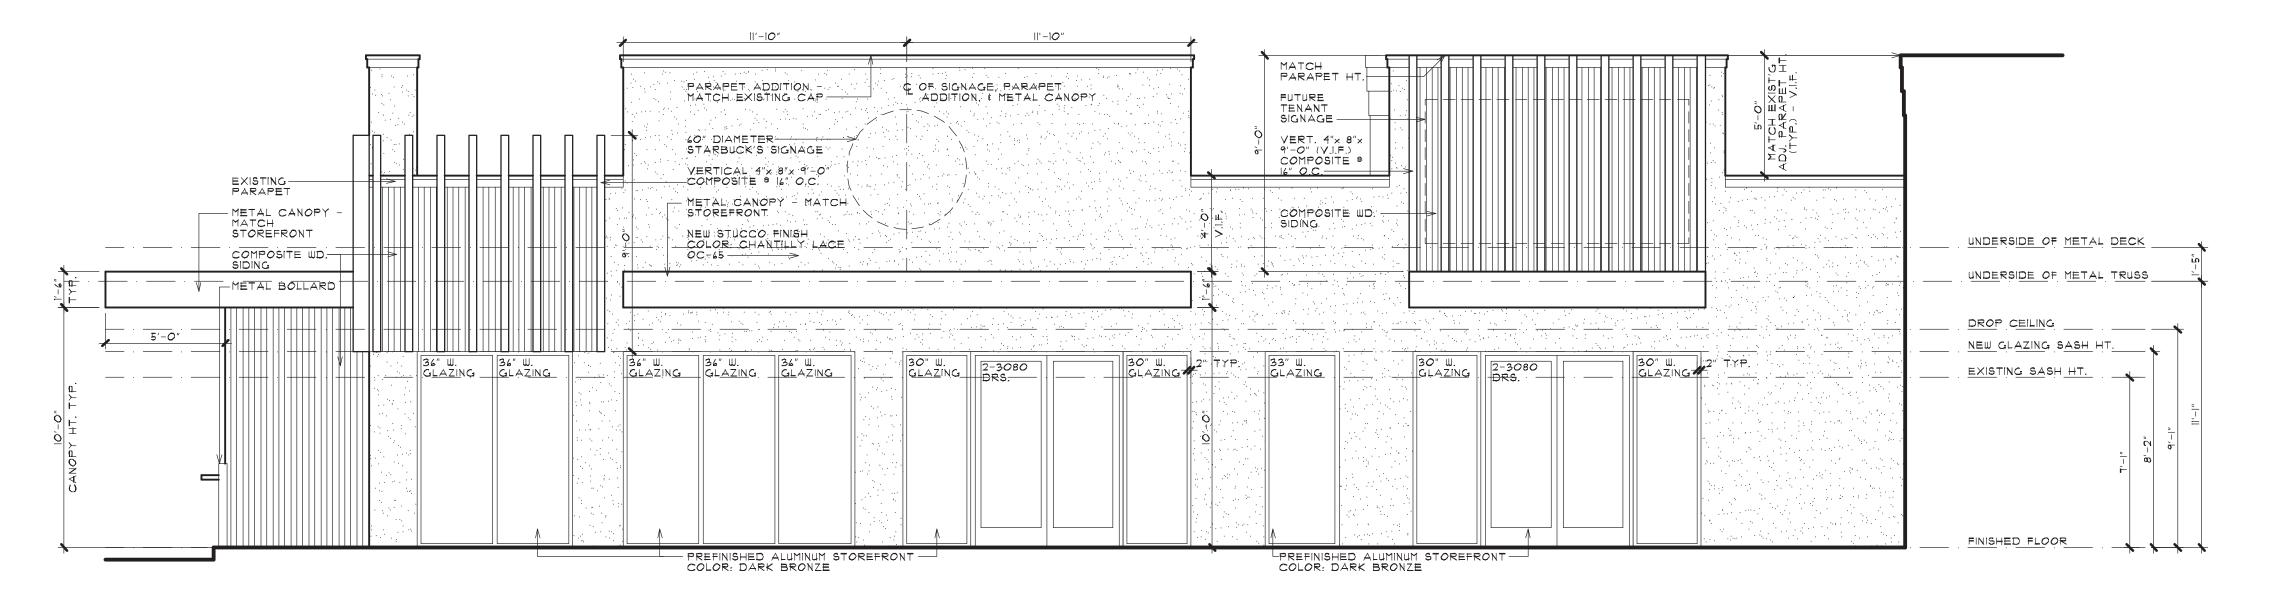
REAR ELEVATION

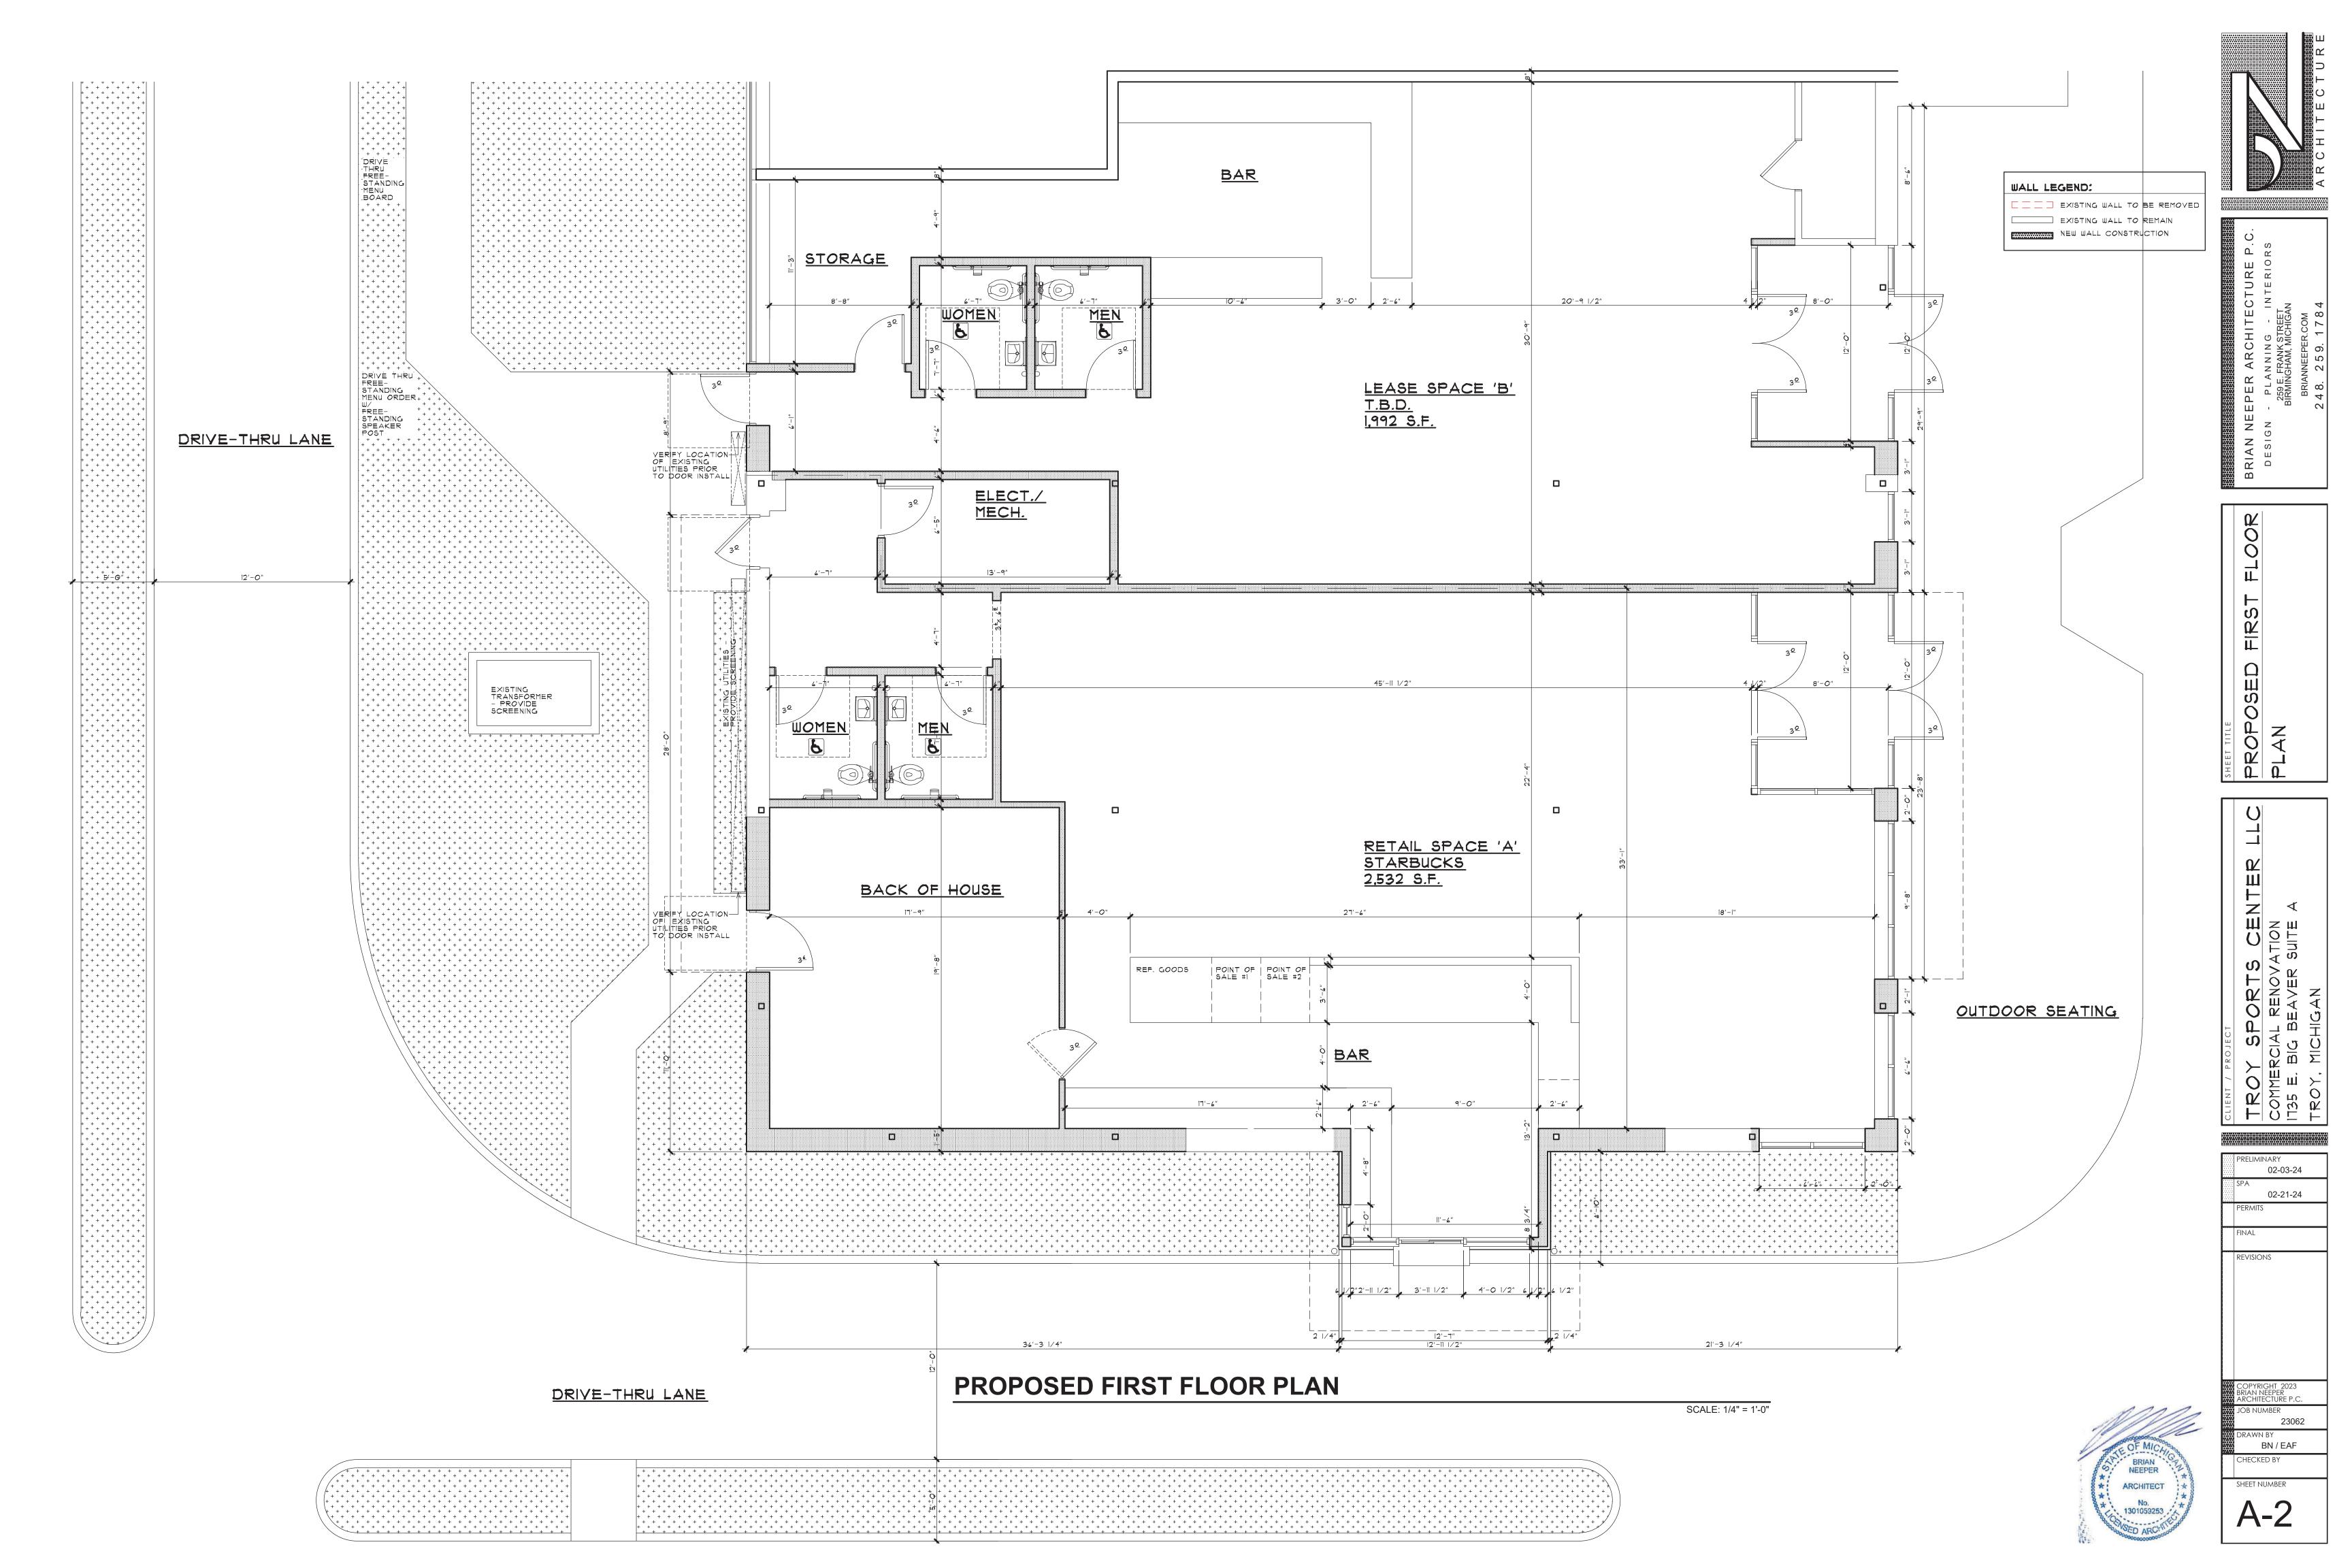SCALE: 1/4" = 1'-0"

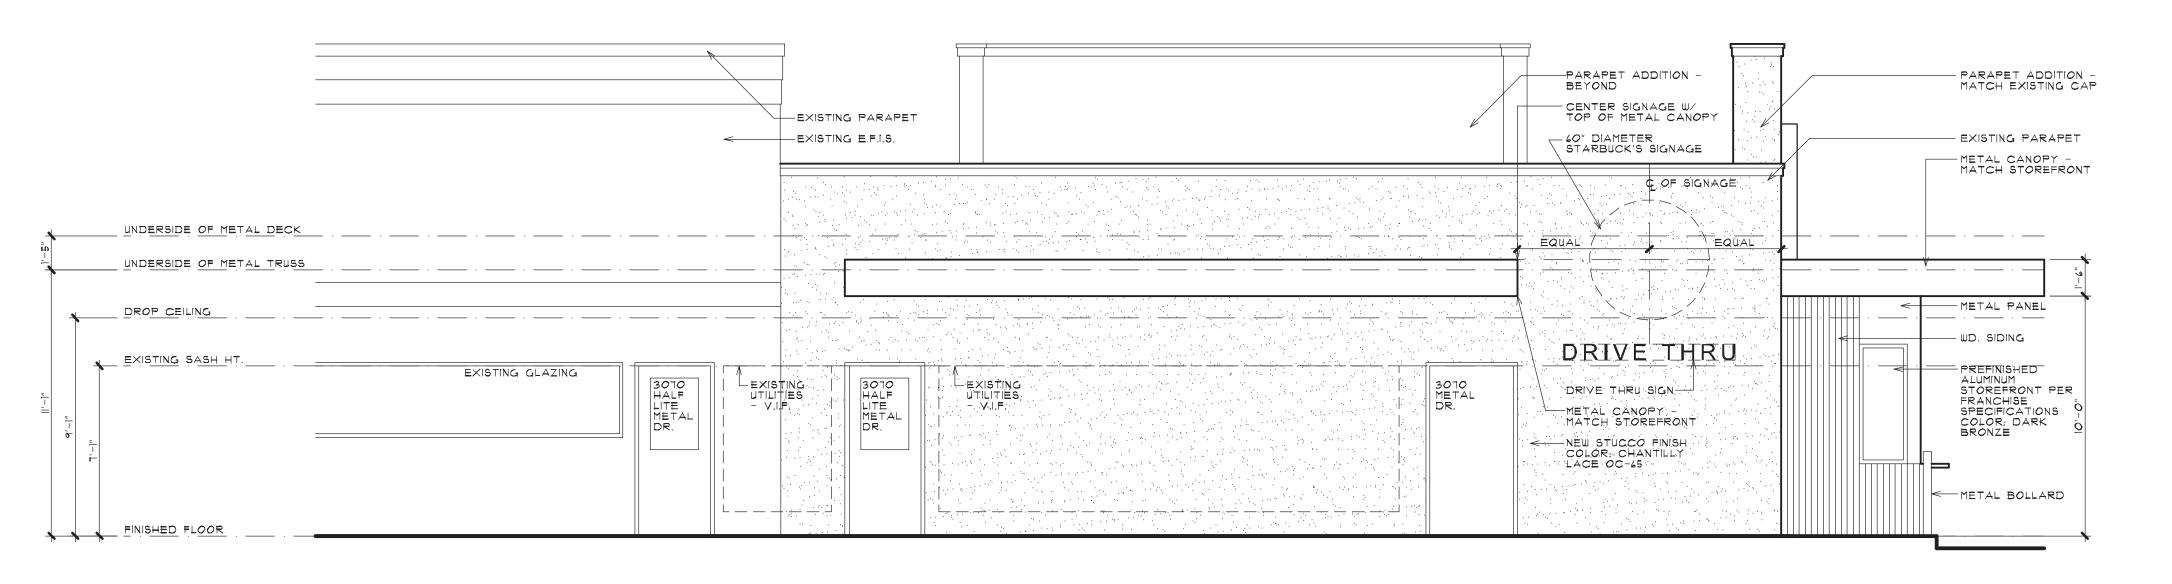

LEFT SIDE ELEVATION

SCALE: 1/4" = 1'-0"

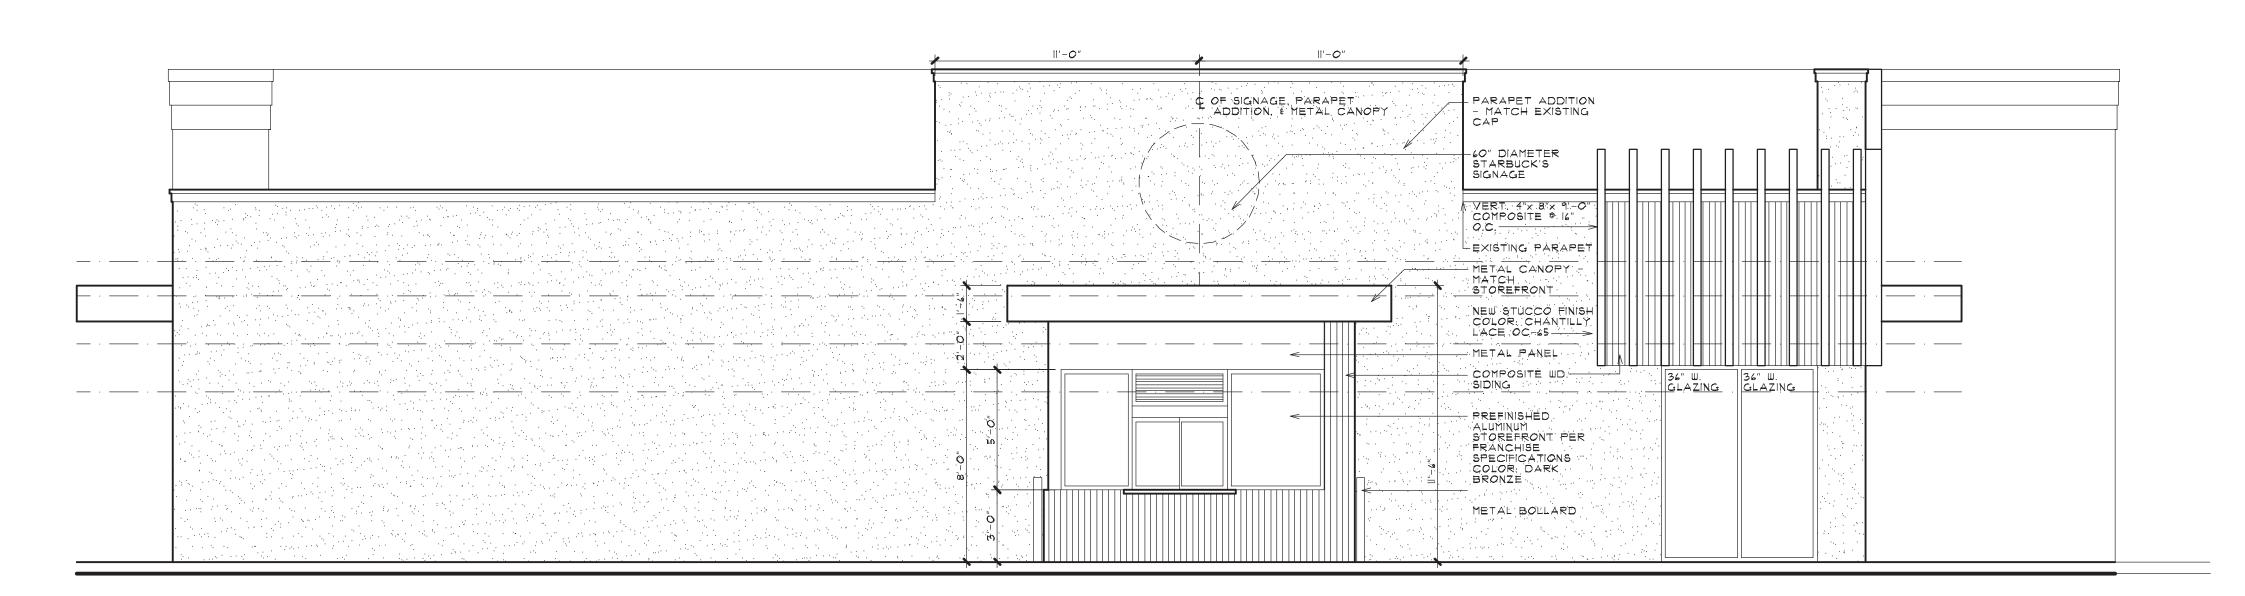

FRONT ELEVATION


SCALE: 1/4" = 1'-0"



02-03-24 02-21-24

BN / EAF

ARCHITECT

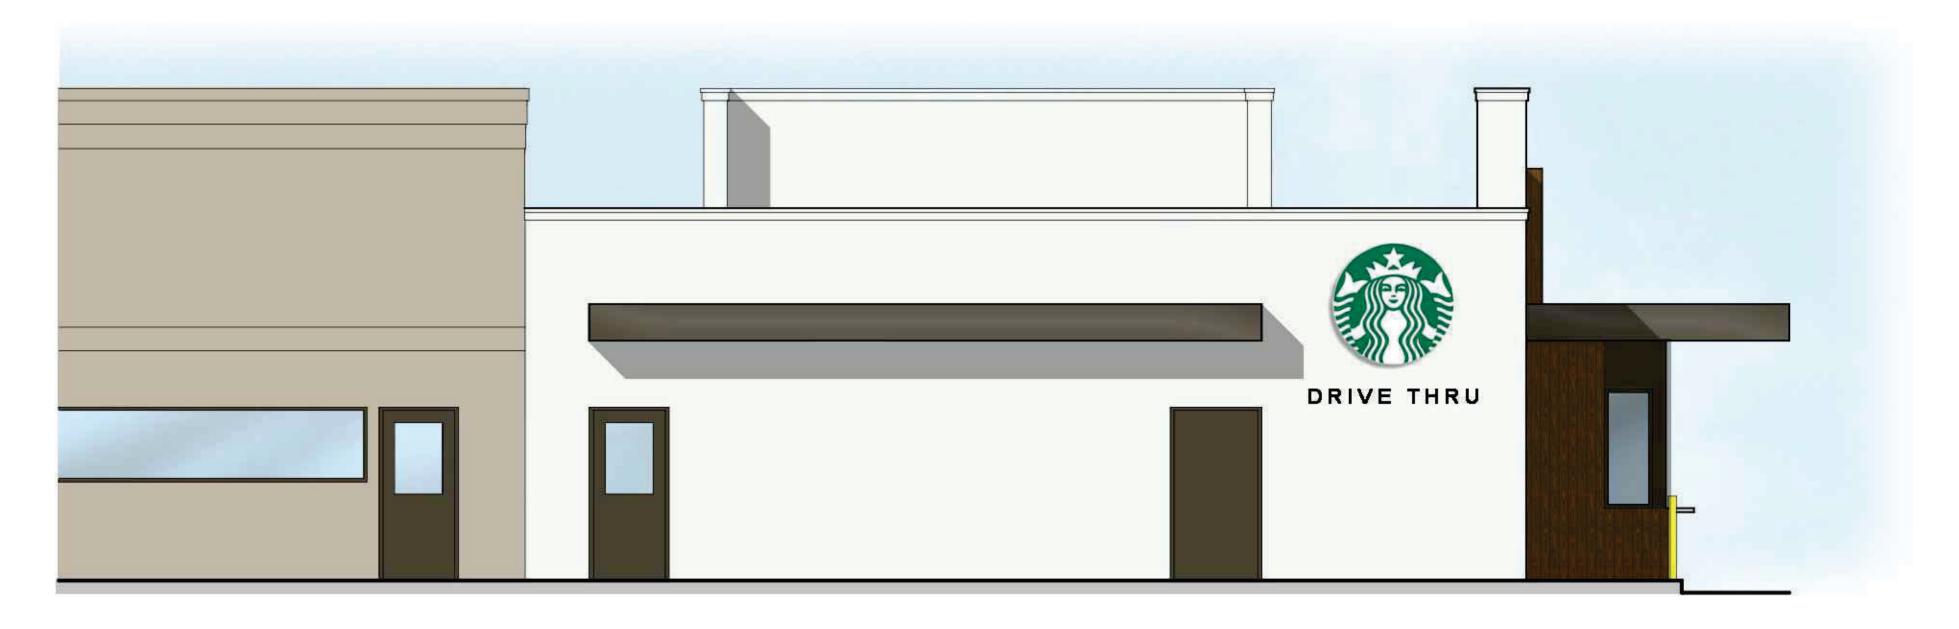

REAR ELEVATION




LEFT SIDE ELEVATION



FRONT ELEVATION

CALE: 1/4" = 1'-0"

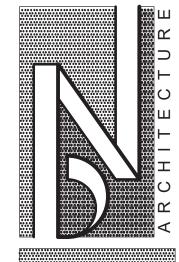

BRIAN NEEPER ARCHITECTURE P.C.

DESIGN - PLANNING - INTERIORS
259 E. FRANK STREET
BIRMINGHAM, MICHIGAN
BRIANNEEPER.COM

MINUTATIO TITIVA IIONS

TROY SPORTS CENTER LI
COMMERCIAL RENOVATION
1135 E. BIG BEAVER SUITE A
TROY MICHIGAN

PRELIMINARY

PRELIMINARY 02-03-24

SPA 02-21-24

INAL

REVISIONS

REVISIONS

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BRIAN NEEPER
ARCHITECTURE P.C.

JOB NUMBER
23062

DRAWN BY

JOB NUMBER
23062

DRAWN BY
BN / EAF

CHECKED BY

A-4

ITEM #7

DATE: May 9, 2024

TO: Planning Commission

FROM: R. Brent Savidant, Community Development Director

SUBJECT: PRELIMINARY SITE PLAN APPROVAL (JPLN2023-0028) - Proposed John R

Commons Townhome Development, West side of John R, North of Big Beaver (PIN 88-20-23-476-017), Section 23, Zoned MF (Multi-Family Residential) Zoning District.

The petitioner Troy Sports Center, LLC. submitted the above referenced Preliminary Site Plan application for a 118-unit townhome development. The property is currently zoned MF (Multi-Family) Zoning District. Two-story attached residential units are permitted by right in the MF district. The Planning Commission is responsible for granting Preliminary Site Plan approval for this item.

The Planning Commission considered this item on January 23, 2024 and postponed the item to provide the applicant an opportunity to address the Planning Commission comments:

- 1. Landscape buffer on the south side of the development.
- 2. Landscape enhancements.
- Pedestrian amenities.
- 4. Vehicular access at the southwest entrance.
- 5. Recreational amenities.
- 6. Consideration of saving additional trees.

The attached report prepared by Carlisle/Wortman Associates, Inc. (CWA), the City's Planning Consultant, summarizes the project. CWA prepared the report with input from various City departments including Planning, Engineering, Public Works and Fire. City Management supports the findings of fact contained in the report and the recommendations included therein.

Attachments:

- 1. Maps
- 2. Minutes from January 23, 2024 Planning Commission Regular meeting (excerpt).
- 3. Report prepared by Carlisle/Wortman Associates, Inc.
- 4. Preliminary site plan

G:\SITE PLANS\SP_JPLN2023-0028_JOHN R COMMONS TOWNHOME DEVELOPMENT\PC Memo 2024 05 14.docx

PROPOSED RESOLUTION

PRELIMINARY SITE PLAN APPROVAL (JPLN2023-0028) — Proposed John R Gardens Townhome Development, East side of John R, north of Big Beaver (PIN 88-20-23-476-017), Section 23, Zoned MF (Multi-Family Residential) Zoning District.

Resol	ution	#PC-	202	4-05-
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Moved by: Seconded by:

RESOLVED, That Preliminary Site Plan Approval, pursuant to Article 8 of the Zoning Ordinance, as requested for the proposed John R Gardens Townhome Development, located on the East side of John R, North of Big Beaver, Section 23, Zoned MF (Multi-Family Residential) District, be granted, subject to applicant the following:

) or
(denied, for the following reasons:) or
(postponed, for the following reasons:)
Yes: No:	

MOTION CARRIED/FAILED



GIS Online




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TROY

1,153

GIS Online

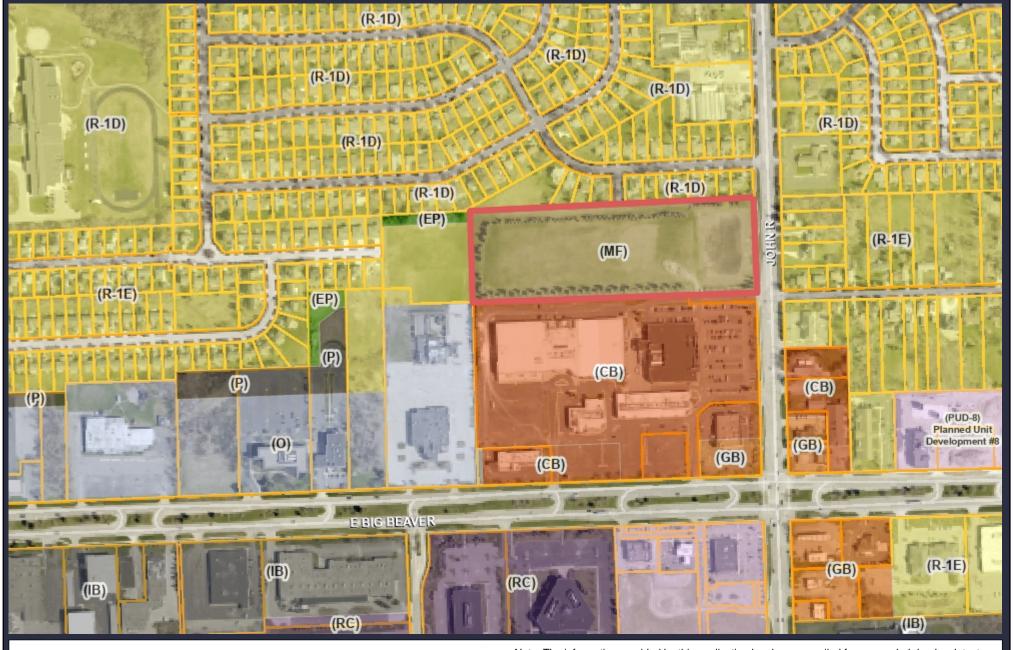

1,153Feet

577

Note: The information provided by this application has been compiled from recorded deeds, plats, tax maps, surveys, and other public records and data. It is not a legally recorded map survey. Users of this data are hereby notified that the source information represented should be consulted for verification.



117 NORTH FIRST STREET SUITE 70 ANN ARBOR, MI 48104 734.662.2200 734.662.1935 FAX

Date: September 18, 2023

December 14, 2023

May 7, 2024

Preliminary Site Plan For City of Troy, Michigan

Applicant: Troy Sports Center, LLC & JSD Real Estate, LLC

Project Name: John R Townhome Development

Plan Date: March 1, 2024

Location: Eastside of John R Road, North of Big Beaver

Zoning: MF, Multiple Family Residential

Action Requested: Preliminary Site Plan Approval

PROJECT AND SITE DESCRIPTION

An application has been submitted for a proposed multiple family building on the east side of John R Road just north of Big Beaver. The subject site is 11.86 acres. The site is currently vacant and used in part as stormwater detention.

The applicant is requesting approval of one hundred eighteen (118) units. The one hundred eighteen (118) units are distributed in twenty (20) buildings. The proposed residential use is permitted in the MF, Multiple Family district. The development is accessed via one proposed egress/ingress along Nancy Bostwick Drive as well as a secondary egress/ingress drive located at the western end of the development connecting to the Troy Sports Complex retail center. The site is served with internal private roadways.

The site is currently one parcel. There are no existing structures on the site.

Location of subject site:

East side of John R Road, north of Big Beaver Road.

Location and Aerial Image of Subject Site



Size of subject site:

The property is 11.68 acres in area.

Proposed use of subject site:

The proposed use is for one hundred eighteen (118) units.

John R Townhome Development May 7, 2024

Current use of subject site:

The property currently is vacant.

Current Zoning:

The property is currently zoned MF, Multiple Family Residential District.

Surrounding Property Details:


Direction	Zoning	<u>Use</u>
North	R1-D, One Family Residential District	Single Family Housing
South	CB, Community Business	Retail and Commercial Recreation
East	R1-E, One Family Residential District	Single Family Housing
West	R1-E, One Family Residential District	BWW Soccer Fields (Recreation)

PREVIOUS PLANNING COMMISSION REVIEW

The application was last reviewed by the Planning Commission on January 23, 2024. After lengthy discussion, the application was postponed for the following reasons to address the following Planning Commission comments:

- 1. Landscape buffer on the south side of the development
- 2. Landscape enhancements
- 3. Pedestrian amenities
- 4. Vehicular access at the southwest entrance
- 5. Recreational amenities
- 6. Consideration of saving additional trees

CHANGES SINCE LAST REVIEW

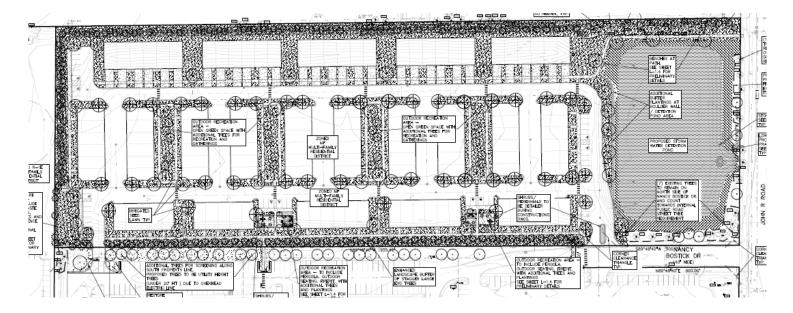

Landscape buffer on the south side of the development

The applicant has added 26 trees along the northern property line of the Troy Sports Arena site, which supplements the double row of trees along the southern property line.

Landscape enhancements

In addition to trees on the Troy Sport Arena site, the applicant has added interior trees to the development along internal sidewalks, trees in the courtyard between the buildings, and trees along the detention pond. The proposed amount of trees exceed ordinance requirements.

Pedestrian amenities

The applicant is providing a complete pedestrian circulation system within development with access to John R Road, Nancy Bostwick Drive and the Troy Sports Area site. In addition, a sidewalk is proposed to the north to connect with Floyd Drive. This will provide a pedestrian connection to Baker Middle School and the International Academy.

Vehicular access at the southwest entrance

The applicant has added the following traffic calming devices between the Troy Sports Arena and the proposed development:

- Striped cross walk from development to Troy Sports Arena
- Stop sign exiting development
- Speed limit sign
- "Slow" and "10 MPH" pavement markings

Recreational amenities

The applicant is proposing the following recreational amenities:

- Two outdoor areas which include pergola, outdoor seating, firepit, and landscaping
- Dog Park
- Internal sidewalks

Consideration of saving additional trees

The applicant was unable to preserve any additional trees.

Replacement Details		
Protected Tree	Inches Removed	Replacement Required
Landmark	18 inches	18 inches
Woodland	1080 inches	540 inches
Preservation/Mitigation	Inches Preserved	Credit
Landmark	0 inches	0 inches
Woodland	234 inches	468 inches
Total	90 inches required for replacement.	

SITE PLAN REVIEW STANDARDS

Section 8.06 outlines Site Plan Review Design Standards.

- 1. Development shall ensure compatibility to existing commercial districts and provide a transition between land uses.
 - a. Building design shall enhance the character of the surrounding area in relation to building and parking placement, landscape and streetscape features, and architectural design.
 - b. Street fronts shall provide a variety of architectural expression that is appropriate in its context and prevents monotony.
 - c. Building design shall achieve a compatible transition between areas with different height, massing, scale, and architectural style.
- 2. Development shall incorporate the recognized best architectural building design practices.
 - a. Foster a lasting impact on the community through the provision of high quality design, construction, and detailing.
 - b. Provide high quality, durable materials, such as but not limited to stone, brick, glass, and metal. E.I.F.S. or material equivalent shall only be used as an accent material.
 - c. Develop buildings with creativity that includes balanced compositions and forms.
 - d. Design roofs that are appropriate to the architectural style of the building and create an appropriate visual exterior mass of the building given the context of the site.
 - e. For commercial buildings, incorporate clearly defined, highly visible customer entrances using features such as canopies, porticos, arcades, arches, wing walls, ground plane elements, and/or landscape planters.

- f. Include community amenities that add value to the development such as patio/ seating areas, water features, art work or sculpture, clock towers, pedestrian plazas with park benches or other features located in areas accessible to the public.
- 3. Enhance the character, environment and safety for pedestrians and motorists.
 - a. Provide elements that define the street and the pedestrian realm.
 - b. Create a connection between the public right of way and ground floor activities.
 - c. Create a safe environment by employing design features to reduce vehicular and pedestrian conflict, while not sacrificing design excellence.
 - d. Enhance the pedestrian realm by framing the sidewalk area with trees, awnings, and other features.
 - e. Improve safety for pedestrians through site design measures.

Items to be Addressed: Planning Commission to consider if site plan standards have been met.

RECOMMENDATIONS

The Planning Commission should review the development and confirm if the site plan standards have been met.

CARLISLE/WORTMAN ASSOC., INC. Benjamin R. Carlisle, LEED AP, AICP

PRELIMINARY SITE PLAN

5. <u>PRELIMINARY SITE PLAN APPROVAL (JPLN2023-0028)</u> – Proposed John R Commons Townhome Development, West side of John R, North of Big Beaver (PIN 88-20-23-476-017), Section 23, Zoned MF (Multi-Family Residential) Zoning District

Mr. Savidant announced three dimensional (3-D) color renderings requested of the applicant are displayed in the visual presentation this evening.

Mr. Carlisle gave a brief history of a previous 2019 application of the John R Commons Townhome Development in which the applicant requested a rezoning of the parcels and was denied by the City Council. Mr. Carlisle stated the application before the Board this evening is a by-right development and not for a rezoning change. He identified the significant changes to the application as relates to a reduction in the number of units, alignment of five apartment buildings along the south property line, reconfiguration of the detention pond, a reduction of size/massing of the buildings abutting the northern property line, elimination of recreational area and clubhouse, reduction of building height to 25 feet and adding outdoor amenity spaces.

Mr. Carlisle addressed site arrangement, setbacks, building height, buffers along both the north and south property lines, access and circulation, mitigation of trees, trash removal, elevations, landscaping, and parking. He asked the applicant to consider some type of physical screening and/or additional landscaping to improve the buffer adjacent to the commercial uses. Mr. Carlisle asked the applicant to provide color renderings and to address building materials, specifically the type of siding.

Mr. Carlisle announced that the City Traffic Consultant Stephen Dearing of OHM Advisors is present this evening to address any traffic concerns.

In summary, Mr. Carlisle asked the Planning Commission to consider in its deliberations if the application meets Site Plan Review Design Standards (Section 8.06) and that the applicant consider additional screening options including a screen wall with additional landscaping as part of the Final Site Plan submittal.

Some of the comments during discussion among the administration related to:

- Ingress and egress.
- Width of typical residential streets and private roads.
- Public stub street off John R.
- Bicycle parking.
- Green space.
- Recreational amenities.

Property owner/applicant Dennis Bostick, Civil Engineer Greg Bono of PEA and Project Architect Brian Neeper were present.

Mr. Bostick addressed the proposed rezoning that the City Council denied in 2019. He said the 2019 townhome project offered more amenities than the proposed development for Planning Commission consideration this evening. He identified properties he owns, including five acres behind the San Marino Club zoned for single family residential.

There was discussion, some comments related to:

- Ingress and egress.
 - Nancy Bostick Drive
 - o Commercial center to the south.
- Buffer/screening on both the north side adjacent to residential and the south side adjacent to the commercial uses.
 - o Solid screening (brick wall) to buffer residential to north.
 - Additional landscaping.
 - o Difference of north and south density of buffering.
 - Applicant prefers landscaping.
- Potential for light spillage and noise pollution from commercial uses.
- Pedestrian circulation within development; pattern of sidewalks.
- Pedestrian access to commercial uses.
- Commercial entrances; both front and rear.
- Retention pond, as relates to aesthetics.
- Green space, amenities offered; i.e., outdoor seating, dog park, internal sidewalk loops, optional recreational uses.
- Concerns with traffic circulation, traffic pattern.
 - o Internal circulation.
 - Access points.
 - o Safety of children and pedestrians (nearby soccer fields and commercial parking).
 - o Traffic calming devices.
 - Emergency vehicular access (EVA).
- Bicycle parking, location of bicycle spaces.
- Marketing of townhomes; option to rent or own.
- Building materials and color scheme.
- Site arrangement; soften with green space, vertical landscaping.
- Tree survey; removal of landmark tree.
- Architectural features as relates to Site Plan Design Standards.

Mr. Bostick indicated he is amenable to the Planning Commission comments.

City Traffic Consultant Stephen Dearing addressed the ingress and egress accesses off Nancy Bostick Drive and the commercial center to the south. He said the traffic impact study completed for the previously proposed development in 2019 determined that access off Nancy Bostick Drive should be signalized. Mr. Dearing said the reduced density of the proposed development before the Board this evening would generate less traffic. He indicated a rudimentary analysis of generated traffic during peak hours would go either way; to signalize Nancy Bostwick Drive or install an EVA. He addressed traffic calming techniques that might ease concerns for safety.

Chair Perakis opened the floor for public comment. Acknowledging there was no one present who wished to speak, Chair Perakis closed the floor for public comment.

Resolution # PC-2024-01-006

Moved by: Lambert Seconded by: Fox

RESOLVED, That Preliminary Site Plan Approval, pursuant to Article 8 of the Zoning Ordinance, as requested for the proposed John R Commons Townhome Development, located on the West side of John R, North of Big Beaver, Section 23, Zoned MF (Multi-Family Residential) District, be postponed for the following reasons to address the Planning Commission comments:


- 1. Landscape buffer on the south side of the development.
- 2. Landscape enhancements.
- 3. Pedestrian amenities.
- 4. Vehicular access at the southwest entrance.
- Recreational amenities.
- 6. Consideration of saving additional trees.

Yes: All present (9)

MOTION CARRIED

JOHN R COMMONS TOWNHOME DEVELOPMENT

PART OF THE SOUTHEAST 1/4
OF SECTION 23, T.2N, R.11E
CITY OF TROY, OAKLAND COUNTY, MICHIGAN

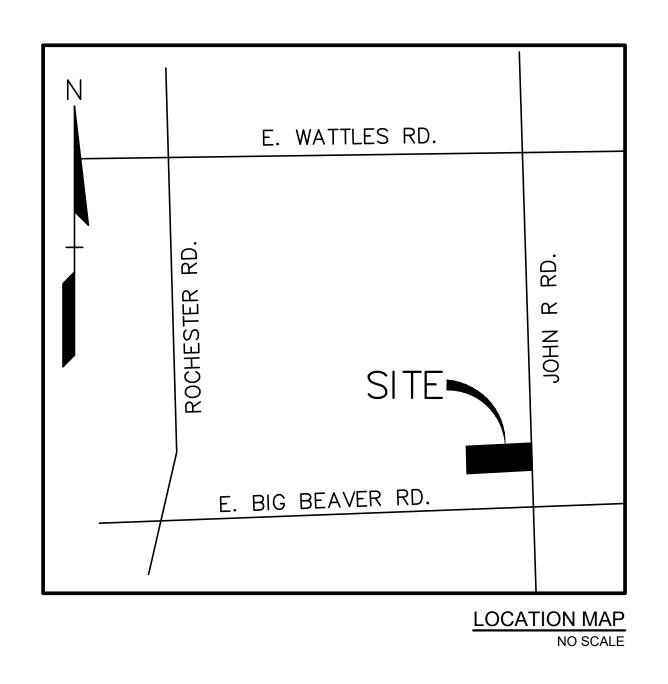

DESIGN TEAM

OWNER/APPLICANT/DEVELOPER

TROY SPORTS CENTER, LLC & JSD REAL ESTATE, LLC
1819 EAST BIG BEAVER ROAD
TROY, MI 48083
CONTACT: DENNIS BOSTICK
PHONE: 248.709.4001
EMAIL: DENNISBOSTICK@ATT.NET

ARCHITECT

BRIAN NEEPER ARCHITECTURE P.C. 630 N. OLD WOODWARD SUITE 203 BIRMINGHAM, MI 48009 CONTACT: BRIAN NEEPER PHONE: 248.259.1784

CIVIL ENGINEER

PEA GROUP
1849 POND RUN
AUBURN HILLS, MI 48326
CONTACT: GREG BONO, PE
PHONE: 844.813.2949
EMAIL: GBONO@PEAGROUP.COM

LANDSCAPE ARCHITECT


PEA GROUP 7927 NEMCO WAY, STE. 115 BRIGHTON, MI 48116 CONTACT: JEFF SMITH, PLA, LEED AP PHONE: 844.813.2949 EMAIL: JSMITH@PEAGROUP.COM

NUMBER	TITLE
C-0.0	COVER SHEET
C-1.1	TOPOGRAPHIC SURVEY
C-1.2	TOPOGRAPHIC SURVEY
C-2.0	OVERALL SITE PLAN
C-2.1	PRELIMINARY SITE PLAN
C-2.2	PRELIMINARY SITE PLAN
C-3.1	PRELIMINARY GRADING PLAN
C-3.2	PRELIMINARY GRADING PLAN
C-4.1	PRELIMINARY UTILITY PLAN
C-4.2	PRELIMINARY UTILITY PLAN
C-5.0	NOTES AND DETAILS
L-1.0	OVERALL LANDSCAPE PLAN
L-1.1	PRELIMINARY LANDSCAPE PLAN - WEST
L-1.2	PRELIMINARY LANDSCAPE PLAN - EAST
L-1.3	LANDSCAPE DETAILS
L-1.4	SITE AMENITY DETAILS
T-1.0	TREE SURVEY PLAN - WEST
T-1.1	TREE SURVEY PLAN - EAST
T-1.2	EXISTING TREE LIST
SL-1.0	LIGHTING PLAN
T-1A	TITLE SHEET
A-1A	BUILDING FOUNDATION PLAN - 5 UNIT
A-2A	BUILDING FIRST & SECOND FLOOR PLANS - 5 UNIT
A-3A	BUILDING ROOF PLAN - 5 UNIT
A-4A	BUILDING FOUNDATION PLAN - 6 UNIT
A-5A	BUILDING FIRST & SECOND FLOOR PLAN - 6 UNIT
A-6A	BUILDING ROOF PLAN - 6 UNIT
A-7A	BUILDING ELEVATIONS - 5 UNIT
A-8A	BUILDING ELEVATIONS - 6 UNIT
A-9A	DWELLING UNIT PLANS
A-10A	UNIT ELEVATIONS
A-11A	BUILDING SECTION & EXTERIOR WALL SECTIONS
A-12A	INTERIOR WALL SECTIONS
A-13A	RENDERED FRONT ELEVATION
T-1	TITLE SHEET
A-1B	BUILDING FOUNDATION PLAN - 6 UNIT
A-2B	BUILDING FIRST & SECOND FLOOR PLANS - 6 UNIT
A-3B	BUILDING ROOF PLAN - 6 UNIT
A-4B	BUILDING ELEVATIONS - 6 UNIT
A-5B	DWELLING UNIT PLANS
A-6B	UNIT ELEVATIONS
^ 7D	BUILDING SECTION & EXTERIOR WALL SECTIONS
A-7B	
A-7B A-8B	INTERIOR WALL SECTIONS RENDERED FRONT ELEVATIONS

INDEX OF DRAWINGS

REVISIO	NS
DESCRIPTION	DATE
ORIGINAL ISSUE DATE	8/18/2023
SPA COMMENTS	11/8/2023
SPA COMMENTS	3/1/2024



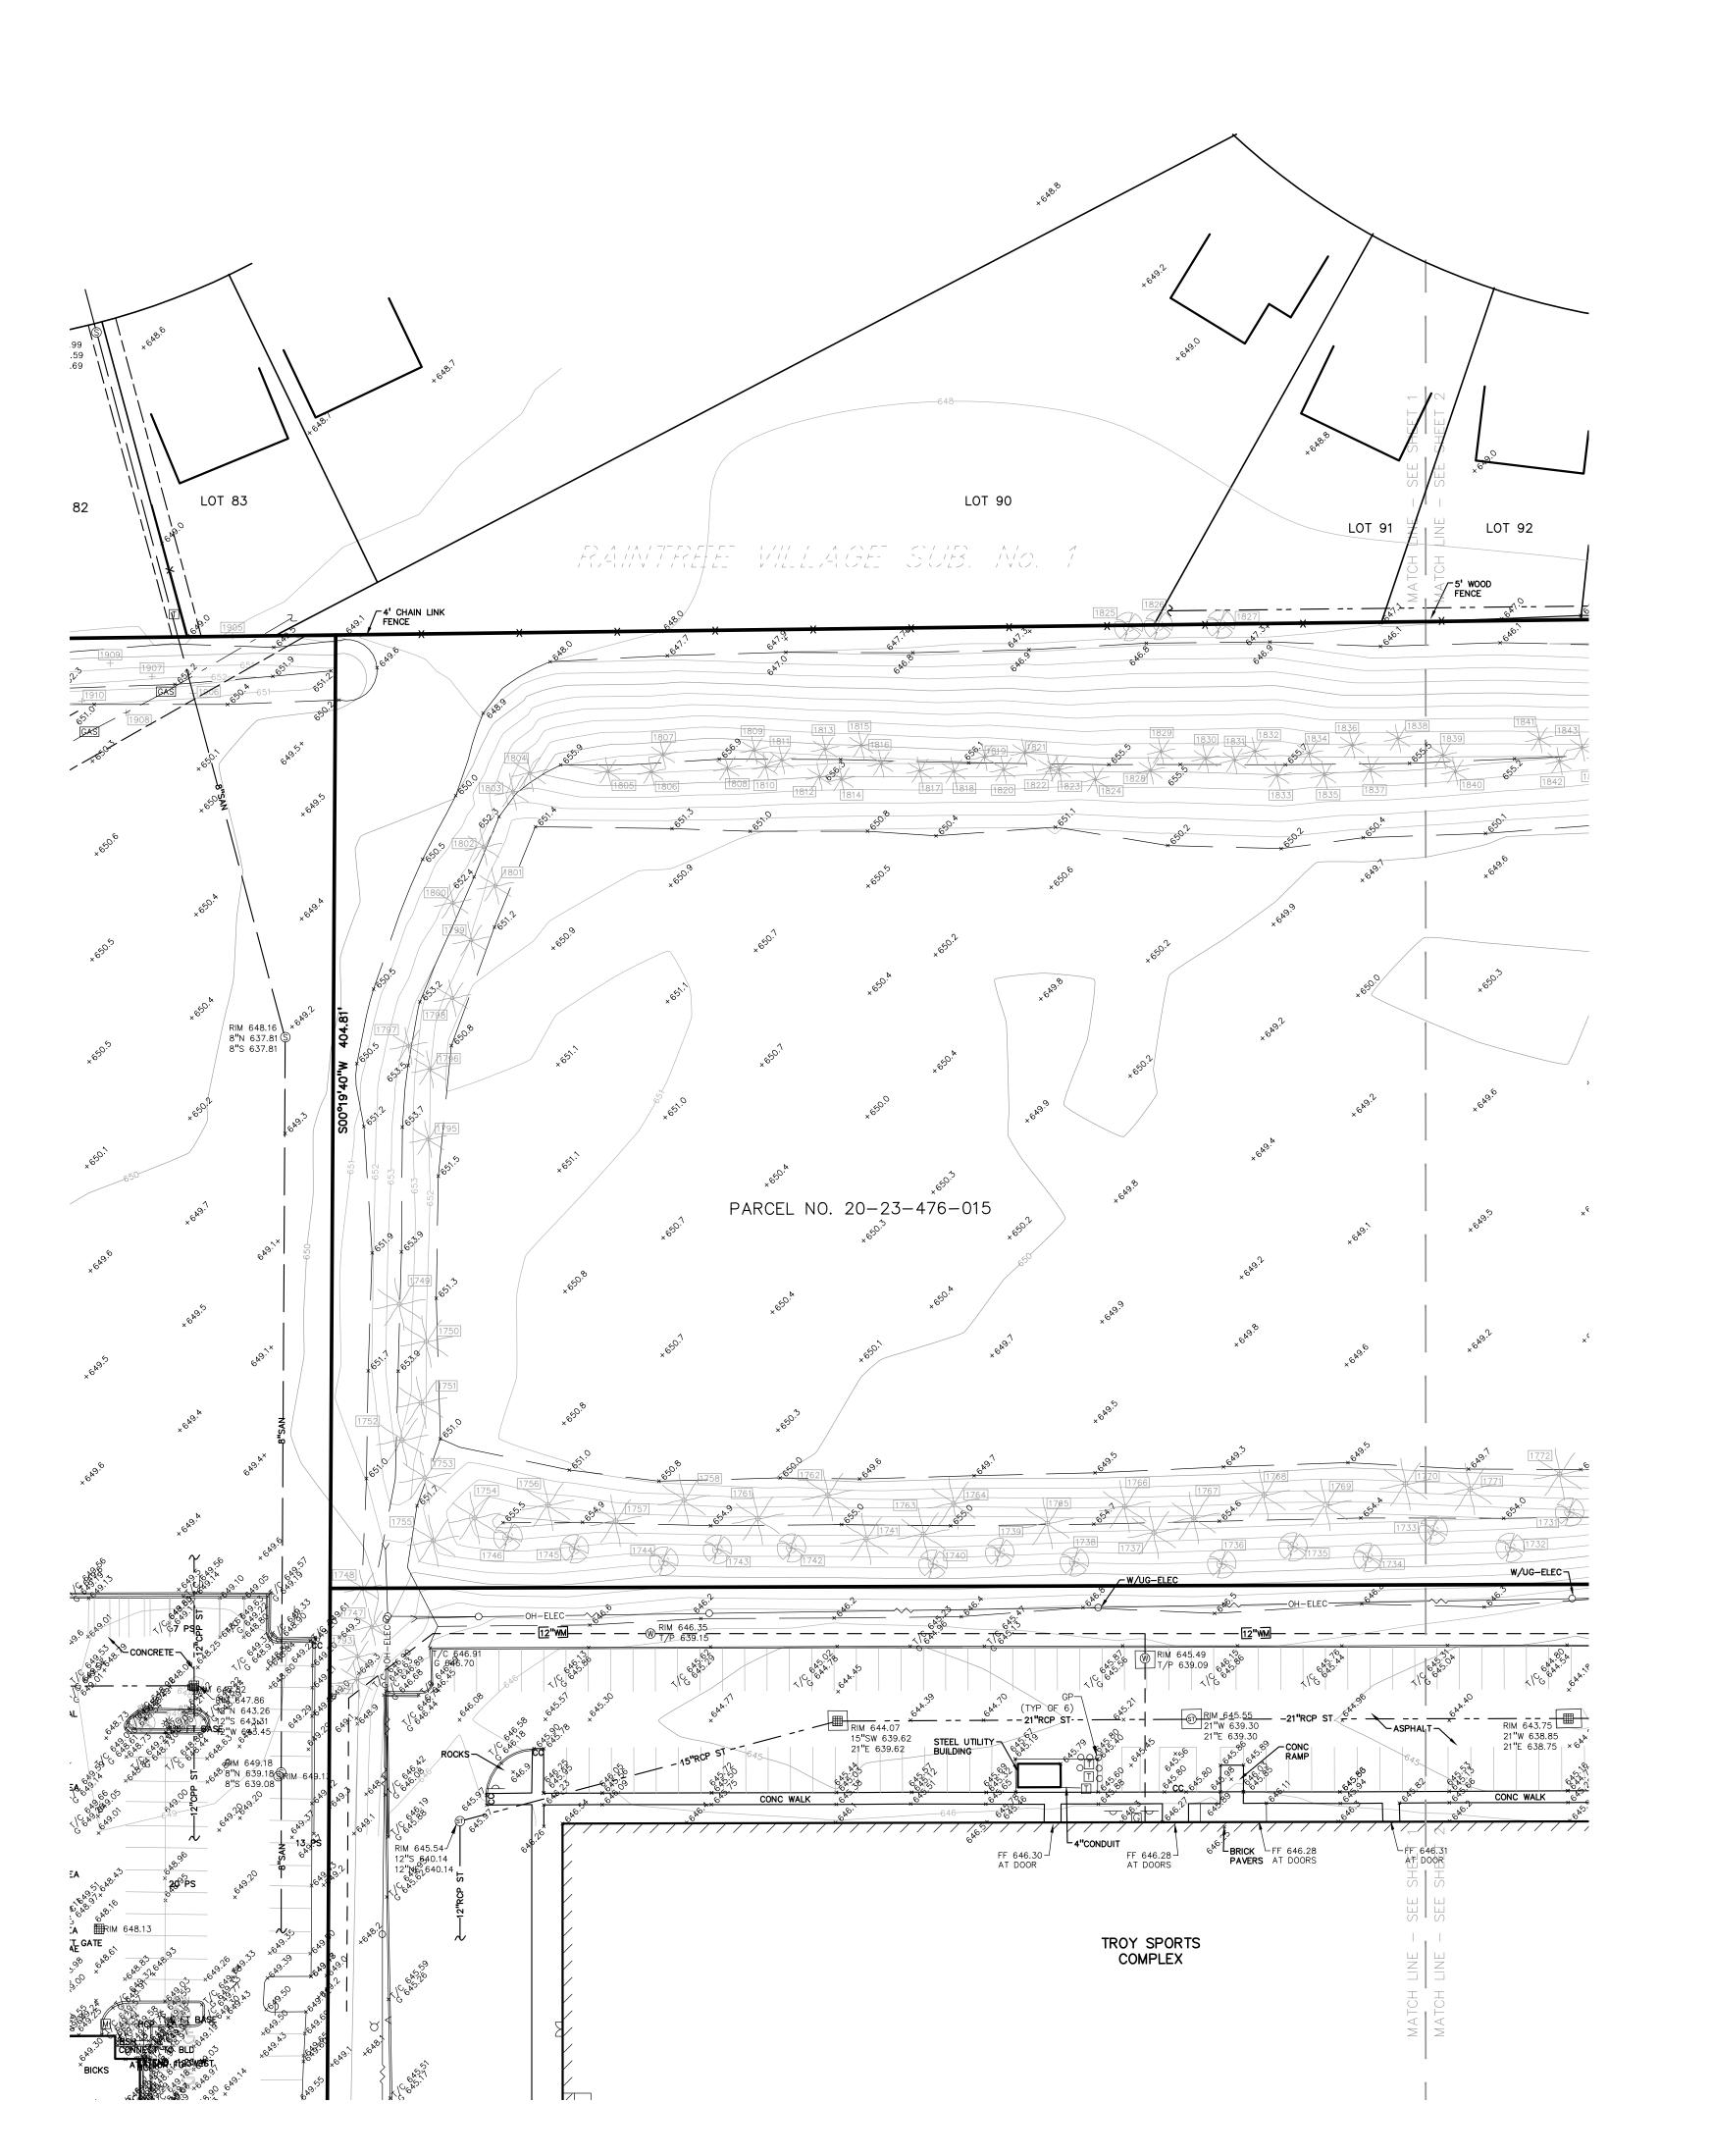











CAUTION!!

THE LOCATIONS AND ELEVATIONS OF EXISTING UNDERGROUND UTILITIES AS SHOWN ON THIS DRAWING ARE ONLY APPROXIMATE. NO GUARANTEE IS EITHER EXPRESSED OR IMPLIED AS TO THE COMPLETENESS OR ACCURACY THEREOF. THE CONTRACTOR SHALL BE EXCLUSIVELY RESPONSIBLE FOR DETERMINING THE EXACT UTILITY LOCATIONS AND ELEVATIONS PRIOR TO THE START OF CONSTRUCTION.

CLIENT

TROY SPORTS CENTER, LLC 1819 EAST BIG BEAVER ROAD

LEGAL DESCRIPTION (20-23-476-015)
(Per City of Troy Assessing)

T2N, R11E, SEC 23 LASIER GARDENS SUB LOTS 1, 2 & 3 EXC E 7 FT TAKEN FOR JOHN R RD, ALSO N 96 FT OF LOT 4 EXC E 7 FT TAKEN FOR JOHN R RD, ALSO N 96 FT OF LOT 7, ALSO LOTS 8 TO 34 INCL EXC S 49 FT OF LOTS 15, 16, 25 & 26 TAKEN FOR BIG BEAVER RD, ALSO EXC PART OF LOTS 2, 9, 12 & VAC MANHATTAN AVE DESC AS BEG AT PT DIST N 00-15-00 E 102 FT & S 89-48-40 W 60 FT & N 00-15-00 E 766.33 FT FROM SE SEC COR, TH N 00-15-00 E 40 FT, TH S 89-48-00 W 300 FT, TH S 00-15-00 W 40 FT, TH N 89-48-40 E 300 FT TO BEG, ALSO LOTS 37 TO 40 INCL, ALSO ALL OF VAC MANHATTAN, ALGER, BRONX, BELLINGHAM & WALFORD AVES ADJ TO SAME EXC E 27 FT OF VAC MANHATTAN AVE ADJ TO LOT 6, ALSO EXC E 27 FT OF VAC MANHATTAN AVE ADJ TO LOT 7 EXC N 96 FT, ALSO EXC W 1/2 OF VAC BRONX AVE ADJ TO LOT 35, ALSO EXC E 7 FT OF VAC WALFORD AVE, ALSO PART OF LOT 4, PART OF LOT 7 & PART OF VAC MANHATTAN AVE DESC AS BEG AT PT DIST N 00-15-00 E 102 FT & S 89-48-00 W 329.14 FT FROM SE SEC COR, TH S 89-48-40 W 2.86 FT, TH N 00-15-00 E 330 FT, TH N 89-48-40 E 272 FT, TH S 00-15-00 W 4.30 FT, TH N 89-45-00 W 211.18 FT, TH S 52-13-38 W 73.56 FT, TH S 00-15-00 W 282.45 FT TO BEG

PROJECT TITLE

COMMONS **TOWNHOME** DEVELOPMENT PART OF THE SE 1/4 OF SECTION 23, T 2N., R. 11E. TROY, OAKLAND COUNTY, MI

BENCHMARKS (GPS DERIVED - NAVD88)

BM #300
ARROW ON HYDRANT WEST SIDE JOHN R ROAD 11' OF B/CURB, AND 95' SOUTH OF NORTH PROPERTY LINE OF SITE.
ELEV. — 648.05

BM #301
MAG NAIL ON NORTH SIDE OF CONCRETE LIGHT POLE BASE 21' SOUTH
OF CENTERLINE NANCY BOSTICK DRIVE, AND 29' EAST OF ENTRANCE TO
KROGER PARKING LOT FROM SAID DRIVE.
ELEV. — 648.13

BM #302
ARROW ON HYDRANT FLANGE 6' NORTH OF B/CURB FOR PARKING
ALONG NANCY BOSTICK DRIVE, AND ±80' WEST OF EAST BUILDING LINE
OF TROY SPORTS COMPLEX.
ELEV. — 647.09

FLOODPLAIN NOTE:

BY GRAPHICAL PLOTTING, SITE IS WITHIN ZONE 'X', AREA DETERMINED TO BE OUTSIDE OF THE 0.2% ANNUAL CHANCE FLOODPLAIN PER FLOOD INSURANCE RATE MAP NUMBER 26125C0553G, DATED JANUARY 16, 2009.


REVISIONS SPA COMMENTS 11/8/23 SPA COMMENTS 3/1/24

ORIGINAL ISSUE DATE: AUGUST 18, 2023

DRAWING TITLE **TOPOGRAPHIC**

SURVEY

PEA JOB NO.	18-0034
P.M.	GME
DN.	CNF
DES.	GME
DRAWING NUMBER:	

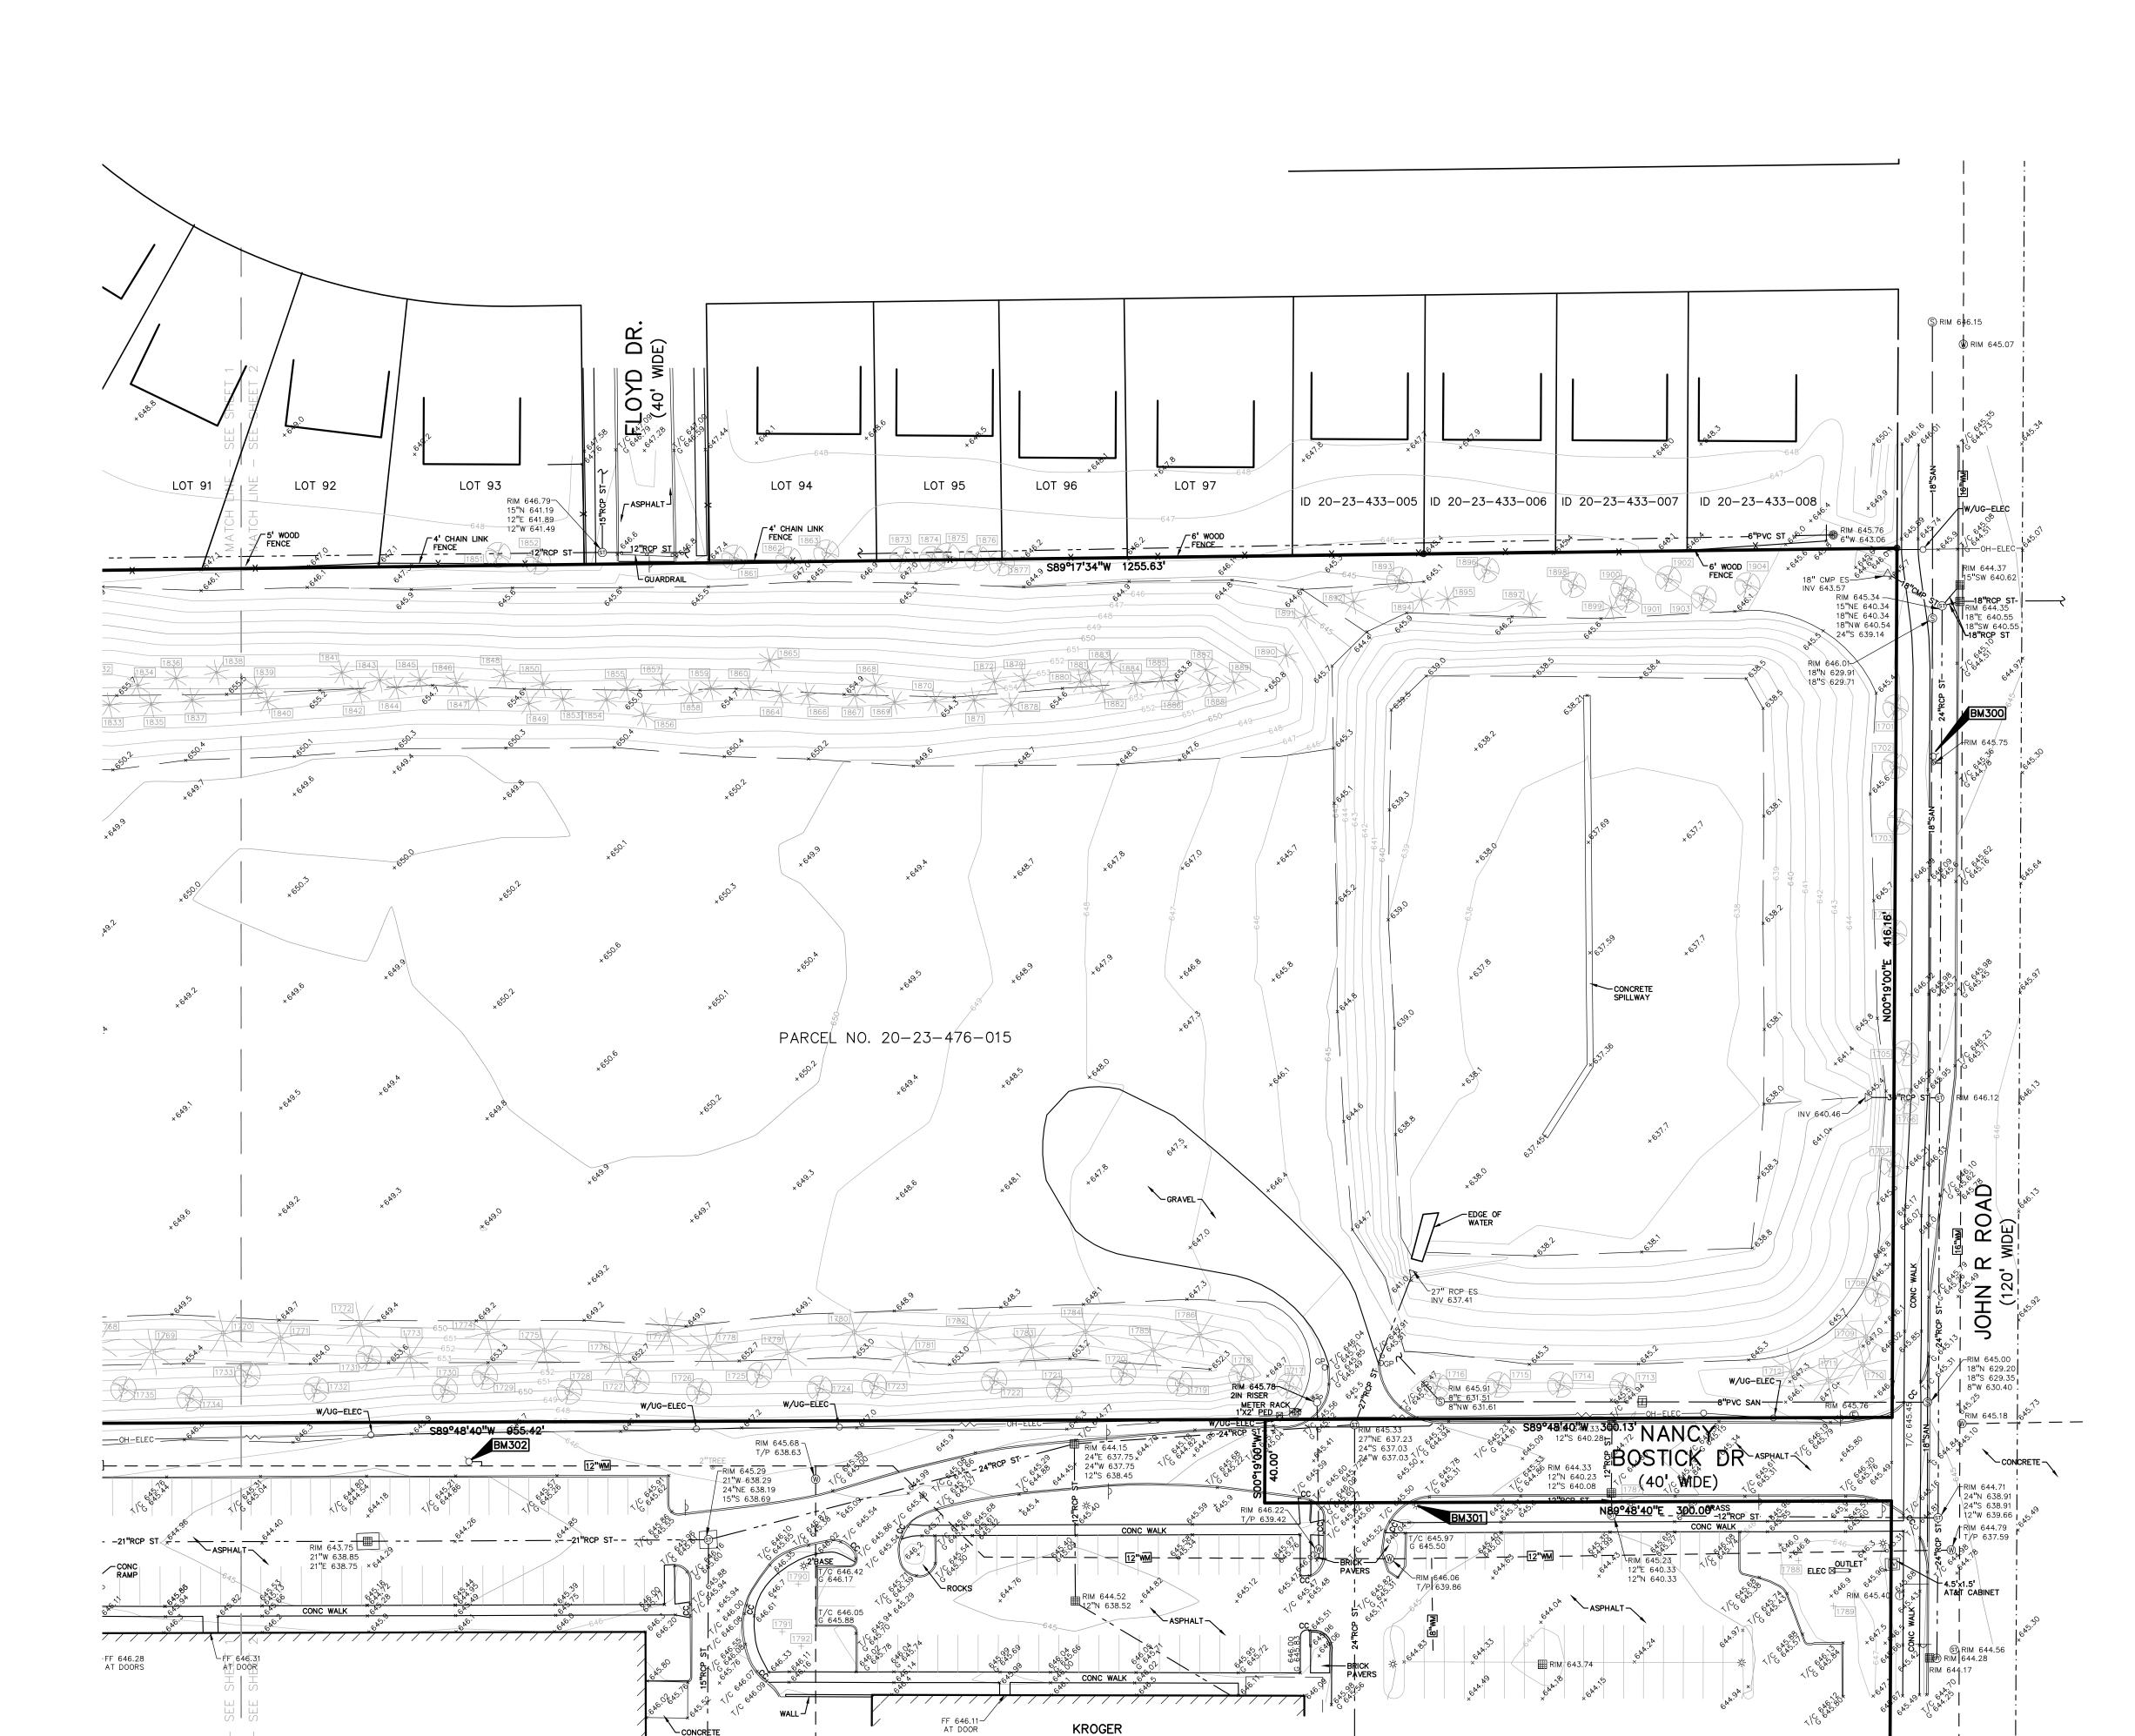

RIM 645.23











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PROJECT TITLE

COMMONS **DEVELOPMENT** PART OF THE SE 1/4 OF SECTION 23, T 2N., R. 11E.
TROY, OAKLAND COUNTY, MI

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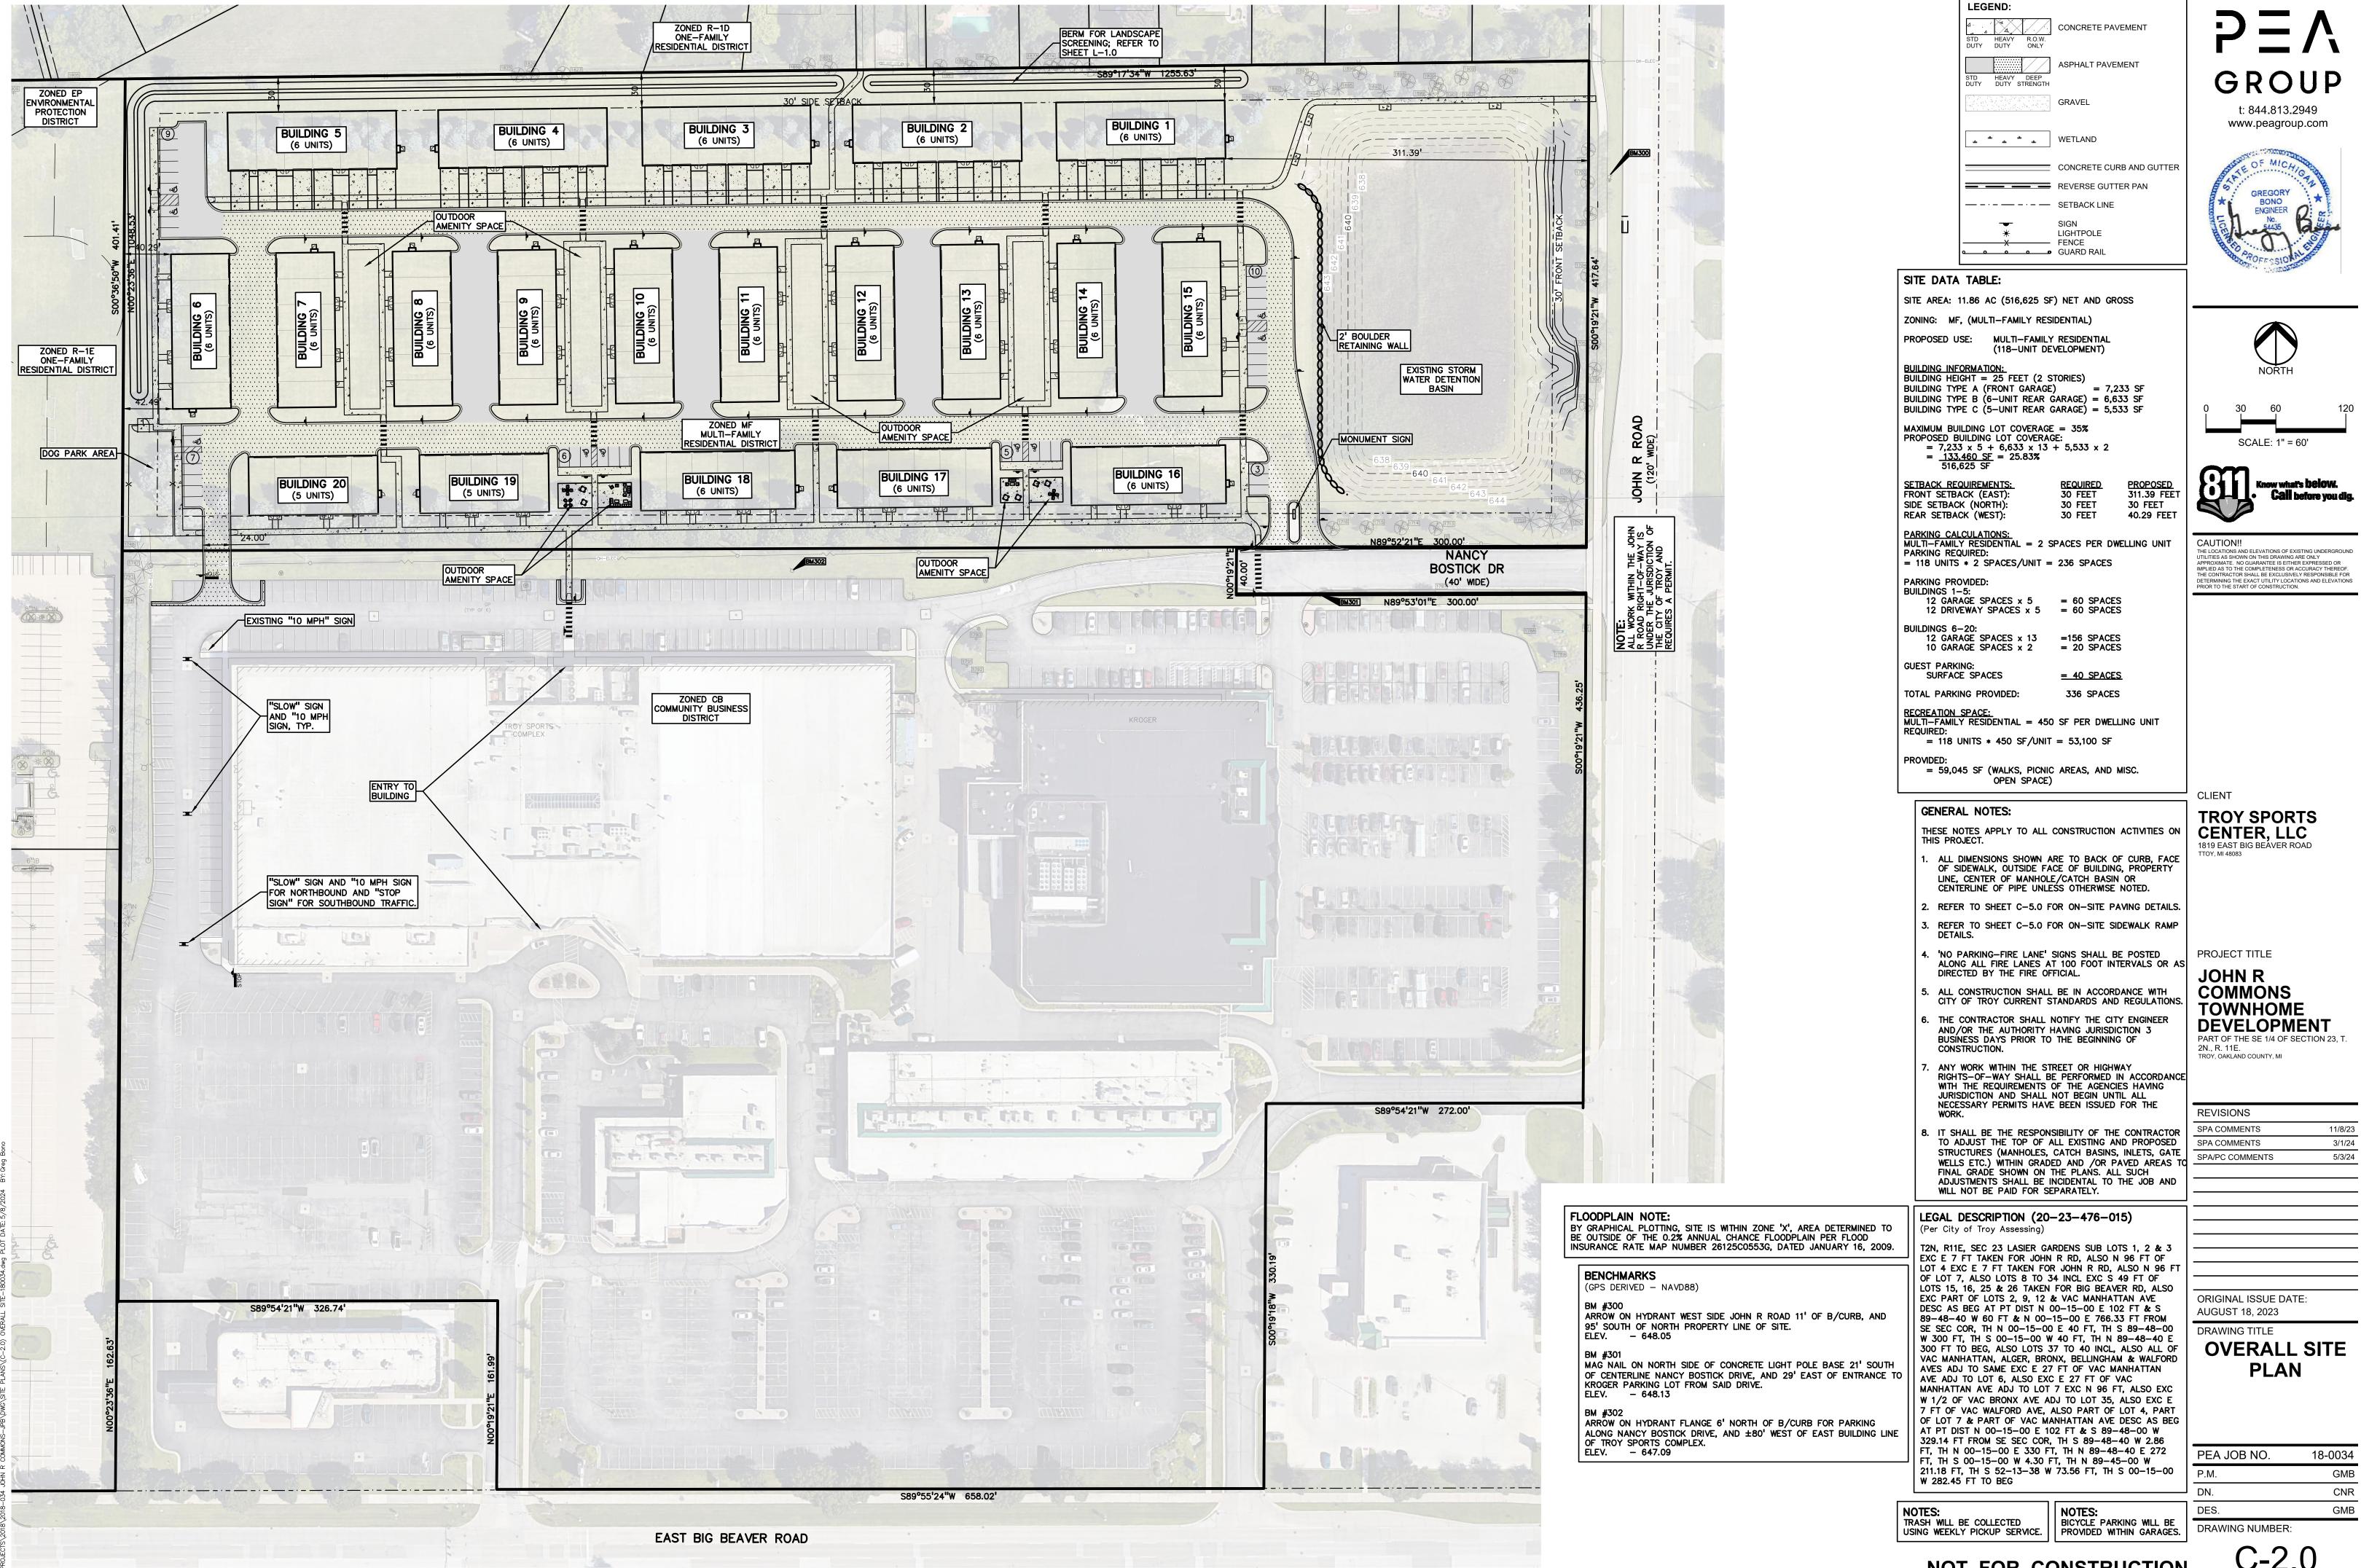
REVISIONS SPA COMMENTS 11/8/23 SPA COMMENTS 3/1/24

ORIGINAL ISSUE DATE: AUGUST 18, 2023

DRAWING TITLE **TOPOGRAPHIC SURVEY**

PEA JOB NO.	18-0034
P.M.	GMB
DN.	CNR
DES.	GMB

DRAWING NUMBER:



NOT FOR CONSTRUCTION

ARROW ON HYDRANT WEST SIDE JOHN R ROAD 11' OF B/CURB, AND 95' SOUTH OF NORTH PROPERTY LINE OF SITE.

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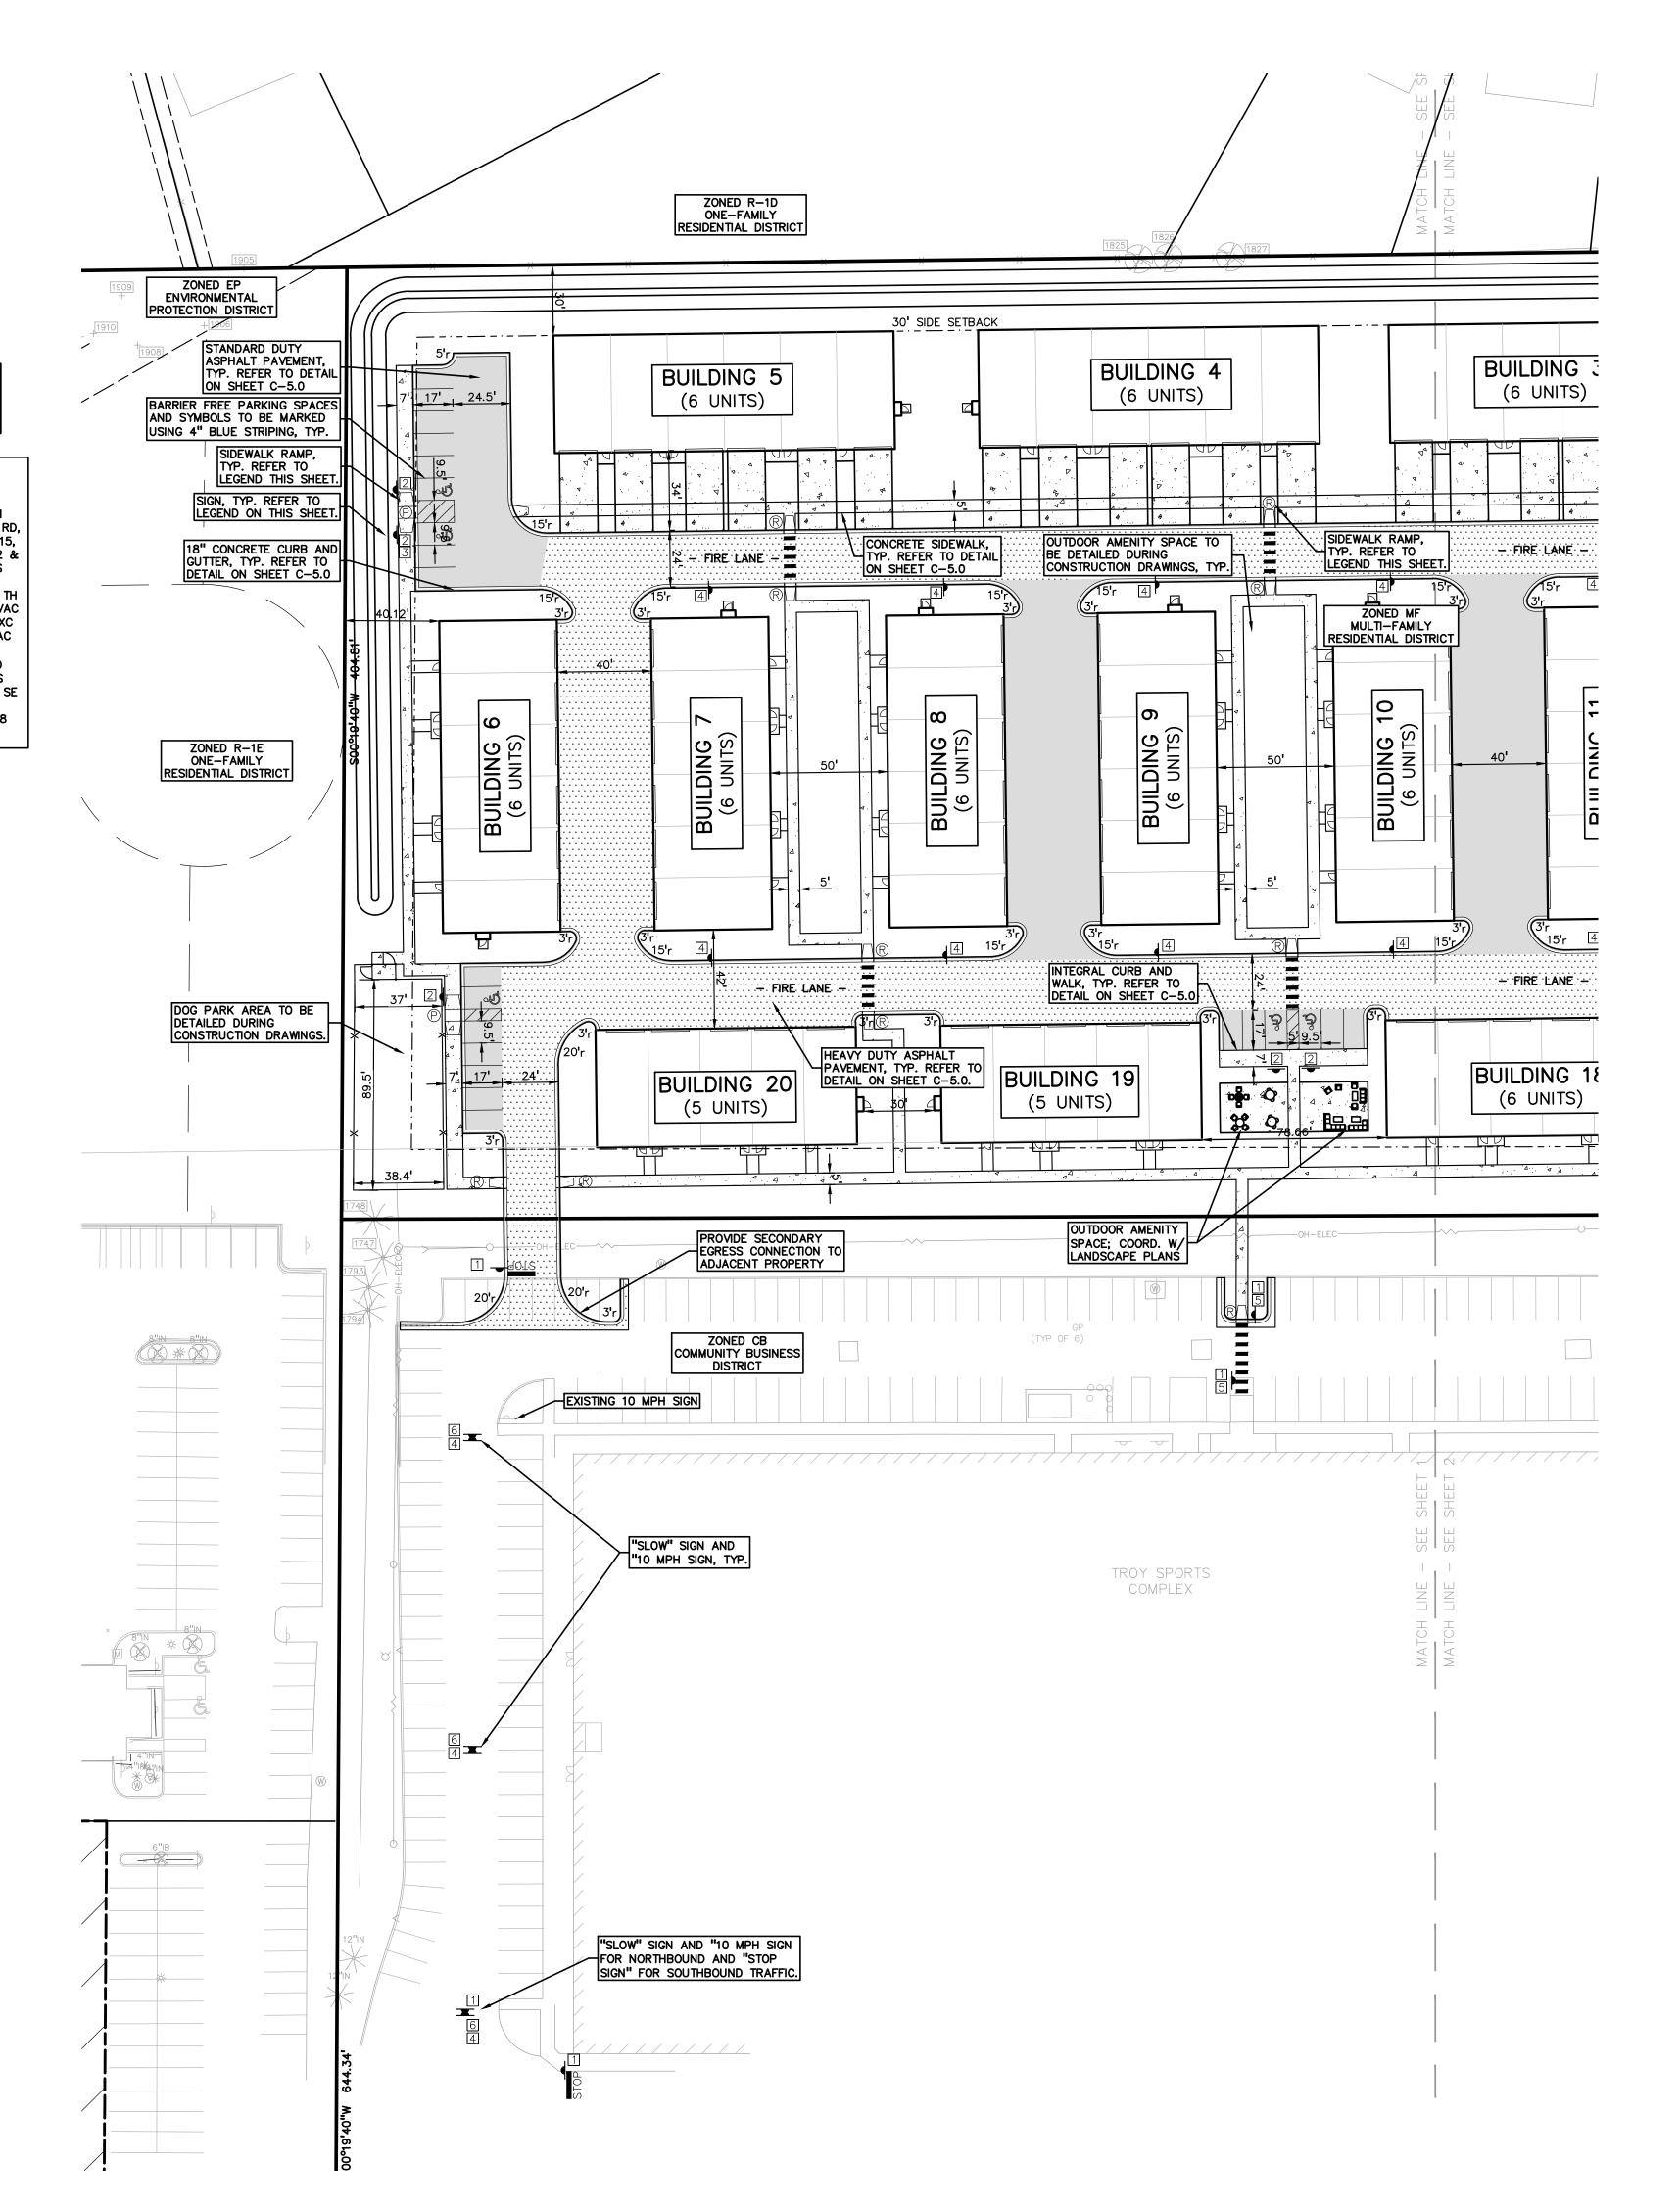
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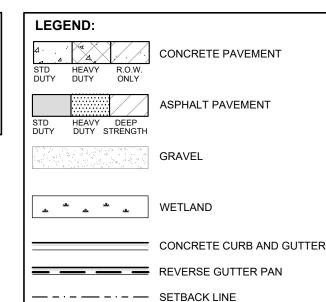
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SIDEWALK RAMP LEGEND: SIDEWALK RAMP 'TYPE R' SIDEWALK RAMP 'TYPE P' REFER TO LATEST M.D.O.T. R-28 STANDARD RAMP

AND DETECTABLE WARNING DETAILS	
SIGN LEGEND:	
'STOP' SIGN	1
'BARRIER FREE PARKING' SIGN	2
'VAN ACCESSIBLE' SIGN	3
'NO PARKING FIRE LANE' SIGN	4
'CROSSWALK' SIGN	5
'SLOW' SIGN	6
'10 MPH' SIGN	7
REFER TO SHEET C-5.0 FOR SIGN	DETAILS



LIGHTPOLE







ALL DIMENSIONS SHOWN ARE TO BACK OF CURB, FACE OF SIDEWALK, OUTSIDE FACE OF BUILDING, PROPERTY LINE, CENTER OF MANHOLE/CATCH BASIN OR CENTERLINE OF PIPE UNLESS OTHERWISE NOTED.

X FENCE

GUARD RAIL

- 2. REFER TO SHEET C-5.0 FOR ON-SITE PAVING DETAILS. REFER TO SHEET C-5.0 FOR ON-SITE SIDEWALK RAMP
- . 'NO PARKING-FIRE LANE' SIGNS SHALL BE POSTED ALONG ALL FIRE LANES AT 100 FOOT INTERVALS OR AS DIRECTED BY THE FIRE OFFICIAL.
- ALL CONSTRUCTION SHALL BE IN ACCORDANCE WITH CITY OF TROY CURRENT STANDARDS AND REGULATIONS.
- THE CONTRACTOR SHALL NOTIFY THE CITY ENGINEER AND/OR THE AUTHORITY HAVING JURISDICTION 3 BUSINESS DAYS
- PRIOR TO THE BEGINNING OF CONSTRUCTION. ANY WORK WITHIN THE STREET OR HIGHWAY RIGHTS-OF-WAY SHALL BE PERFORMED IN ACCORDANCE WITH THE REQUIREMENTS OF THE AGENCIES HAVING JURISDICTION AND SHALL NOT BEGIN UNTIL ALL NECESSARY PERMITS HAVE BEEN
- 3. IT SHALL BE THE RESPONSIBILITY OF THE CONTRACTOR TO ADJUST THE TOP OF ALL EXISTING AND PROPOSED STRUCTURES (MANHOLES, CATCH BASINS, INLETS, GATE WELLS ETC.) WITHIN GRADED AND /OR PAVED AREAS TO FINAL GRADE SHOWN ON THE PLANS. ALL SUCH ADJUSTMENTS SHALL BE INCIDENTAL TO THE JOB AND WILL NOT BE PAID FOR SEPARATELY.


BICYCLE PARKING WILL BE PROVIDED WITHIN GARAGES

ISSUED FOR THE WORK.


GENERAL NOTES:

TRASH WILL BE COLLECTED USING WEEKLY PICKUP SERVICE.



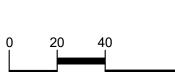



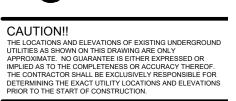

CLIENT TROY SPORTS CENTER, LLC 1819 EAST BIG BEAVER ROAD

PROJECT TITLE

JOHN R COMMONS **TOWNHOME** DEVELOPMENT PART OF THE SE 1/4 OF SECTION 23, 1 2N., R. 11E. TROY, OAKLAND COUNTY, MI

REVISIONS	
SPA COMMENTS	11/8/23
SPA COMMENTS	3/1/24
SPA/PC COMMENTS	5/3/24

ORIGINAL ISSUE DATE: AUGUST 18, 2023

DRAWING TITLE **PRELIMINARY** SITE PLAN

PEA JOB NO.	18-0034
P.M.	GME
DN.	CNF
DES.	GME
DRAWING NUMBER:	

ARROW ON HYDRANT WEST SIDE JOHN R ROAD 11' OF B/CURB, AND 95' SOUTH OF NORTH PROPERTY LINE OF SITE.

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BY GRAPHICAL PLOTTING, SITE IS WITHIN ZONE 'X', AREA DETERMINED TO BE OUTSIDE OF THE 0.2% ANNUAL CHANCE FLOODPLAIN PER FLOOD INSURANCE RATE MAP NUMBER 26125C0553G, DATED JANUARY 16, 2009. LEGAL DESCRIPTION (20-23-476-015) (Per City of Troy Assessing)

T2N, R11E, SEC 23 LASIER GARDENS SUB LOTS 1, 2 & 3 EXC E 7 FT TAKEN MANHATTAN AVE ADJ TO LOT 7 EXC N 96 FT, ALSO EXC W 1/2 OF VAC

FOR JOHN R RD, ALSO N 96 FT OF LOT 4 EXC E 7 FT TAKEN FOR JOHN R RD, ALSO N 96 FT OF LOT 7, ALSO LOTS 8 TO 34 INCL EXC S 49 FT OF LOTS 15, 16, 25 & 26 TAKEN FOR BIG BEAVER RD, ALSO EXC PART OF LOTS 2, 9, 12 & VAC MANHATTAN AVE DESC AS BEG AT PT DIST N 00-15-00 E 102 FT & S 89-48-40 W 60 FT & N 00-15-00 E 766.33 FT FROM SE SEC COR, TH N 00-15-00 E 40 FT, TH S 89-48-00 W 300 FT, TH S 00-15-00 W 40 FT, TH N 89-48-40 E 300 FT TO BEG, ALSO LOTS 37 TO 40 INCL, ALSO ALL OF VAC MANHATTAN, ALGER, BRONX, BELLINGHAM & WALFORD AVES ADJ TO SAME EXC E 27 FT OF VAC MANHATTAN AVE ADJ TO LOT 6, ALSO EXC E 27 FT OF VAC BRONX AVE ADJ TO LOT 35, ALSO EXC E 7 FT OF VAC WALFORD AVE, ALSO PART OF LOT 4, PART OF LOT 7 & PART OF VAC MANHATTAN AVE DESC AS BEG AT PT DIST N 00-15-00 E 102 FT & S 89-48-00 W 329.14 FT FROM SE SEC COR, TH S 89-48-40 W 2.86 FT, TH N 00-15-00 E 330 FT, TH N 89-48-40 E 272 FT, TH S 00-15-00 W 4.30 FT, TH N 89-45-00 W 211.18 FT, TH S 52-13-38 W 73.56 FT, TH S 00-15-00 W 282.45 FT TO BEG

DR.

SIDEWALK RAMP LEGEND: SIDEWALK RAMP 'TYPE R' SIDEWALK RAMP 'TYPE P' REFER TO LATEST M.D.O.T. R-28 STANDARD RAMP AND DETECTABLE WARNING DETAILS SIGN LEGEND: 'STOP' SIGN 'BARRIER FREE PARKING' SIGN 'VAN ACCESSIBLE' SIGN 'NO PARKING FIRE LANE' SIGN

'CROSSWALK' SIGN

REFER TO SHEET C-5.0 FOR SIGN DETAILS

'SLOW' SIGN

'10 MPH' SIGN

LEGEND: CONCRETE PAVEMENT STD HEAVY R.O.W. DUTY DUTY ONLY ASPHALT PAVEMENT CONCRETE CURB AND GUTTER REVERSE GUTTER PAN — - · - — SETBACK LINE LIGHTPOLE X FENCE GUARD RAIL



GROUP


t: 844.813.2949

www.peagroup.com

NOTES: BICYCLE PARKING WILL BE PROVIDED WITHIN GARAGES.

TRASH WILL BE COLLECTED USING WEEKLY PICKUP SERVICE.



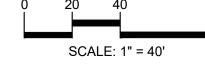



CAUTION!! THE LOCATIONS AND ELEVATIONS OF EXISTING UNDERGROUND UTILITIES AS SHOWN ON THIS DRAWING ARE ONLY APPROXIMATE. NO GUARANTEE IS EITHER EXPRESSED OR IMPLIED AS TO THE COMPLETENESS OR ACCURACY THEREOF. THE CONTRACTOR SHALL BE EXCLUSIVELY RESPONSIBLE FOR DETERMINING THE EXACT UTILITY LOCATIONS AND ELEVATIONS PRIOR TO THE START OF CONSTRUCTION.

CLIENT

TROY SPORTS CENTER, LLC 1819 EAST BIG BEAVER ROAD

PROJECT TITLE

REVISIONS

SPA COMMENTS

JOHN R COMMONS
TOWNHOME
DEVELOPMENT
PART OF THE SE 1/4 OF SECTION 23, T. 2N., R. 11E. TROY, OAKLAND COUNTY, MI


SPA COMMENTS	3/1/24
SPA/PC COMMENTS	5/3/24

ORIGINAL ISSUE DATE: AUGUST 18, 2023 DRAWING TITLE

> **PRELIMINARY SITE PLAN**

PEA JOB NO.	18-0034
P.M.	GME
DN.	CNR
DES.	GME
DRAWING NUMBER:	

NOT FOR CONSTRUCTION

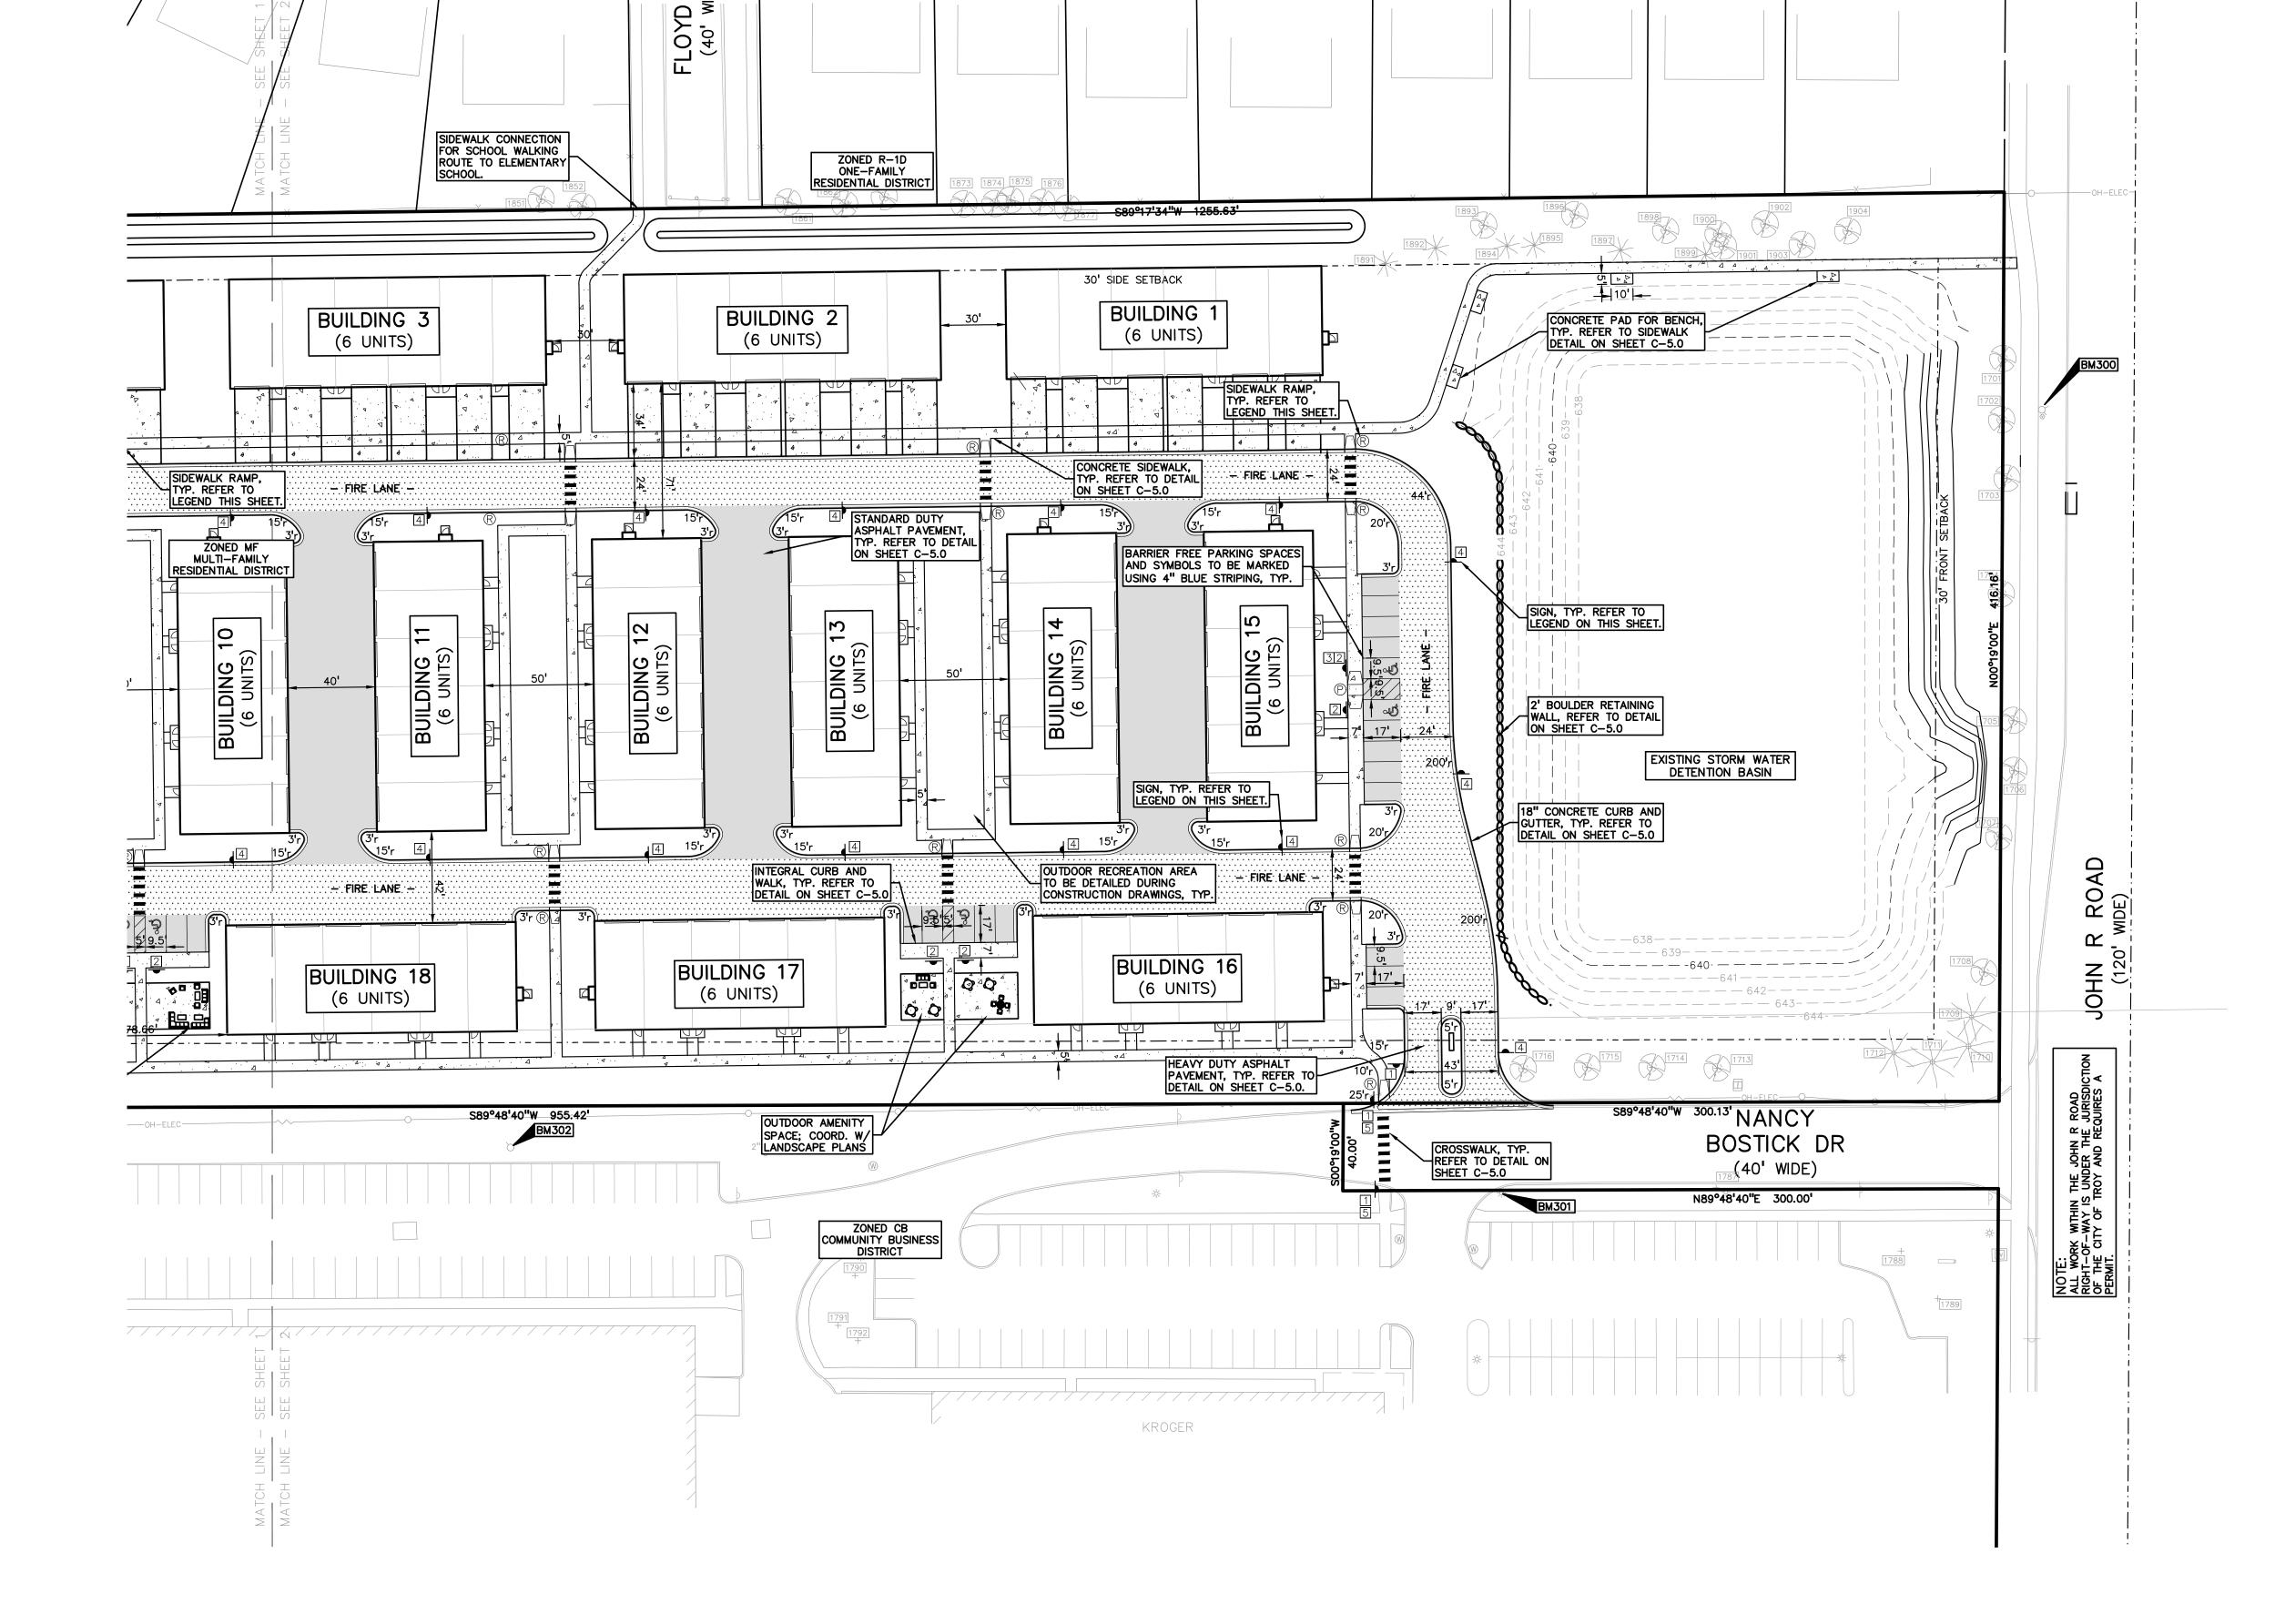


ARROW ON HYDRANT WEST SIDE JOHN R ROAD 11' OF B/CURB, AND 95' SOUTH OF NORTH PROPERTY LINE OF SITE.

MAG NAIL ON NORTH SIDE OF CONCRETE LIGHT POLE BASE 21' SOUTH OF CENTERLINE NANCY BOSTICK DRIVE, AND 29' EAST OF ENTRANCE TO KROGER PARKING LOT FROM SAID DRIVE. ELEV. - 648.13

ARROW ON HYDRANT FLANGE 6' NORTH OF B/CURB FOR PARKING ALONG NANCY BOSTICK DRIVE, AND ±80' WEST OF EAST BUILDING LINE OF TROY SPORTS COMPLEX. ELEV. - 647.09

FLOODPLAIN NOTE:

BY GRAPHICAL PLOTTING, SITE IS WITHIN ZONE 'X', AREA DETERMINED TO BE OUTSIDE OF THE 0.2% ANNUAL CHANCE FLOODPLAIN PER FLOOD INSURANCE RATE MAP NUMBER 26125C0553G, DATED JANUARY 16, 2009.

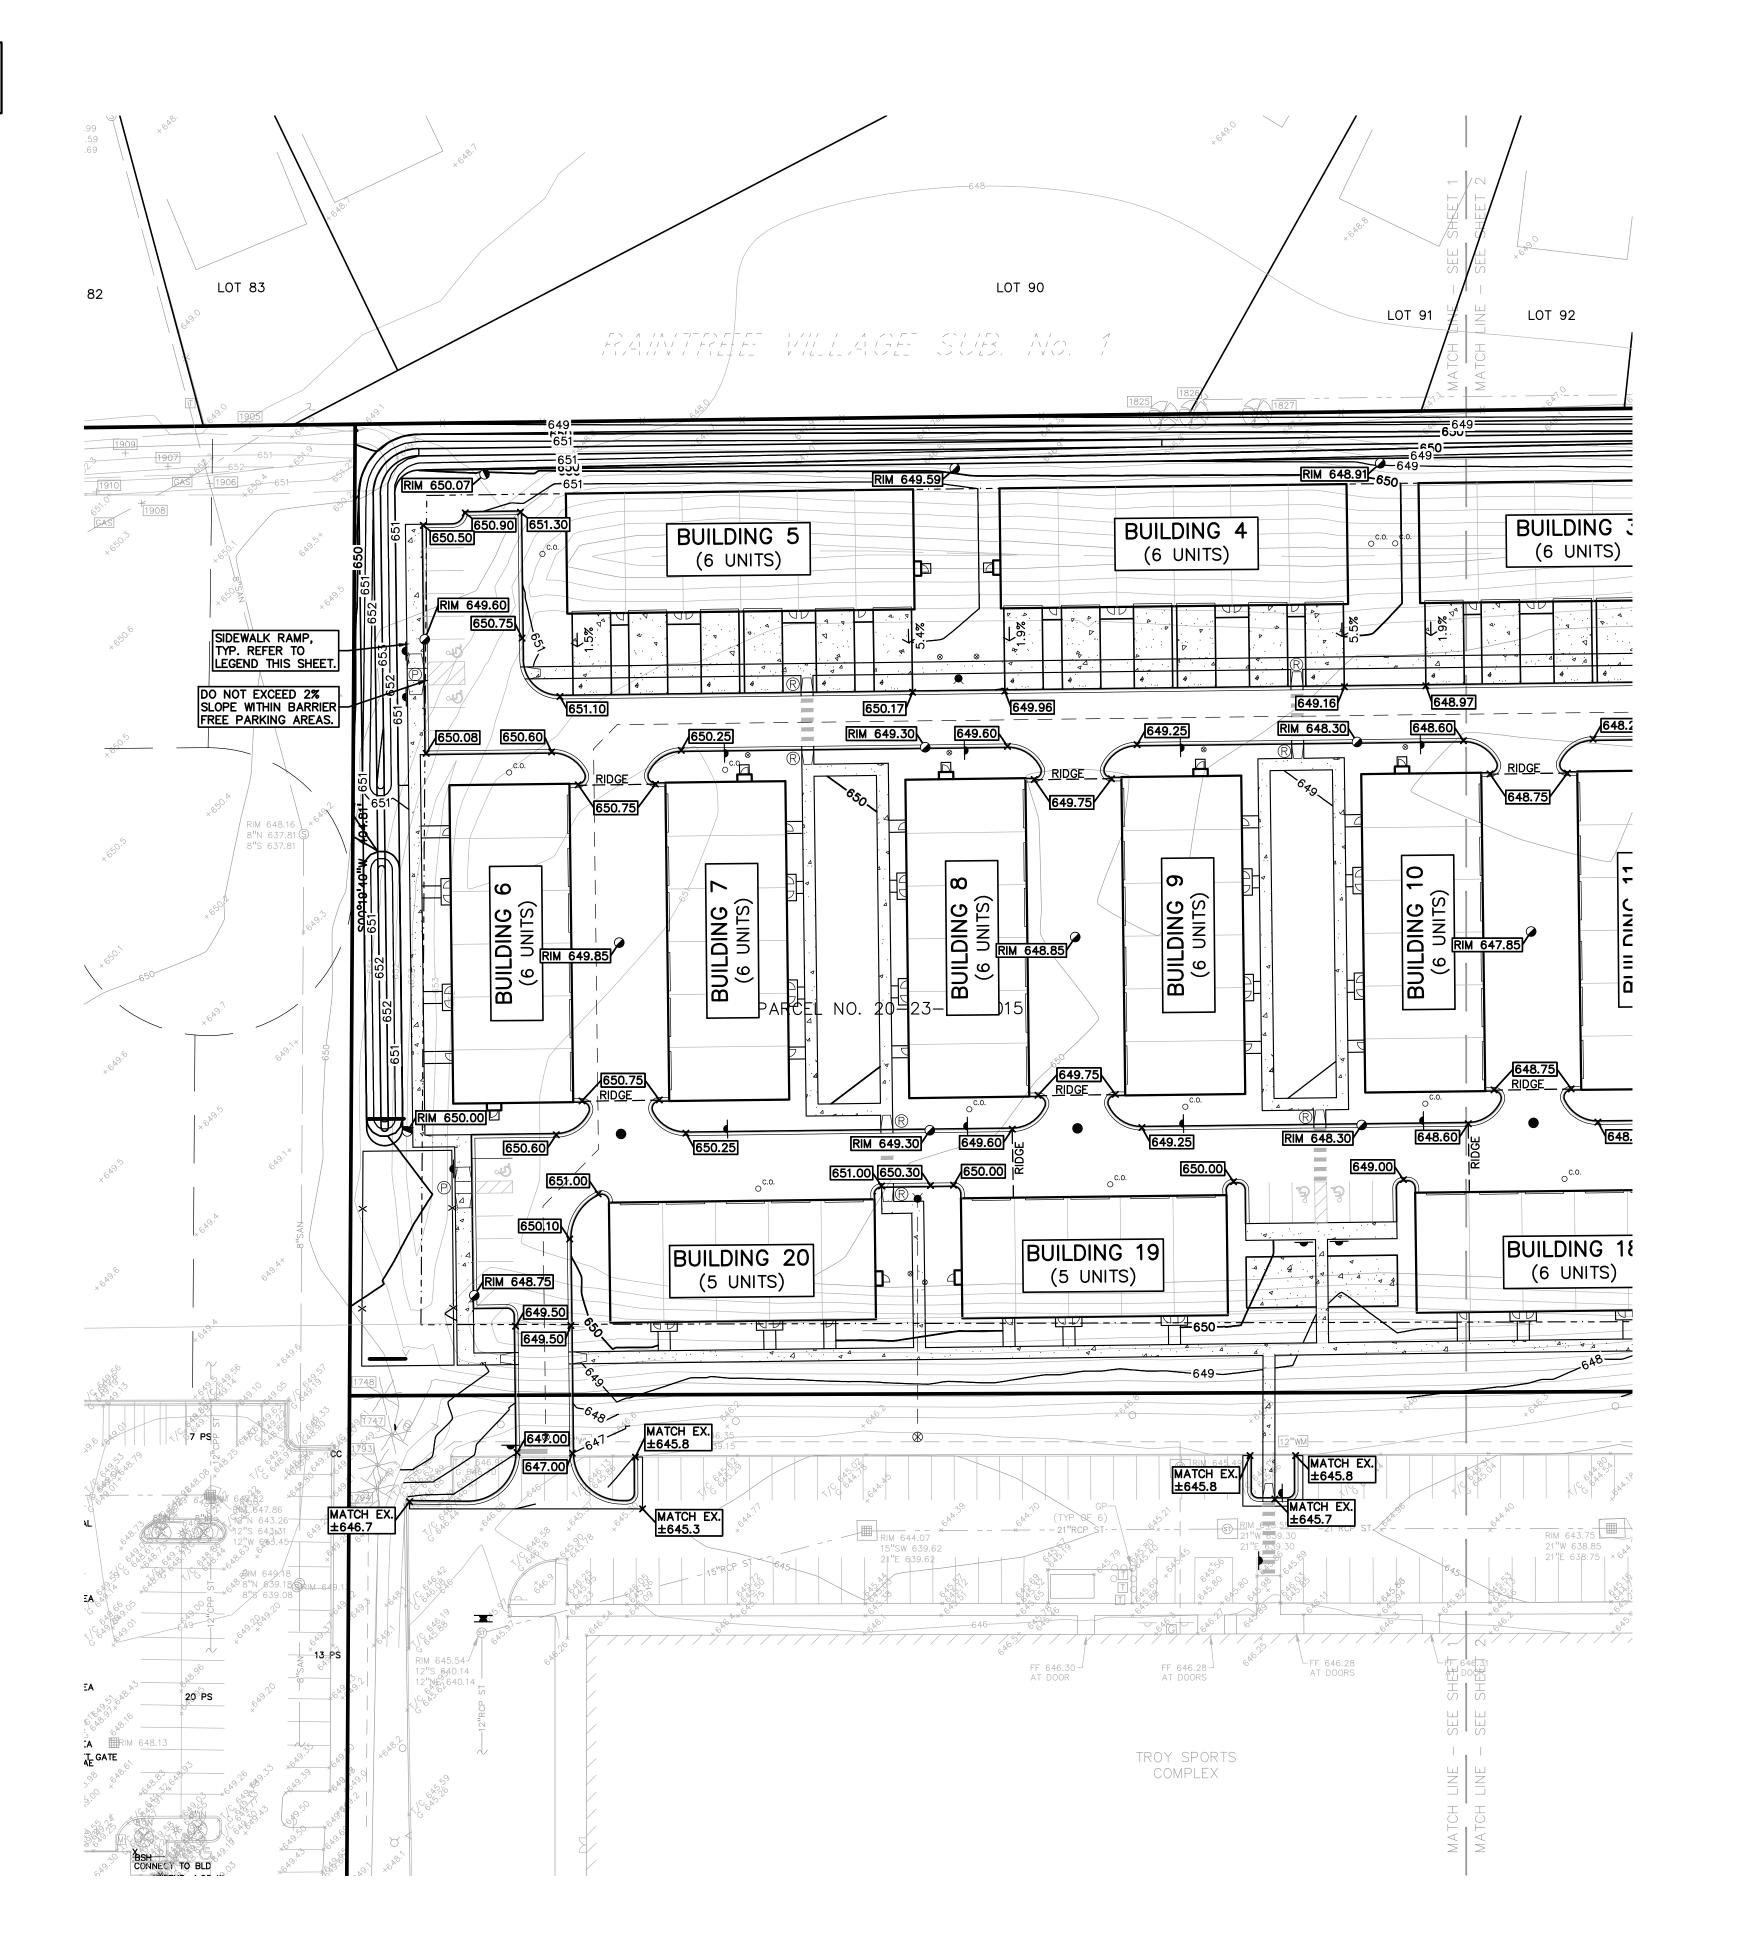

SIDEWALK RAMP LEGEND:

SIDEWALK RAMP 'TYPE R'

SIDEWALK RAMP 'TYPE P'

REFER TO LATEST M.D.O.T. R-28 STANDARD RAMP AND DETECTABLE WARNING DETAILS

SYMBOLS: GRADING

PROPOSED CONTOUR LINE

PROPOSED SPOT GRADE ELEVATION. ALL GRADES INDICATED ARE TOP OF PAVEMENT UNLESS OTHERWISE NOTED.

694.50 ----695---

EARTHWORK BALANCING NOTE:

THE CONTRACTOR SHALL BE RESPONSIBLE FOR IMPORTING OR EXPORTING ALL MATERIALS AS REQUIRED TO PROPERLY GRADE THIS PROJECT TO THE FINISHED ELEVATIONS SHOWN ON THE APPROVED PLANS. THE CONTRACTOR SHALL MAKE THEIR OWN DETERMINATION OF CUT AND FILL QUANTITIES AND ALLOW FOR REMOVAL OF EXCESS OR IMPORTATION OF ADDITIONAL MATERIAL AT NO ADDITIONAL COST TO THE OWNER.


GENERAL GRADING AND EARTHWORK NOTES:


- THESE NOTES APPLY TO ALL CONSTRUCTION ACTIVITIES ON THIS PROJECT
- CONTRACTOR TO FIELD VERIFY ALL EXISTING TREES AND BRUSH AND REMOVE ALL THAT ARE NECESSARY TO GRADE SITE.
- 2. ALL GRADES ARE TO TOP OF PAVEMENT UNLESS OTHERWISE NOTED.
- THE STAGING OF CONSTRUCTION ACTIVITIES SHALL OCCUR ONLY WITHIN THE SITE BOUNDARIES. ANY CONSTRUCTION ACTIVITIES OUTSIDE OF THE SITE BOUNDARIES SHALL BE AT THE SOLE RESPONSIBILITY AND RISK OF THE CONTRACTOR.
- REQUIREMENTS OF THE CITY OF TROY. AN EROSION CONTROL PERMIT MUST BE SECURED FROM THE CITY PRIOR TO CONSTRUCTION.
- ALL EARTHWORK AND GRADING OPERATIONS SHALL BE PERFORMED IN ACCORDANCE WITH THE SOILS INVESTIGATION AND REPORT.
- THE DETENTION BASIN SIDE SLOPES AND ALL SLOPE EXCEEDING 1:6 MUST BE STABILIZED BY SODDING OR BY PLACING A MULCH BLANKET PEGGED IN PLACE OVER SEED.
- . ALL DISTURBED AREAS SHALL BE SEEDED AND MULCHED OR SODDED IN ACCORDANCE WITH THE LANDSCAPE PLANS. PROVIDE A MINIMUM OF 3" OF TOPSOIL IN THESE AREAS UNLESS OTHERWISE NOTED.
- . THE CONTRACTOR SHALL NOTE EXISTING UNDERGROUND UTILITIES WITHIN AND ADJACENT TO THE SITE. BACKFILL FOR EXISTING UTILITY TRENCHES SHALL BE EXAMINED CRITICALLY. ANY TRENCHES FOUND TO HAVE SOFT, UNSTABLE OR UNSUITABLE BACKFILL MATERIAL, IN THE OPINION OF THE GEOTECHNICAL ENGINEER, THAT ARE TO BE WITHIN THE ZONE OF INFLUENCE OF PROPOSED BUILDINGS OR PAVEMENT SHALL BE COMPLETELY EXCAVATED AND BACKFILLED WITH SUITABLE MATERIAL.


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CLIENT

TROY SPORTS CENTER, LLC 1819 EAST BIG BEAVER ROAD TTOY, MI 48083

PROJECT TITLE

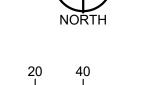
JOHN R
COMMONS
TOWNHOME
DEVELOPMENT
PART OF THE SE 1/4 OF SECTION 23, T.
2N., R. 11E.
TROY, OAKLAND COUNTY, MI

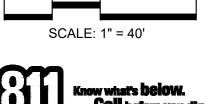REVISIONS	
SPA COMMENTS	11/8/2
SPA COMMENTS	3/1/2

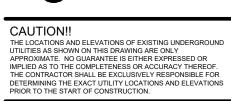ORIGINAL ISSUE DATE: AUGUST 18, 2023 DRAWING TITLE

PRELIMINARY GRADING PLAN

PEA JOB NO.	18-0034
P.M.	GME
DN.	CNF
DES.	GME
DRAWING NUMBER:	

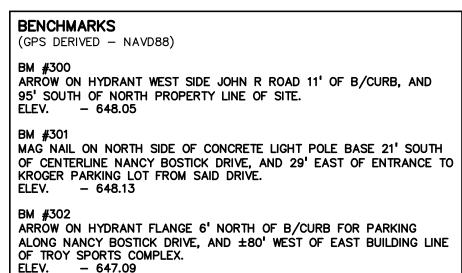

FLOODPLAIN NOTE: BY GRAPHICAL PLOTTING, SITE IS WITHIN ZONE 'X', AREA DETERMINED TO BE OUTSIDE OF THE 0.2% ANNUAL CHANCE FLOODPLAIN PER FLOOD INSURANCE RATE MAP NUMBER 26125C0553G, DATED JANUARY 16, 2009. S RIM 646.15 ₩ RIM 645.07 LOYD (40' W LOT 91 LOT 92 LOT 95 LOT 96 LOT 97 ID 20-23-433-005 | ID 20-23-433-006 | ID 20-23-433-007 | ID 20-23-433-008 MATCH EX. ±645.7 ±645.6 RIM 647.18 RIM 647.78 BUILDING 1 BUILDING 2 BUILDING 3 (6 UNITS) (6 UNITS) (6 UNITS) TYP. REFER TO LEGEND THIS SHEET. T/W 645.00 B/W 645.00 647.17 RIM 645.69 646.25 RIM 647.30 T/W 645.00 B/W 643.00 <u>RIDGE</u> 646.75 2 T/W 645.00 B/W 643.00 STIND RIM 646.85 EXISTING DETENTION BASIN 645.45 DO NOT EXCEED 2% SLOPE WITHIN BARRIER FREE PARKING AREAS. 647.30 648.00 648.30 RIM 646.30 647.60 647.25 647.00 T/W 645.00 649.00 B/W 643.00 646.25 BUILDING 16 (6 UNITS) **BUILDING 17 BUILDING 18** T/W 645.00_ 647 646.25 646.05 645.P (6 UNITS) B/W 645.00 (6 UNITS) MATCH EX. 9°48'40'W33300.13' NANCY 12'S 640.28 NANCY 12'S 640.28 NANCY 12'S 640.28 NANCY 15' NAN S89°48'40"W 955.42' BOSTICK DR MATCH EX. ±645.2 (40' WDE) MATCH EX. ±645.8 N89°48'40"E 300.00" TCH EX. 45.7 -FF 646.28 AT DOORS KROGER

SIDEWALK RAMP LEGEND:

SIDEWALK RAMP 'TYPE R'

SIDEWALK RAMP 'TYPE P'

REFER TO LATEST M.D.O.T. R-28 STANDARD RAMP AND DETECTABLE WARNING DETAILS

SYMBOLS: GRADING

PROPOSED SPOT GRADE ELEVATION. ALL GRADES INDICATED ARE TOP OF PAVEMENT UNLESS OTHERWISE NOTED.

----695*-*--

EARTHWORK BALANCING NOTE:

PROPOSED CONTOUR LINE

THE CONTRACTOR SHALL BE RESPONSIBLE FOR IMPORTING OR EXPORTING ALL MATERIALS AS REQUIRED TO PROPERLY GRADE THIS PROJECT TO THE FINISHED ELEVATIONS SHOWN ON THE APPROVED PLANS. THE CONTRACTOR SHALL MAKE THEIR OWN DETERMINATION OF CUT AND FILL QUANTITIES AND ALLOW FOR REMOVAL OF EXCESS OR IMPORTATION OF ADDITIONAL MATERIAL AT NO ADDITIONAL COST TO THE OWNER.

GENERAL GRADING AND EARTHWORK NOTES:

THESE NOTES APPLY TO ALL CONSTRUCTION ACTIVITIES ON THIS PROJECT


- CONTRACTOR TO FIELD VERIFY ALL EXISTING TREES AND BRUSH AND REMOVE ALL THAT ARE NECESSARY TO GRADE SITE.
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- ALL SOIL EROSION AND SEDIMENTATION CONTROL MEASURES SHALL MEET THE REQUIREMENTS OF THE CITY OF TROY. AN EROSION CONTROL PERMIT MUST BE SECURED FROM THE CITY PRIOR TO CONSTRUCTION.
- ALL EARTHWORK AND GRADING OPERATIONS SHALL BE PERFORMED IN ACCORDANCE WITH THE SOILS INVESTIGATION AND REPORT.
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CLIENT

TROY SPORTS CENTER, LLC 1819 EAST BIG BEAVER ROAD

PROJECT TITLE

JOHN R
COMMONS
TOWNHOME
DEVELOPMENT
PART OF THE SE 1/4 OF SECTION 23, T.
2N., R. 11E.
TROY, OAKLAND COUNTY, MI

REVISION	ONS	
SPA COM	IMENTS	11/8/23
SPA COM	IMENTS	3/1/24

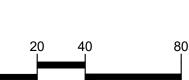ORIGINAL ISSUE DATE: AUGUST 18, 2023

DRAWING TITLE **PRELIMINARY GRADING PLAN**

PEA JOB NO.	18-0034
P.M.	GME
DN.	CNF
DES.	GME
DRAWING NUMBER:	


ARROW ON HYDRANT WEST SIDE JOHN R ROAD 11' OF B/CURB, AND 95' SOUTH OF NORTH PROPERTY LINE OF SITE.

MAG NAIL ON NORTH SIDE OF CONCRETE LIGHT POLE BASE 21' SOUTH OF CENTERLINE NANCY BOSTICK DRIVE, AND 29' EAST OF ENTRANCE TO KROGER PARKING LOT FROM SAID DRIVE. ELEV. – 648.13

ARROW ON HYDRANT FLANGE 6' NORTH OF B/CURB FOR PARKING ALONG NANCY BOSTICK DRIVE, AND ±80' WEST OF EAST BUILDING LINE OF TROY SPORTS COMPLEX. ELEV. – 647.09

FLOODPLAIN NOTE:

BY GRAPHICAL PLOTTING, SITE IS WITHIN ZONE 'X', AREA DETERMINED TO BE OUTSIDE OF THE 0.2% ANNUAL CHANCE FLOODPLAIN PER FLOOD INSURANCE RATE MAP NUMBER 26125C0553G, DATED JANUARY 16, 2009.

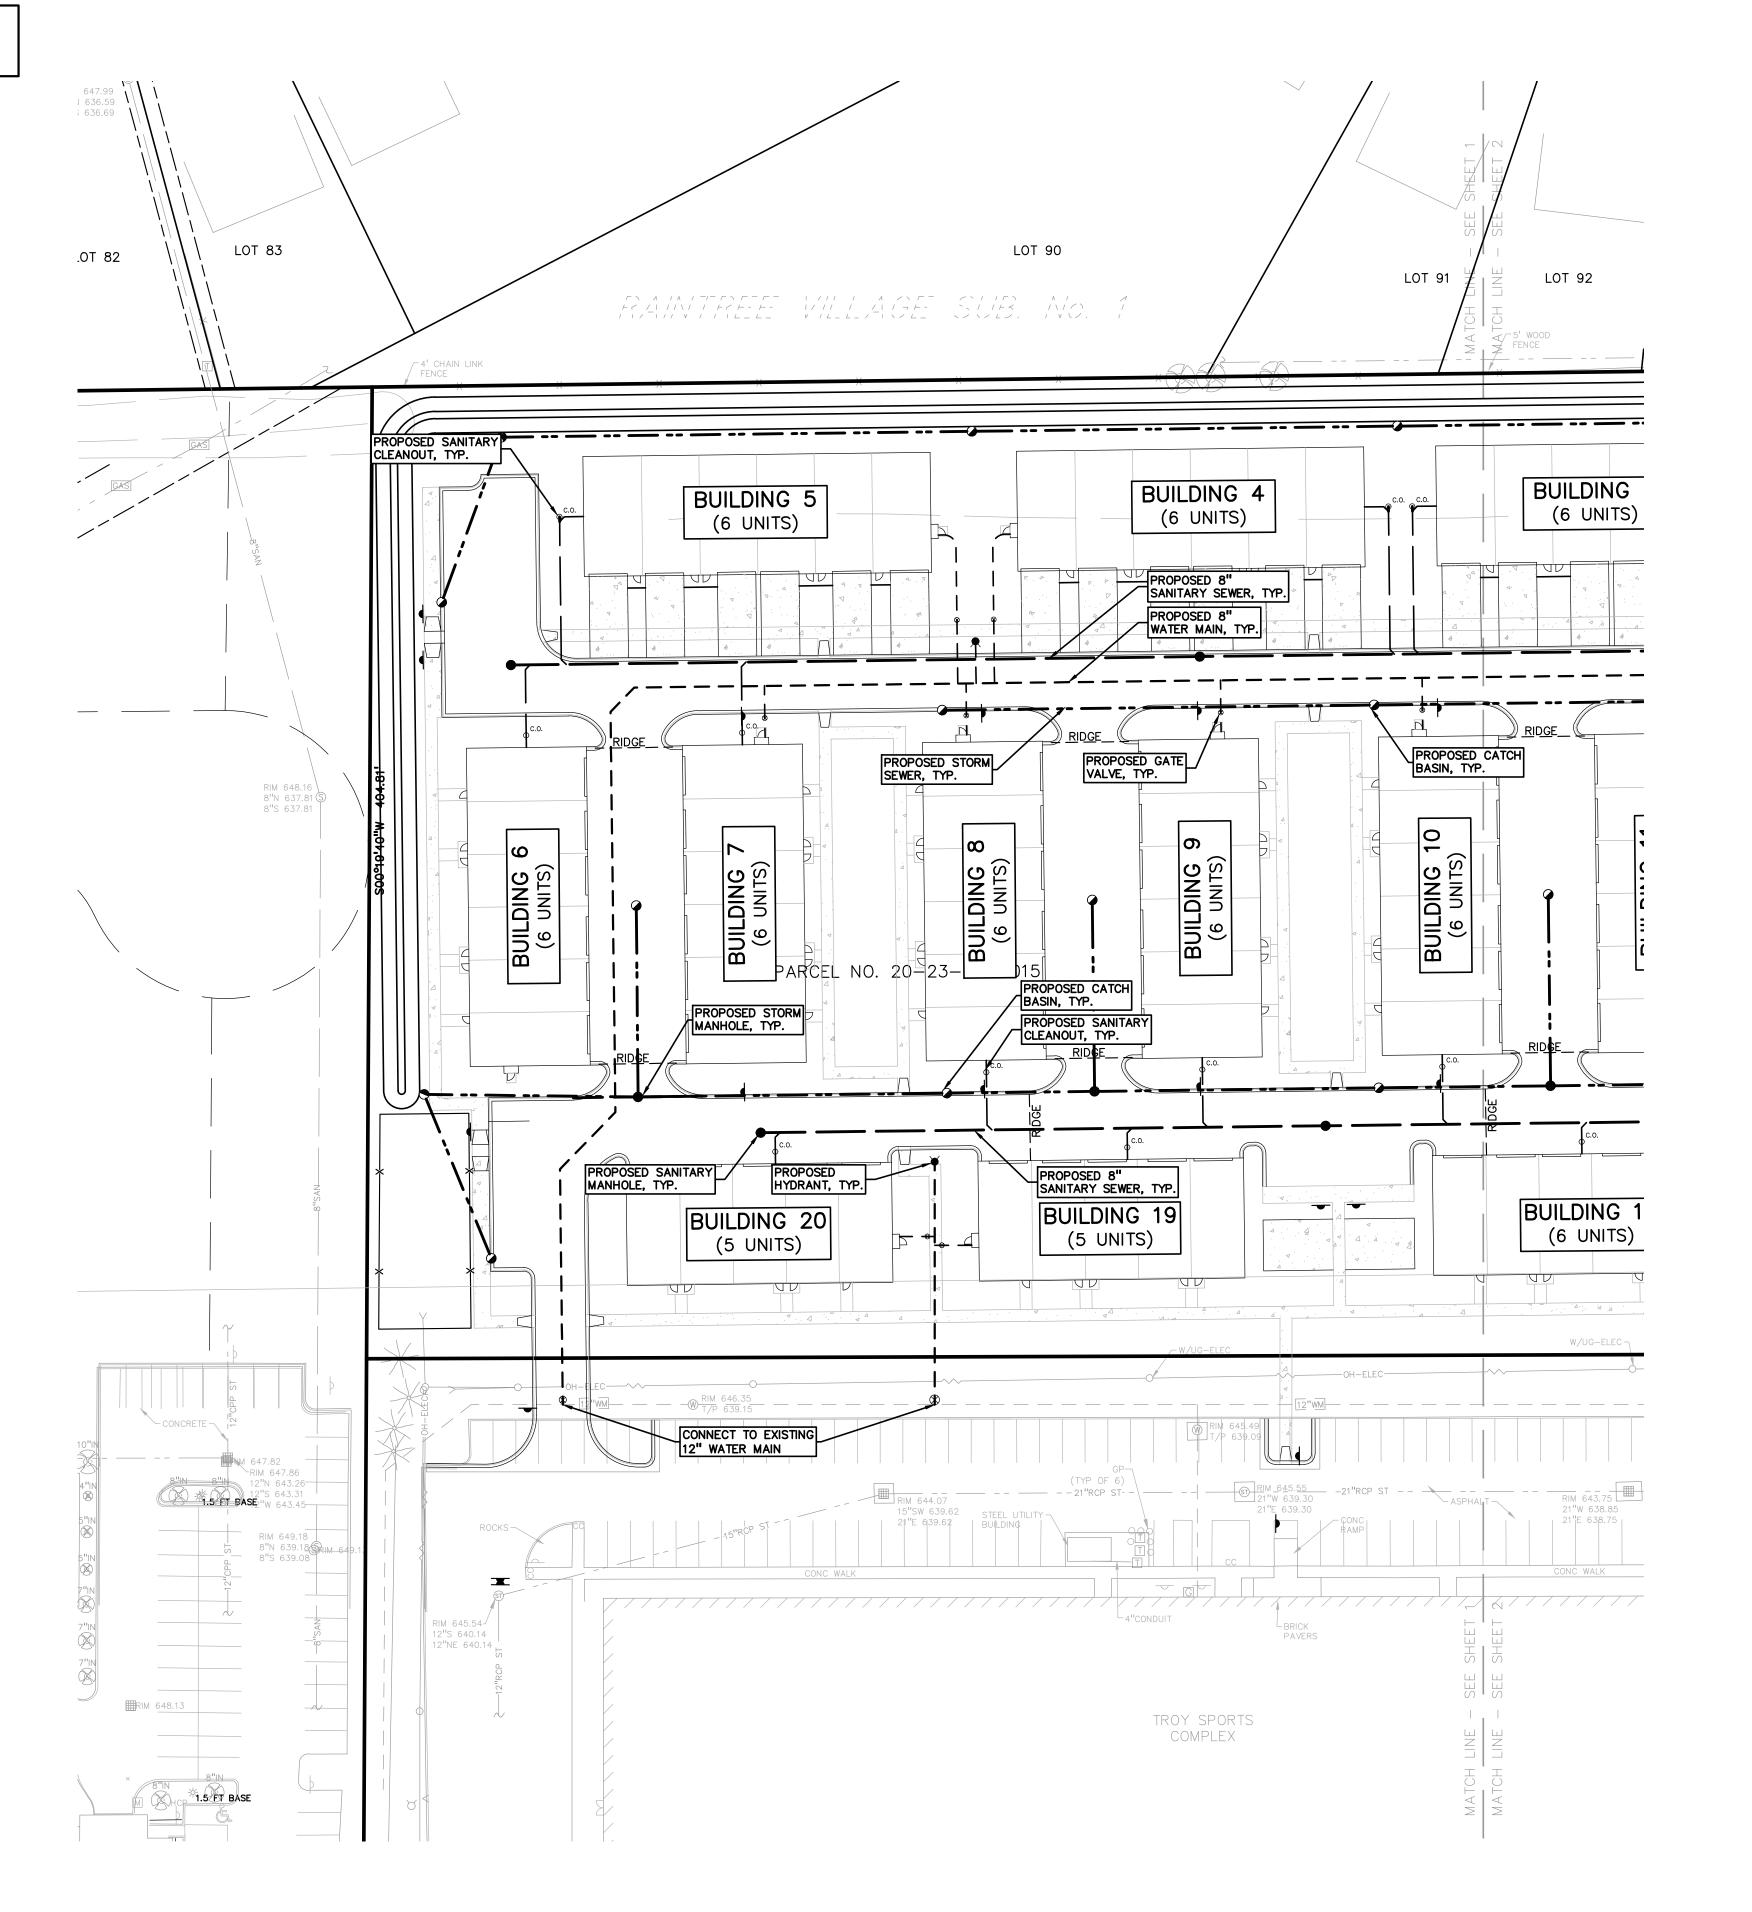

SAND BACKFILL NOTE:

ALL UTILITIES UNDER PAVEMENT OR WITHIN 3' OF THE EDGE OF PAVEMENT (OR WITHIN THE 45° LINE OF INFLUENCE OF PAVEMENT) SHALL HAVE M.D.O.T. CLASS II GRANULAR BACKFILL COMPACTED TO 95% MAX. DRY DENSITY (ASTM D-1557).

PUBLIC UTILITY EASEMENTS:

ALL SANITARY SEWERS 8" AND LARGER IN DIAMETER ARE TO BE PUBLIC AND SHALL BE LOCATED IN A 20' WIDE EASEMENT. ALL WATER MAIN SHALL BE LOCATED IN A 20' WIDE EASEMENT.

UTILITY LEGEND:

-OH-ELEC-W-O- EX. OH. ELEC, POLE & GUY WIRE -UG-CATV-V EX. U.G. CABLE TV & PEDESTAL -UG-ELEC-E-E-EX. U.G. ELEC,MANHOLE, METER & HANDHOLE — – — – EX. GAS LINE © GAS EX. GAS VALVE & GAS LINE MARKER EX. TRANSFORMER & IRRIGATION VALVE — — — EX. WATER MAIN

∀ -> W EX. HYDRANT, GATE VALVE & POST INDICATOR VALVE EX. SANITARY SEWER S EX. SANITARY CLEANOUT & MANHOLE EX. COMBINED SEWER MANHOLE — EX. STORM SEWER EX. CLEANOUT & MANHOLE EX. SQUARE, ROUND, & BEEHIVE CATCH BASIN EX. YARD DRAIN & ROOF DRAIN

EX. UNIDENTIFIED STRUCTURE PROPOSED WATER MAIN PROPOSED HYDRANT AND GATE VALVE PROPOSED TAPPING SLEEVE, VALVE & WELL PROPOSED POST INDICATOR VALVE

PROPOSED SANITARY SEWER OC.O. PROPOSED SANITARY CLEANOUT & MANHOLE PROPOSED STORM SEWER


○ C.O. ■ PROPOSED STORM SEWER CLEANOUT & MANHOLE PROPOSED CATCH BASIN, INLET & YARD DRAIN

GROUP







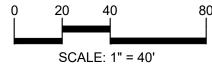



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CLIENT TROY SPORTS CENTER, LLC 1819 EAST BIG BEAVER ROAD TTOY, MI 48083

PROJECT TITLE

JOHN R
COMMONS
TOWNHOME
DEVELOPMENT
PART OF THE SE 1/4 OF SECTION 23, T.
2N., R. 11E.
TROY, OAKLAND COUNTY, MI

REVISIONS	
PA COMMENTS	11/8/23
PA COMMENTS	3/1/24
	_

ORIGINAL ISSUE DATE: AUGUST 18, 2023

DRAWING TITLE

PRELIMINARY UTILITY PLAN

PEA JOB NO.	18-003
P.M.	GM
DN.	CNI
DES.	GM
DRAWING NUMBER:	

BENCHMARKS (GPS DERIVED - NAVD88) ARROW ON HYDRANT WEST SIDE JOHN R ROAD 11' OF B/CURB, AND 95' SOUTH OF NORTH PROPERTY LINE OF SITE. ELEV. - 648.05 MAG NAIL ON NORTH SIDE OF CONCRETE LIGHT POLE BASE 21' SOUTH OF CENTERLINE NANCY BOSTICK DRIVE, AND 29' EAST OF ENTRANCE TO KROGER PARKING LOT FROM SAID DRIVE. ELEV. - 648.13 ARROW ON HYDRANT FLANGE 6' NORTH OF B/CURB FOR PARKING ALONG NANCY BOSTICK DRIVE, AND ±80' WEST OF EAST BUILDING LINE OF TROY SPORTS COMPLEX. ELEV. - 647.09 FLOODPLAIN NOTE: BY GRAPHICAL PLO BE OUTSIDE OF TH

SAND BACKFILL NOTE: ALL UTILITIES UNDER PAVEMENT OR WITHIN 3' OF THE EDGE OF PAVEMENT (OR WITHIN THE 45° LINE OF INFLUENCE OF PAVEMENT) SHALL HAVE M.D.O.T. CLASS II GRANULAR BACKFILL COMPACTED TO 95% MAX. DRY DENSITY (ASTM D-1557).

PUBLIC UTILITY EASEMENTS: ALL SANITARY SEWERS 8" AND LARGER IN DIAMETER ARE TO BE PUBLIC AND SHALL BE LOCATED IN A 20' WIDE EASEMENT. ALL

UTILITY LEGEND: -OH-ELEC-W-O-C EX. OH. ELEC, POLE & GUY WIRE -UG-CATV-VEX. U.G. CABLE TV & PEDESTAL -UG-ELEC-E-E-E EX. U.G. ELEC,MANHOLE, METER & HANDHOLE — – — – EX. GAS LINE © GAS EX. GAS VALVE & GAS LINE MARKER WATER MAIN SHALL BE LOCATED IN A 20' WIDE EASEMENT. — — — EX. WATER MAIN ♡ -○- W EX. HYDRANT, GATE VALVE & POST INDICATOR VALVE EX. SANITARY SEWER ⊚ S EX. SANITARY CLEANOUT & MANHOLE EX. COMBINED SEWER MANHOLE ---- EX. STORM SEWER EX. SQUARE, ROUND, & BEEHIVE CATCH BASIN O^{Y.D.} ® EX. YARD DRAIN & ROOF DRAIN


EX. UNIDENTIFIED STRUCTURE PROPOSED WATER MAIN ▼ ⊗ PROPOSED HYDRANT AND GATE VALVE PROPOSED TAPPING SLEEVE, VALVE & WELL PROPOSED POST INDICATOR VALVE PROPOSED SANITARY SEWER OC.O. PROPOSED SANITARY CLEANOUT & MANHOLE PROPOSED STORM SEWER ○ C.O. ● PROPOSED STORM SEWER CLEANOUT & MANHOLE

PROPOSED CATCH BASIN, INLET & YARD DRAIN







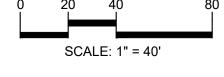



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CLIENT TROY SPORTS CENTER, LLC 1819 EAST BIG BEAVER ROAD TTOY, MI 48083

PROJECT TITLE JOHN R
COMMONS
TOWNHOME
DEVELOPMENT
PART OF THE SE 1/4 OF SECTION 23, T.
2N., R. 11E.
TROY, OAKLAND COUNTY, MI

REVISIONS	
SPA COMMENTS	11/8/23
SPA COMMENTS	3/1/24

ORIGINAL ISSUE DATE: AUGUST 18, 2023


DRAWING TITLE **PRELIMINARY UTILITY PLAN**


PEA JOB NO.	18-0034
P.M.	GMB
DN.	CNR
DES.	GMB
DRAWING NUMBER:	

FLOODPLAIN NOTE: BY GRAPHICAL PLOTTING, SITE IS WITHIN ZONE 'X', AREA DETERMINED TO BE OUTSIDE OF THE 0.2% ANNUAL CHANCE FLOODPLAIN PER FLOOD INSURANCE RATE MAP NUMBER 26125C0553G, DATED JANUARY 16, 2009.	
LOT 91 LOT 92 LOT 93 LOT 95 LOT 96 LOT 97 ID 20-23-433-006 ID 20-23-433-007 ID 20-23-433-008	
12"E 641.89 12"W 641.49 12"RCP ST 18" CMADRAIL 6' WOOD FENCE 18" CMADRAIL 18" CMP ES 18" CMADRAIL 18" CMP ES 18" CMADRAIL	i 1 1
RIM 645.34 16 No 640.34 18 No 640.34 18 No 640.55 18 N	
BUILDING 3 (6 UNITS) BUILDING 3 (6 UNITS) BUILDING 1 (6 UNITS) BUILDING 3 (6 UNITS) BUILDING 1 (6 UNITS)	
PROPOSED 8" SANITARY SEWER, TYP. PROPOSED SANITARY MANHOLE, TYP. PROPOSED STORM SEWER, TYP.	
PROPOSED END SECTION, TYP.	 - - - - -
PROPOSED CATCH BASIN, TYP.	 - - -
STORAGE EL. 642.50	 - -
PROPOSED 8" WATER MAIN, TYP.	· -
PROPOSED STORM MANHOLE, TYP. PROPOSED STORM SEWER, TYP. RIDGE PROPOSED SANITARY MANHOLE, TYP. RIDGE PROPOSED STORM SEWER, TYP. RIDGE PROPOSED STORM SEWER STORM SEWE	XISTING MANHOLE
PROPOSED CATCH BASIN, TYP.	
BUILDING 18 (6 UNITS) BUILDING 17 (6 UNITS) BUILDING 17 (6 UNITS)	
WATER MAIN, TYP. WATER MAIN, TYP. WYUG-ELEC WYUG-ELEC WYUG-ELEC WYUG-ELEC WYUG-ELEC WYUG-ELEC WYUG-ELEC RIM 645.00 18"N 629.20 18"S 629.25 18"S 629.35 8"W 631.51 RIM 645.76 RIM 645.76	
S89°48'40"W 955.42' OH-ELEC	
N89°48'40"E_ 300.00" A52" A58-91 A59	
ROCKS RIM 644.52 ASPHALT CC GC GC T/P 639.86 RIM 645.40 (T) ASPHALT ASPHALT CC GC GC GC GC GC GC GC GC G	
SONG WALK CONC WALK WALL WALL WALL WALL	
ROGER RIM 645.23 FOR BIO	
$\begin{array}{c c} & & & & \\ & &$	


Rainfall Intensity		
Time of Concentration (T _C)	20.00	min
Since 15 <tc<60, equation<="" intensity="" td="" use=""><td></td><td></td></tc<60,>		
I1 = 30.2 /[(T + 9.17)^.81]	1.97	in/hr
I10 = 50.12 / [(T + 9.17)^.81]	3 26	in/hr
1100 = 83.3/[(T + 9.17)^.81]		in/hr
CPVC: Channel Protection Volume Control V		_
Vcpvc = (4719)CA	43,095	cf
CPRC: Channel Protection Rate Control Volu	∣ me:Extended∣	Detentio
VED= (6897)CA	62,985	cf
ODDO Allemente Ordet Dete		
CPRC Allowable Outlet Rate	0.20	
$Q_{VED} = V_{ED} / (48*60*60)$	0.36	CIS
Water Quality Control		
Forebay Volume = (545)CA	4,977	cf
Forebay Release Rate: QVF = VF/(48*60*60)	0.03	cfs
100-Year Allowable Outlet Rate Since 2 <a<100, qvrr="1.1055-0.206xIn(A)</td"><td></td><td></td></a<100,>		
	0.60	cfs/ac
Q _{VRR} =	0.60	CIS/ac
100-Year Peak Allowable Discharge		
Area, A =	11.86	
$Q_{100P} = Q_{VRR}(A)$	7.07	cts
100-Year Runoff Volume		
V100R = (18,985)CA	173,376	cf
100-Year Peak Inflow		_
$Q_{100IN} = C(I_{100})A$	49.50	cts
Storage Curve Factor (Vs/Vr)		
R = 0.206-0.15 x In(Q100P/Q100IN)	0.498	
100-Year Storage Volume		
Vs = R(V100R)	86,341	cf
Infiltration will be provided. CPVC can be de	ducted:	
V100 = Vs-Vcpvc	86,341	cf
EXISTING VOLUME FROM TROY SPORTS DEV		
V _{TROYSPORTS} =	111,472	cf
DETENTION VOLUME REQUIRED =	197,813	cf
Docian Paguiromente		
Design Requirements	62.00	5 of
CPRC Extended Detention: V _{ED} =	62,98	
CPRC Allowable Outlet Rate: Q _{VED} =	0.3	6 cfs
100 Voor Storago Volumo V	107.81	


Design Requi	rements			
CPRC Extende	ed Detention: V _E	_{ED} =	62,985	С
CPRC Allowab	le Outlet Rate:	Q _{VED} =	0.36	С
100-Year Stora	ige Volume, V ₁₀	_{00D} =	197,813	С
100-Year Allow	able Outlet Rat	e: Q _{VRR} =	7.07	С
100 Year Peak	Inflow: Q _{100IN} =		49.50	С
Detention Bas	sin			
CPRC Storage	Elevation:	<u>639.62</u>	62,985	C
100-yr Storage	Elevation:	<u>642.31</u>	197,813	C
Elev. (ft)	Area (sf)	Vol. (cf)	Total Vol. (cf)	
638.00	34,362	0	0	
639.00	39,349	36,856	36,856	
640.00	44,758	42,054	78,909	
641.00	50,391	47,575	126,484	
642.00	56,439	53,415	179,899	
642.50	59,300	28,935	208,833	
643.50	freeboard	0	208,833	
				F

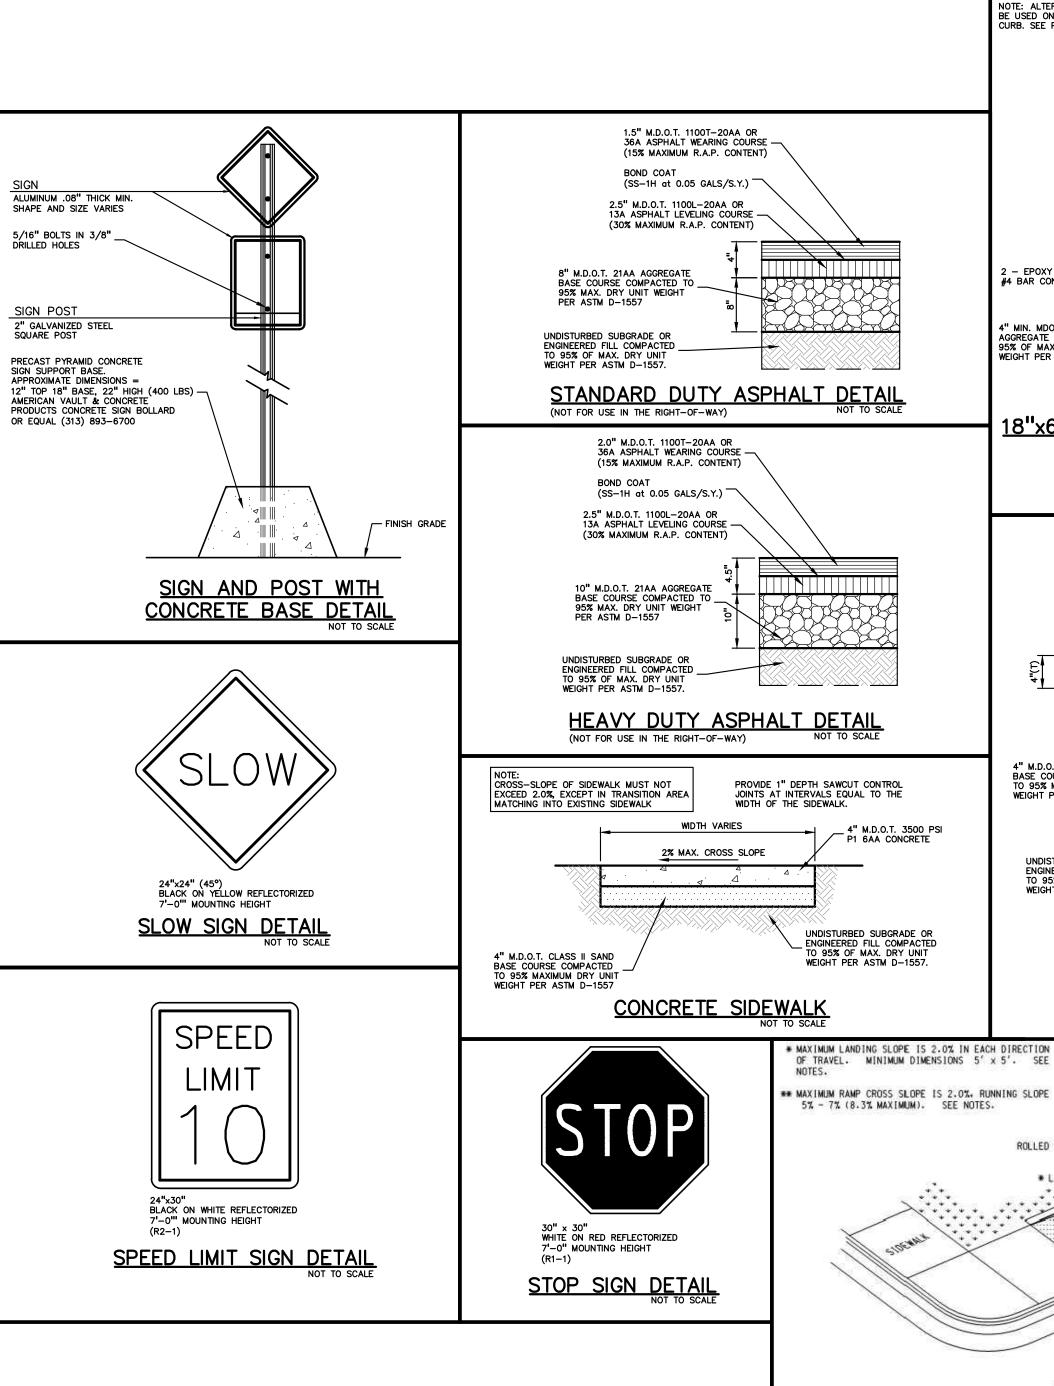

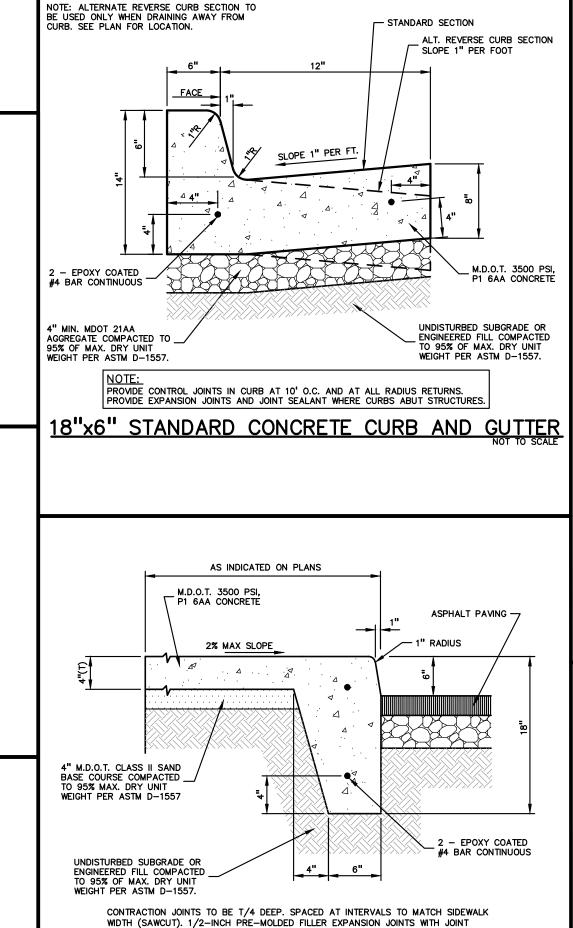



INTEGRAL CURB AND SIDEWALK

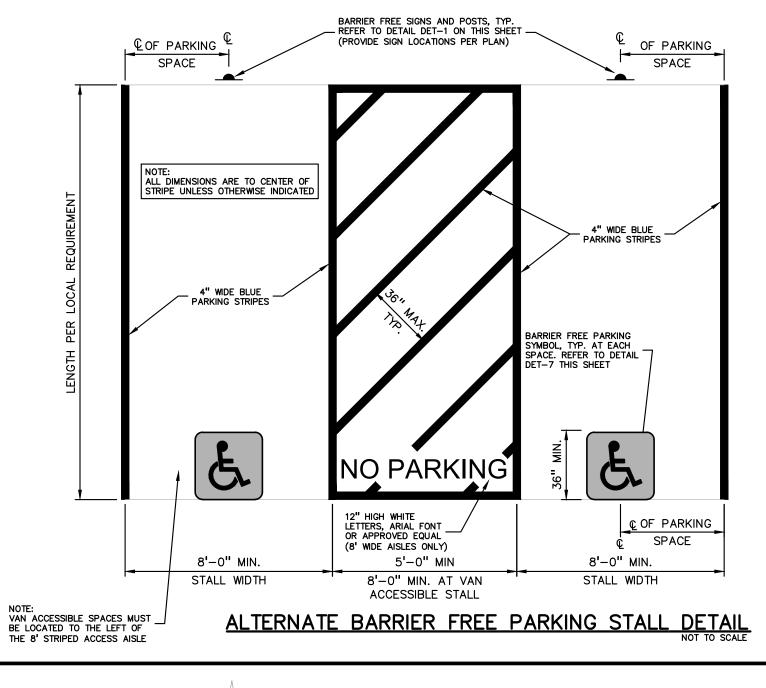

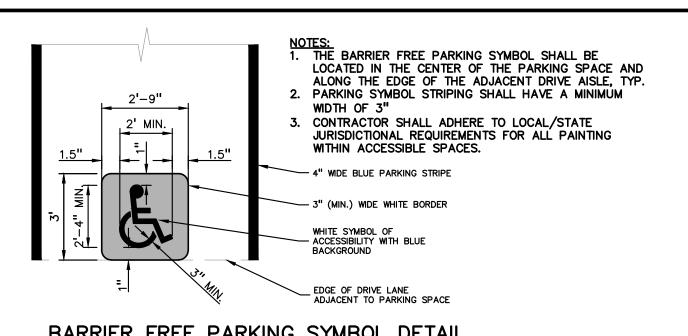


BARRIER FREE PARKING SYMBOL DETAIL (INTERNATIONAL SYMBOL OF ACCESSIBILITY)

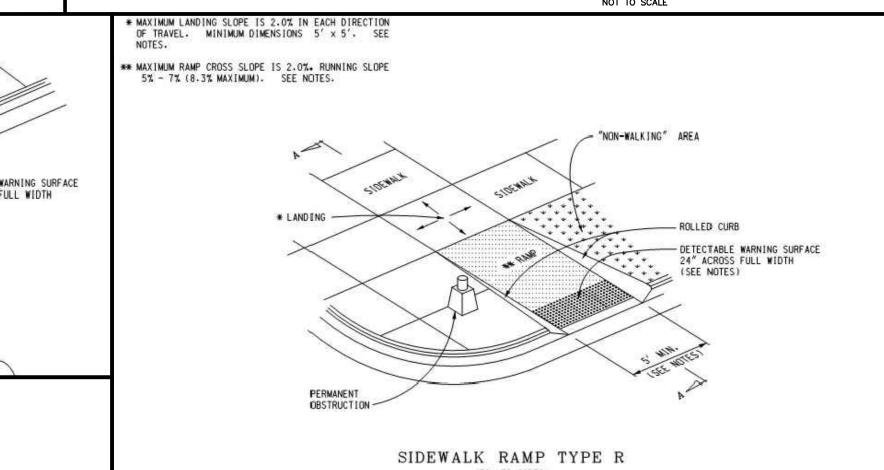

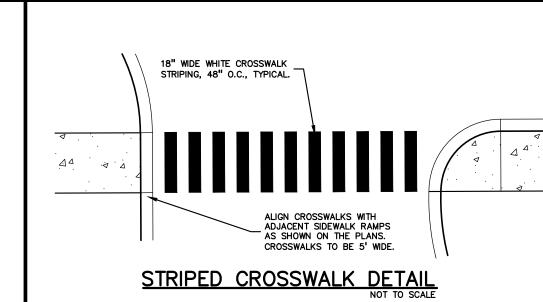




- ONE SIGN IS REQUIRED AT EACH BARRIER FREE PARKING SPACE.
 ALL SIGNS SHALL COMPLY WITH THE LATEST STANDARDS OF THE MICHIGAN MANUAL OF UNIFORM TRAFFIC CONTROL DEVICES (MMUTCD).
- 3. WHEN TWO BARRIER FREE PARKING SPACES ARE ADJACENT AND FACING EACH OTHER, TWO SIGNS ARE REQUIRED, BUT CAN BE MOUNTED ON THE SAME POST.
- 4. SIGN POSTS SHALL BE 2" NOM. SQUARE 14-GAUGE GALVANIZED STEEL TUBE WITH 7/16" HOLES AT 1" CENTERS. POSTS SHALL TELESCOPE INSIDE ANCHOR POSTS A
- MINIMUM OF 12". 5. ANCHOR POSTS SHALL BE 2.25" NOM. SQUARE 12-GAUGE GALVANIZED STEEL POST, A MINIMUM OF 3 FEET LONG.
- 6. IF THESE NOTES AND DETAILS CONFLICT WITH LOCAL CODES AND ORDINANCES, THE STRICTER REQUIREMENT SHOULD BE USED. 7. ALTERNATE MATERIALS MAY BE USED IF IN COMPLIANCE WITH A.D.A. GUIDELINES

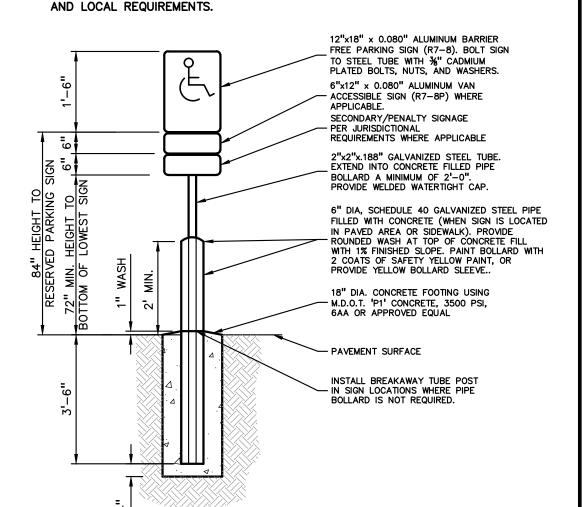

BARRIER FREE SIGN AND POST DETAIL

NOT TO SCALE



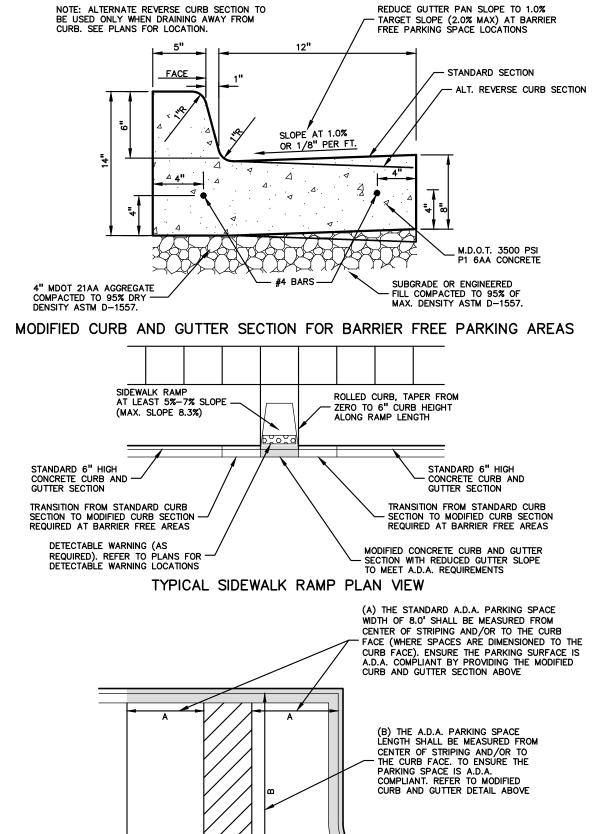

TYPICAL BARRIER FREE PARKING SPACES

THE LOCATIONS AND ELEVATIONS OF EXISTING UNDERGROUND UTILITIES AS SHOWN ON THIS DRAWING ARE ONLY APPROXIMATE. NO GUARANTEE IS EITHER EXPRESSED OR IMPLIED AS TO THE COMPLETENESS OR ACCURACY THEREOF. THE CONTRACTOR SHALL BE EXCLUSIVELY RESPONSIBLE FOR DETERMINING THE EXACT UTILITY LOCATIONS AND ELEVATIONS PRIOR TO THE START OF CONSTRUCTION.

t: 844.813.2949

www.peagroup.com

GREGORY

BONO

ENGINEER

CLIENT **TROY SPORTS CENTER, LLC**

CAUTION!!

PROJECT TITLE JOHN R **COMMONS TOWNHOME**

DEVELOPMENT PART OF THE SE 1/4 OF SECTION 23, 1 2N., R. 11E. TROY, OAKLAND COUNTY, MI

REVISIONS	
SPA COMMENTS	11/8/23
SPA COMMENTS	3/1/24


ORIGINAL ISSUE DATE: AUGUST 18, 2023 DRAWING TITLE

NOTES AND DETAILS


18-0034 PEA JOB NO. GMB CNR DES. GMB DRAWING NUMBER:

C-5.0

ROLLED CURB -* LANDING -ETECTABLE WARNING SURFACE 24" ACROSS FULL WIDTH (SEE NOTES) SIDEWALK RAMP TYPE P (PARALLEL RAMP)
DO NOT USE IN AREAS WHERE PONDING MAY OCCUR "NON-WALKING" AREA -1'-2' DIA. USE LARGER BOULDER ON BOTTOM OF PROPOSED CURB -(ROLLED SIDES) FILTER FABRIC (MIRAF BURY BOTTOM — BOULDER TO A

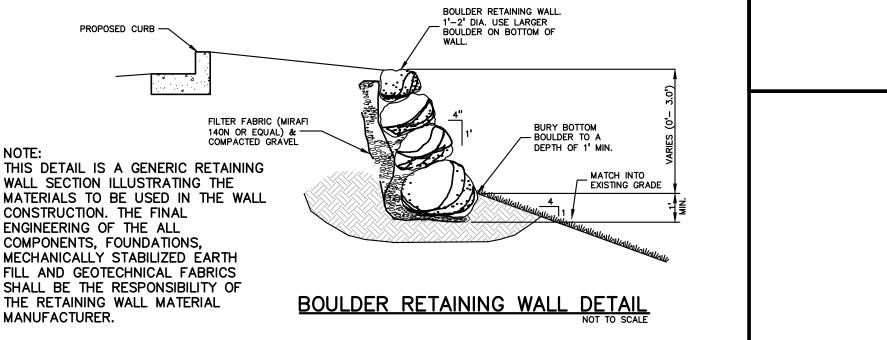

MODIFIED 18"x6" CONCRETE CURB AND GUTTER DETAIL TO BE USED IN BARRIER FREE AREAS NOT FOR CONSTRUCTION

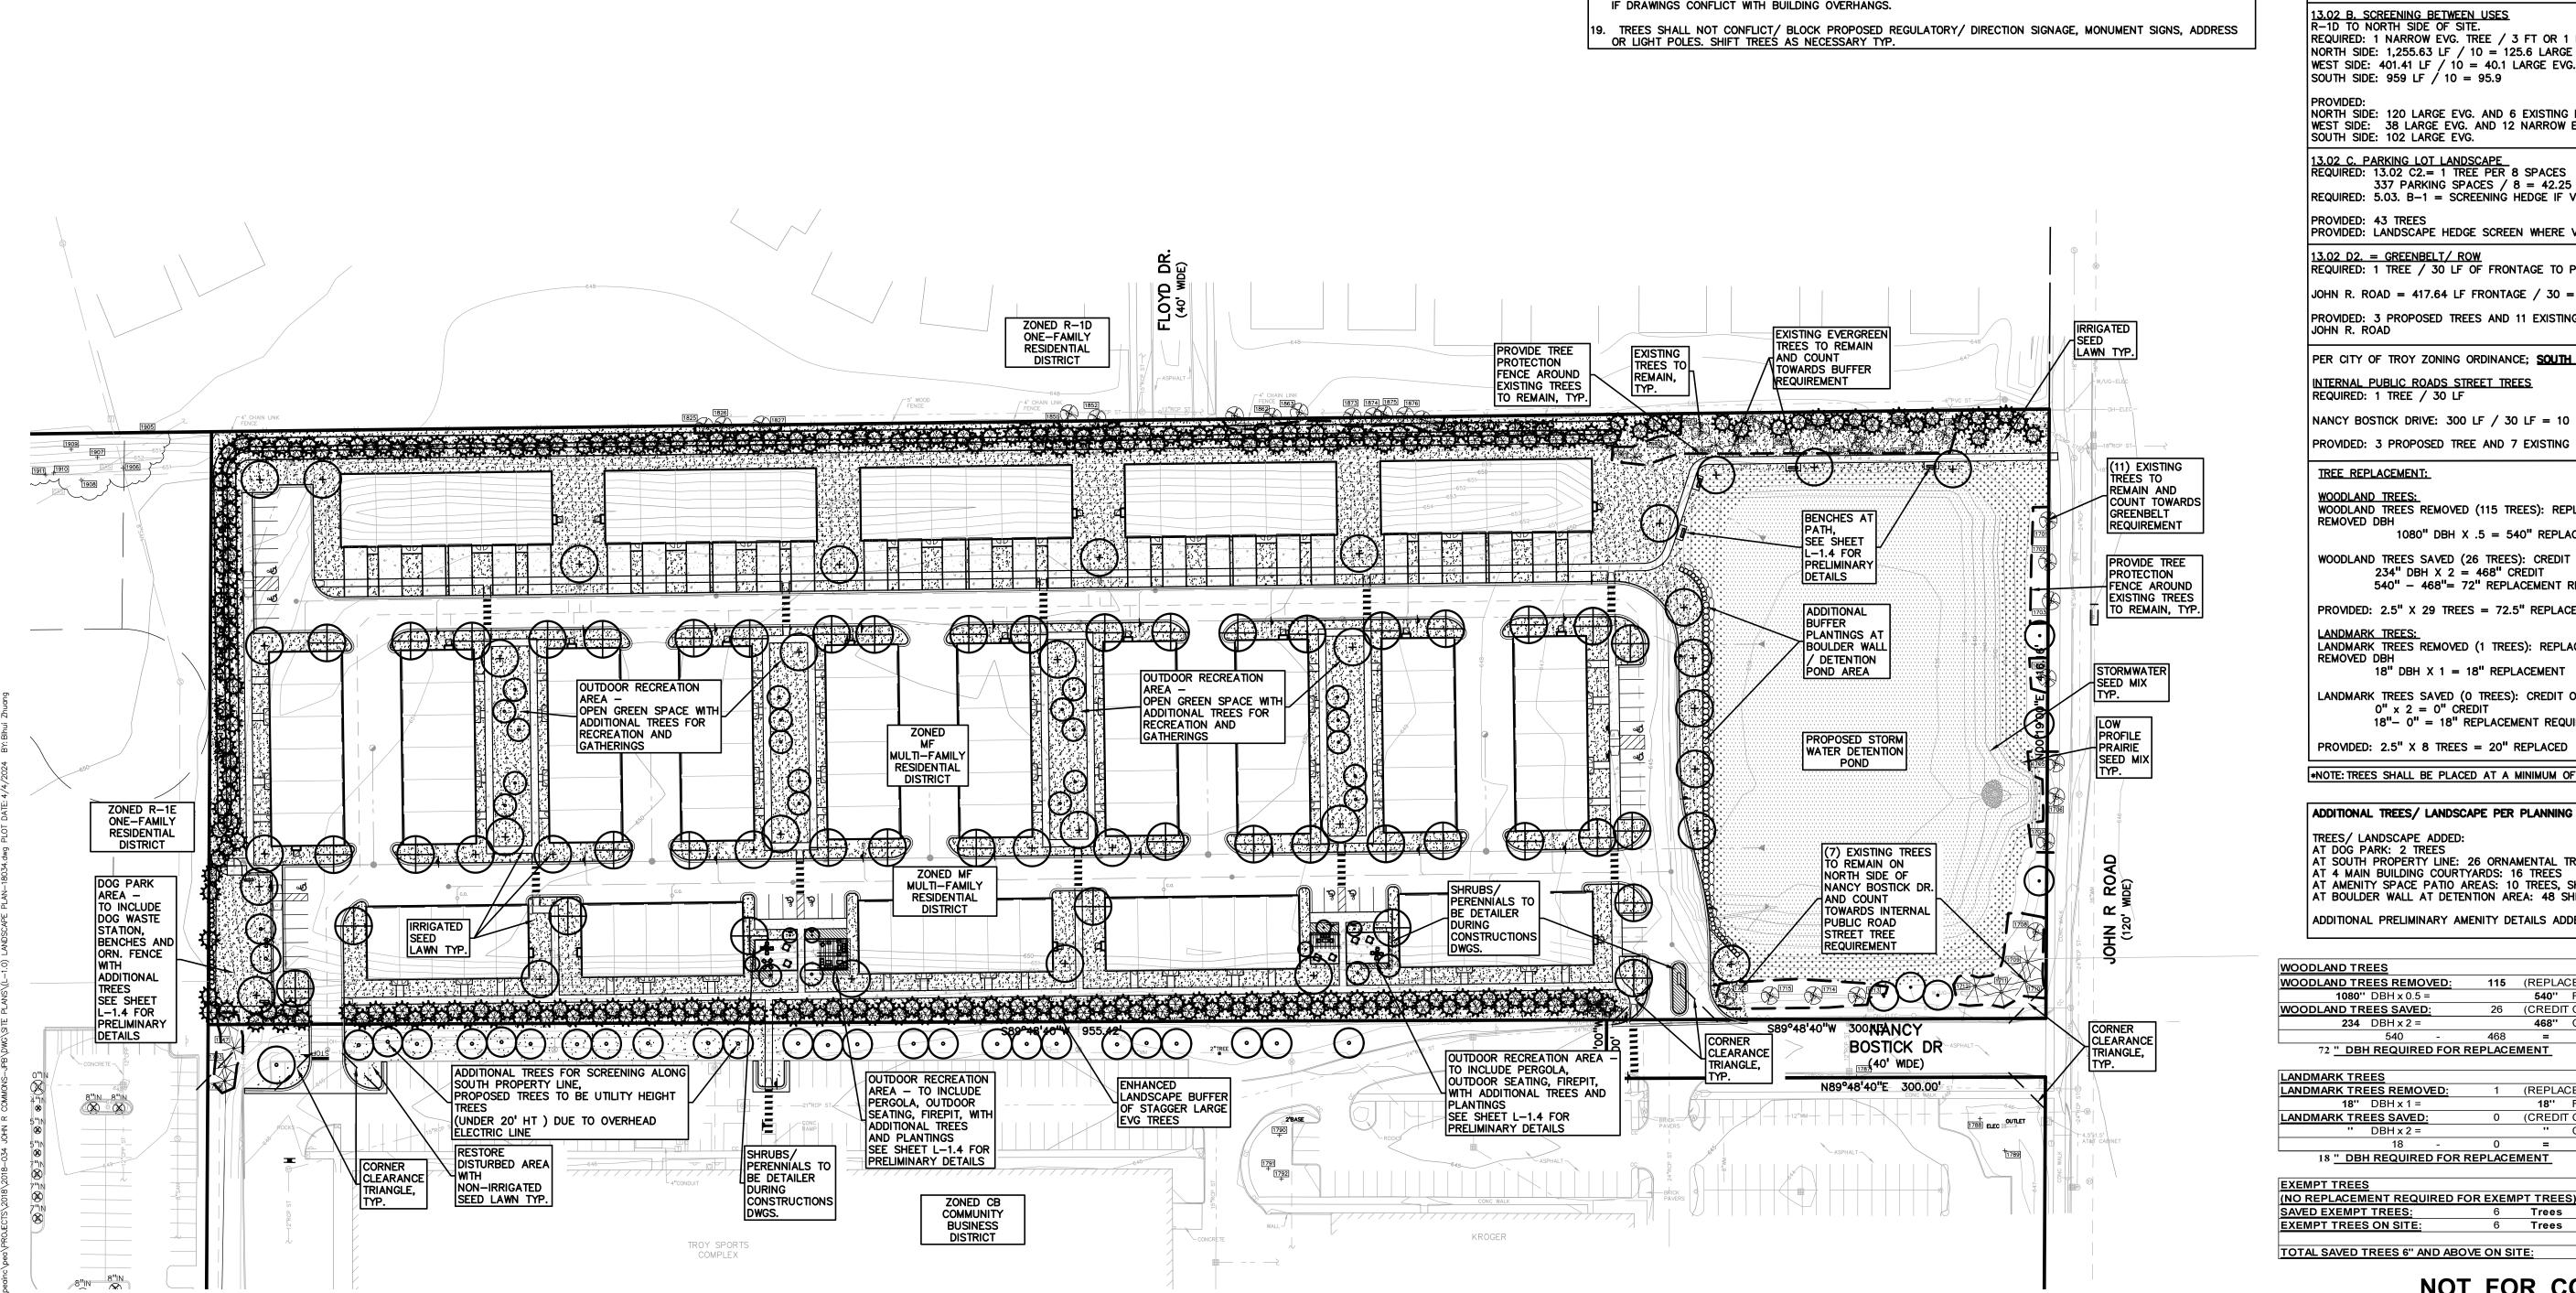

GENERAL PLANTING NOTES:

SPECIFICATIONS.

QUANTITIES. CONTACT LANDSCAPE ARCHITECT WITH ANY CONCERNS.

THOSE WITH THIN OR OPEN CROWNS SHALL NOT BE ACCEPTED.

15. ALL LANDSCAPED AREAS SHALL RECEIVE 3" COMPACTED TOPSOIL.

NOT SHEARED FOR THE LAST FIVE GROWING SEASONS.

THE DRIP LINE OF EXISTING TREES.

LANDSCAPE CONTRACTOR SHALL VISIT SITE, INSPECT EXISTING SITE CONDITIONS AND REVIEW PROPOSED PLANTING AND RELATED WORK. IN CASE OF DISCREPANCY BETWEEN PLAN AND PLANT LIST, PLAN SHALL GOVERN

CONTRACTOR SHALL VERIFY LOCATIONS OF ALL ON SITE UTILITIES PRIOR TO BEGINNING CONSTRUCTION ON HIS/HER

1-800-482-7171. ANY DAMAGE OR INTERRUPTION OF SERVICES SHALL BE THE RESPONSIBILITY OF CONTRACTOR. CONTRACTOR SHALL COORDINATE ALL RELATED ACTIVITIES WITH OTHER TRADES ON THE JOB AND SHALL REPORT

ALL PLANT MATERIAL TO BE PREMIUM GRADE NURSERY STOCK AND SHALL SATISFY AMERICAN ASSOCIATION OF NURSERYMEN STANDARD FOR NURSERY STOCK. ALL LANDSCAPE MATERIAL SHALL BE NORTHERN GROWN, NO. 1.

CONTRACTOR IS RESPONSIBLE FOR VERIFYING ALL QUANTITIES SHOWN ON LANDSCAPE PLAN PRIOR TO PRICING THE

ALL SINGLE TRUNK SHADE TREES TO HAVE A CENTRAL LEADER; TREES WITH FORKED OR IRREGULAR TRUNKS WILL

ALL MULTI STEM TREES SHALL BE HEAVILY BRANCHED AND HAVE SYMMETRICAL CROWNS. ONE SIDED TREES OR

ALL EVERGREEN TREES SHALL BE HEAVILY BRANCHED AND FULL TO THE GROUND, SYMMETRICAL IN SHAPE AND

I. NO MACHINERY IS TO BE USED WITHIN THE DRIP LINE OF EXISTING TREES; HAND GRADE ALL LAWN AREAS WITHIN

12. ALL TREE LOCATIONS SHALL BE STAKED BY LANDSCAPE CONTRACTOR AND ARE SUBJECT TO THE APPROVAL OF

14. ALL PLANTING BEDS SHALL RECEIVE 3" SHREDDED HARDWOOD BARK MULCH WITH PRE EMERGENT, SEE

16. SEE SPECIFICATIONS FOR ADDITIONAL COMMENTS, REQUIREMENTS, PLANTING PROCEDURES AND WARRANTY

17. FOR NON-LAWN SEED MIX AREAS, AS NOTED ON PLAN, BRUSH MOW ONCE SEASONALLY FOR INVASIVE SPECIES

18. CONTRACTOR SHALL NOT INSTALL PLANTS UNDER BUILDING OVERHANG AND SHALL NOTIFY LANDSCAPE ARCHITECT

THE OWNER'S REPRESENTATIVE RESERVES THE RIGHT TO REJECT ANY PLANT MATERIAL NOT MEETING

PHASE OF WORK. ELECTRIC, GAS, TELEPHONE, CABLE TELEVISION MAY BE LOCATED BY CALLING MISS DIG

ANY UNACCEPTABLE JOB CONDITIONS TO OWNER'S REPRESENTATIVE PRIOR TO COMMENCING.

. ALL SINGLE STEM SHADE TREES TO HAVE STRAIGHT TRUNKS AND SYMMETRICAL CROWNS.

10. ALL TREES TO HAVE CLAY OR CLAY LOAM BALLS, TREES WITH SAND BALLS WILL BE REJECTED.

THE LANDSCAPE ARCHITECT PRIOR TO INSTALLATION OF THE PLANT MATERIAL.

13. IT IS MANDATORY THAT POSITIVE DRAINAGE IS PROVIDED AWAY FROM ALL BUILDINGS.

SPECIFICATIONS. SHREDDED PALETTE AND DYED MULCH WILL NOT BE ACCEPTED.

KEY: = BUFFER TREES / EVERGREEN SCREENING BETWEEN USES = PARKING LOT TREES = GREENBELT / ROW TREES AND INTERNAL ROAD TREES = REPLACEMENT TREES = ADDITIONAL TREE ADDED PER PLANNING COMMISSION COMMENTS = IRRIGATED SEED LAWN = NON-IRRIGATED SEED LAWN = SHRUBS / PERENNIALS TO BE DETAILED DURING CONSTRUCTION DWGS. = EXISTING TREE TO REMAIN = TREE PROTECTION FENCING SEE SHEETS L-1.2, L-1.3 FOR TREE TYPE / QTY; L-1.3 FOR LANDSCAPE DETAILS , SHEET L-1.4 FOR PRELIMINARY AMENITY DETAILS SEE SHEETS T-1.0 - T-1.2 FOR EXISTING TREE INFORMATION NOTE: TREES SHALL BE PLACED AT A MINIMUM OF 5' AWAY FROM UTILITY LEADS. ANDSCAPE CALCULATIONS: PER CITY OF TROY ZONING ORDINANCE: MF - MULTIFAMILY RESIDENTIAL 5.03 C-1a. = GENERAL SITE LANDSCAPE REQUIRED: 20% OF SITE AREA SHALL BE LANDSCAPE MATERIAL 516,625 SF * 20% = 103,325 SQ FT REQUIRED PROVIDED: 173,048 SQ FT LANDSCAPE 13.02 B. SCREENING BETWEEN USES R-1D TO NORTH SIDE OF SITE. REQUIRED: 1 NARROW EVG. TREE / 3 FT OR 1 LARGE EVG. TREE / 10 LF NORTH SIDE: 1,255.63 LF / 10 = 125.6 LARGE EVG. WEST SIDE: $401.41 \, \text{LF} / 10 = 40.1 \, \text{LARGE} \, \text{EVG}.$ SOUTH SIDE: 959 LF / 10 = 95.9 NORTH SIDE: 120 LARGE EVG. AND 6 EXISTING EVG. TREES WEST SIDE: 38 LARGE EVG. AND 12 NARROW EVERGREEN TREES SOUTH SIDE: 102 LARGE EVG. 13.02 C. PARKING LOT LANDSCAPE REQUIRED: 13.02 C2.= 1 TREE PER 8 SPACES 337 PARKING SPACES / 8 = 42.25 TREES REQUIRED REQUIRED: 5.03. B-1 = SCREENING HEDGE IF VISIBLE TO PUBLIC ROADPROVIDED: 43 TREES PROVIDED: LANDSCAPE HEDGE SCREEN WHERE VISIBLE ON JOHN R. RD 13.02 D2. = GREENBELT/ROWREQUIRED: 1 TREE / 30 LF OF FRONTAGE TO PUBLIC RD. JOHN R. ROAD = 417.64 LF FRONTAGE / 30 = 13.9 TREES PROVIDED: 3 PROPOSED TREES AND 11 EXISTING TREES TO REMAIN ALONG JOHN R. ROAD PER CITY OF TROY ZONING ORDINANCE; SOUTH EAST END OF SITE INTERNAL PUBLIC ROADS STREET TREES REQUIRED: 1 TREE / 30 LF NANCY BOSTICK DRIVE: 300 LF / 30 LF = 10 TREES PROVIDED: 3 PROPOSED TREE AND 7 EXISTING TREES TREE REPLACEMENT:

WOODLAND TREES:

LANDMARK TREES:

TREES/ LANDSCAPE ADDED:

234 DBH x 2 =

18" DBH x 1 =

REMOVED DBH

REMOVED DBH

WOODLAND TREES REMOVED (115 TREES): REPLACE AT 50% OF

540" - 468"= 72" REPLACEMENT REQUIRED

LANDMARK TREES REMOVED (1 TREES): REPLACE AT 100% OF

18" DBH X 1 = 18" REPLACEMENT

LANDMARK TREES SAVED (0 TREES): CREDIT OF 2X DBH

18"- 0" = 18" REPLACEMENT REQUIRED

ADDITIONAL PRELIMINARY AMENITY DETAILS ADDED TO SHEET L-1.3

WOODLAND TREES SAVED (26 TREES): CREDIT OF 2X DBH

234" DBH X 2 = 468" CREDIT

PROVIDED: 2.5" X 29 TREES = 72.5" REPLACED

 $0" \times 2 = 0" CREDIT$

PROVIDED: 2.5" X 8 TREES = 20" REPLACED

AT DOG PARK: 2 TREES
AT SOUTH PROPERTY LINE: 26 ORNAMENTAL TREES
AT 4 MAIN BUILDING COURTYARDS: 16 TREES

72 " DBH REQUIRED FOR REPLACEMENT

18 " DBH REQUIRED FOR REPLACEMENT

1080" DBH \times .5 = 540" REPLACEMENT

TROY SPORTS CENTER, LLC 1819 EAST BIG BEÁVER ROAD TTOY, MI 48083 PROJECT TITLE JOHN R COMMONS **TOWNHOME DEVELOPMENT** PART OF THE SE 1/4 OF SECTION 23, 2N., R. 11E. TROY, OAKLAND COUNTY, MI REVISIONS SPA COMMENTS 11/8/23 SPA COMMENTS 3/1/24 *NOTE: TREES SHALL BE PLACED AT A MINIMUM OF 5' AWAY FROM UTILITY LEADS. ADDITIONAL TREES/ LANDSCAPE PER PLANNING COMMISSION COMMENTS: AT AMENITY SPACE PATIO AREAS: 10 TREES, SHRUBS TO BE DTL. AT CDS AT BOULDER WALL AT DETENTION AREA: 48 SHRUBS AND 27 PERENNIALS ORIGINAL ISSUE DATE: AUGUST 18, 2023 115 (REPLACE AT 50% OF REMOVED DBH) DRAWING TITLE **OVERALL LANDSCAPE PLAN**

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SCALE: 1" = 60'

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CAUTION!!

NOT FOR CONSTRUCTION

540" REPLACEMENT

18" REPLACEMENT

(REPLACE AT 100% OF REMOVED DBH)

26 (CREDIT OF 2X DBH)

468" CREDIT

(CREDIT OF 2X DBH)

Trees

Trees

PEA JOB NO.

DRAWING NUMBER:

PM

DN.

DES.

18-0034


GMB


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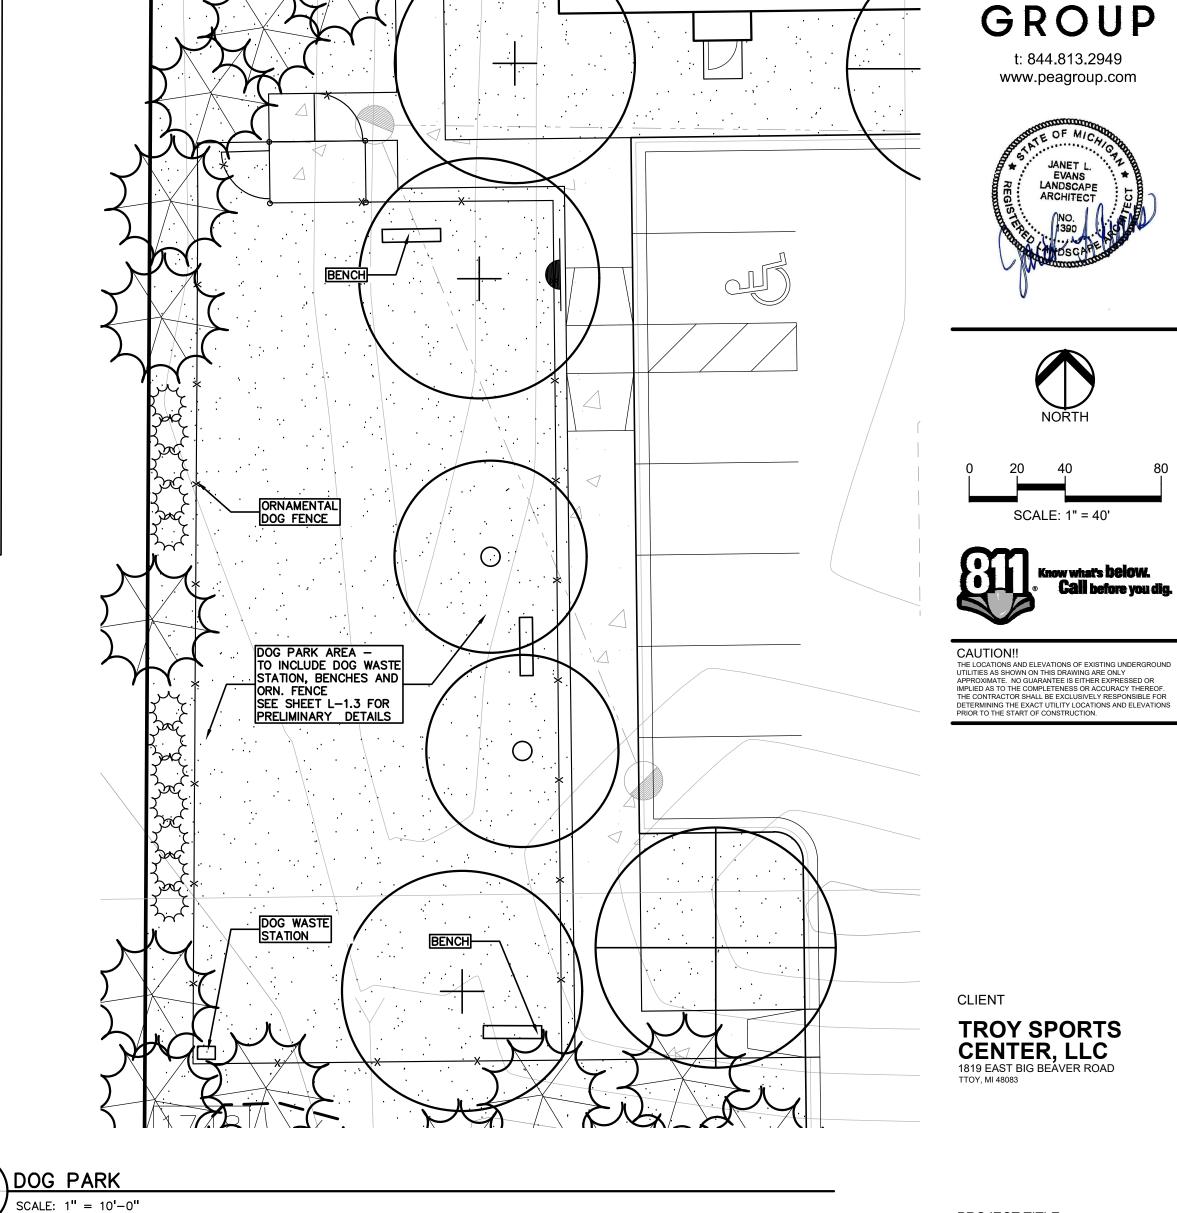
JLE


DECIDUO	US TREE PL	ANT LIST:			
QUANTITY	KEY SYMBOL	COMMON NAME	SCIENTIFIC NAME	SIZE	SPEC
5	AL8	Allegheny Serviceberry	Amelanchier laevis	8' Ht.	B&B
1	AR2.5	Bowhall Maple	Acer rubrum 'Bowhall'	2.5" Cal.	B&B
1	AS2.5	Green Mountian Sugar Maple	Acer saccharum 'Green Mountain'	2.5" Cal.	B&B
7	CC8	Ace of Heart Eastern Redbud	Cercis canadensis 'Ace of Heart'	8' Ht.	B&B
5	HI8	Arnold Promise Witch Hazel	Hamamelis x intermedia 'Arnold Promise'	8' Ht.	B&B
1	LS2.5	Slender Silhouette Sweetgum	Liquidambar styraciflua 'Slender Silhouette'	2.5" Cal.	B&B
7	MR2.5	Red Jewel Crabapple	Malus 'Red Jewel'	2.5" Cal.	B&B
2	QS2.5	Streetspire Oak	Quercus alba 'JFS-KW1QX' (columnar)	2.5" Cal.	B&B
4	SR2.5	Japanese Tree Lilac	Syringa reticulata	2.5" Cal.	B&B
33	TOTAL DEC.				
SHRUB P	LANT LIST:				
QUANTITY	KEY SYMBOL	COMMON NAME	SCIENTIFIC NAME	SIZE	SPEC
12	JH6	Hetz Columnar Juniper	Juniperus chinensis 'Hetzii Columnaris'	6'	B&B
12	TOTAL SHRUE	3S			


DECIDUO	US TREE PL	ANT LIST:			
QUANTITY	KEY SYMBOL	COMMON NAME	SCIENTIFIC NAME	SIZE	SPEC
2	AR2.5	Bowhall Maple	Acer rubrum 'Bowhall'	2.5" Cal.	B&B
2	AS2.5	Green Mountian Sugar Maple	Acer saccharum 'Green Mountain'	2.5" Cal.	B&B
8	GT2.5	Skyline Honeylocust	Gleditsia triacanthos 'Skyline' Inermis	2.5" Cal.	B&B
4	PA2.5	Encore London Planetree	Platanus x acerifolia 'Encore'	2.5" Cal.	B&B
4	QR2.5	Red Oak	Quercus rubra	2.5" Cal.	B&B
8	TC2.5	Greenspire Linden	Tilia cordata 'Greenspire'	2.5" Cal.	B&B
8	UF2.5	Frontier Elm	Ulmus 'Frontier'	2.5" Cal.	B&B
36	TOTAL DEC.				
EVERGRE	EN TREE PL	ANT LIST:			
QUANTITY	KEY SYMBOL	COMMON NAME	SCIENTIFIC NAME	SIZE	SPEC
19	PA8	Norway Spruce	Picea abies	8' Ht.	B&B
32	PG8	Black Hills Spruce	Picea glauca 'Densata'	8' Ht.	B&B
34	PO8	Serbian Spruce	Picea omorika	8' Ht.	B&B
27	PM8	Douglas Fir	Pseudotsuga menziesii	8' Ht.	B&B
5	PS8	Eastern White pine	Pinus strobus	8' Ht.	B&B
10	TC8	Canadian Hemlock	Tsuga canadensis	8' Ht.	B&B
127	TOTAL EVG.				



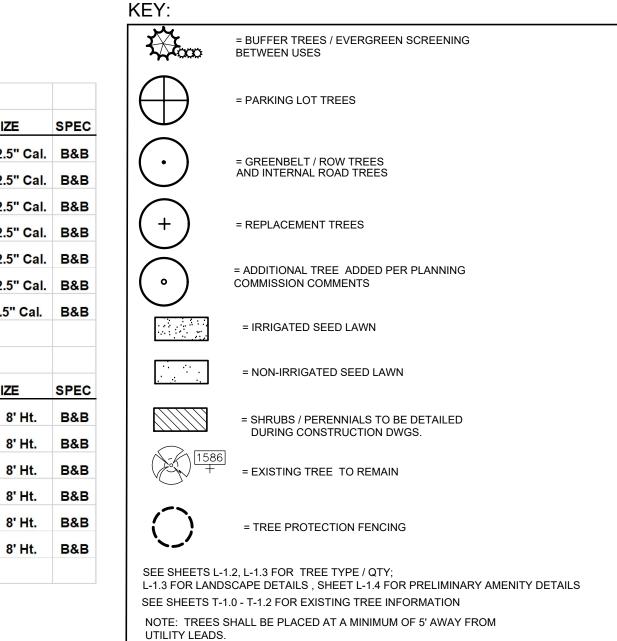

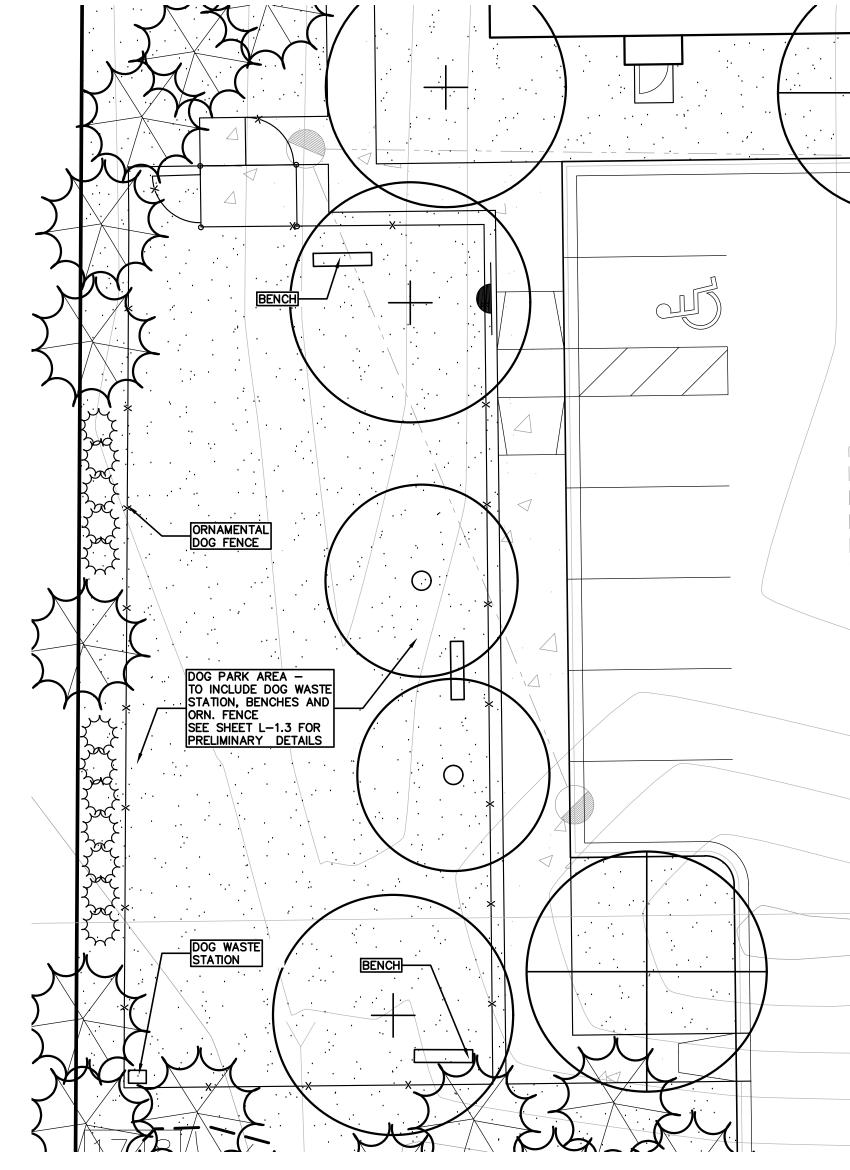

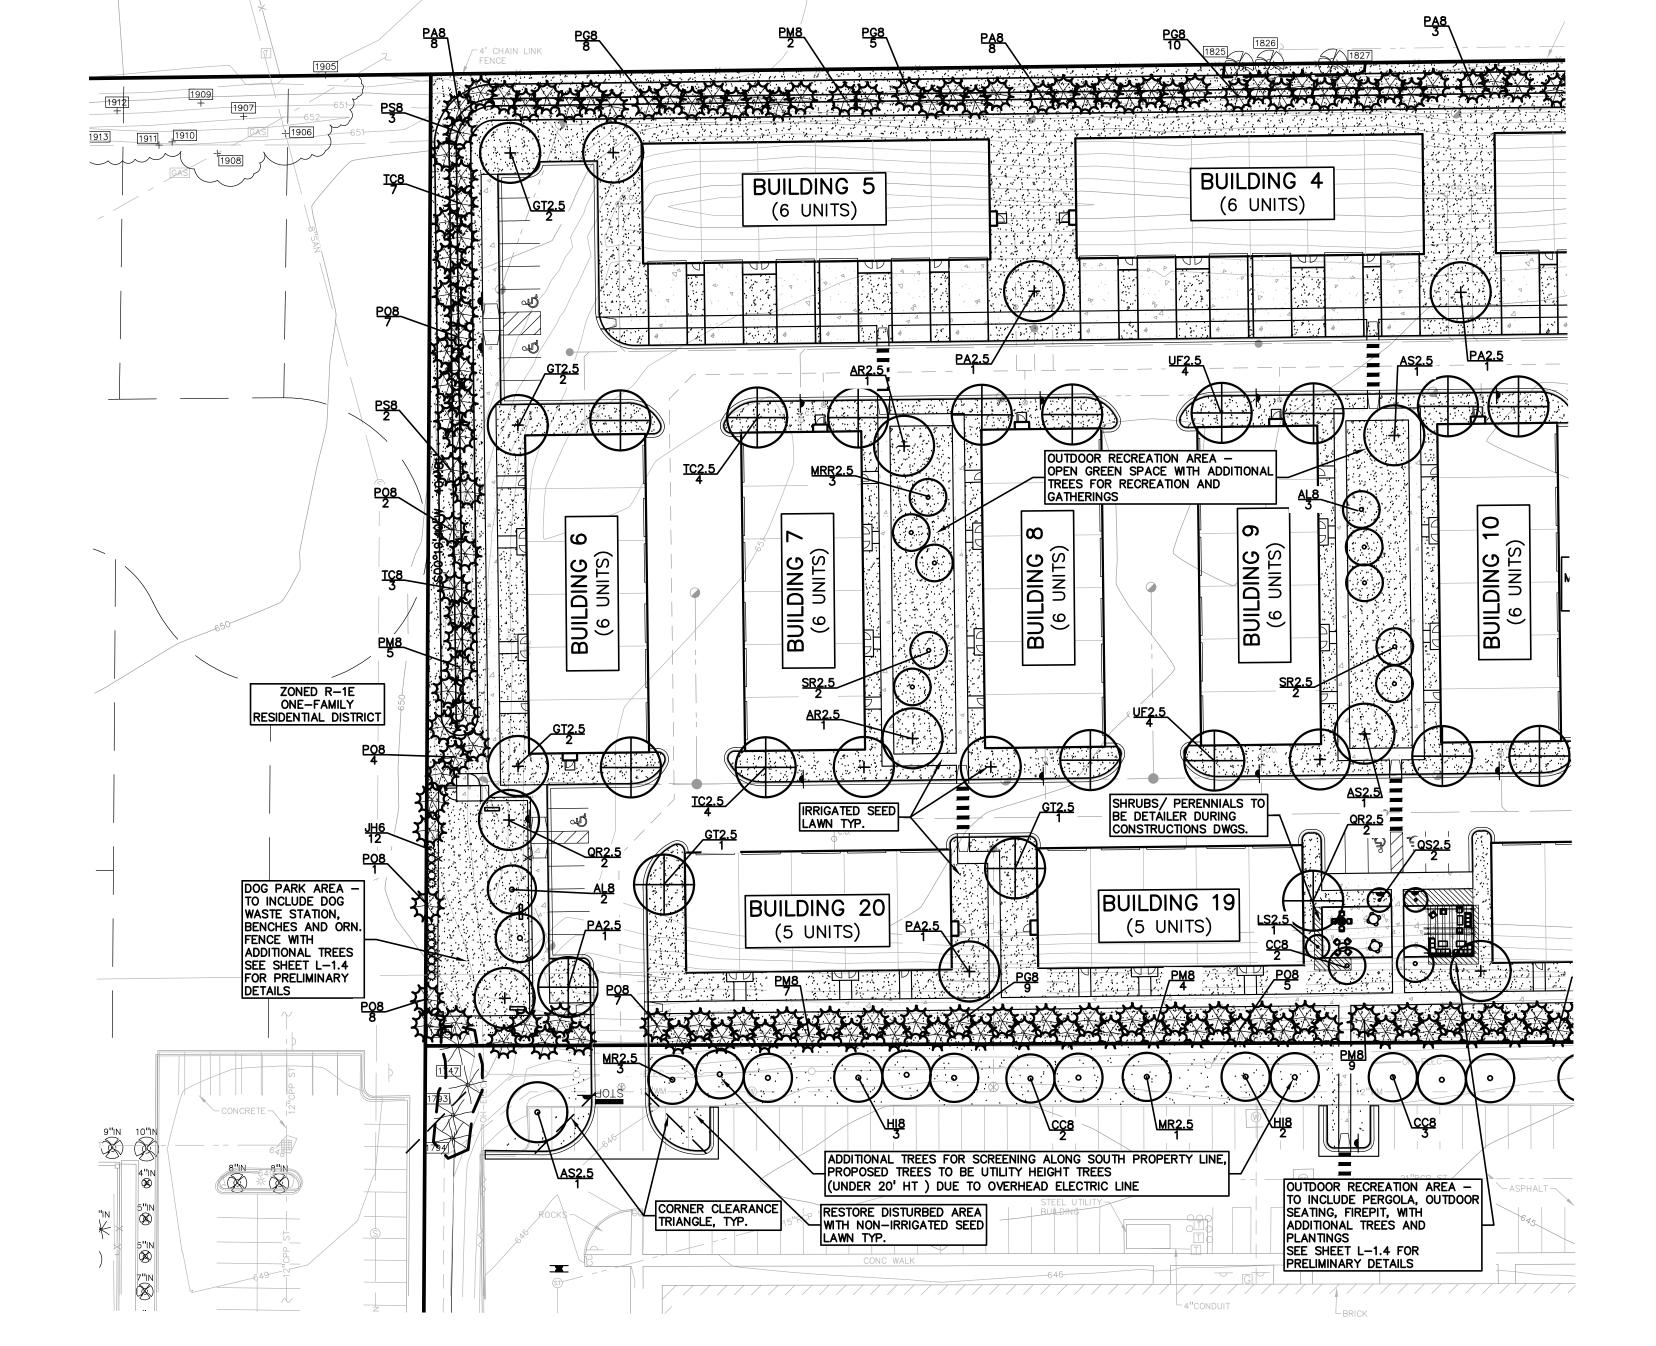

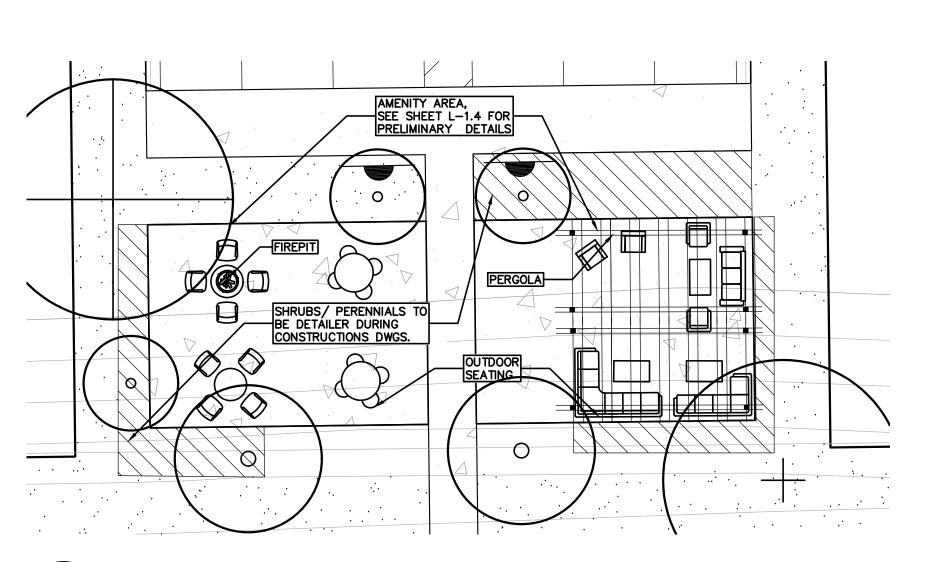

OUTDOOR RECREATION AREA


PROJECT TITLE JOHN R COMMONS TOWNHOME DEVELOPMENT PART OF THE SE 1/4 OF SECTION 23, T. 2N., R. 11E. TROY, OAKLAND COUNTY, MI

REVISIONS	
SPA COMMENTS	11/8/2
SPA COMMENTS	3/1/2

ORIGINAL ISSUE DATE: AUGUST 18, 2023

DRAWING TITLE **PRELIMINARY** LANDSCAPE **PLAN - WEST**

PEA JOB NO.	18-0034
P.M.	GME
DN.	BZ
DES.	JLE
DRAWING NUMBER:	

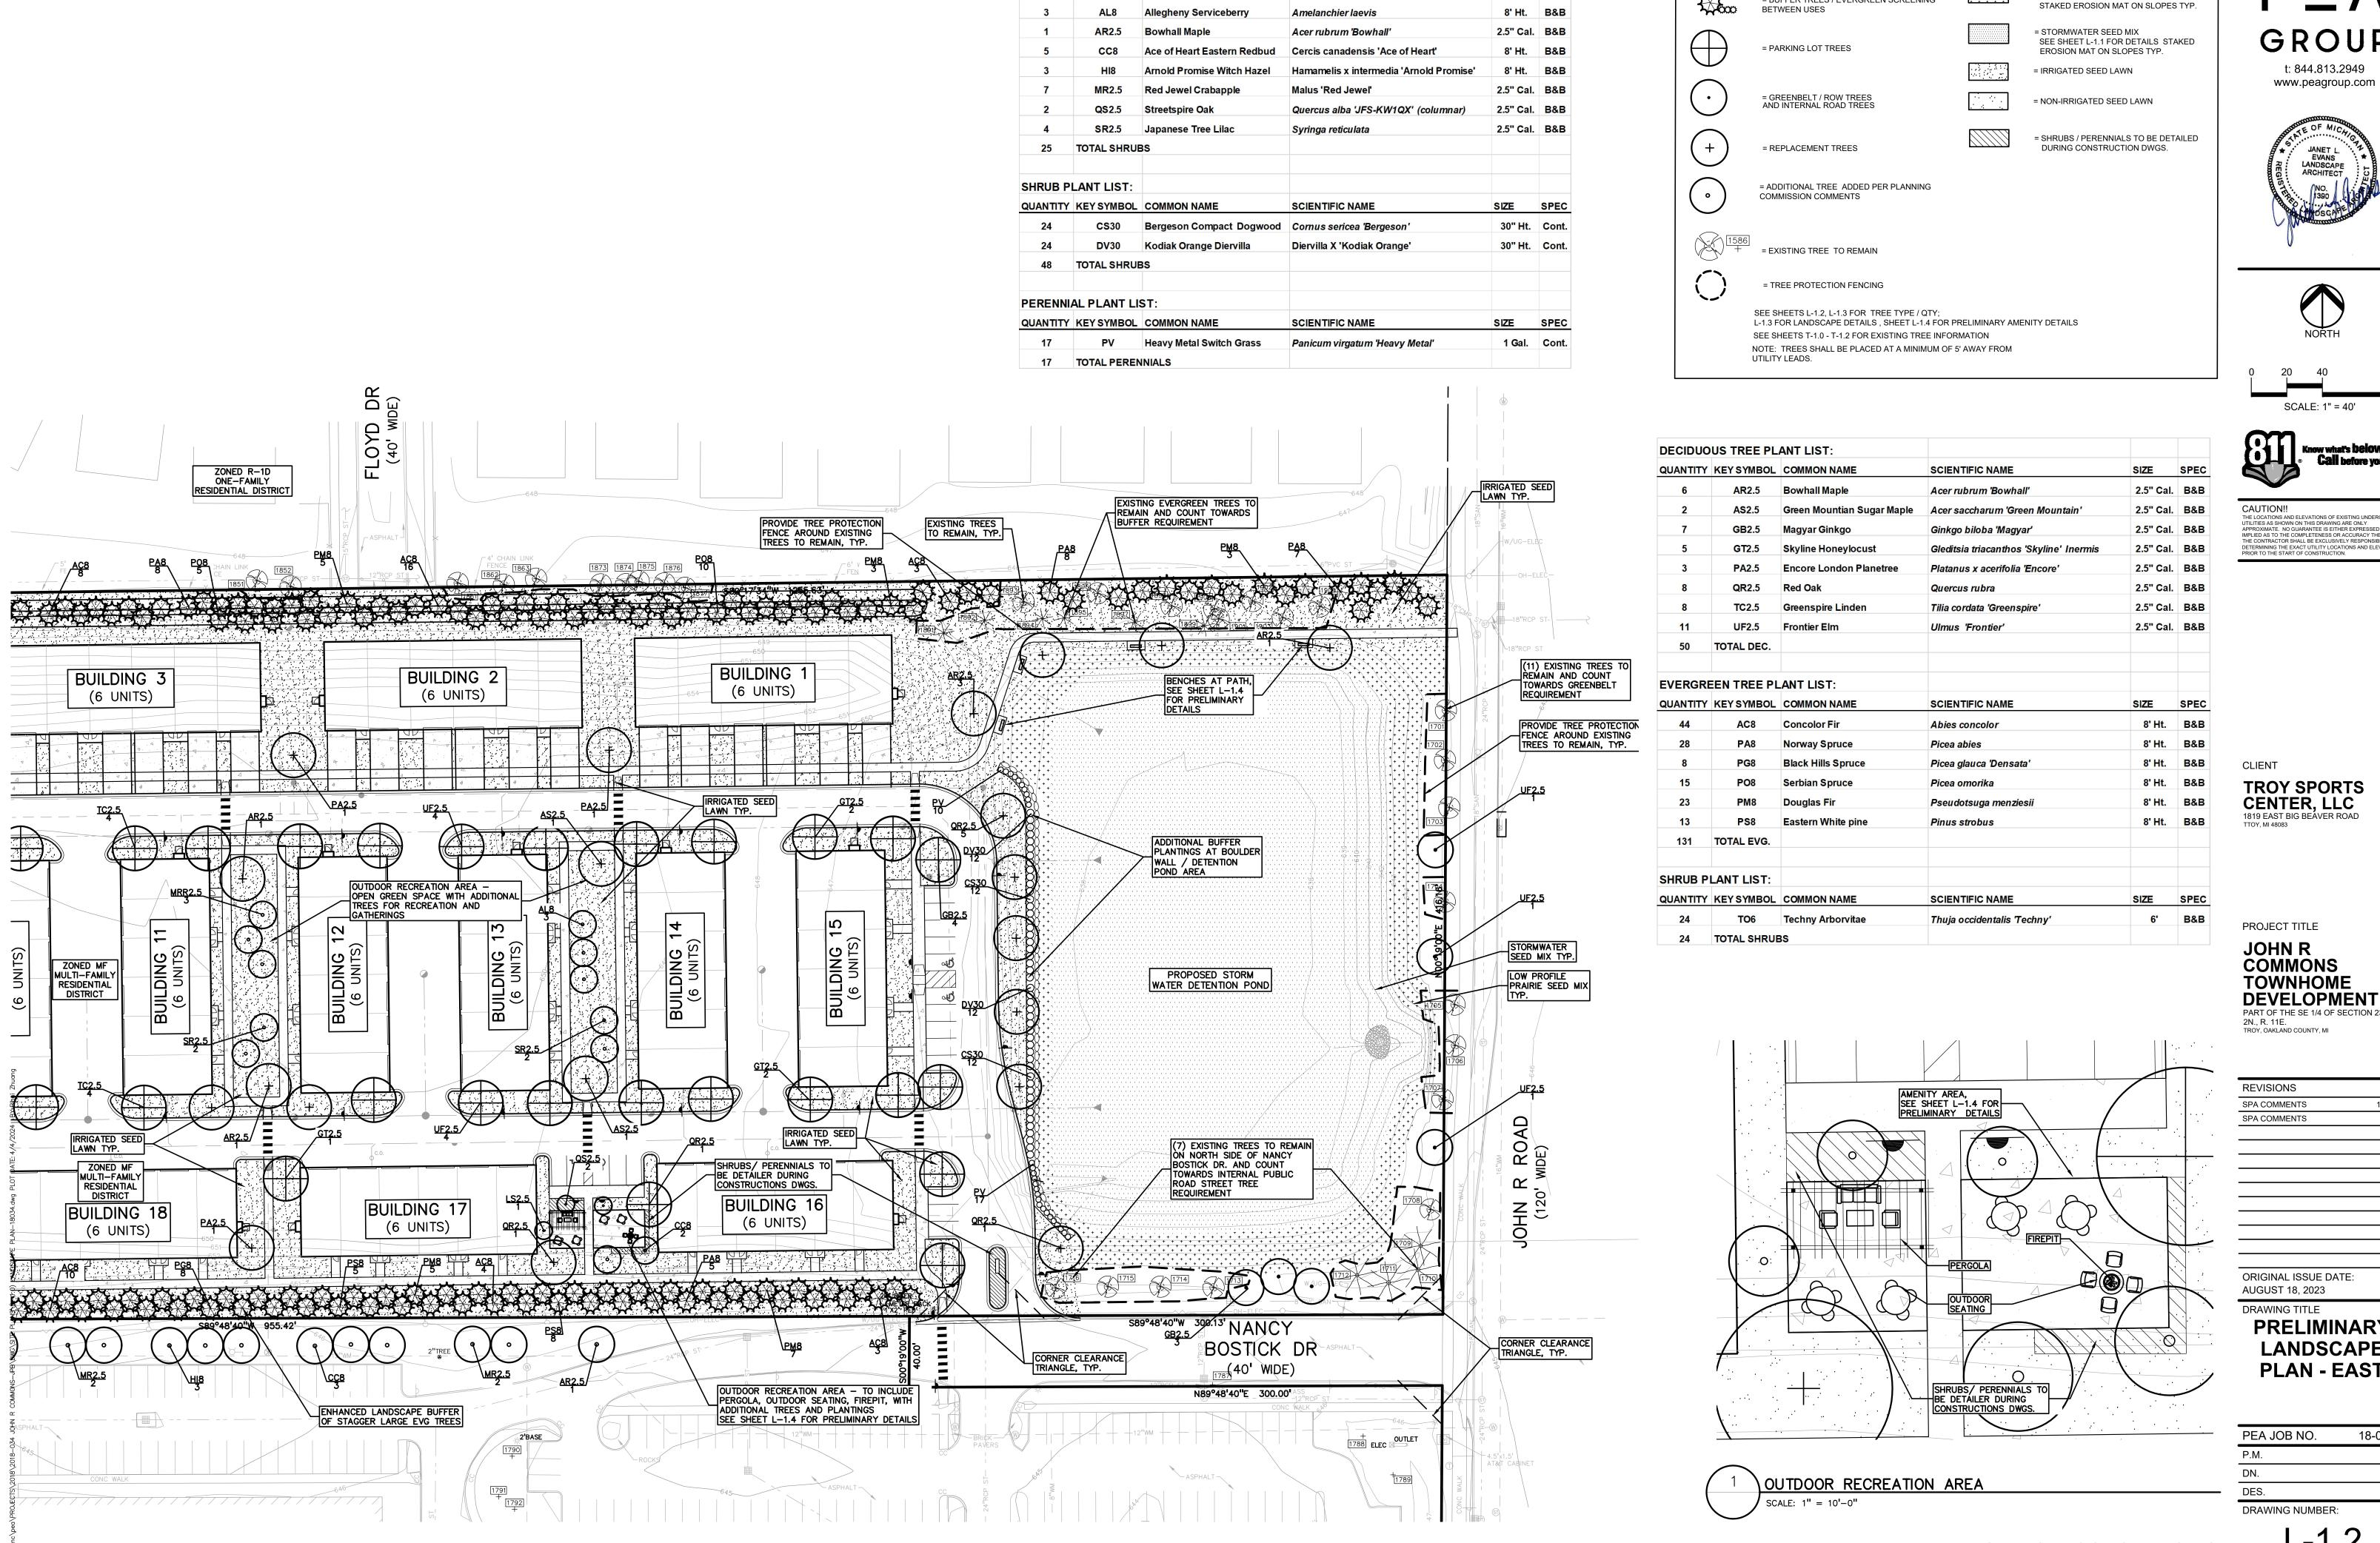

ADDITIONAL PLANTING PLANT LIST

DECIDUOUS TREE PLANT LIST:

QUANTITY KEYSYMBOL COMMON NAME


SCIENTIFIC NAME


=LOW PROFILE PRAIRIE SEED MIX SEE SHEET L-1.1 FOR DETAILS

KEY:

= BUFFER TREES / EVERGREEN SCREENING

SIZE SPEC

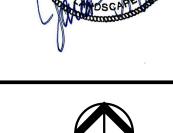

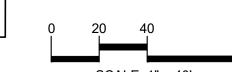



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DEVELOPMENT PART OF THE SE 1/4 OF SECTION 23, 7


11/8/23

3/1/24

ORIGINAL ISSUE DATE:

PRELIMINARY LANDSCAPE PLAN - EAST

PEA JOB NO.	18-0034
P.M.	GMB
DN.	BZZ
DES.	JLE
DRAWING NUMBER:	

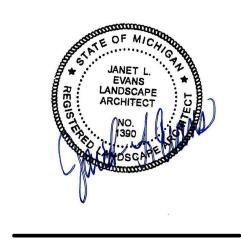

PLANT SO THAT TOP OF ROOT BALL IS FLUSH TO GRADE OR 1-2" HIGHER IF IN POORLY DRAINED SOILS DO NOT COVER TOP OF ROOTBALL WITH SOIL FORM SAUCER WITH 4" HIGH CONTINUOUS RIM SHREDDED HARDWOOD BARK MULCH 3" DEEP AND LEAVE 3" CIRCLE OF BARE SOIL AROUND TRUNK. DO NOT PLACE MULCH IN CONTACT WITH TRUNK - FINISH GRADE SPECIFIED PLANTING MIX. WATER AND TAMP TO REMOVE AIR POCKETS REMOVE ALL BURLAP FROM TOP 1 OF -ROOTBALL. DISCARD ALL NON-BIODEGRADABLE MATERIAL OFF SITE VARIES ON CONTAINER OR BALL SIZE PLACE ROOTBALL ON UNEXCAVATED OR

SHRUB PLANTING DETAIL SCALE: 1'' = 2'-0''



CAUTION!! THE LOCATIONS AND ELEVATIONS OF EXISTING UNDERGROUND UTILITIES AS SHOWN ON THIS DRAWING ARE ONLY APPROXIMATE. NO GUARANTEE IS EITHER EXPRESSED OR IMPLIED AS TO THE COMPLETENESS OR ACCURACY THEREOF. THE CONTRACTOR SHALL BE EXCLUSIVELY RESPONSIBLE FOR DETERMINING THE EXACT UTILITY LOCATIONS AND ELEVATIONS PRIOR TO THE START OF CONSTRUCTION.

PLANT SO THAT THE TREE'S ROOT FLARE (TRUNK FLARE) IS FLUSH WITH GRADE OR 1-2" HIGHER IN POORLY DRAIN SOIL. STAKE JUST BELOW BRANCHES WITH 2"-3" STAKING/GUYING WIDE NYLON OR PLASTIC STRAPS. CONNECT LOCATION FROM TREE TO STAKE AND ALLOW FOR FLEXIBILITY. REMOVE AFTER (1) ONE YEAR. (DO NOT USE WIRE & HOSE) THREE 2"X2" HARDWOOD STAKES OR STEEL T-POSTS DRIVEN A MIN. OF 18" DEEP FIRMLY INTO SUBGRADE PRIOR TO BACKFILLING SHREDDED HARDWOOD BARK MULCH TO DRIPLINE. 3" DEEP AND LEAVE 3" CIRCLE OF CLIENT BARE SOIL AROUND TREE TRUNK. DO NOT PLACE MULCH IN CONTACT WITH TREE TRUNK. FORM SAUCER WITH 4" HIGH CONTINUOUS RIM -FINISH GRADE SPECIFIED PLANTING MIX, WATER & TAMP TO - REMOVE AIR POCKETS, ÁMEND SOIL PER SITE CONDITIONS & TREE REQUIREMENTS EXPOSE ROOT FLARE OF TREE. CONTRACTOR MAY HAVE TO REMOVE EXCESS SOIL FROM TOP OF ROOTBALL. REMOVE ALL BURLAP FROM TOP 1 OF ROOTBALL. DISCARD ALL MIN. TYP. NON-BIODEGRADABLE MATERIAL OFF SITE

EVERGREEN TREE PLANTING DETAIL

DECIDUOUS TREE PLANTING DETAIL

SCALE: 1'' = 3'-0''

SCALE: 1'' = 3'-0''

PROJECT TITLE JOHN R

COMMONS **TOWNHOME DEVELOPMENT** PART OF THE SE 1/4 OF SECTION 23, 2N., R. 11E.

11/8/23

3/1/24

5/3/24

TROY, OAKLAND COUNTY, MI

REVISIONS

SPA COMMENTS

SPA COMMENTS

SPA/PC COMMENTS

TROY SPORTS

CENTER, LLC

PLANT SO THAT THE TREE'S ROOT FLARE (TRUNK FLARE) IS FLUSH WITH GRADE OR 1-2" HIGHER IN POORLY DRAIN SOIL. SECURE TREE WRAP WITH BIODEGRADABLE MATERIAL AT TOP & BOTTOM, REMOVE AFTER FIRST WINTER DO NOT PRUNE TERMINAL LEADER PRUNE ONLY DEAD, BROKEN BRANCHES AS DIRECTED BY LANDSCAPE ARCHITECT STAKE JUST BELOW BRANCHES WITH 2"-3" WIDE NYLON OR PLASTIC STRAPS. CONNECT FROM TREE TO STAKE AND ALLOW FOR FLEXIBILITY. REMOVE AFTER (1) ONE YEAR. (DO NOT USE WIRE & HOSE) (3) THREE 2"X2" HARDWOOD STAKES DRIVEN A MIN. OF 18" DEEP FIRMLY INTO SUBGRADE PRIOR TO BACKFILLING SHREDDED HARDWOOD BARK MULCH TO 120° DRIPLINE. 3" DEEP AND LEAVE 3" CIRCLE OF BARE SOIL AROUND TREE TRUNK. DO NOT STAKING/GUYING PLACE MULCH IN CONTACT WITH TREE <u>LOCATION</u> TRUNK. FORM SAUCER WITH 4" HIGH CONTINUOUS RIM SPECIFIED PLANTING MIX, WATER & TAMP TO - REMOVE AIR POCKETS, AMEND SOIL PER SITE CONDITIONS & TREE REQUIREMENTS -FINISH GRADE EXPOSE ROOT FLARE OF TREE. CONTRACTOR

ORIGINAL ISSUE DATE: AUGUST 18, 2023 DRAWING TITLE

> **LANDSCAPE DETAILS**

PEA JOB NO. 18-0034 P.M. GMB DN. BGG DES. JLE

SPECIES SEE PLAN FOR QUANTITY PLANT PERENNIALS EQUAL DISTANCE IN ALL DIRECTIONS ALL SPACING IS TO BE TRIANGULAR UNLESS NOTED OR GRAPHICALLY SHOWN OTHERWISE PLAN VIEW 3" SHREDDED BARK MULCH. DO NOT PILE MULCH AGAINST PLANT STEMS SHOVEL CUT EDGE OR ALUMINUM EDGING AS INDICATED ON PLAN - SPECIFIED PLANTING MIX NOTE: REMOVE ALL CONTAINERS PRIOR TO PLANTING SECTION VIEW PERENNIAL PLANTING DETAIL SCALE: 1'' = 2'-0''

VARIES PER SPECIES SEE PLAN FOR QUANTITY

ACCESS DOORS NOT BLOCKED BY PLANTINGS, - SHIFT PLANTS AS NECESSARY TO MAINTAIN CLEARANCE (TYP.) 2-3" DIAMETER RIVER -ROCK AT 5" DEPTH OVER WEED FABRIC TRANSFORMER SEE PLAN FOR EXACT PLANT - LAYOUT, TYPE AND QTY. FOR ACCESS REFERENCE ONLY

TRANSFORMER SCREENING DETAIL

ALUMINUM EDGE DETAIL

SCALE: 1/2'' = 1'-0''

stantec.com/native-plant-nursery Botanical Name

Common Name Permanent Grasses: Side Oats Grama Bouteloua curtipendula Carex spp. Prairie Carex Mix Canada Wild Rye Elymus canadensis Koeleria pyramidata June Grass Switch Grass Panicum virgatum Schizachyrium scoparium Little Bluestem Temporary Cover: Avena sativa Common Oat

Lolium multiflorum Annual Rye

FOR ALL SEED MIXES, PROVIDE EROSION MAT ON SLOPES AND AREAS OF WASH OUT TYP.

Stantec Native Plant Nursery 574-586-2412

NO INVASIVE SPECIES PERMITTED, USE ONLY SPECIES NATIVE TO COUNTY.

Low-profile Prairie Seed Mix

INSTALL AND PREP PER MANUFACTURES SPECIFICATIONS.

Asclepias syriaca

Baptisia alba

Dalea candida

Dalea purpurea

Botanical Name Permanent Grasses/Sedges/Rushes: Bolboschoenus fluviatilis River Bulrush Carex cristatella Carex lurida Carex vulpinoidea Elymus virginicus Glyceria striata Juncus effusus Leersia oryzoides Panicum virgatum Switch Grass Schoenoplectus tabernaemontani Scirpus atrovirens Wool Grass

Scirpus cyperinus Temporary Cover: Avena sativa Lolium multiflorum Forbs & Shrubs: Alisma spp.

Stormwater Seed Mix

Stantec Native Plant Nursery 574-586-2412

stantec.com/native-plant-nursery

Asclepias incarnata Bidens spp. Helenium autumnale Iris virginica Lvcopus americanus Mimulus ringens Oligoneuron riddellii Penthorum sedoides Polygonum spp. Rudbeckia subtomentosa Rudbeckia triloba Sagittaria latifolia Senna hebecarpa Symphyotrichum novae-angliae Thalictrum dasycarpum

Common Name Crested Oval Sedge Bottlebrush Sedge Brown Fox Sedge Virginia Wild Rye Fowl Manna Grass Common Rush Rice Cut Grass Softstem Bulrush Dark Green Rush

Liatris aspera Common Oat Lupinus perennis Annual Rye Monarda fistulosa Oligoneuron rigidum Water Plantain (Various Mix) Penstemon digitalis Swamp Milkweed Penstemon hirsutus Bidens (Various Mix) Sneezeweed Blue Flag Ratibida pinnata Common Water Horehound Rudbeckia hirta Monkey Flower Rudbeckia subtomentosa Riddell's Goldenrod Silphium terebinthinaceum Ditch Stonecrop Solidago speciosa Pinkweed (Various Mix) Symphyotrichum ericoides Sweet Black-Eyed Susan Symphyotrichum laeve Brown-Eyed Susan Common Arrowhead Tradescantia ohiensis Wild Senna Verbena stricta New England Aster Vernonia spp. Purple Meadow Rue Veronicastrum virginicum

Lead Plant Amorpha canescens Anemone cylindrica ThimbleWeed Common Milkweed Butterfly MilkWeed Asclepias tuberosa White Wild Indigo Chamaecrista fasciculata Partridge Pea Coreopsis lanceolata Sand Coreopsis Coreopsis palmata Prairie Coreopsis White Prairie Clover Purple Prairie Clover Desmanthus illinoensis Illinois Sensitive Plant Echinacea purpurea Eryngium yuccifolium Rattlesnake Master Round-Head Bush Clover Lespedeza capitata Rough Blazing Star Wild Lupine Wild Bergamot Stiff Goldenrod Parthenium integrifolium Wild Quinine Foxglove Beard Tongue Hairy Beard Tongue Pycnanthemum virginianum Common Mountain Mint

Broad-Leaved Purple Coneflower Yellow Coneflower Black-Eyed Susan Sweet Black-Eyed Susan Prairie Dock Showy Goldenrod Heath Aster Smooth Blue Aster Symphyotrichum novae-angliae New England Aster Common Spiderwort Hoary Vervain

Ironweed (Various Mix)

Culvers Root

SOIL DEPOSITS WITHIN DRIP LINES GRADE CHANGES MAY NOT OCCUR WITHIN THE DRIP LINE OF PROTECTED TREES DURING CONSTRUCTION, NO PERSON SHALL ATTACH ANY DEVICE OR WIRE TO ANY REMAINING TREE ALL UTILITY SERVICE REQUESTS MUST INCLUDE NOTIFICATION TO THE INSTALLER THAT PROTECTED OCCUR OUTSIDE OF THE PROTECTIVE FENCING BE AFFECTED BY CONSTRUCTION ACTIVITIES MUST BE FLAGGING PRIOR TO THE TREE CLEARING PROVIDE FENCE AROUND CRITICAL ROOT ZONE OF FENCE SHALL BE PLACED IN A CIRCLE WITH A MINIMUM RADIUS OF 1' PER 1" DIAMETER OF THE TREE MEASURED AT 4.5' ABOVE GROUND

> 4'HIGH PROTECTIVE FENCING WITH STEEL POSTS - 10' O.C.

TREE PROTECTION WILL BE ERECTED PRIOR TO

START OF CONSTRUCTION ACTIVITIES AND SHALL

REMAIN IN PLACE UNTIL CONSTRUCTION IS COMPLETE

NO PERSON MAY CONDUCT ANY ACTIVITY WITHIN THE

INCLUDING, BUT NOT LIMITED TO PLACING SOLVENTS,

BUILDING MATERIAL, CONSTRUCTION EQUIPMENT OR


TREES MUST BE AVOIDED. ALL TRENCHING SHALL

TREES LOCATED ON ADJACENT PROPERTY THAT MAY

TREES TO BE PRESERVED SHALL BE IDENTIFIED WITH

DRIP LINE OF ANY TREE DESIGNATED TO REMAIN;

TREE PROTECTION DETAIL SCALE: 1'' = 3'-0''

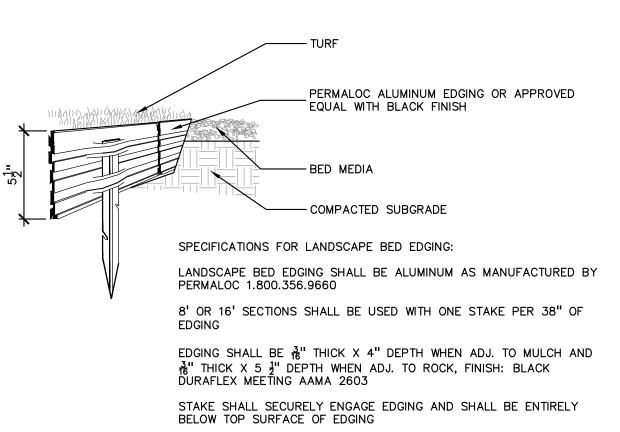

EDGING SHALL HAVE A MINIMUM OF 2" OF INTERLOCKING OVERLAP BETWEEN SECTIONS INSTALL AS PER MANUFACTURER'S SPECIFICATIONS WITH TOP OF

EDGING $\frac{1}{4}$ "- $\frac{1}{2}$ " ABOVE COMPACTED FINISH GRADE. FINISH GRADE TO BE COMPACTED ON BOTH SIDES OF EDGING TO MAINTAIN STABILITY

NOT FOR CONSTRUCTION

MAY HAVE TO REMOVE EXCESS SOIL FROM

- TOP OF ROOTBALL. REMOVE ALL BURLAP

FROM TOP 1 OF ROOTBALL. DISCARD ALL

NON-BIODEGRADABLE MATERIAL OFF SITE

PLACE ROOTBALL ON UNEXCAVATED OR

PLACE ROOTBALL ON UNEXCAVATED OR

DRAWING NUMBER:

PERGOLA: 14X16 MODERN FIBERGLASS PERGOLA WITH CUSTOM OVERHANG BY: PERGOLA KITS USA PHONE: 800-403-9259 COLOR: FRAME IN SHERWIN WILLIAMS PEPPERCORN COLOR, LOUVERED RAFTERS IN SHERWIN WILLIAMS BRANDY WIND COLOR. OWNER TO SELECT/APPROVE COLOR QUANTITY: X QTY. TO BE APPROVED BY OWNER



BY: FORMS+SURFACES PHONE: 412-781-9003 COLOR: OWNER TO SELECT/APPROVE COLOR FINISH: SANDSTONE, DIAMOND, SATIN. OWNER TO SELECT/APPROVE FINISH QUANTITY: X QTY. TO BE APPROVED BY OWNER

TABLE: CAROUSEL WITH 3 OR 4 SEATS. SEATS ARE AVAILABLE BACKLESS, BACKED OR HOOP

COLOR: OWNER TO SELECT/APPROVE COLOR

TABLE TOP: OWNER TO SELECT/APPROVE TABLE

QUANTITY: X, QTY. TO BE APPROVED BY OWNER

TABLE: COLUMN TABLE

BY: LANDSCAPE FORMS PHONE: 800-430-6209

TOP MATERIAL



LITTER CONTAINER: PLAINWELL, ALUMINUM

COLOR: TITANIUM OR SILVER, POWDER COATED,


QUANTITY: X, QTY. TO BE APPROVED BY OWNER

ITTER IMAGE DETAIL OPTIONS

OWNER TO SELECT/APPROVE COLOR

PHONE: 800-521-2546

NOT TO SCALE

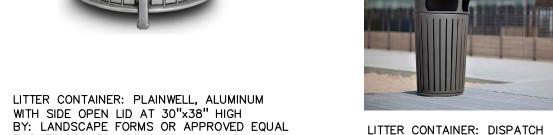

BY: FORMS+SURFACES
PHONE: 412-781-9003 COLOR: OWNER TO SELECT/APPROVE COLOR QUANTITY: X, QTY. TO BE APPROVED BY OWNER

LITTER CONTAINER: TONYO BY: FORMS+SURFACES

COLOR: OWNER TO SELECT/APPROVE COLOR QUANTITY: X, QTY. TO BE APPROVED BY OWNER

PHONE: 412-781-9003



PΞΛ

GROUP

t: 844.813.2949 www.peagroup.com

CAUTION!!






PERGOLA: PREMIUM VINYL PAVILION, TRADITIONAL ROOF BY: PERGOLA KITS USA PHONE: 800-403-9259 COLOR: OWNER TO SELECT/APPROVE COLOR QUANTITY: X, QTY. TO BE APPROVED BY OWNER



TABLE SET IMAGE DETAIL OPTIONS

NOT TO SCALE

FIRE PIT INSERT: RECTANGLE H 54"X16" NATURAL GAS FIRE PIT INSERT WITH REMOTE ELECTRONIC IGNITION CONTROL COVER: HPHC-54X16SS BY: HPC PHONE: 877-585-9800 QUANTITY: X, QTY. TO BE APPROVED BY

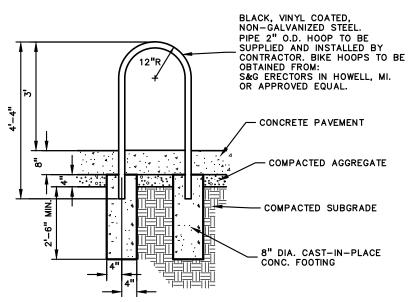

6' O.C. Nom.

CLIENT TROY SPORTS CENTER, LLC 1819 EAST BIG BEAVER ROAD

PROJECT TITLE

JOHN R

COMMONS TOWNHOME DEVELOPMENT

11/8/23

3/1/24

BIKE RACK DETAIL



PERGOLA IMAGE DETAIL OPTIONS

NOT TO SCALE

PERGOLA: SERENITY CEDAR PERGOLA KIT BY: PERGOLA KITS USA PHONE: 800-403-9259


COLOR: MAPLE, RUSTIC CEDAR, CEDAR, MAHOGANY, CINDER, WALNUT. OWNER TO SELECT/APPROVE COLOR QUANTITY: X, QTY. TO BE APPROVED BY OWNER







BENCH: TRIO BENCH BY: FORMS+SURFACES PHONE: 412-781-9003 COLOR: ALUMINUM, POWDER COATED, OWNER TO SELECT/APPROVE COLOR QUANTITY: X QTY. TO BE APPROVED BY OWNER

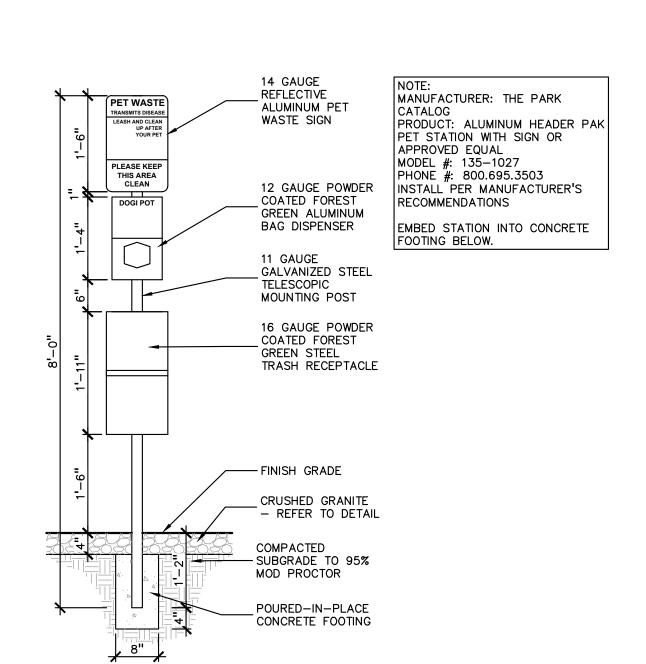

PET STATION DETAIL, OR EQUAL

SCALE: $1 \frac{1}{2}$ " = 1'-0"

ORNAMENTAL FENCE @ DOG PARK NOT TO SCALE

PART OF THE SE 1/4 OF SECTION 23, T 2N., R. 11E. TROY, OAKLAND COUNTY, MI REVISIONS SPA COMMENTS SPA COMMENTS ORIGINAL ISSUE DATE: AUGUST 18, 2023 DRAWING TITLE SITE AMENITY

> **DETAILS** PEA JOB NO. 18-0034


P.M. ΒZ DN. DES. JLE DRAWING NUMBER:







BENCH: 72" PLAINWELL, ALUMINUM BY: LANDSCAPE FORMS OR APPROVED EQUAL PHONE: 800-521-2546 COLOR: TITANIUM OR SILVER, POWDER COATED, OWNER TO SELECT/APPROVE COLOR QUANTITY: X, QTY. TO BE APPROVED BY OWNER

BENCH IMAGE DETAIL OPTIONS NOT TO SCALE

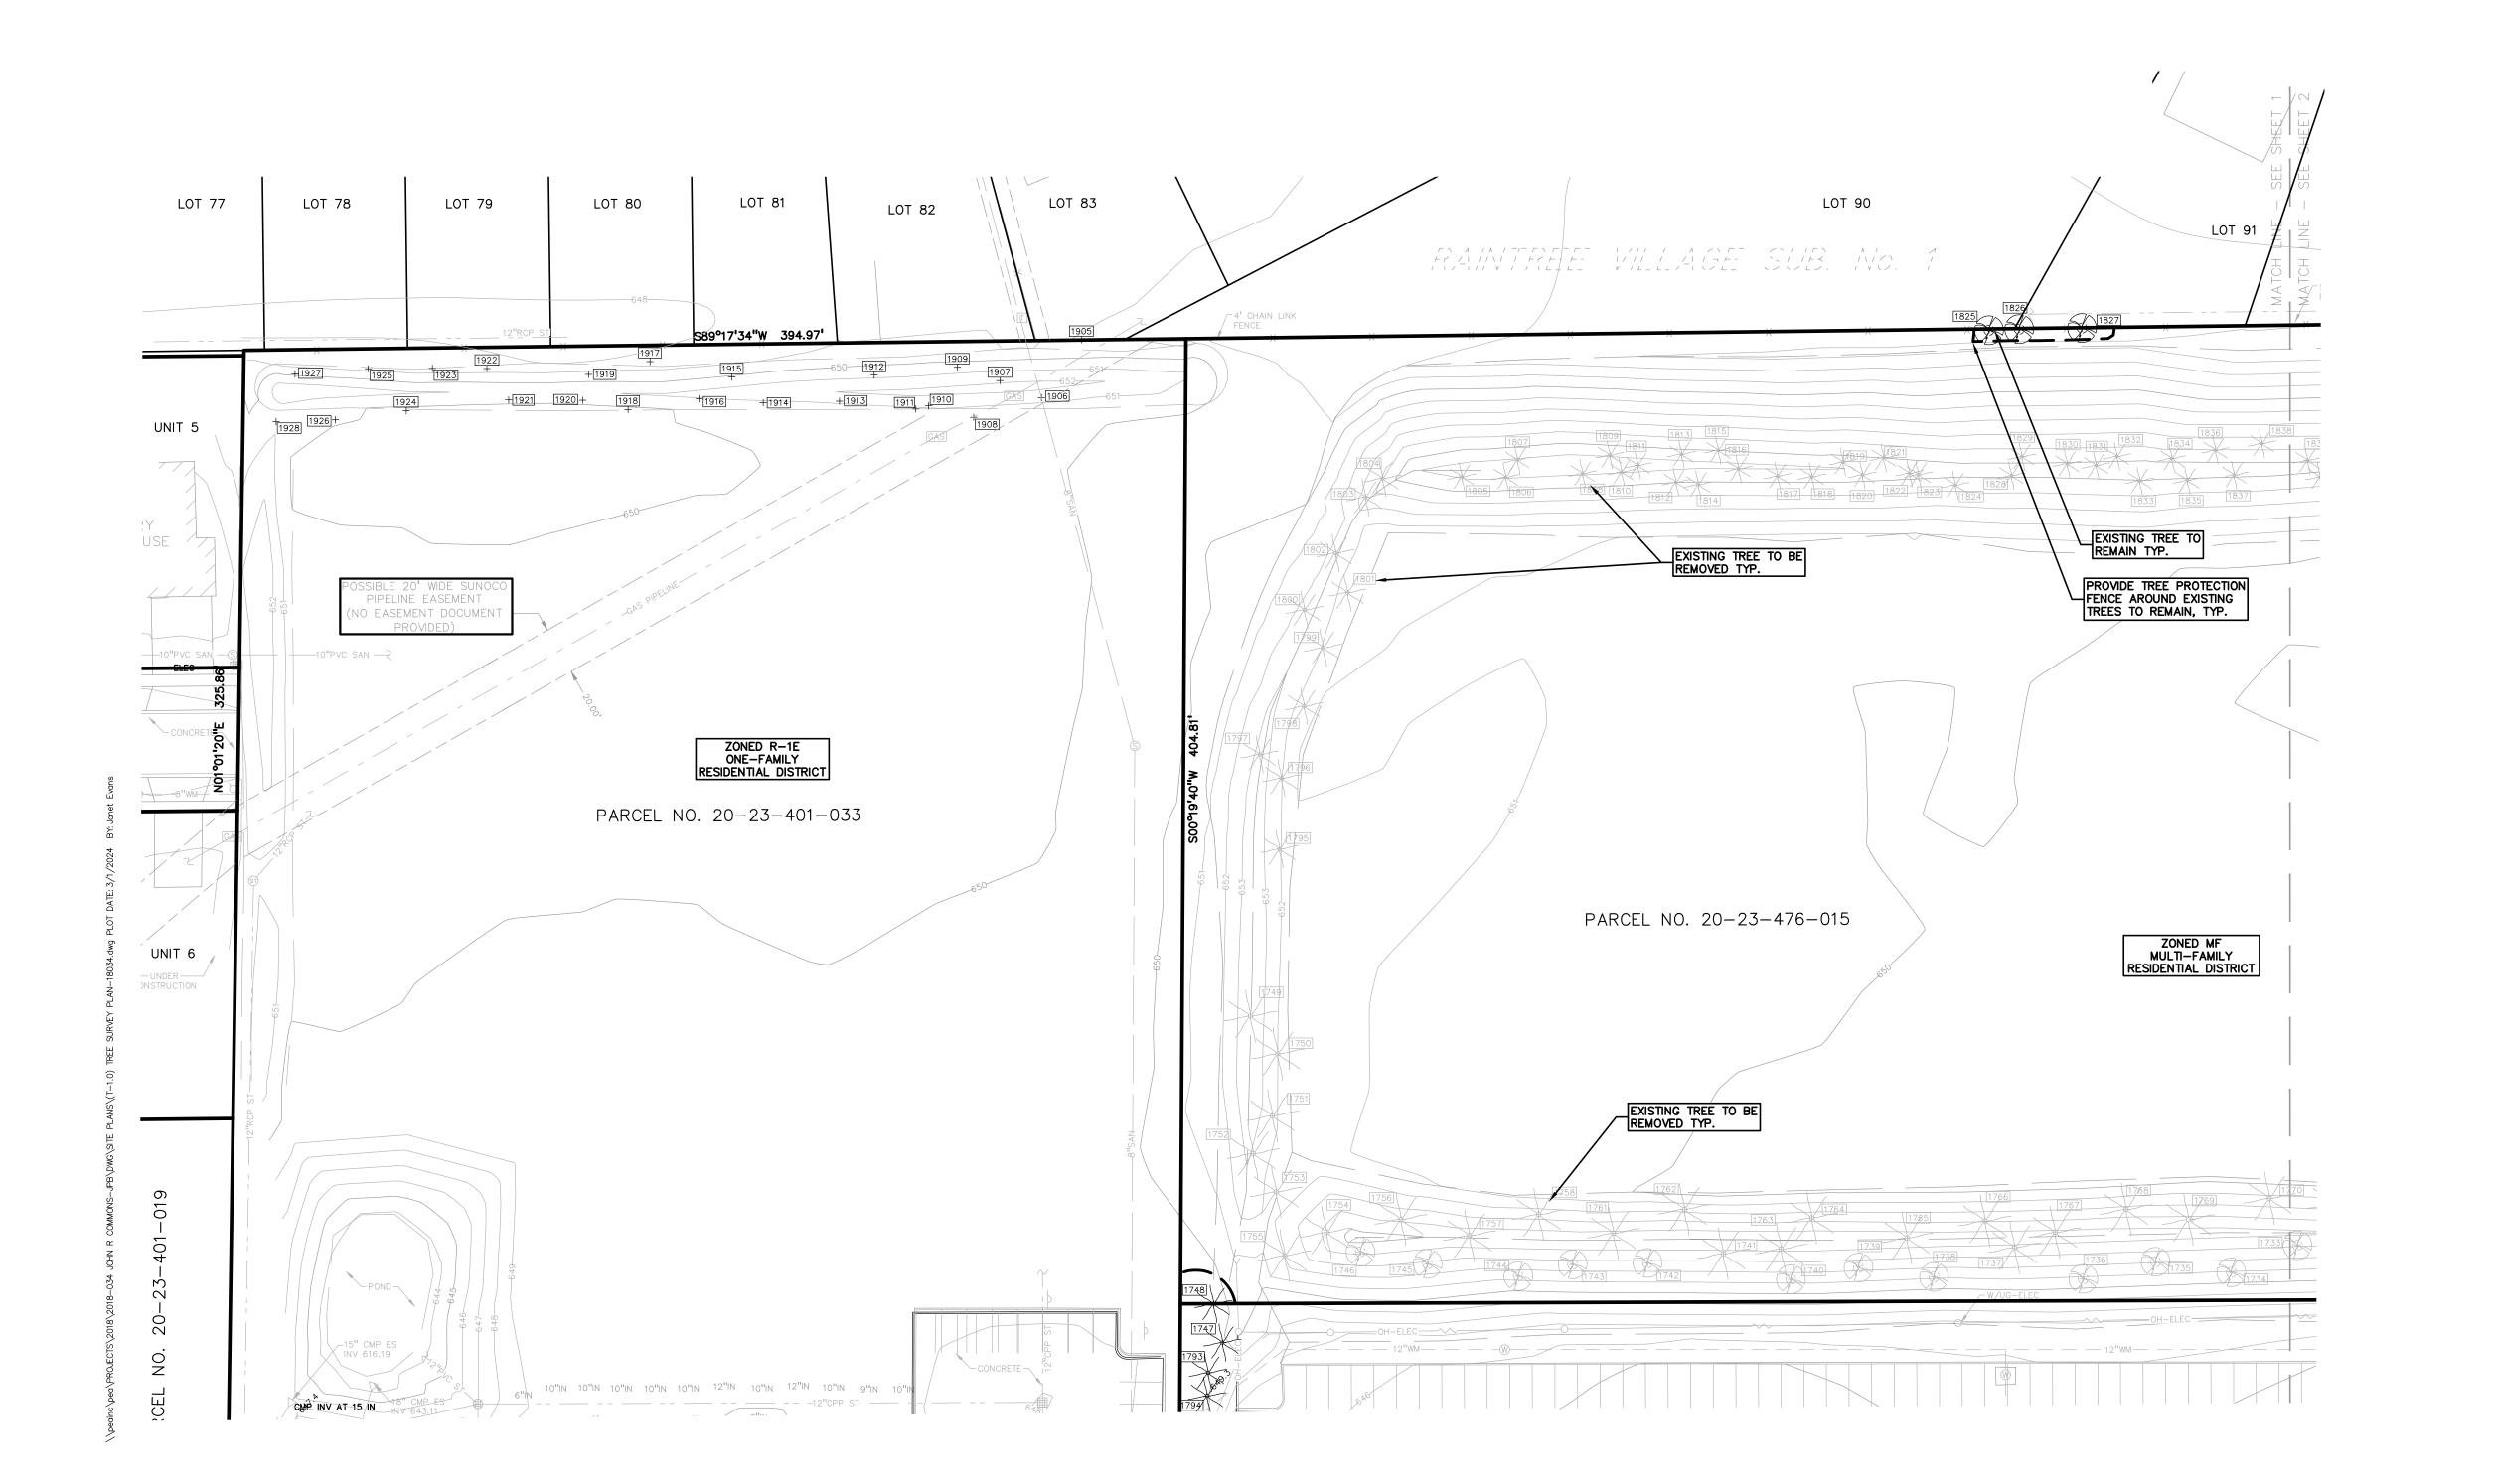

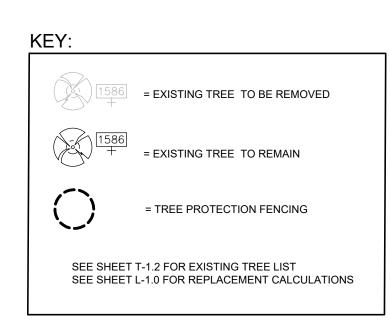



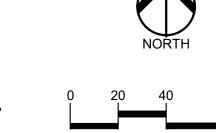

TREE PROTECTION WILL BE ERECTED PRIOR TO START OF CONSTRUCTION ACTIVITIES AND SHALL REMAIN IN PLACE UNTIL CONSTRUCTION IS COMPLETE. NO PERSON MAY CONDUCT ANY ACTIVITY WITHIN THE DRIP LINE OF ANY TREE DESIGNATED TO REMAIN; INCLUDING, BUT NOT LIMITED TO PLACING SOLVENTS, BUILDING MATERIAL, CONSTRUCTION EQUIPMENT OR SOIL DEPOSITS WITHIN DRIP LINES. SCALE: 1" = 40' GRADE CHANGES MAY NOT OCCUR WITHIN THE DRIP LINE OF PROTECTED TREES.

DURING CONSTRUCTION, NO PERSON SHALL ATTACH ANY DEVICE OR WIRE TO ANY REMAINING TREE. ALL UTILITY SERVICE REQUESTS MUST INCLUDE NOTIFICATION TO THE INSTALLER THAT PROTECTED TREES MUST BE AVOIDED. ALL TRENCHING SHALL OCCUR OUTSIDE OF THE PROTECTIVE FENCING. TREES LOCATED ON ADJACENT PROPERTY THAT MAY BE AFFECTED BY CONSTRUCTION ACTIVITIES MUST BE PROTECTED. CAUTION!! THE LOCATIONS AND ELEVATIONS OF EXISTING UNDERGROUND UTILITIES AS SHOWN ON THIS DRAWING ARE ONLY APPROXIMATE. NO GUARANTEE IS EITHER EXPRESSED OR IMPLIED AS TO THE COMPLETENESS OR ACCURACY THEREOF. THE CONTRACTOR SHALL BE EXCLUSIVELY RESPONSIBLE FOR DETERMINING THE EXACT UTILITY LOCATIONS AND ELEVATIONS PRIOR TO THE START OF CONSTRUCTION.

TREES TO BE PRESERVED SHALL BE IDENTIFIED WITH FLAGGING PRIOR TO THE TREE CLEARING OPERATIONS. PROVIDE FENCE AROUND CRITICAL ROOT ZONE OF TREE. FENCE SHALL BE PLACED IN A CIRCLE WITH A RADIUS OF 1' PER 1" DIAMETER OF THE TREE MEASURED AT 4.5' ABOVE GROUND. - 4' HIGH PROTECTIVE FENCING WITH STEEL POSTS - 10' O.C.

TREE PROTECTION DETAIL

CLIENT

TROY SPORTS CENTER, LLC 1819 EAST BIG BEAVER ROAD TTOY, MI 48083

PROJECT TITLE


JOHN R
COMMONS
TOWNHOME
DEVELOPMENT
PART OF THE SE 1/4 OF SECTION 23, T.
2N., R. 11E.
TROY, OAKLAND COUNTY, MI


,	
REVISIONS	
SPA COMMENTS	11/8/23
SPA COMMENTS	3/1/24

ORIGINAL ISSUE DATE: AUGUST 18, 2023 DRAWING TITLE


TREE SURVEY PLAN - WEST


PEA JOB NO.	18-0034
P.M.	GME
DN.	BGG
DES.	JLE
DRAWING NUMBER:	

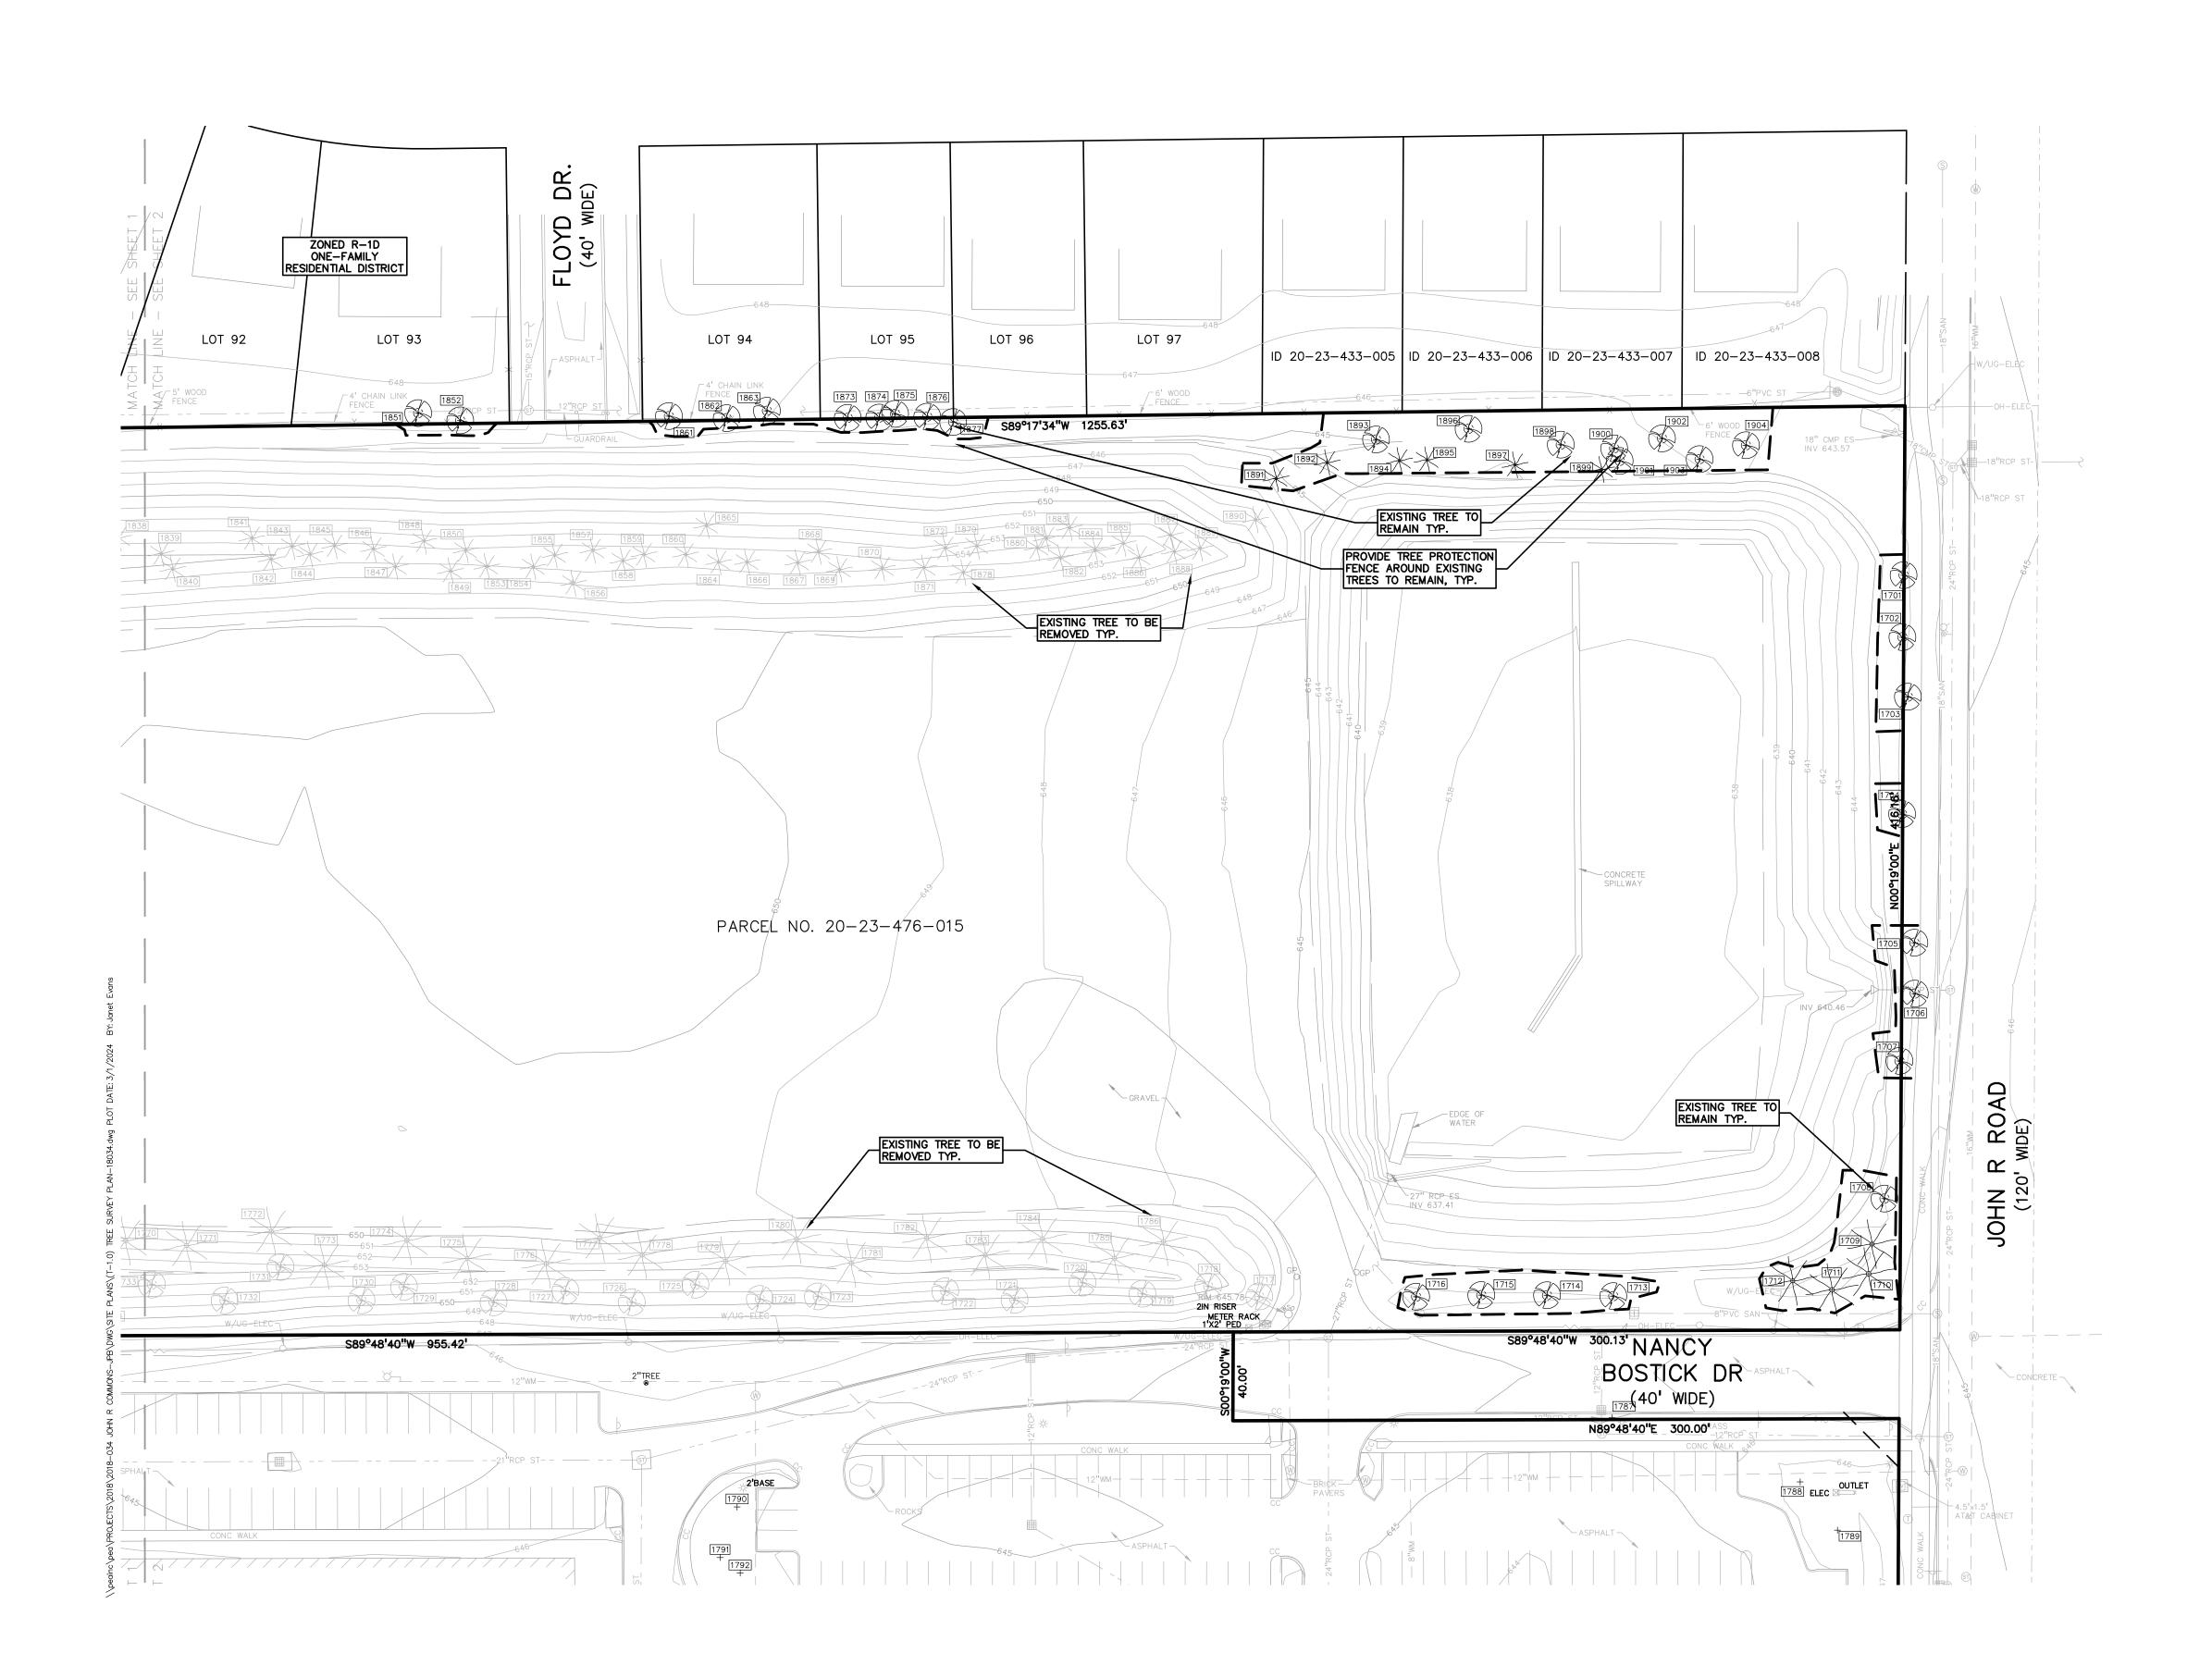

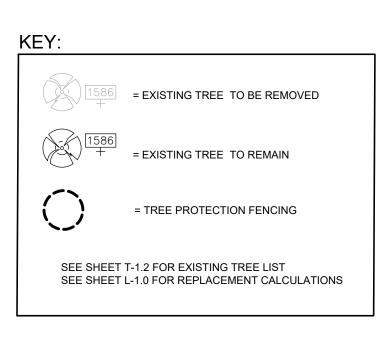



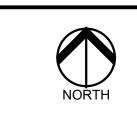

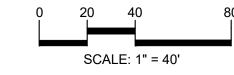



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TROY SPORTS CENTER, LLC 1819 EAST BIG BEAVER ROAD TTOY, MI 48083

PROJECT TITLE

JOHN R
COMMONS
TOWNHOME
DEVELOPMENT
PART OF THE SE 1/4 OF SECTION 23, T.
2N., R. 11E.
TROY, OAKLAND COUNTY, MI

REVISIONS

SPA COMMENTS 11/8/23

SPA COMMENTS 3/1/24

ORIGINAL ISSUE DATE: AUGUST 18, 2023 DRAWING TITLE

TREE SURVEY PLAN - EAST

PEA JOB NO.	18-0034
P.M.	GME
DN.	BGG
DES.	JLE
DRAWING NUMBER:	

G NO.	BP BP	DBH 15	COMMON NAME Bradford Pear	Pyrus calleryanna	COND Fair	COMMENTCLASSINVASIVE	S	ON-SITE]- \]-
702 703	BP BP	13 15	Bradford Pear Bradford Pear	Pyrus calleryanna Pyrus calleryanna	Fair Fair	INVASIVE	S S	Y N]-
'04	BP	15	Bradford Pear	Pyrus calleryanna	Fair	INVASIVE INVASIVE	S	Y	<u>[</u>
705 706	BP BP	14 14	Bradford Pear Bradford Pear	Pyrus calleryanna Pyrus calleryanna	Fair Poor	INVASIVE INVASIVE	S S	N N	<u> </u> -
'07 '08	BP WS	11 8	Bradford Pear White Spruce	Pyrus calleryanna Picea glauca	Fair Poor	INVASIVE	S	Y]-
709	BS	10	Blue Spruce	Picea gladca Picea pungens	Fair	WOODLAND WOODLAND	S S	Y	<u>-</u>
710 711	BS BS	9 12	Blue Spruce Blue Spruce	Picea pungens Picea pungens	Good Good	WOODLAND WOODLAND	S S	Y	<u> </u> -
712	WS	12	White Spruce	Picea glauca	Fair	WOODLAND	S	Y]-
713 714	G G	6	Ginkgo Ginkgo	Ginkgo biloba Ginkgo biloba	Good Good	WOODLAND WOODLAND	S S	Y	_ - -
715 716	G G	6 6	Ginkgo Ginkgo	Ginkgo biloba Ginkgo biloba	Good	WOODLAND	S	Y Y	1-
1716	SU	8	Sugar Maple	Acer saccharum	Poor	WOODLAND WOODLAND	S R	¥	<u> </u>
718 719	SU SU	10 10	Sugar Maple Sugar Maple	Acer saccharum Acer saccharum	Good Good	WOODLAND WOODLAND	R R	¥ ¥	REPLAC REPLAC
720	SU	6	Sugar Maple	Acer saccharum	Good	WOODLAND	R	¥	REPLAC
721 722	SU SU	9	Sugar Maple Sugar Maple	Acer saccharum Acer saccharum	Good Good	WOODLAND WOODLAND	R R	¥ ¥	REPLAC REPLAC
1 723	SU SU	6 8	Sugar Maple Sugar Maple	Acer saccharum Acer saccharum	Good Good	WOODLAND WOODLAND	R R	¥ ¥	REPLAC REPLAC
1725	SU	9	Sugar Maple	Acer saccharum	Good	WOODLAND	R	¥	REPLAC
1 726 1 727	SU SU	8 9	Sugar Maple Sugar Maple	Acer saccharum Acer saccharum	Good Good	WOODLAND WOODLAND	R R	¥ ¥	REPLAC REPLAC
1728 1729	SU SU	9 10	Sugar Maple Sugar Maple	Acer saccharum Acer saccharum	Good Good	WOODLAND	R	¥ ¥	REPLAC REPLAC
1730	SU	10	Sugar Maple	Acer saccharum	Good	WOODLAND WOODLAND	R R	¥	REPLAC
1731 1732	SU SU	10 8	Sugar Maple Sugar Maple	Acer saccharum Acer saccharum	Good Good	WOODLAND WOODLAND	R R	¥ ¥	REPLAC REPLAC
1733	SU	10	Sugar Maple	Acer saccharum	Good	WOODLAND	R	¥	REPLAC
1734 1735	SU SU	10 10	Sugar Maple Sugar Maple	Acer saccharum Acer saccharum	Good Good	WOODLAND WOODLAND	R R	¥ ¥	REPLAC REPLAC
1736 1737	SU SU	9	Sugar Maple Sugar Maple	Acer saccharum Acer saccharum	Good Good	WOODLAND WOODLAND	R R	¥ ¥	REPLAC REPLAC
1738	SU	9	Sugar Maple	Acer saccharum	Good	WOODLAND	R	¥	REPLAC
1739 1740	SU SU	9	Sugar Maple Sugar Maple	Acer saccharum Acer saccharum	Good Good	WOODLAND WOODLAND	R R	¥ ¥	REPLAC REPLAC
1741 1742	SU SU	9	Sugar Maple Sugar Maple	Acer saccharum Acer saccharum	Good Good	WOODLAND	R	¥ ¥	REPLAC REPLAC
1743	SU	10	Sugar Maple	Acer saccharum	Good	WOODLAND WOODLAND	R R	¥	REPLAC
1744 1745	SU SU	8 8	Sugar Maple Sugar Maple	Acer saccharum Acer saccharum	Good Good	WOODLAND WOODLAND	R R	¥ ¥	REPLAC REPLAC
1746	SU	8	Sugar Maple	Acer saccharum	Good	WOODLAND	R	¥	REPLAC
1747 1748	BS WS	11 11	Blue Spruce White Spruce	Picea pungens Picea glauca	Good Good	WOODLAND WOODLAND	S S	Y]-]-
1749 1750	WS WS	15 9	White Spruce White Spruce	Picea glauca Picea glauca	Fair Very Poor	WOODLAND WOODLAND	R R	¥ ¥	REPLAC
1751	BS	16	Blue Spruce	Picea pungens	Fair	WOODLAND	R	¥	REPLAC
1 752 1 753	BS BS	18 16	Blue Spruce Blue Spruce	Picea pungens Picea pungens	Fair Poor	LANDMARK WOODLAND	R R	¥ ¥	REPLAC -
1754 1755	BS WS	16 10	Blue Spruce White Spruce	Picea pungens Picea glauca	Good Fair	WOODLAND WOODLAND	R R	¥ ¥	REPLAC REPLAC
1756	BS	11	Blue Spruce	Picea pungens	Good	WOODLAND	R	¥	REPLAC
1757 1758	BS WS	12 14	Blue Spruce White Spruce	Picea pungens Picea glauca	Good Poor	WOODLAND WOODLAND	R R	<u>Ұ</u>	REPLAC -
1761 1762	WS WS	13 14	White Spruce White Spruce	Picea glauca	Fair	WOODLAND	R	¥	REPLAC
1763	BS	12	Blue Spruce	Picea glauca Picea pungens	Good Fair	WOODLAND WOODLAND	R R	¥ ¥	REPLAC REPLAC
1764 1765	BS BS	15 15	Blue Spruce Blue Spruce	Picea pungens Picea pungens	Good Good	WOODLAND WOODLAND	R R	¥ ¥	REPLAC REPLAC
1766	WS	10	White Spruce	Picea glauca	Poor	WOODLAND	R	¥	-
1767 1768	BS BS	11 15	Blue Spruce Blue Spruce	Picea pungens Picea pungens	Very Poor Fair	WOODLAND WOODLAND	R R	¥ ¥	- REPLAC
1769 1770	BS BS	12 12	Blue Spruce Blue Spruce	Picea pungens Picea pungens	Fair Fair	WOODLAND WOODLAND	R R	¥ ¥	REPLAC REPLAC
1771	BS	12	Blue Spruce	Picea pungens	Fair	WOODLAND	R	¥	REPLAC
1772 1773	BS BS	13 12	Blue Spruce Blue Spruce	Picea pungens Picea pungens	Good Fair	WOODLAND WOODLAND	R R	¥ ¥	REPLAC REPLAC
1774 1775	BS BS	12 14	Blue Spruce Blue Spruce	Picea pungens Picea pungens	Fair Fair	WOODLAND	R	¥ ¥	REPLAC REPLAC
1776	BS	12	Blue Spruce	Picea pungens	Good	WOODLAND WOODLAND	R R	¥	REPLAC
1777 1778	BS BS	12 11	Blue Spruce Blue Spruce	Picea pungens Picea pungens	Fair Fair	WOODLAND WOODLAND	R R	¥ ¥	REPLAC REPLAC
1779 1780	NS NS	9 10	Norway Spruce Norway Spruce	Picea Abies	Poor Poor	WOODLAND	R	¥ ¥	1
1781	NS	11	Norway Spruce	Picea Abies	Poor	WOODLAND WOODLAND	R R	¥	-
1782 1783	NS RA	43 8	Norway Spruce Norway Spruce	Picea Abies Picea Abies	Good Fair	WOODLAND WOODLAND	R R	¥ ¥	REPLAC REPLAC
1784	NS NS	10	Norway Spruce	Picea Abies	Fair	WOODLAND	R	¥	REPLAC
1785 1786	RA SH	8 10	Norway Spruce Norway Spruce	Picea Abies Picea Abies	Poor Fair	WOODLAND WOODLAND	R R	¥ ¥	- REPLAC
1787 1788	G BS	8 7	Ginkgo Blue Spruce	Ginkgo biloba Picea pungens	Good Fair	WOODLAND WOODLAND	S S	N Y	 -
1789	BS	7	Blue Spruce	Picea pungens	Fair	WOODLAND	S	Υ	1-
1790 1791	NS BS	7	Norway Spruce Blue Spruce	Picea Abies Picea pungens	Fair Poor	WOODLAND WOODLAND	S S	Y	<u></u>
1792 1793	BS NS	8 14	Blue Spruce Norway Spruce	Picea pungens Picea Abies	Poor Good	WOODLAND WOODLAND	S S	Y Y	<u> </u> - -
1794	NS	12	Norway Spruce	Picea Abies	Good	WOODLAND	S	Υ	1
1795 1796	BS BS	16 13	Blue Spruce Blue Spruce	Picea pungens Picea pungens	Good Good	WOODLAND WOODLAND	R R	¥ ¥	REPLAC REPLAC
1797 1798	WS BS	12 10	White Spruce Blue Spruce	Picea glauca Picea pungens	Fair Poor	WOODLAND WOODLAND	R	¥ ¥	REPLAC
1799	₩S	10	White Spruce	Picea glauca	Fair	WOODLAND	R R	¥	- REPLAC
1800 1801	BS BS	13 12	Blue Spruce Blue Spruce	Picea pungens Picea pungens	Fair Poor	WOODLAND WOODLAND	R R	¥ ¥	REPLAC
1802	BS BS	10	Blue Spruce	Picea pungens	Poor	WOODLAND	R	¥	- -
1804	BS	9	Blue Spruce Blue Spruce	Picea pungens Picea pungens	Fair	WOODLAND WOODLAND	R R	¥	REPLAC REPLAC
1805 1806	WS WS	8 8	White Spruce White Spruce	Picea glauca Picea glauca	Fair Fair	WOODLAND WOODLAND	R R	¥ ¥	REPLAC REPLAC
1807	₩S	8	White Spruce	Picea glauca	Fair	WOODLAND	R	¥	REPLAC
1808 1809	BS BS	7 7	Blue Spruce Blue Spruce	Picea pungens Picea pungens	Good Fair	WOODLAND WOODLAND	R R	¥ ¥	REPLAC REPLAC
1810 1811	BS BS	8 8	Blue Spruce	Picea pungens Picea pungens	Fair Fair	WOODLAND WOODLAND	R R	¥ ¥	REPLAC REPLAC
1812	BS	7	Blue Spruce	Picea pungens	Fair	WOODLAND	R	¥	REPLAC
1813 1814	BS BS	8	Blue Spruce Blue Spruce	Picea pungens Picea pungens	Fair Poor	WOODLAND WOODLAND	R R	¥ ¥	REPLAC
1815 1816	BS	8 7	Blue Spruce	Picea pungens	Fair	WOODLAND	R	¥	REPLAC
1816 1817	BS BS	8	Blue Spruce Blue Spruce	Picea pungens Picea pungens	Fair Fair	WOODLAND WOODLAND	R R	¥ ¥	REPLAC REPLAC
1818	BS	7	Blue Spruce	Picea pungens	Poor	WOODLAND	R-	¥	L

1821	BS	DBH 9	Blue Spruce	Picea pungens	COND	COMMENT	CLASS WOODLAND	SAVE / REMOVE	¥	REPLACE
1822	₩S	6	White Spruce	Picea glauca	Fair		WOODLAND	R	¥	REPLACE
1823 1824	BS BS	8 7	Blue Spruce	Picea pungens	Fair		WOODLAND	R	¥	REPLACE
1825	SM	6	Blue Spruce Silver Maple	Picea pungens Acer saccharinum	Poor Good		WOODLAND INVASIVE	R S	Y Y	┨.
1826	SC	16	Scotch Pine	Pinus sylvestris	Fair		WOODLAND	S	Y]-
1827 1828	WP BS	16 7	(Eastern) White Pine Blue Spruce	Pinus strobus Picea pungens	Fair Fair		WOODLAND	S	Y ¥	- REPLACE
1829	BS	8	Blue Spruce	Picea pungens	Fair		WOODLAND WOODLAND	R R	¥	REPLACE
1830	WS	7	White Spruce	Picea glauca	Fair		WOODLAND	R	¥	REPLACE
1831 1832	WS WS	6	White Spruce White Spruce	Picea glauca Picea glauca	Poor		WOODLAND	R	¥ ¥	
1833	WS	6	White Spruce	Picea glauca	Poor		WOODLAND WOODLAND	R R	¥	┨.
1834	₩S	6	White Spruce	Picea glauca	Poor		WOODLAND	R	¥	_ -
1835 1836	WS BS	6	White Spruce Blue Spruce	Picea glauca Picea pungens	Fair Good		WOODLAND	R P	¥ ¥	REPLACE REPLACE
1837	₩S	6	White Spruce	Picea glauca	Poor		WOODLAND WOODLAND	R R	¥	- REPLACE
1838	₩S	7	White Spruce	Picea glauca	Fair		WOODLAND	R	¥	REPLACE
1839 1840	WS WS	8	White Spruce White Spruce	Picea glauca Picea glauca	Fair Fair		WOODLAND	R	¥ ¥	REPLACE REPLACE
1841	BS	8	Blue Spruce	Picea pungens	Good		WOODLAND WOODLAND	R R	¥	REPLACE
1842	₩\$	7	White Spruce	Picea glauca	Fair		WOODLAND	R	¥	REPLACE
1843 1844	BS WS	9	Blue Spruce White Spruce	Picea pungens Picea glauca	Fair Poor		WOODLAND	R	¥ ¥	REPLACE
1845	BS	8	Blue Spruce	Picea pungens	Fair		WOODLAND WOODLAND	R R	¥	_ REPLACE
1846	BS	9	Blue Spruce	Picea pungens	Good		WOODLAND	R	¥	REPLACE
1847 1848	₩ S BS	6 8	White Spruce Blue Spruce	Picea glauca	Poor Fair		WOODLAND	R	¥ ¥	- - -
1849	BS	7	Blue Spruce	Picea pungens Picea pungens	Fair		WOODLAND WOODLAND	R R	¥	REPLACE REPLACE
1850	BS	8	Blue Spruce	Picea pungens	Fair		WOODLAND	R	¥	REPLACE
1851	NS	12	Norway Spruce	Picea Abies	Fair		WOODLAND	S	N]-
1852 1853	NS BS	13 8	Norway Spruce Blue Spruce	Picea Abies Picea pungens	Fair Fair		WOODLAND WOODLAND	S R	N ¥	- REPLACE
1854	WS	8	White Spruce	Picea glauca	Fair		WOODLAND	R	¥	REPLACE
1855	BS	8	Blue Spruce	Picea pungens	Fair		WOODLAND	R	¥	REPLACE
1856 1857	WS BS	9	White Spruce Blue Spruce	Picea glauca Picea pungens	Fair Fair		WOODLAND WOODLAND	R R	¥ ¥	REPLACE REPLACE
1858	WS	6	White Spruce	Picea glauca	Poor		WOODLAND	R	¥	
1859	BS	8	Blue Spruce	Picea pungens	Fair		WOODLAND	R	¥	REPLACE
1860 1861	BS NM	9 10	Blue Spruce Norway Maple	Picea pungens Acer platanoides	Fair Good		WOODLAND INVASIVE	R S	Y N	REPLACE
1862	BP	13	Bradford Pear	Pyrus calleryanna	Good		INVASIVE	S	N	
1863	SM	12	Silver Maple	Acer saccharinum	Fair		INVASIVE	S	N]-
1864 1865	BS BS	7 9	Blue Spruce Blue Spruce	Picea pungens Picea pungens	Poor Fair		WOODLAND WOODLAND	R R	¥ ¥	- REPLACE
1866	WS	9	White Spruce	Picea glauca	Poor		WOODLAND	R R	¥	-
1867	₩S	6	White Spruce	Picea glauca	Poor		WOODLAND	R	¥]-
1868 1869	BS WS	7 5	Blue Spruce White Spruce	Picea pungens Picea glauca	Fair Poor		WOODLAND	R P	¥ ¥	REPLACE
1870	₩S	5	White Spruce	Picea glauca	Poor		WOODLAND WOODLAND	R R	¥	-[-
1871	₩S	6	White Spruce	Picea glauca	Poor		WOODLAND	R	¥	_ -
1872 1873	BS NM	8	Blue Spruce	Picea pungens Acer platanoides	Fair Good		WOODLAND	R G	¥	REPLACE
1874	NM	6	Norway Maple Norway Maple	Acer platanoides Acer platanoides	Good		INVASIVE INVASIVE	S S	N N	┨.
1875	NM	6	Norway Maple	Acer platanoides	Good		INVASIVE	S	N	
1876 1877	NS	8	Norway Spruce	Picea Abies	Good		WOODLAND	S	N	-}-
1878	NS BS	8 7	Norway Spruce Blue Spruce	Picea Abies Picea pungens	Good Fair		WOODLAND WOODLAND	S R	Y ¥	_ REPLACE
1879	BS	8	Blue Spruce	Picea pungens	Good		WOODLAND	R	¥	REPLACE
1880	BS	8	Blue Spruce	Picea pungens	Good		WOODLAND	R	¥	REPLACE
1881 1882	BS BS	9 7	Blue Spruce Blue Spruce	Picea pungens Picea pungens	Fair Poor		WOODLAND WOODLAND	R R	¥ ¥	REPLACE
1883	BS	9	Blue Spruce	Picea pungens	Fair		WOODLAND	R	¥	REPLACE
1884	BS	7	Blue Spruce	Picea pungens	Fair		WOODLAND	R	¥	REPLACE
1885 1886	BS BS	8	Blue Spruce Blue Spruce	Picea pungens Picea pungens	Fair Fair		WOODLAND WOODLAND	R R	¥ ¥	REPLACE REPLACE
1887	BS	7	Blue Spruce	Picea pungens	Fair		WOODLAND	R	¥	REPLACE
1888	₩S	8	White Spruce	Picea glauca	Fair		WOODLAND	R	¥	REPLACE
1889 1890	WS BS	8 7	White Spruce Blue Spruce	Picea glauca Picea pungens	Fair Poor		WOODLAND	R R	¥ ¥	REPLACE
1891	BS	7	Blue Spruce	Picea pungens	Fair		WOODLAND WOODLAND	S	Y	-[.
1892	BS	6	Blue Spruce	Picea pungens	Poor		WOODLAND	S	Y]-
1893 1894	BS BS	11	Blue Spruce Blue Spruce	Picea pungens Picea pungens	Fair Fair		WOODLAND	S	Y	-[
1895	WS BS	8	White Spruce	Picea glauca	Poor		WOODLAND WOODLAND	S S	Y	
1896	NS	12	Norway Spruce	Picea Abies	Fair		WOODLAND	S	Y].
1897 1898	BS BS	12 11	Blue Spruce	Picea pungens	Fair Poor		WOODLAND	S	Y	1
1898 1899	WW BS	11 12	Blue Spruce Weeping Willow	Picea pungens Salix babylonica	Poor		WOODLAND INVASIVE	S S	Y	
1900	WW	13	Weeping Willow	Salix babylonica	Fair		INVASIVE	S	Y]-
1901	NS NS	8	Norway Spruce	Picea Abies	Very Poor		WOODLAND	S	Y	1
1902 1903	NS BS	7 10	Norway Spruce Blue Spruce	Picea Abies Picea pungens	Very Poor Very Poor		WOODLAND WOODLAND	S S	Y	-[
	NS	14	Norway Spruce	Picea Abies	Fair		WOODLAND	S	Y	<u></u>
1904	AU	27	Austrian Pine	Pinus nigra	Good		LANDMARK	S	N	1
1905		23	Austrian Pine Red Pine	Pinus nigra Pinus resinosa	Good Fair		LANDMARK LANDMARK	S S	N N	-[
	AU RP	19		Pinus resinosa	Fair		WOODLAND	S	N].
1905 1906 1907 1908	AU RP RP	14	Red Pine		Good		INVASIVE	S	N	-
1905 1906 1907 1908 1909	AU RP RP CT	14 58	Red Pine Cottonwood	Populus deltoides			XXX ~ ~ -			I-
1905 1906 1907 1908	AU RP RP	14	Red Pine Cottonwood Red Pine		Fair Good		WOODLAND LANDMARK	S	N N	┪.
1905 1906 1907 1908 1909 1910 1911 1912	AU RP RP CT RP RP RP	14 58 14 20 22	Red Pine Cottonwood Red Pine Red Pine Red Pine	Populus deltoides Pinus resinosa	Fair		WOODLAND LANDMARK LANDMARK	S S S	N N N].].
1905 1906 1907 1908 1909 1910 1911 1912 1913	AU RP RP CT RP RP RP	14 58 14 20 22 23	Red Pine Cottonwood Red Pine Red Pine Red Pine Red Pine Red Pine	Populus deltoides Pinus resinosa Pinus resinosa Pinus resinosa Pinus resinosa	Fair Good Good Good		LANDMARK LANDMARK LANDMARK	S S S	N N N]. - -
1905 1906 1907 1908 1909 1910 1911 1912 1913 1914	AU RP RP CT RP RP RP RP RP	14 58 14 20 22 23 18	Red Pine Cottonwood Red Pine Red Pine Red Pine Red Pine Red Pine Red Pine	Populus deltoides Pinus resinosa Pinus resinosa Pinus resinosa Pinus resinosa Pinus resinosa	Fair Good Good Good Fair		LANDMARK LANDMARK LANDMARK LANDMARK	S S S	N N N	- - - - - - -
1905 1906 1907 1908 1909 1910 1911 1912 1913	AU RP RP CT RP RP RP	14 58 14 20 22 23	Red Pine Cottonwood Red Pine Red Pine Red Pine Red Pine Red Pine	Populus deltoides Pinus resinosa Pinus resinosa Pinus resinosa Pinus resinosa	Fair Good Good Good		LANDMARK LANDMARK LANDMARK	S S S	N N N	- - - - - - - - - - - - - - - - - - -
1905 1906 1907 1908 1909 1910 1911 1912 1913 1914 1915 1916 1917	AU RP RP CT RP	14 58 14 20 22 23 18 21 19	Red Pine Cottonwood Red Pine	Populus deltoides Pinus resinosa	Fair Good Good Good Fair Fair Poor Fair		LANDMARK LANDMARK LANDMARK LANDMARK LANDMARK LANDMARK WOODLAND	S S S S	N N N N	- - - - - - - - - - - - - - - - - - -
1905 1906 1907 1908 1909 1910 1911 1912 1913 1914 1915 1916 1917 1918	AU RP RP CT RP	14 58 14 20 22 23 18 21 19 17	Red Pine Cottonwood Red Pine	Populus deltoides Pinus resinosa	Fair Good Good Fair Fair Poor Fair Poor		LANDMARK LANDMARK LANDMARK LANDMARK LANDMARK LANDMARK WOODLAND	S S S S S S S S S S	N N N N N N	-
1905 1906 1907 1908 1909 1910 1911 1912 1913 1914 1915 1916 1917	AU RP RP CT RP	14 58 14 20 22 23 18 21 19 17 17	Red Pine Cottonwood Red Pine	Populus deltoides Pinus resinosa	Fair Good Good Good Fair Fair Poor Fair		LANDMARK LANDMARK LANDMARK LANDMARK LANDMARK LANDMARK WOODLAND WOODLAND LANDMARK	S S S S S S S S S S S S S S S S S S S	N N N N N	-
1905 1906 1907 1908 1909 1910 1911 1912 1913 1914 1915 1916 1917 1918 1919	AU RP RP CT RP	14 58 14 20 22 23 18 21 19 17	Red Pine Cottonwood Red Pine	Populus deltoides Pinus resinosa	Fair Good Good Fair Fair Poor Fair Poor Poor		LANDMARK LANDMARK LANDMARK LANDMARK LANDMARK LANDMARK WOODLAND	S S S S S S S S S S	N N N N N N N N N N N N N N N N N N N	
1905 1906 1907 1908 1909 1910 1911 1912 1913 1914 1915 1916 1917 1918 1919 1920 1921 1922	AU RP RP CT RP	14 58 14 20 22 23 18 21 19 17 17 19 40 21 20	Red Pine Cottonwood Red Pine Cottonwood Red Pine Red Pine	Populus deltoides Pinus resinosa	Fair Good Good Fair Fair Poor Fair Poor Good Fair Fair		LANDMARK LANDMARK LANDMARK LANDMARK LANDMARK WOODLAND WOODLAND LANDMARK INVASIVE LANDMARK LANDMARK	S S S S S S S S S S S S S S S S S S S	N N N N N N N N N N N N N N N N N N N	- - - - - - - - - -
1905 1906 1907 1908 1909 1910 1911 1912 1913 1914 1915 1916 1917 1918 1919 1920 1921 1922 1923	AU RP RP CT RP	14 58 14 20 22 23 18 21 19 17 17 19 40 21 20 17	Red Pine Cottonwood Red Pine	Populus deltoides Pinus resinosa Populus deltoides Pinus resinosa Pinus resinosa Pinus resinosa	Fair Good Good Fair Fair Poor Fair Poor Good Fair Fair		LANDMARK LANDMARK LANDMARK LANDMARK LANDMARK WOODLAND WOODLAND LANDMARK INVASIVE LANDMARK LANDMARK UANDMARK WOODLAND	S S S S S S S S S S S S S S S S S S S	N N N N N N N N N N N N N N N N N N N	
1905 1906 1907 1908 1909 1910 1911 1912 1913 1914 1915 1916 1917 1918 1919 1920 1921	AU RP RP CT RP	14 58 14 20 22 23 18 21 19 17 17 19 40 21 20	Red Pine Cottonwood Red Pine Cottonwood Red Pine Red Pine	Populus deltoides Pinus resinosa	Fair Good Good Fair Fair Poor Fair Poor Good Fair Fair		LANDMARK LANDMARK LANDMARK LANDMARK LANDMARK LANDMARK WOODLAND WOODLAND LANDMARK INVASIVE LANDMARK LANDMARK LANDMARK LANDMARK LANDMARK WOODLAND LANDMARK	S S S S S S S S S S S S S S S S S S S	N N N N N N N N N N N N N N N N N N N	
1905 1906 1907 1908 1909 1910 1911 1912 1913 1914 1915 1916 1917 1918 1919 1920 1921 1922 1923 1924	AU RP RP CT RP	14 58 14 20 22 23 18 21 19 17 17 19 40 21 20 17 18	Red Pine Cottonwood Red Pine	Populus deltoides Pinus resinosa Populus deltoides Pinus resinosa Pinus resinosa Pinus resinosa Pinus resinosa	Fair Good Good Fair Fair Poor Fair Poor Good Fair Fair Fair Fair		LANDMARK LANDMARK LANDMARK LANDMARK LANDMARK WOODLAND WOODLAND LANDMARK INVASIVE LANDMARK LANDMARK UANDMARK WOODLAND	S S S S S S S S S S S S S S S S S S S	N N N N N N N N N N N N N N N N N N N	

KEY: NIC FOR REPLACEMENT = DEAD, DAMAGED, DISEASED, INVASIVE SPECIES STRIKETHROUGH, R = TREES TO REMOVE TYP. TEXT = TREES TO SAVE, S

SEE SHEET L-1.0 FOR TREE REPLACEMENT IF APPLICABLE

 WOODLAND TREES
 115
 (REPLACE AT 50% OF REMOVED DBH)

 1080" DBH x 0.5 =
 540" REPLACEMENT

 WOODLAND TREES SAVED:
 26
 (CREDIT OF 2X DBH)

 234 DBH x 2 =
 468" CREDIT

 540 468 =
 72

72 " DBH REQUIRED FOR REPLACEMENT

 LANDMARK TREES REMOVED:
 1
 (REPLACE AT 100% OF REMOVED DBH)

 18"
 DBH x 1 =
 18"
 REPLACEMENT

 LANDMARK TREES SAVED:
 0
 (CREDIT OF 2X DBH)

 "
 DBH x 2 =
 "
 CREDIT

 18
 0
 =
 18

18 " DBH REQUIRED FOR REPLACEMENT

(NO REPLACEMENT REQUIRED	FOR EXEM	IPT TREES)	
SAVED EXEMPT TREES:	6	Trees	
EXEMPT TREES ON SITE:	6	Trees	

PEA GROUP

t: 844.813.2949 www.peagroup.com



Know what's below.
Call before you dig

CAUTION!!

THE LOCATIONS AND ELEVATIONS OF EXISTING UNDERGROUND UTILITIES AS SHOWN ON THIS DRAWING ARE ONLY APPOXIMATE. NO GUARANTEE IS EITHER EXPRESSED OR IMPLIED AS TO THE COMPLETENESS OR ACCURACY THEREOF. THE CONTRACTOR SHALL BE EXCLUSIVELY RESPONSIBLE FOR DETERMINING THE EXACT UTILITY LOCATIONS AND ELEVATIONS PRIOR TO THE START OF CONSTRUCTION.

TROY SPORTS CENTER, LLC 1819 EAST BIG BEAVER ROAD TTOY, MI 48083

PROJECT TITLE

JOHN R
COMMONS
TOWNHOME
DEVELOPMENT
PART OF THE SE 1/4 OF SECTION 23, T.
2N., R. 11E.
TROY, OAKLAND COUNTY, MI

REVISIONS

SPA COMMENTS 11/8/23

SPA COMMENTS 3/1/24


ORIGINAL ISSUE DATE: AUGUST 18, 2023

DRAWING TITLE

EXISTING TREE

LIST

PEA JOB NO. 18-0034
P.M. GMB
DN. BGG
DES. JLE
DRAWING NUMBER:

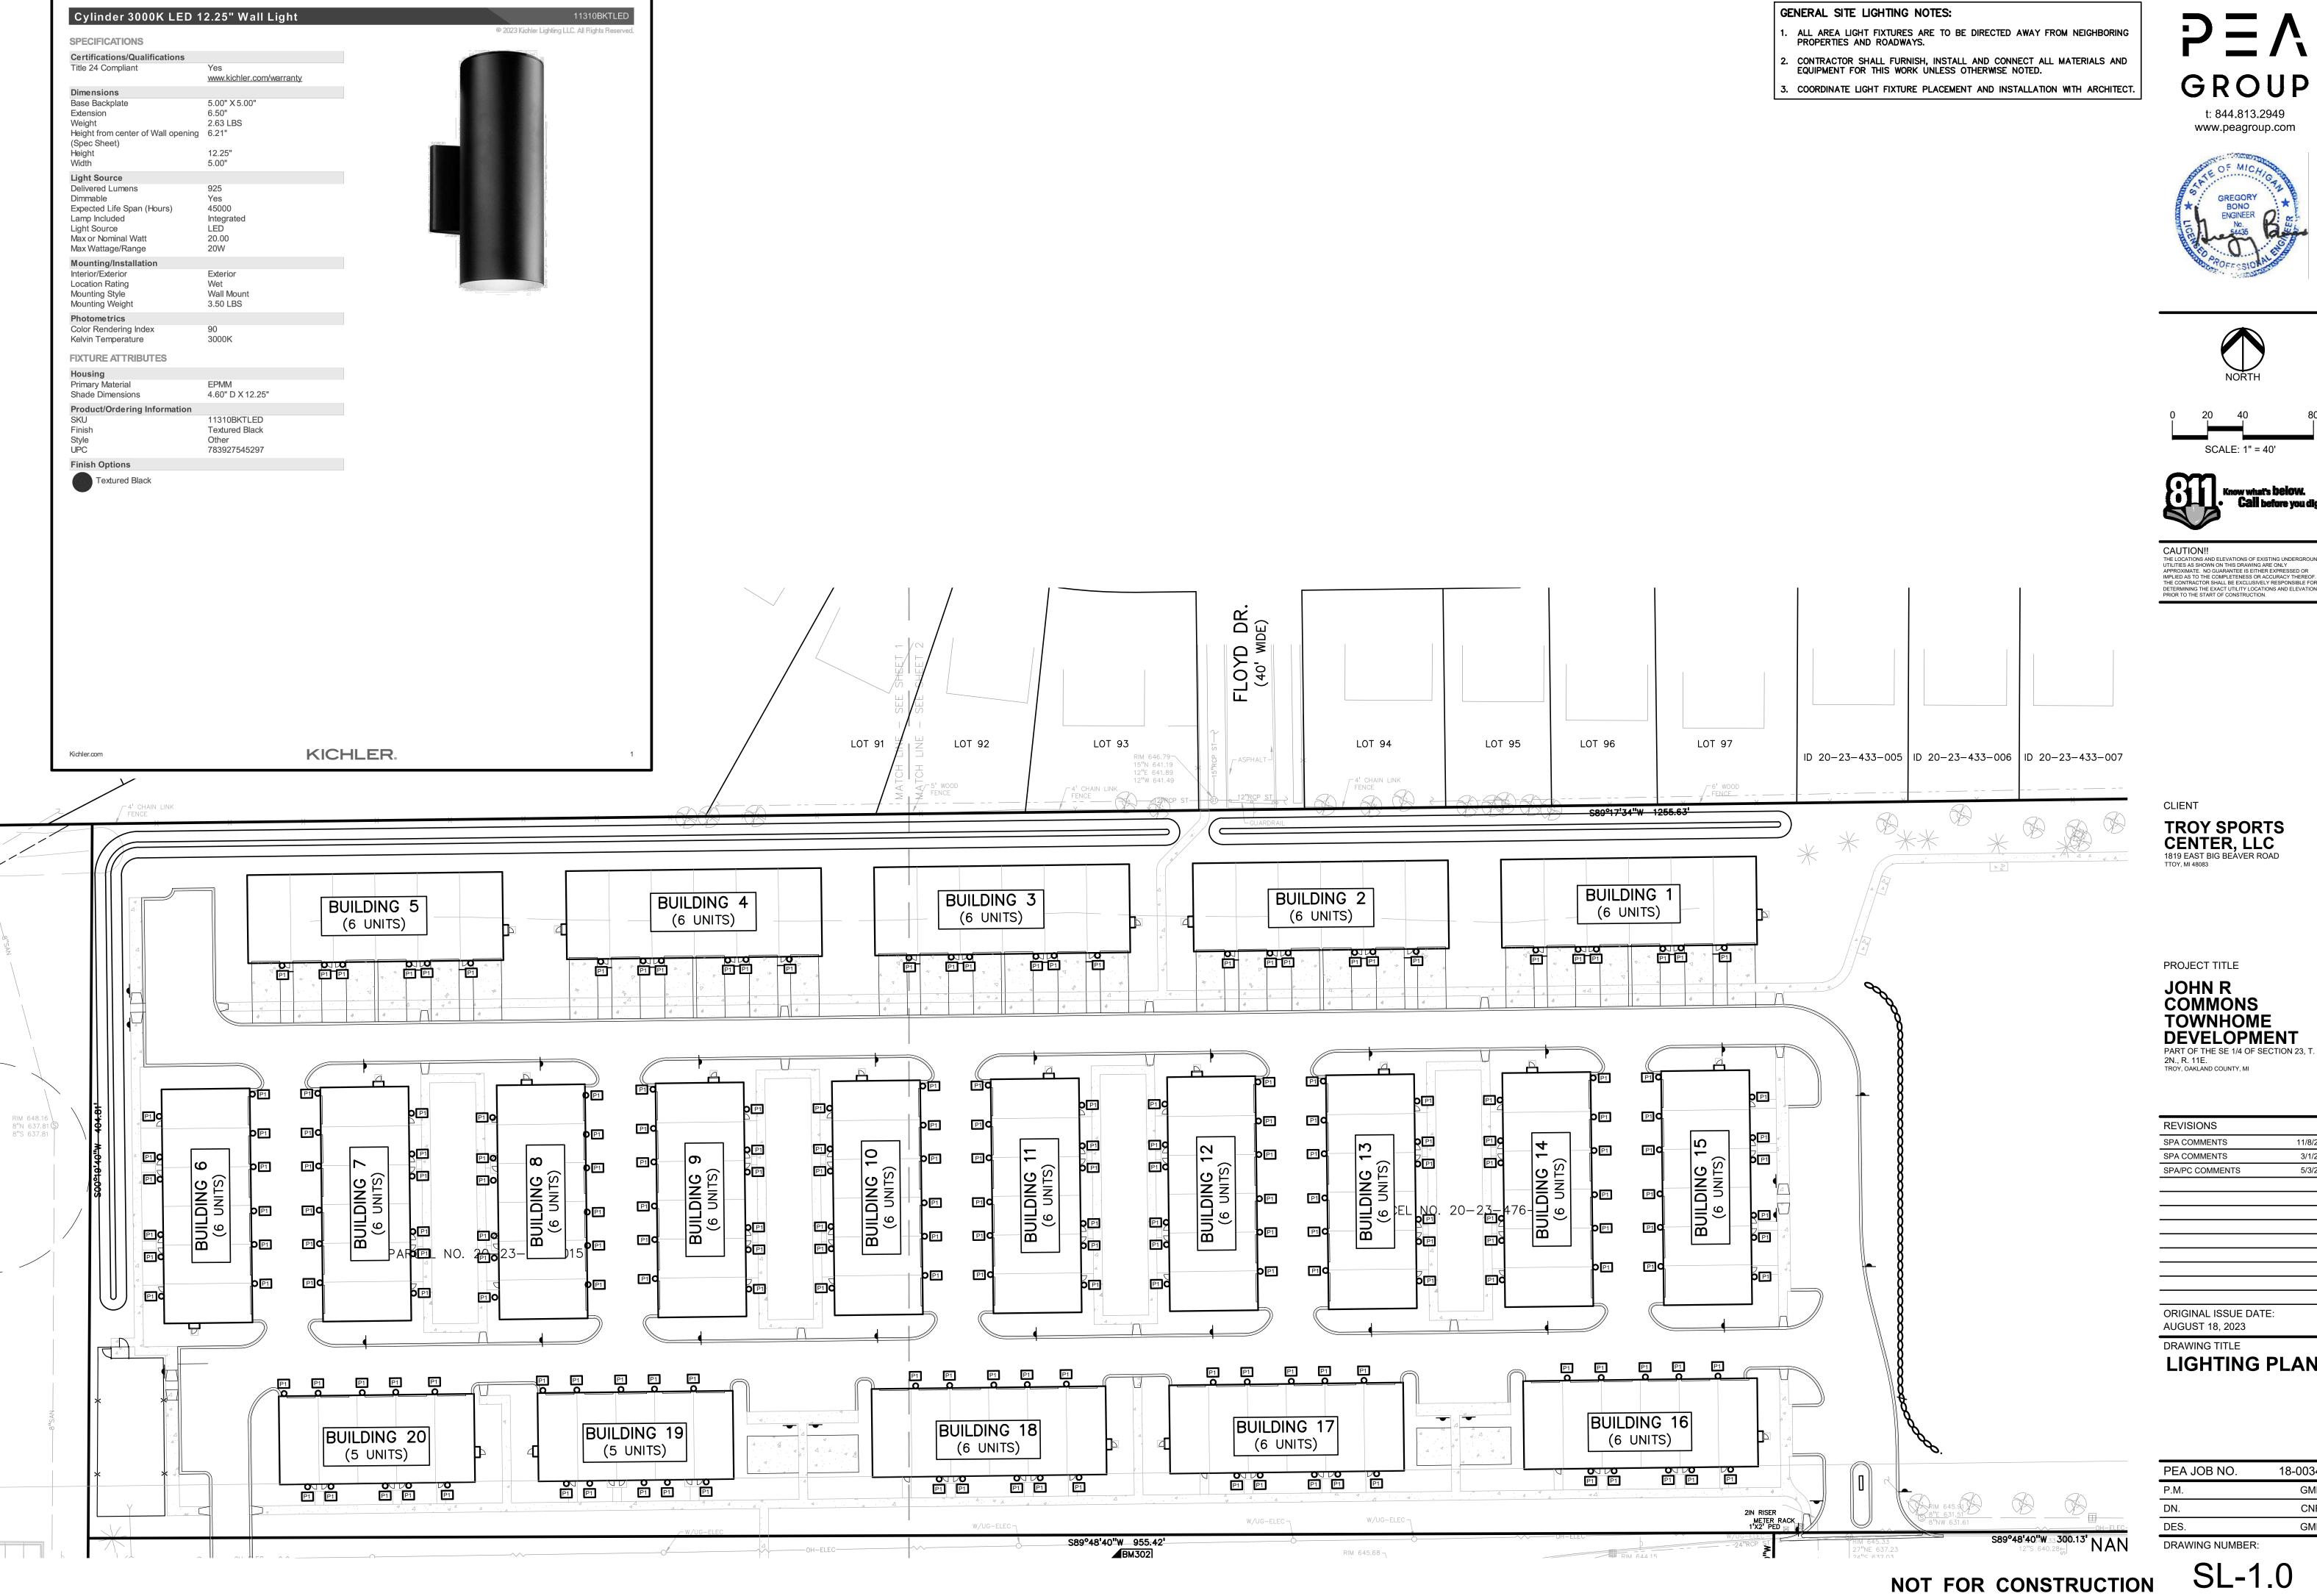









THE LOCATIONS AND ELEVATIONS OF EXISTING UNDERGROUND UTILITIES AS SHOWN ON THIS DRAWING ARE ONLY APPROXIMATE. NO GUARANTEE IS EITHER EXPRESSED OR IMPLIED AS TO THE COMPLETENESS OR ACCURACY THEREOF. THE CONTRACTOR SHALL BE EXCLUSIVELY RESPONSIBLE FOR DETERMINION THE EXACT UTILITY LOCATIONS AND ELEVATIONS PRIOR TO THE START OF CONSTRUCTION.

REVISIONS	
SPA COMMENTS	11/8/23
SPA COMMENTS	3/1/24
SPA/PC COMMENTS	5/3/24

LIGHTING PLAN


18-0034


GMB CNR GMB

JOHN R. TOWNHOME DEVELOPMENT

BUILDING TYPE 'A'

TROY, MICHIGAN

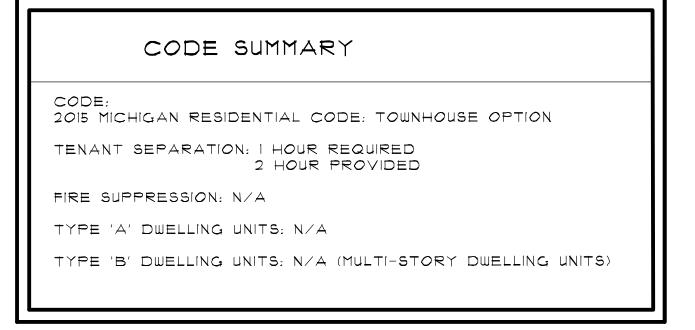

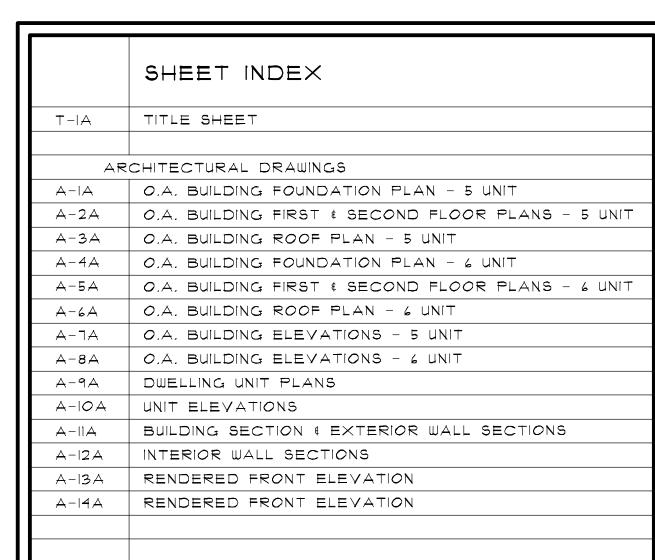






ARCHITECT:

BRIAN NEEPER ARCHITECTURE P.C. 630 N. OLD WOODWARD, SUITE 203

BIRMINGHAM, MICHIGAN 48009 248. 259. 1784

Brian•BrianNeeper.com

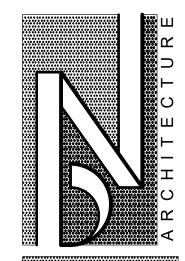

BRIAN NEEPER ARCHITECTURE P.C.

DESIGN - PLANNING - INTERIORS
630 North Old Woodward, Suite 203
BIRMINGHAM, MICHIGAN
BRIANNEEPER.COM
248. 259. 1784

JOHN R TOWNHOME DEV.
BUILDING TYPE 'A'
TROY, MICHIGAN

PRELIMINARY
03-27-24

BIDS

PERMITS


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JOB NUMBER
23060
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BN / EAF
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SHEET NUMBER

T-1A





FOUNDATION PLAN - BUILDING TYPE 'A'

SCALE: 3/16" = 1'-0"

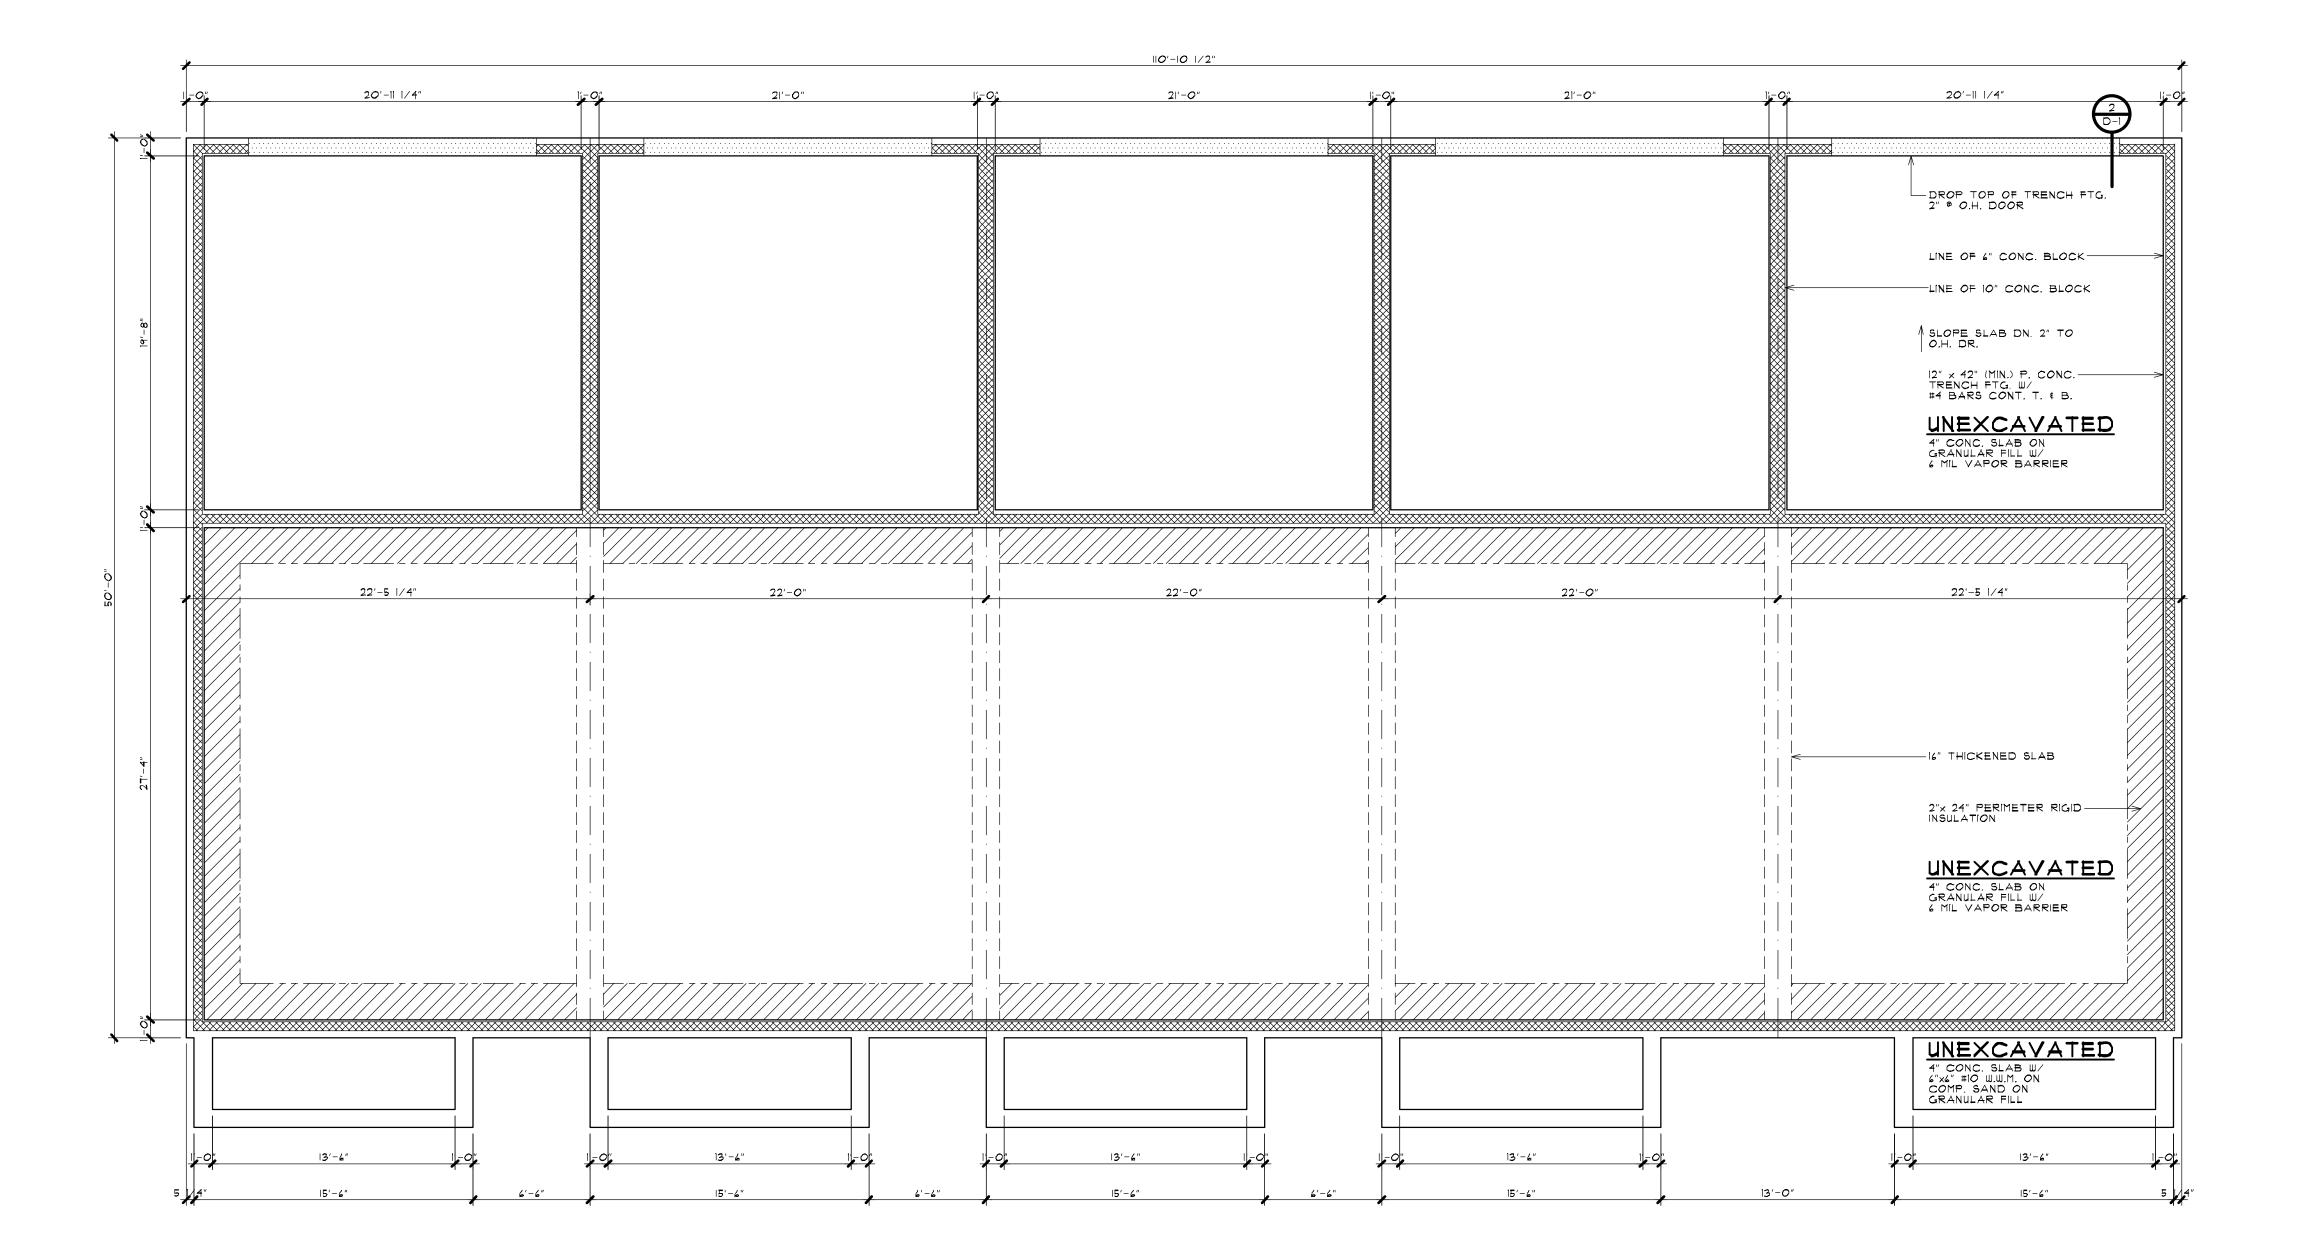FOUND, BLDG.


PRELIMINARY 03-27-24

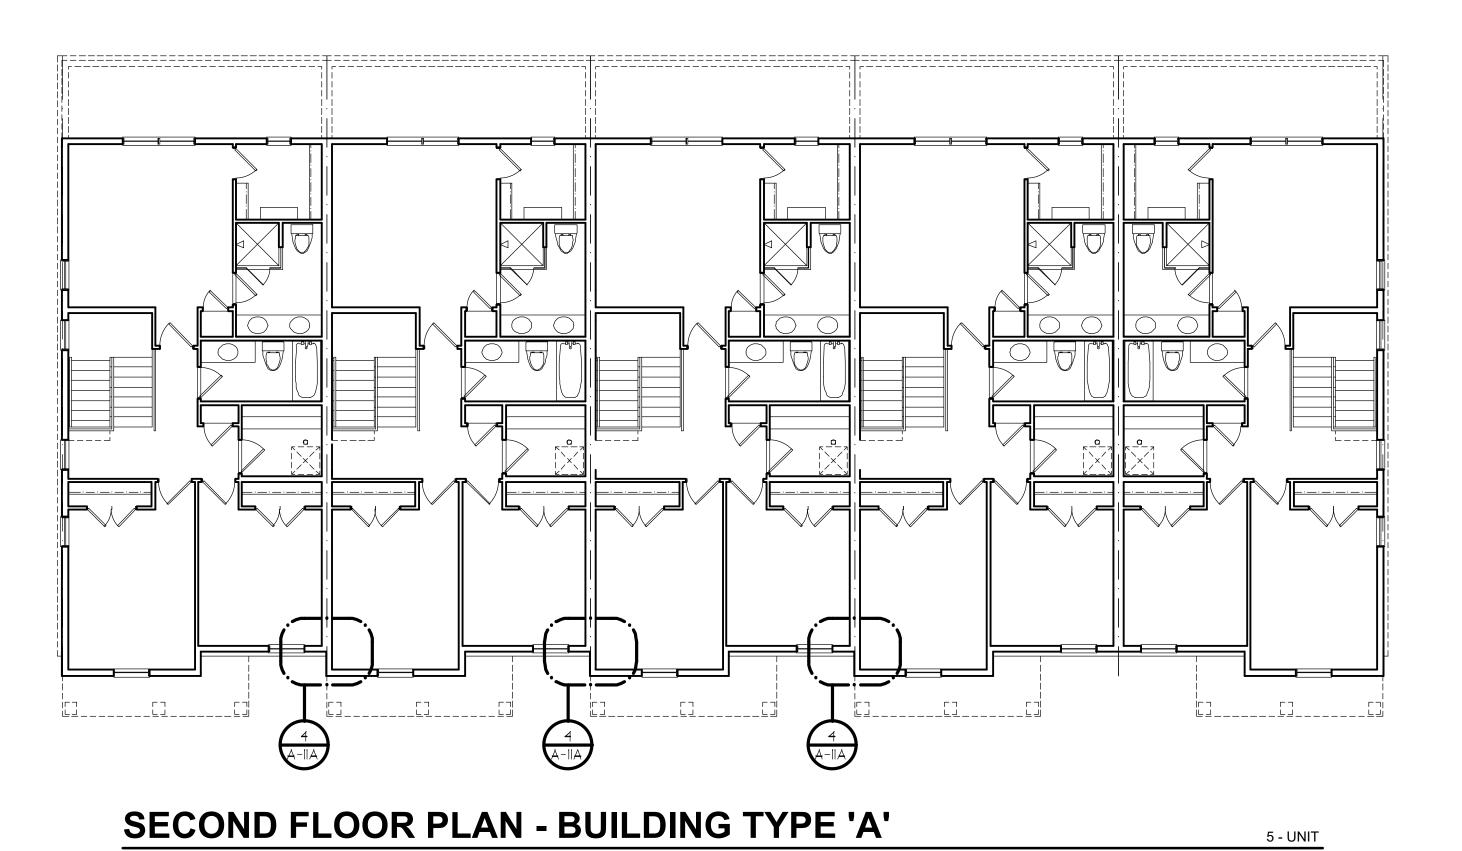

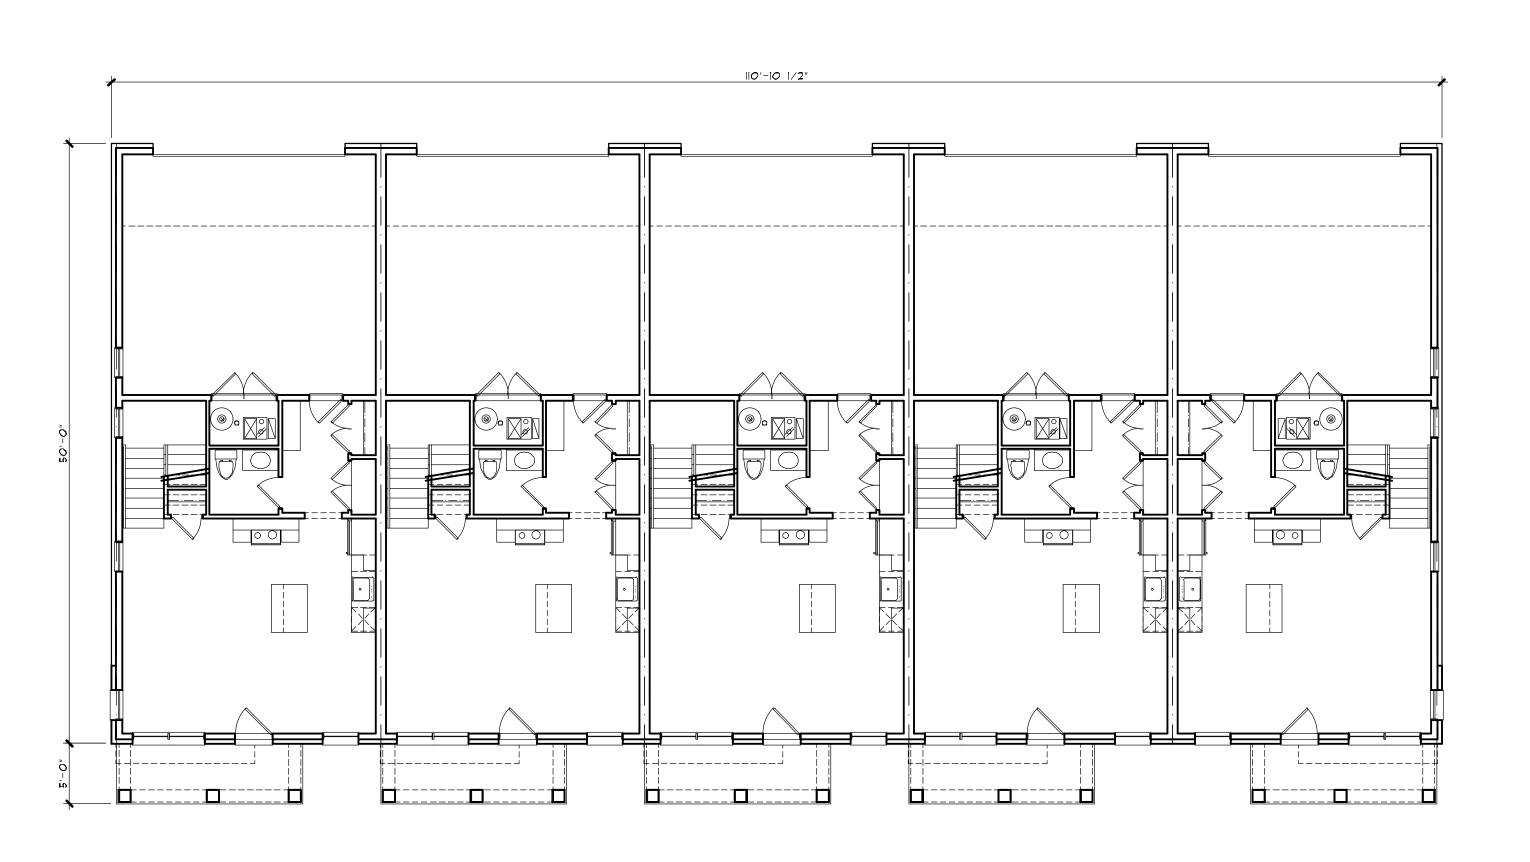



5 - UNIT SCALE: 1/8" = 1'-0"

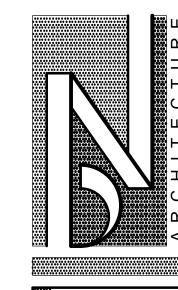

-OWNHOME E'A'

EXCEPTION: THE MINIMUM NET FREE VENTILATION AREA SHALL BE 1/300 OF THE VENTED SPACE, PROVIDED BOTH OF THE FOLLOWING CONDITIONS ARE MET:

IN CLIMATE ZONES 6, 7, AND 8, A CLASS I OR II VAPOR RETARDER IS INSTALLED ON THE

WARM-IN-WINTER SIDE OF THE CEILING.

2. NOT LESS THAN 40 PERCENT AND NOT MORE THAN 50 PERCENT OF THE REQUIRED VENTILATING AREA IS PROVIDED BY VENTILATORS LOCATED IN THE UPPER PORTION OF THE ATTIC OR RAFTER SPACE. UPPER VENTILATORS SHALL BE LOCATED NOT MORE THAN 3 FEET BELOW THE RIDGE OR HIGHEST POINT OF THE SPACE, MEASURED VERTICALLY. THE BALANCE OF THE REQUIRED VENTILATION PROVIDED SHALL BE LOCATED IN THE BOTTOM ONE-THIRD OF THE ATTIC SPACE. WHERE THE LOCATION OF WALL OR ROOF FRAMING MEMBERS CONFLICTS WITH THE INSTALLATION OF UPPER VENTILATORS. INSTALLATION MORE THAN 3 FEET BELOW THE RIDGE OR HIGHEST POINT OF THE SPACE SHALL BE PERMITTED.

OVERHANGS & DRAINAGE

PROVIDE GUTTERS & DOWNSPOUTS FOR DRAINAGE OF ROOF WATER. DOWNSPOUTS ARE TO BE CONNECTED TO STORM WATER COLLECTION SYSTEM. SEE CIVIL ENGINEER DWGs FOR CONNECTION DETAILS/LOCATIONS. DOWNSPOUT LOCATIONS ARE TO BE DETERMINED BY THE

UNLESS NOTED OTHERWISE OVERHANG DIMENSIONS ARE 12" FROM SHEATHING. RAKE DIMENSIONS ARE 4" AT BRICK AND 6" AT SIDING.

ROOF VENTING CALCULATIONS:

PROPOSED VENT AREA PER UNIT VENT AREA RATIO 1:150

ATTIC AREA = <u>966</u> SQ.FT. (1/300) VENT AREA = <u>3.22</u> SQ.FT. x 144 = <u>464</u> SQ.IN.

55% SOFFIT = **255** SQ.IN. EACH 45% RIDGE = **209** SQ.IN. EACH

VENT AREA PROVIDED ® RIDGE CONT. RIDGE TYPE @ 18 SQ.IN. PER FT. = 12 LIN.FT. TOTAL VENTING AT RIDGE = 216 SQ.IN.

VENT AREA PROVIDED ® SOFFIT 16"x 8" SOFFIT VENT 0 <u>50</u> Sq.in. per unit = <u>6</u> units TOTAL VENTING AT SOFFIT = 300 SQ.IN.

PROPOSED VENT AREA PER UNIT @ LOWER GARAGE

VENT AREA RATIO 1:150 ATTIC AREA = 143 SQ.FT. (1/150)


VENT AREA = <u>0.95</u> Sq.ft. x 144 = <u>131</u> Sq.in. 50% SOFFIT AND 50% RIDGE = **48.5** SQ.IN. EACH

VENT AREA PROVIDED ® RIDGE

OMNI-WALL VENT ® 9 SQ.IN. PER FT. = 8 LIN.FT. TOTAL VENTING AT RIDGE = 12 SQ.IN.

VENT AREA PROVIDED * SOFFIT

CONTINUOUS SOFFIT TYPE D 9 9 SQ.IN. PER FT. = 8 LIN.FT. TOTAL VENTING AT SOFFIT = 12 SQ.IN.

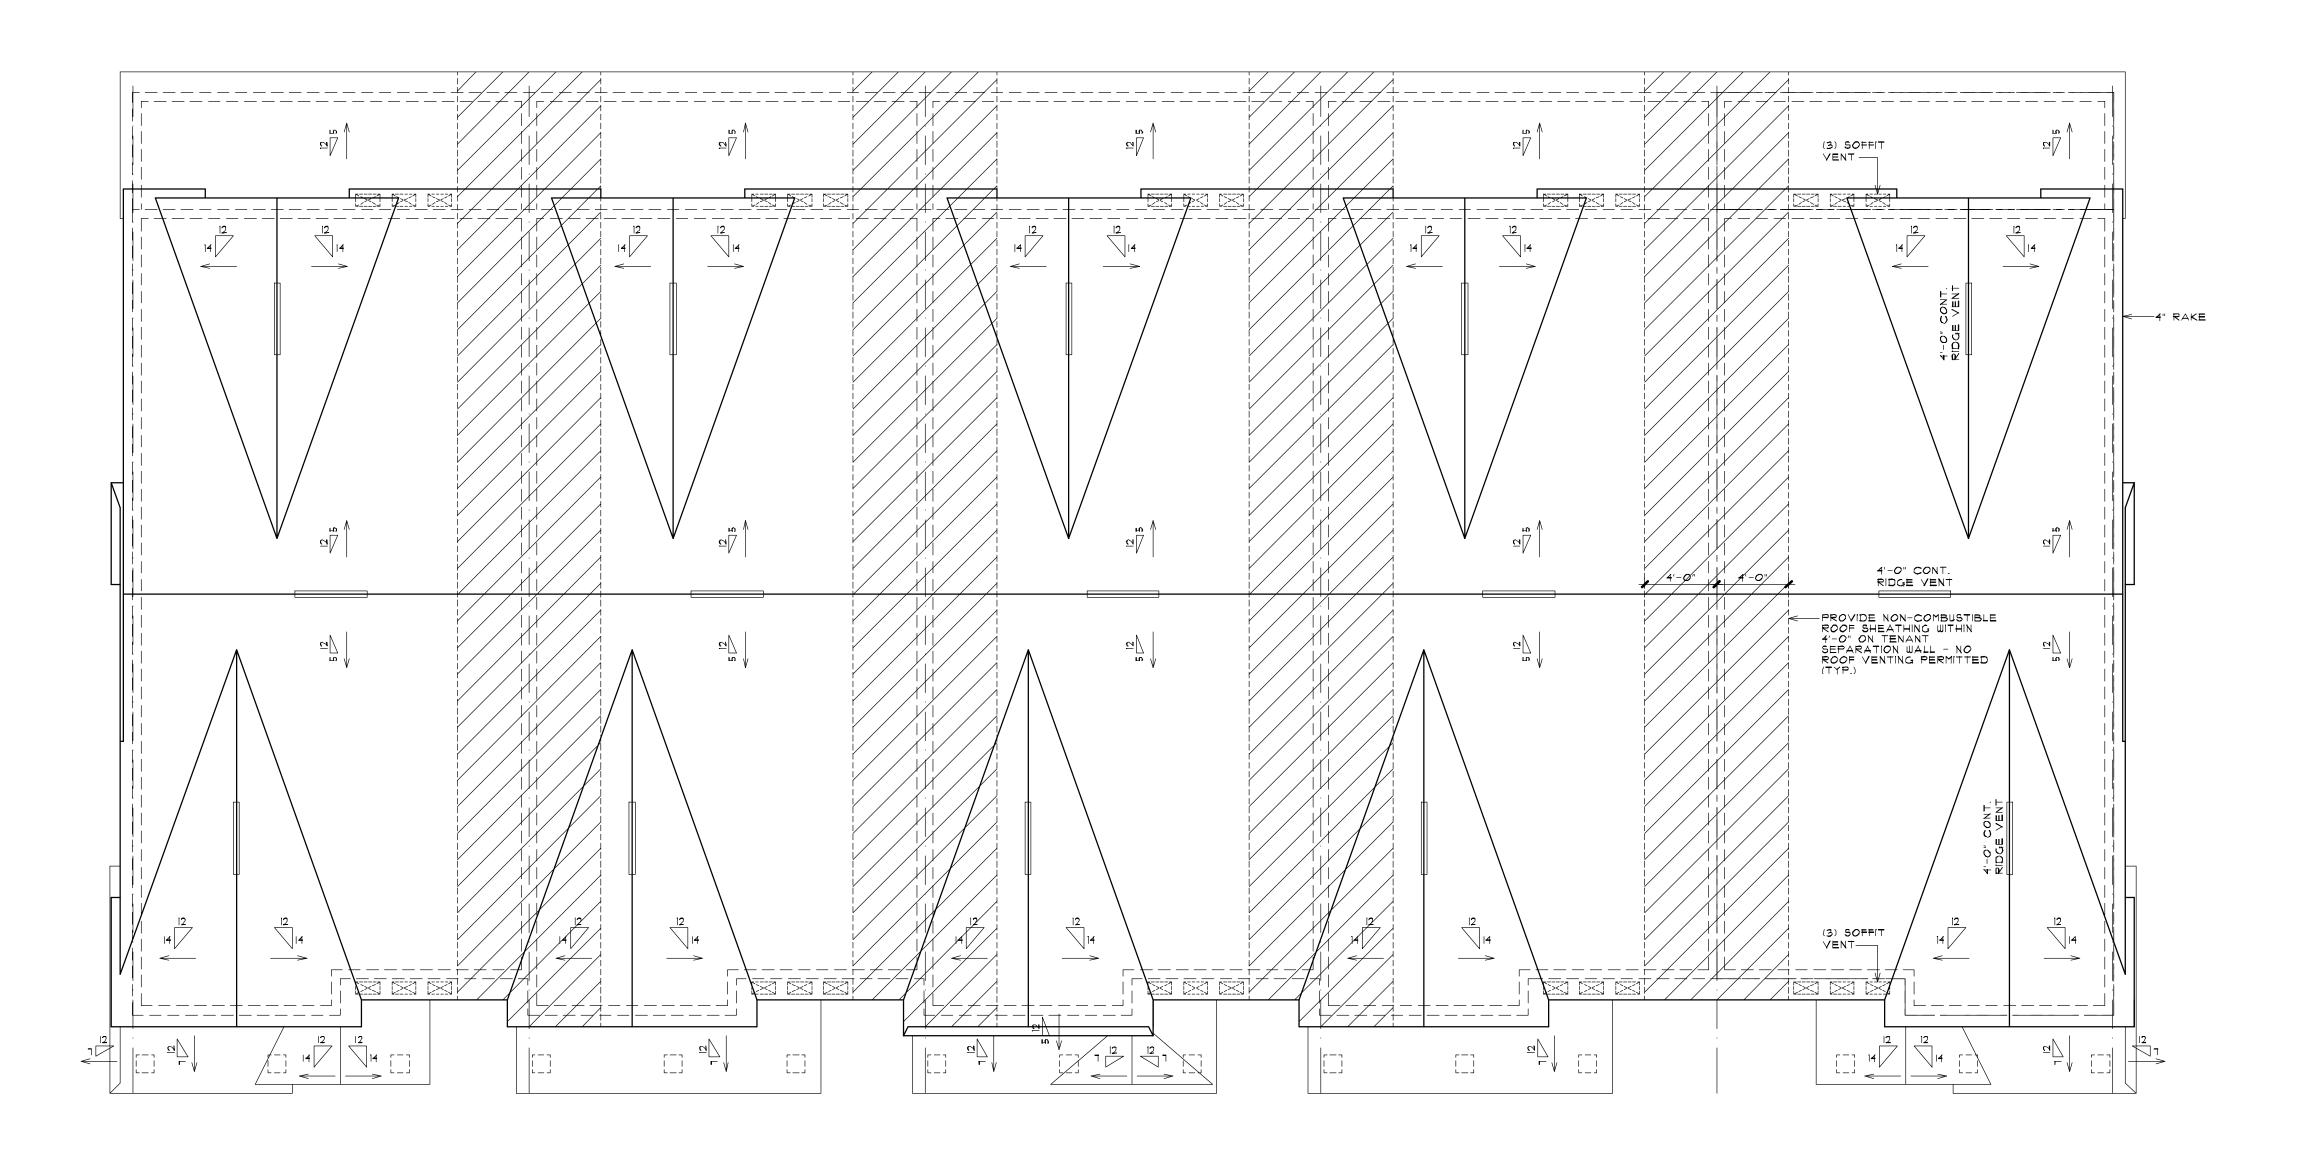

ROOF PLAN - BUILDING TYPE 'A'


5 - UNIT

SCALE: 3/16" = 1'-0"

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OWNH

03-27-24

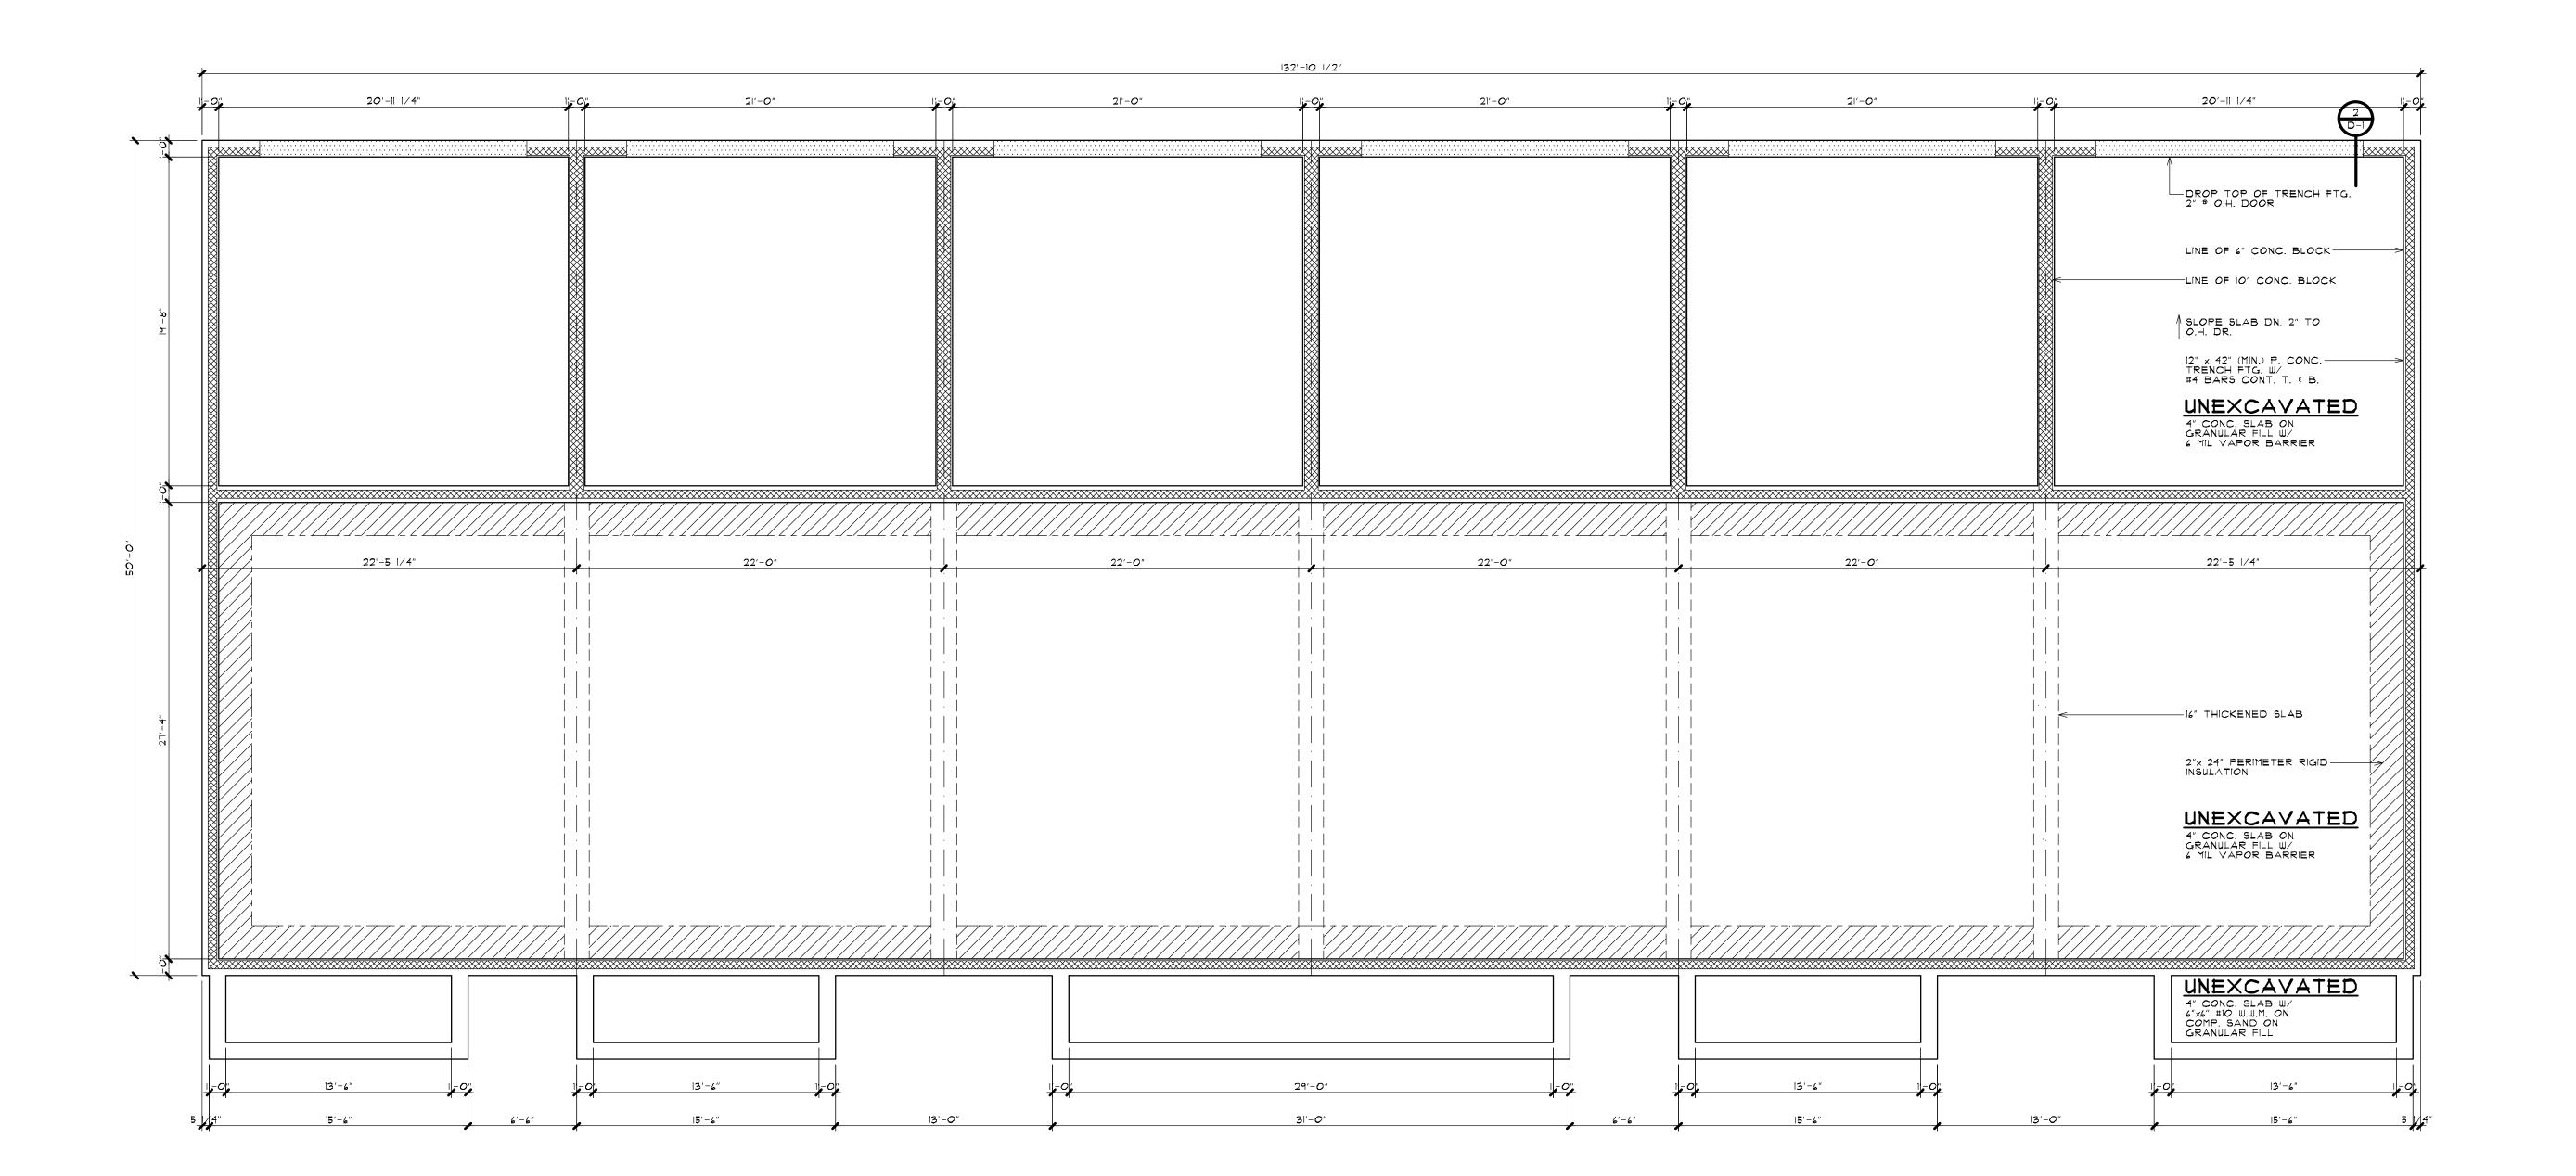

FOUNDATION PLAN - BUILDING TYPE 'A'

SCALE: 3/16" = 1'-0"

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FOUNDATION PLAN BLDG, TYPE 'A'-6 UNIT


JOHN R TOWNHOME DE BUILDING TYPE 'A'
TROY, MICHIGAN


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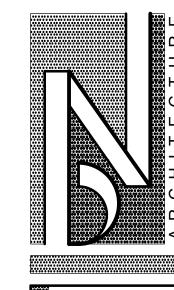
SHEET NUMBER





FIRST FLOOR PLAN - BUILDING TYPE 'A'

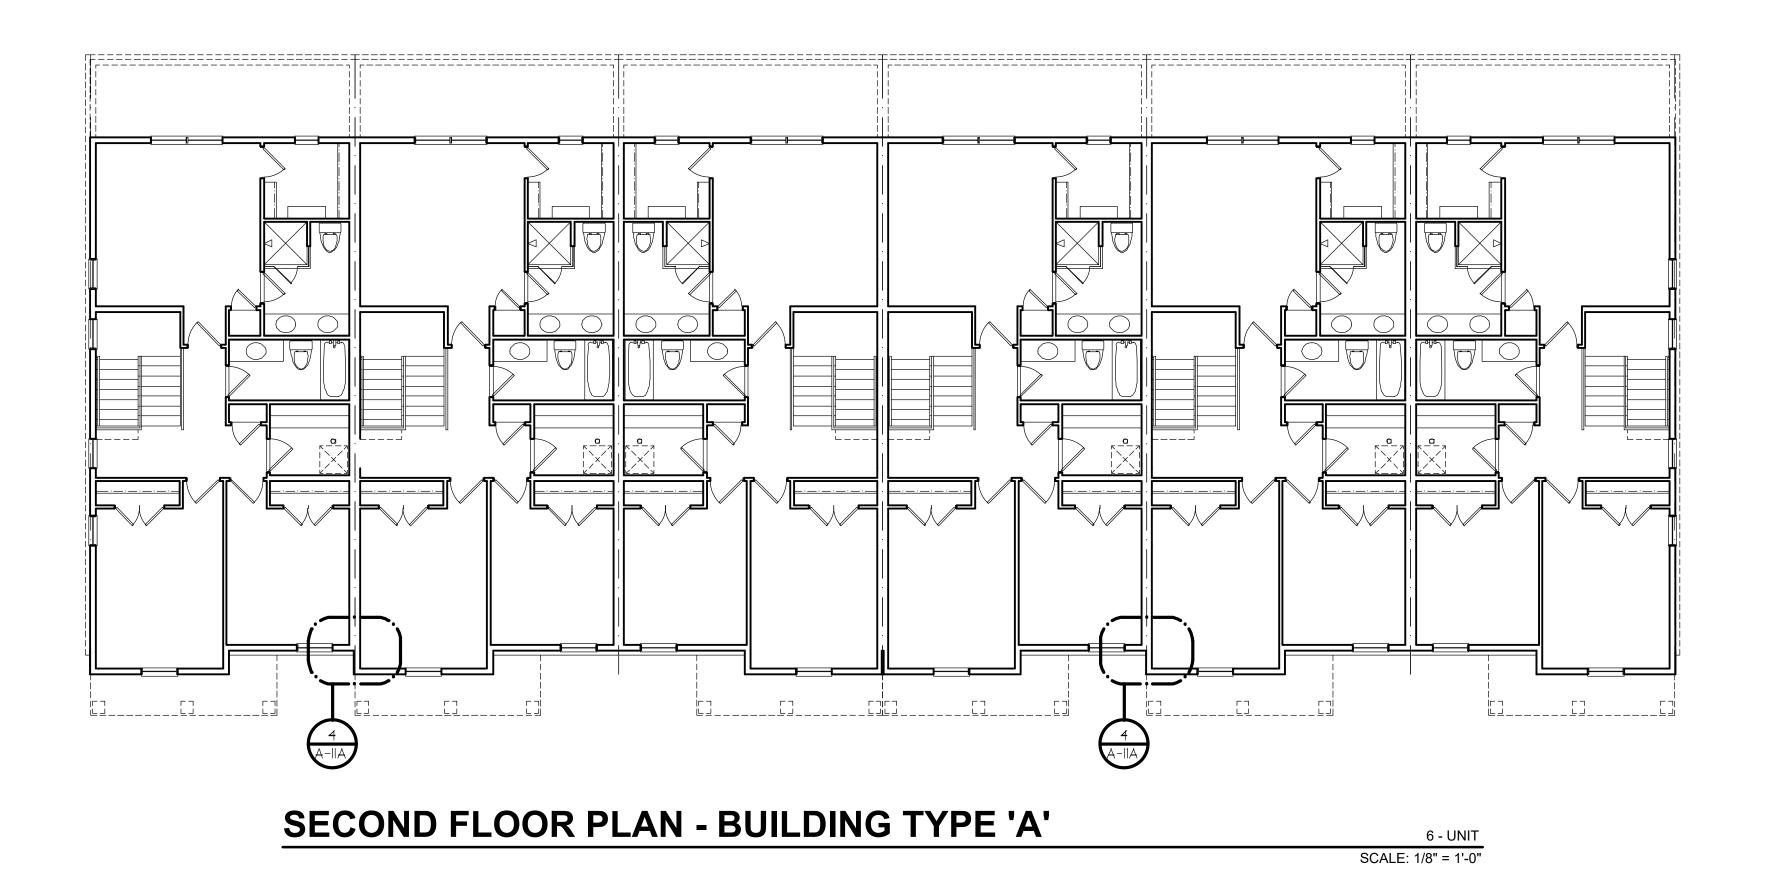6 - UNIT SCALE: 1/8" = 1'-0"

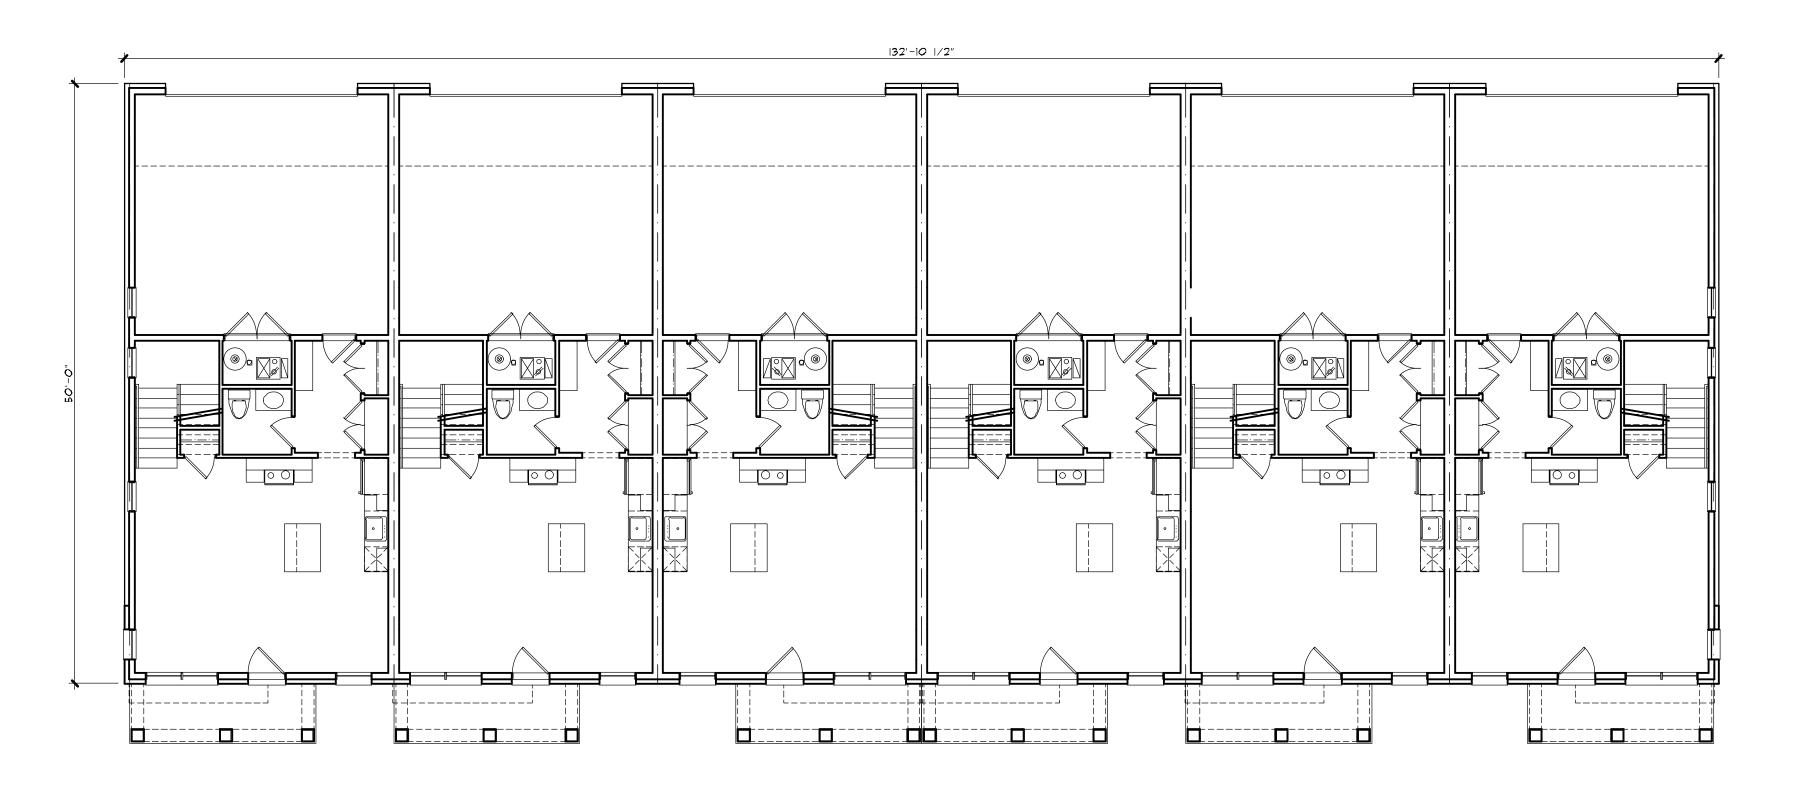

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|st & 2nd FLOOR PL, BLDG, TYPE 'A'-6 |

JOHN R TOWNHOME DE BUILDING TYPE 'A'

TROY, MICHIGAN

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A-5A

EXCEPTION: THE MINIMUM NET FREE VENTILATION AREA SHALL BE 1/300 OF THE VENTED SPACE, PROVIDED BOTH OF THE FOLLOWING CONDITIONS ARE MET:

IN CLIMATE ZONES 6, 1, AND 8, A CLASS I OR II VAPOR RETARDER IS INSTALLED ON THE

WARM-IN-WINTER SIDE OF THE CEILING. 2. NOT LESS THAN 40 PERCENT AND NOT MORE THAN 50 PERCENT OF THE REQUIRED VENTILATING AREA IS PROVIDED BY VENTILATORS LOCATED IN THE UPPER PORTION OF THE ATTIC OR RAFTER SPACE, UPPER VENTILATORS SHALL BE LOCATED NOT MORE THAN

3 FEET BELOW THE RIDGE OR HIGHEST POINT OF THE SPACE, MEASURED VERTICALLY. THE BALANCE OF THE REQUIRED VENTILATION PROVIDED SHALL BE LOCATED IN THE BOTTOM ONE-THIRD OF THE ATTIC SPACE. WHERE THE LOCATION OF WALL OR ROOF FRAMING MEMBERS CONFLICTS WITH THE INSTALLATION OF UPPER VENTILATORS. INSTALLATION MORE THAN 3 FEET BELOW THE RIDGE OR HIGHEST POINT OF THE SPACE SHALL BE PERMITTED.

OVERHANGS & DRAINAGE

PROVIDE GUTTERS & DOWNSPOUTS FOR DRAINAGE OF ROOF WATER. DOWNSPOUTS ARE TO BE CONNECTED TO STORM WATER COLLECTION SYSTEM. SEE CIVIL ENGINEER DWGs FOR CONNECTION DETAILS/LOCATIONS. DOWNSPOUT LOCATIONS ARE TO BE DETERMINED BY THE

UNLESS NOTED OTHERWISE OVERHANG DIMENSIONS ARE 12" FROM SHEATHING. RAKE DIMENSIONS ARE 4" AT BRICK AND 6" AT SIDING.

PROPOSED VENT AREA PER UNIT VENT AREA RATIO 1:150

ATTIC AREA = <u>966</u> SQ.FT. (1/300) VENT AREA = 3.22 SQ.FT. x 144 = 464 SQ.IN.

ROOF VENTING CALCULATIONS:

55% SOFFIT = 255 SQ.IN. EACH 45% RIDGE = **209** SQ.IN. EACH

VENT AREA PROVIDED ® RIDGE

CONT. RIDGE TYPE ® 18 SQ.IN. PER FT. = 12 LIN.FT. TOTAL VENTING AT RIDGE = 216 SQ.IN.

VENT AREA PROVIDED ® SOFFIT

16"x 8" SOFFIT VENT D SQ.IN. PER UNIT = 6 UNITS TOTAL VENTING AT SOFFIT = 300 SQ.IN.

PROPOSED VENT AREA PER UNIT @ LOWER GARAGE

VENT AREA RATIO 1:150 ATTIC AREA = 143 SQ.FT. (1/150)


VENT AREA = <u>0.95</u> Sq.ft. x 144 = <u>131</u> Sq.in. 50% SOFFIT AND 50% RIDGE = **48.5** SQ.IN. EACH

VENT AREA PROVIDED ® RIDGE

OMNI-WALL VENT ® 9 SQ.IN. PER FT. = 8 LIN.FT. TOTAL VENTING AT RIDGE = 12 SQ.IN.

VENT AREA PROVIDED ® SOFFIT

CONTINUOUS SOFFIT TYPE D 9 SQ.IN. PER FT. = 8 LIN.FT. TOTAL VENTING AT SOFFIT = 12 SQ.IN.

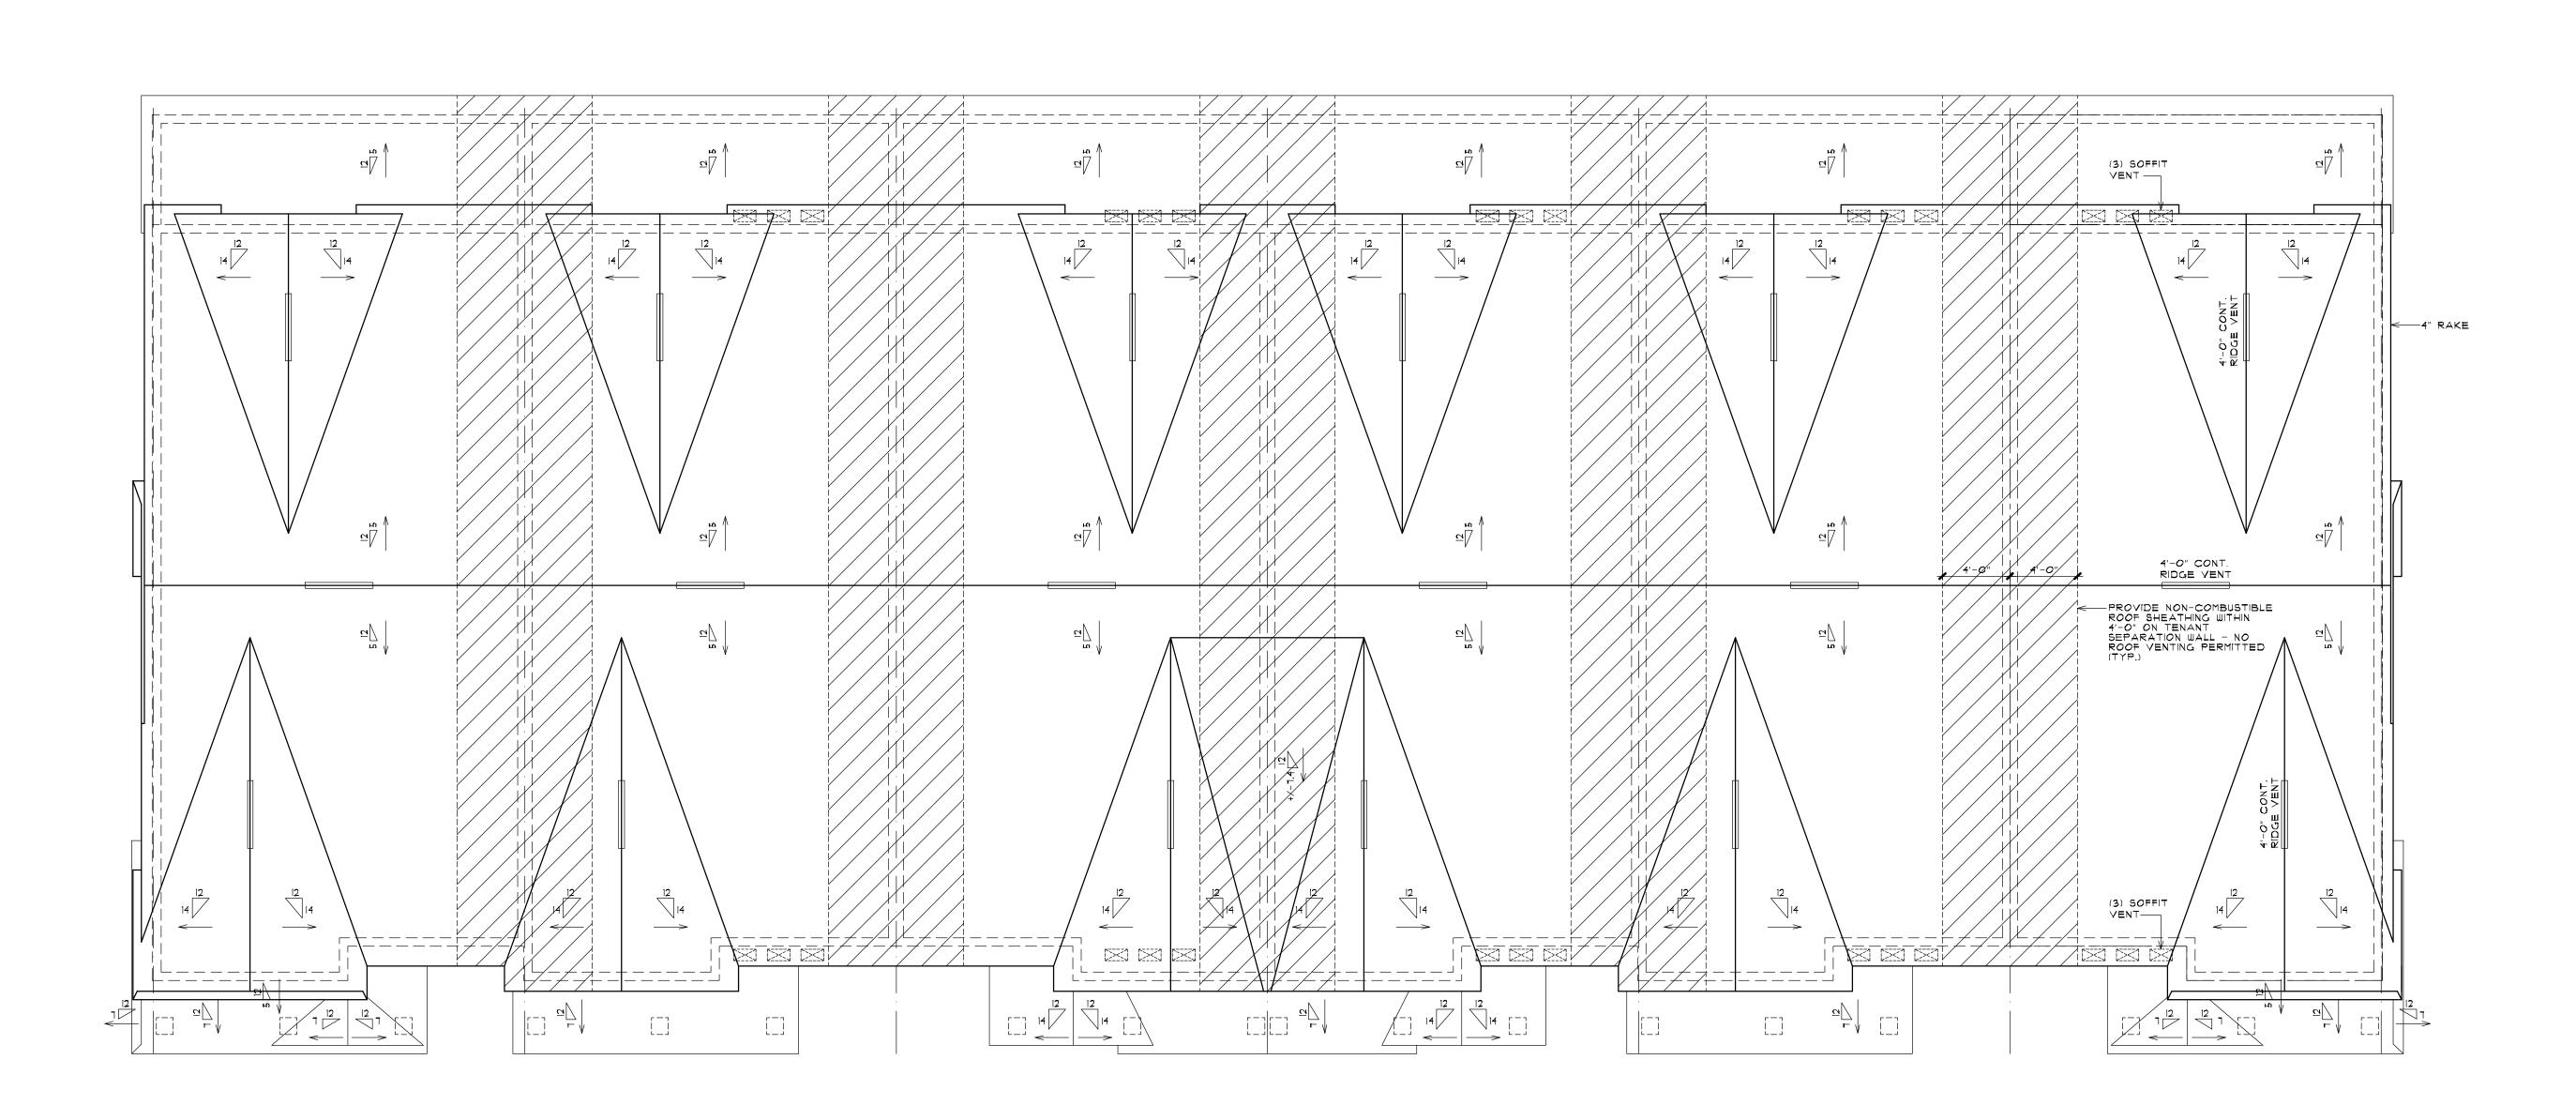



ROOF - BUILDING TYPE 'A'


6 - UNIT SCALE: 3/16" = 1'-0"


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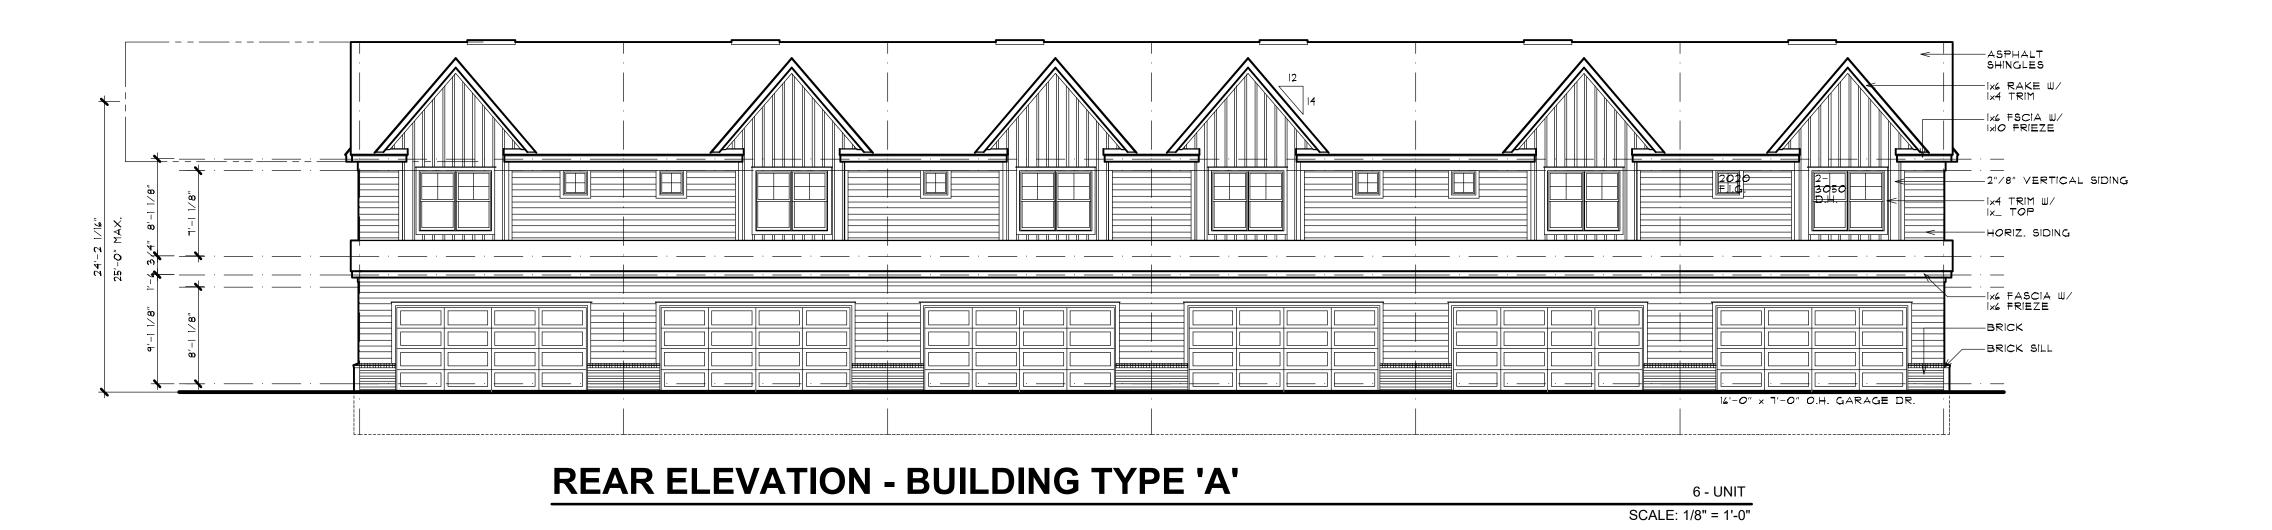
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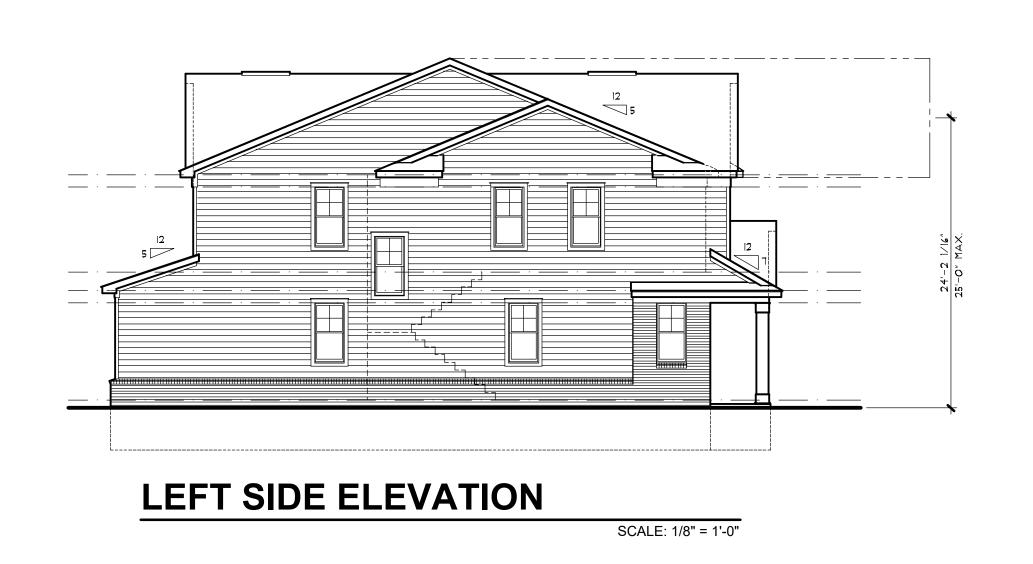
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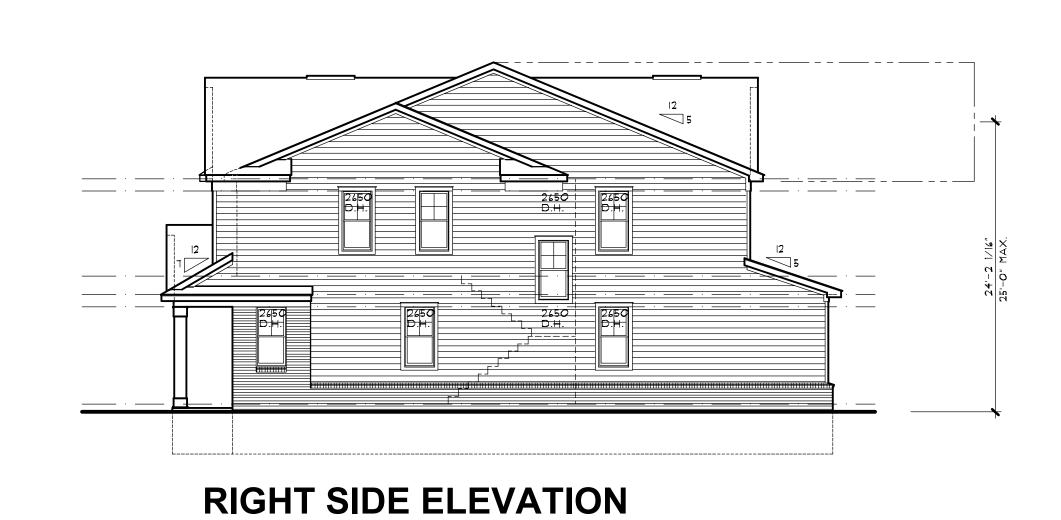
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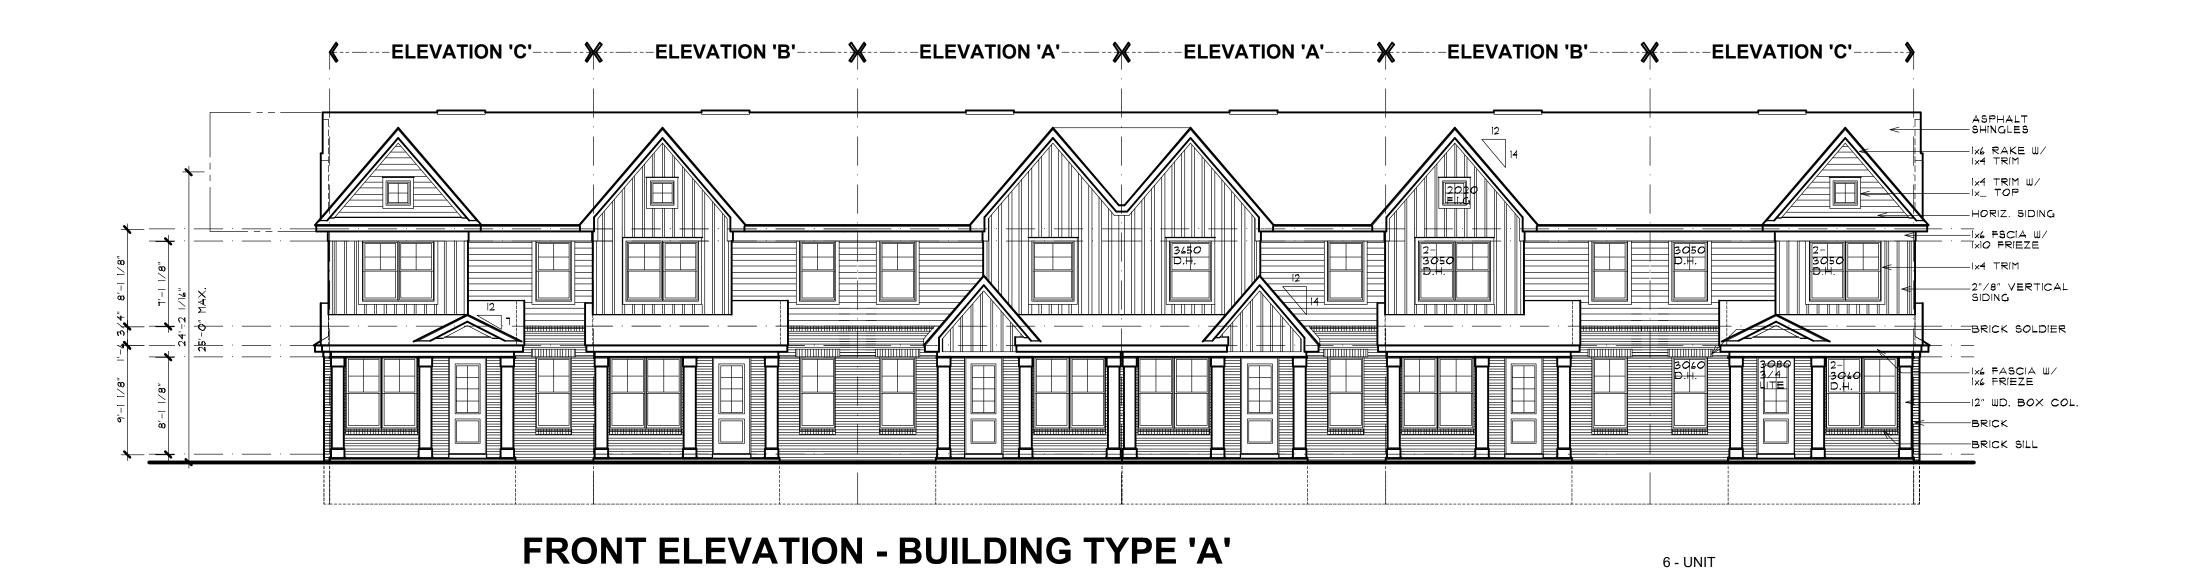




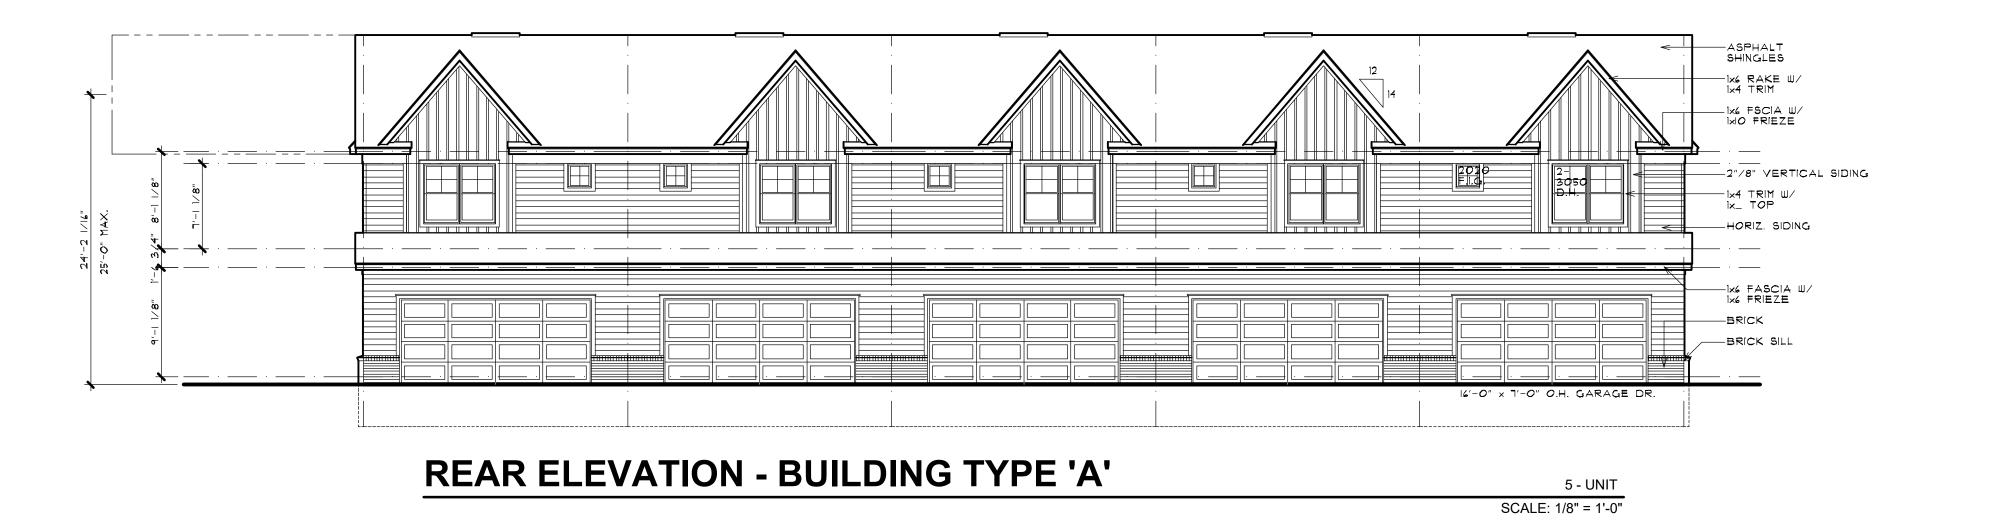

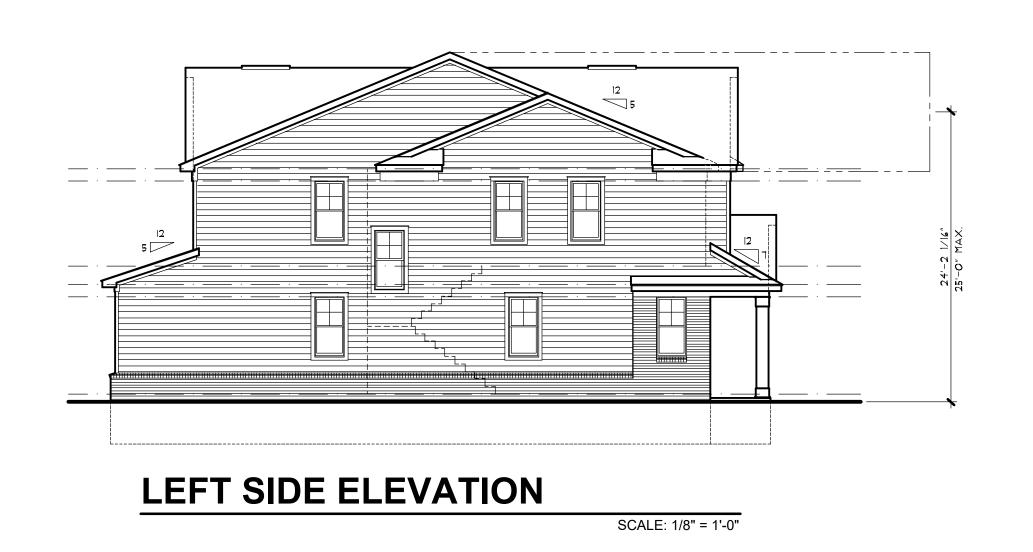SCALE: 1/8" = 1'-0"

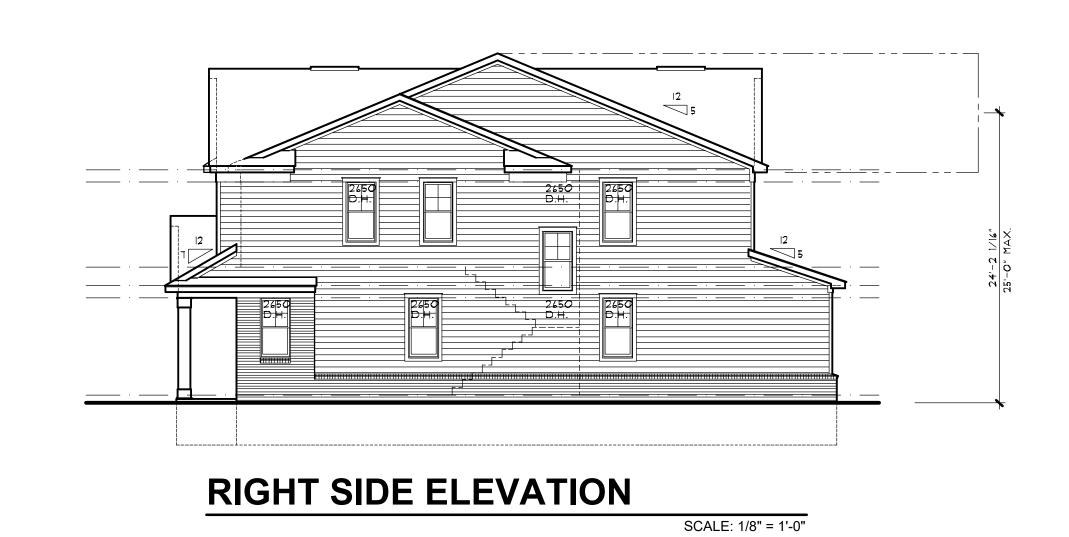SCALE: 1/8" = 1'-0"

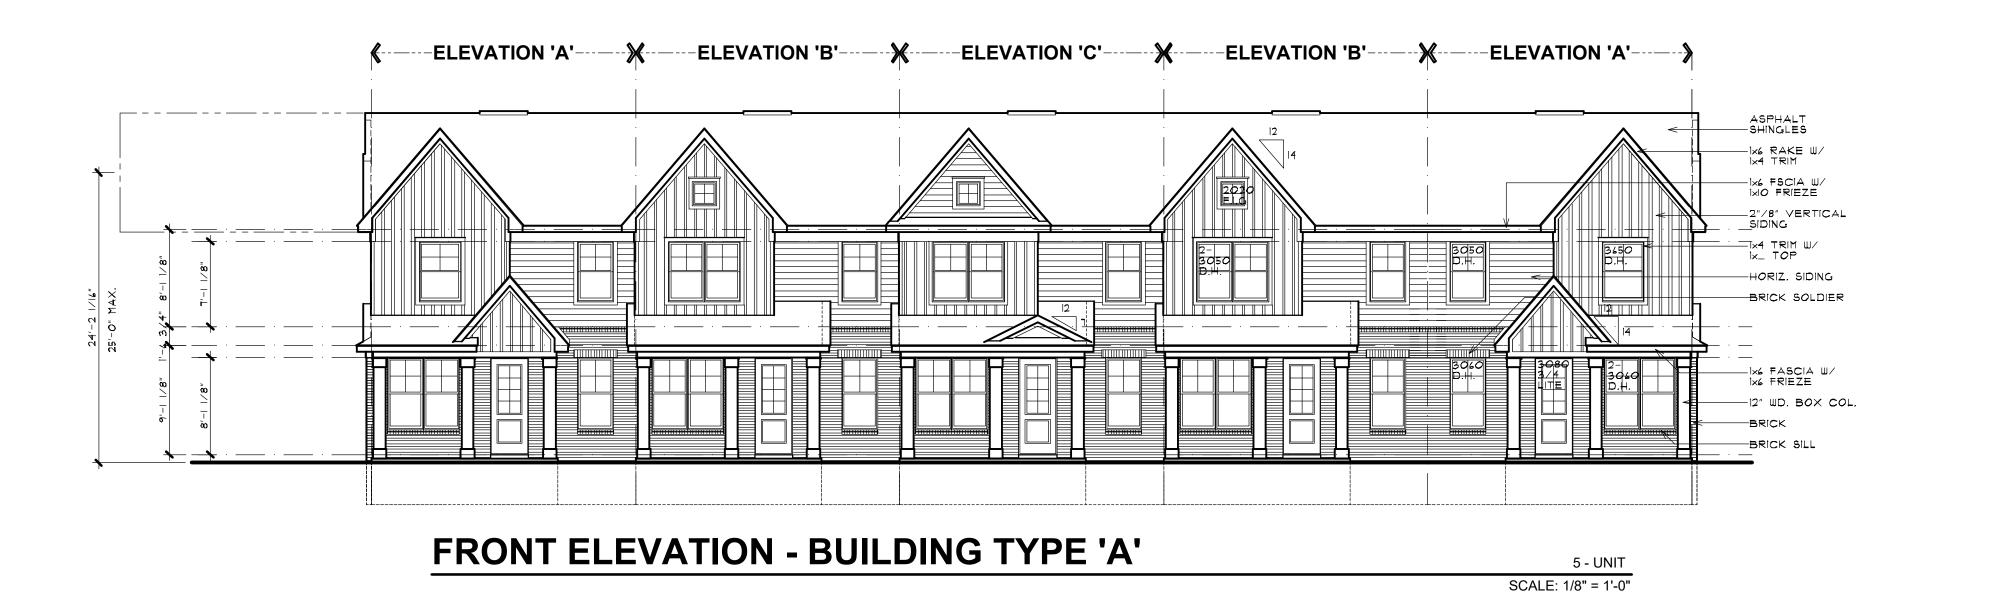

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A-8A

STRUCTURAL NOTES:

(2) 2x8 HEADERS TO BEAR ON (1) ONE JACK STUD UNLESS NOTED OTHERWISE.

(2) 2×10 & LARGER HEADERS TO BEAR ON (2) TWO JACK STUDS UNLESS NOTED OTHERWISE.

ALL PRE-ENGINEERED HEADERS FRAMED PERPENDICULAR TO WALL LINE SHALL BEAR ON REQUIRED NUMBER OF STUDS TO MATCH WIDTH OF HEADER MATERIAL.

ALL PRE-ENGINEERED HEADERS FRAMED PARALLEL TO WALL LINE Shall Bear on a minimum (2) two Jack Studs unless noted otherwise.

ALL PRE-ENGINEERED LUMBER HEADERS SHALL BE BUILT-UP FROM THE NUMBER OF HEADERS INDICATED ON DRAWINGS. ALL MEMBERS SHALL BE SECURED WITH NAILS OR BOLTS AS SPECIFIED BY THE MANUFACTURER FOR SIZES INDICATED.

ALL GIRDER TRUSSES TO BEAR ON (2) TWO STUDS MINIMUM OR AS REQUIRED TO MATCH NUMBER OF TRUSS PLYS, WHICH EVER IS

TRUSS FABRICATOR/CONTRACTOR TO PROVIDE ALL HANGERS W/MODEL No. CLEARLY STAMPED & LAYOUT DRAWINGS CLEARLY INDICATING LOCATION OF VARIOUS HANGERS REQUIRED.

CARPENTER CONTRACTOR TO INSTALL NAIL SIZES & NUMBER REQ'D. AS SPECIFIED FOR EACH TYPE OF HANGER. LVL DESIGN VALUES FOR MODULUS OF ELASTICITY (E) SHALL BE 2,000,000 PSI (2.0 E)

WALL DIMENSION NOTE:

ALL WALL DIMENSIONS ARE TO THE ROUGH. INTERIOR PARTITIONS ARE 3 1/2" (2x4) UNLESS NOTED OR DIMENSIONED OTHERWISE, EXTERIOR FRAME WALLS INCLUDE 1/2" NOMINAL DIMENSION FOR EXTERIOR SHEATHING. EXTERIOR FRAME WALLS ARE 4" (2x4) UNLESS NOTED OR DIMENSIONED OTHERWISE. "BRICK LEDGE" BRICK OR STONE EXTERIOR WITH AIR SPACE IS 4 1/2" UNLESS NOTED OR DIMENSIONED OTHERWISE.

TRUSS NOTES:

FLOOR TRUSS MANUFACTURER TO DESIGN FOR ADDITIONAL DEAD LOAD OF NON-BEARING DOUBLE STUD WALL(S) AND STAGGER STUD WALL(S) CONSTRUCTION.

PROVIDE VERTICAL BLOCKING ® TRUSS WEB AREA IF THERE IS SOLID BLOCKING ON THE FLOOR ABOVE.

ALL STRUCTURAL MEMBERS WHICH ARE REQUIRED TO HAVE A FIRERESISTANCE RATING AND WHICH SUPPORT MORE THAN TWO FLOORS OR ONE FLOOR AND ROOF, OR SUPPORT A LOADBEARING WALL OR A NONLOADBEARING WALL MORE THAN TWO STORIES IN HEIGHT, SHALL BE INDIVIDUALLY PROTECTED ON ALL SIDES FOR THE FULL LENGTH OR HEIGHT WITH MATERIALS HAVING THE REQUIRED FIRERESISTANCE RATING.

ELECTRICAL NOTES:

ALL RECESSED LIGHT ARE TO BE IC (INSULATION CONTACT) RATED. ALL RECESSED FIXTURES ARE TO BE SEALED TO LIMIT AIR LEAKAGE BETWEEN CONDITIONED AND UNCONDITIONED SPACES PROVIDE GROUND-FAULT CIRCUIT-INTERRUPTER PROTECTION FOR ALL 125-VOLT, SINGLE-PHASE, 15- AND 20-AMPERE RECEPTACLES INSTALLED IN GARAGES AND UNFINISHED BASEMENTS AREAS EXCEPT THOSE FOR FIRE OR BURGLAR ALARM SYSTEMS.

A MINIMUM OF 15% OF ALL PERMANENTLY INSTALLED LIGHTING FIXTURES MUST USE CFL BULBS OR OTHER HIGH EFFICIENCY LAMPS ALL INTERIOR TREADS AND LANDINGS MUST BE ILLUMINATED WITH NOT LESS THAN I FOOT CANDLE.


EXTERIOR STAIRWAYS SHALL BE PROVIDED WITH AN ARTIFICIAL LIGHT SOURCE LOCATED AT THE TOP OF THE LANDING.


MICHIGAN UNIFORM ENERGY CODE BUILDERS OPTIONS FOR COMPLIANCE: CLIMATE ZONE 5A

PROVIDE INSULATION AND PERFORMANCE VALUES AS PRESCRIBED IN SECTION 302 (PRESCRIPTIVE) 2009 M.U.E.C.

EXTERIOR ENCLOSURE	VALUE
WALL ASSEMBLIES	R-20
ROOF / CEILING	R-38
SLAB ON GRADE	R-10
CRAWL SPACE WALL (CONTINUOUS)	R-10
CRAWL SPACE WALL (CAVITY)	R-13
BASEMENT WALL (CONTINUOUS)	R-10
BASEMENT WALL (CAVITY)	R-13
FENESTRATION / OPENINGS	u-0.35
(AREA WEIGHTED AVERAGE OF THE	R-2.85
TOTAL AREA OF FENESTRATION UNITS)	
* SEE TABLE 402.1.1 FOR FOOTNOTES	

B) PROVIDE A SIMULATED ENERGY PERFORMANCE ANALYSIS (BY OTHERS) AS PRESCRIBED IN SECTION 405 (PERFORMANCE) PROVIDE INSULATION AND FENESTRATION VALUES AS REQUIRED.

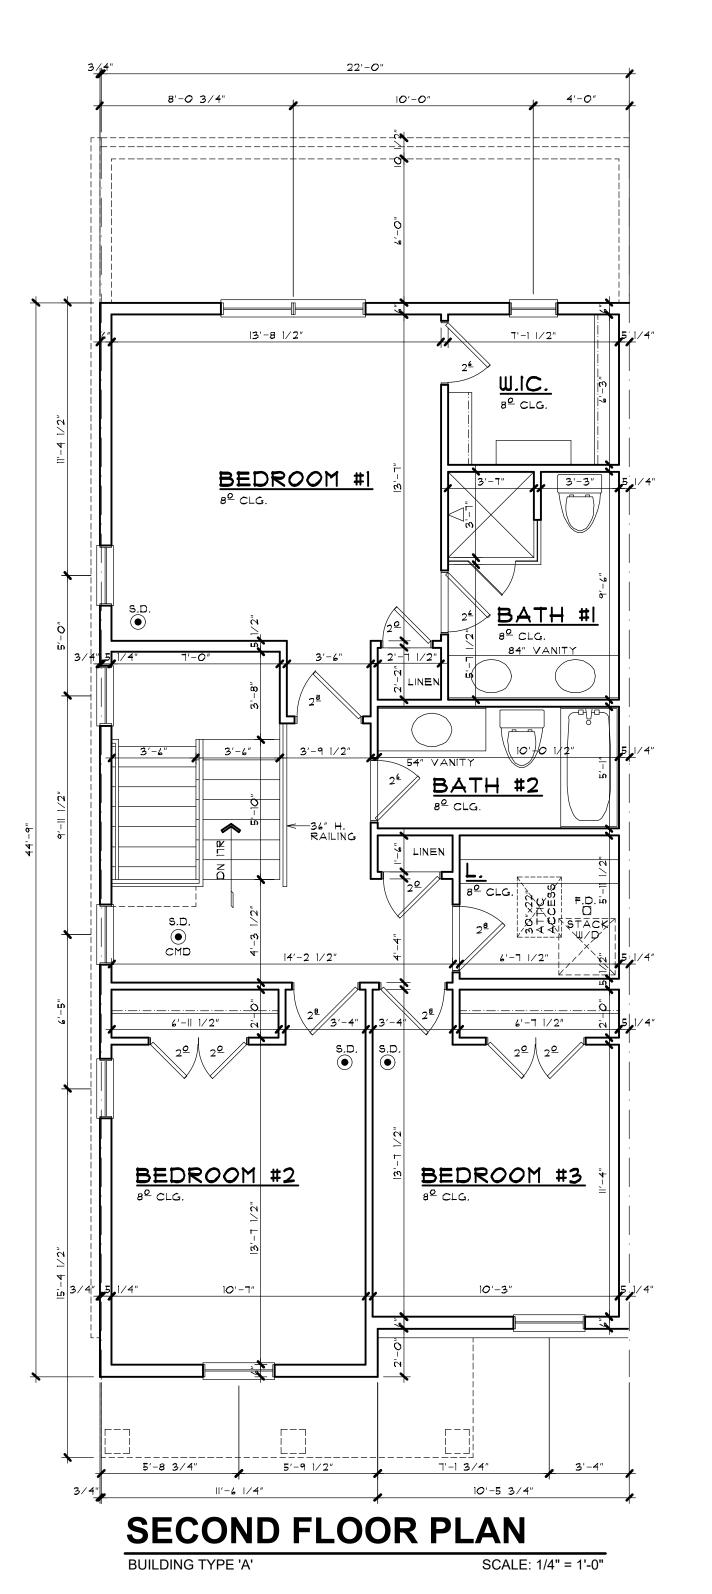

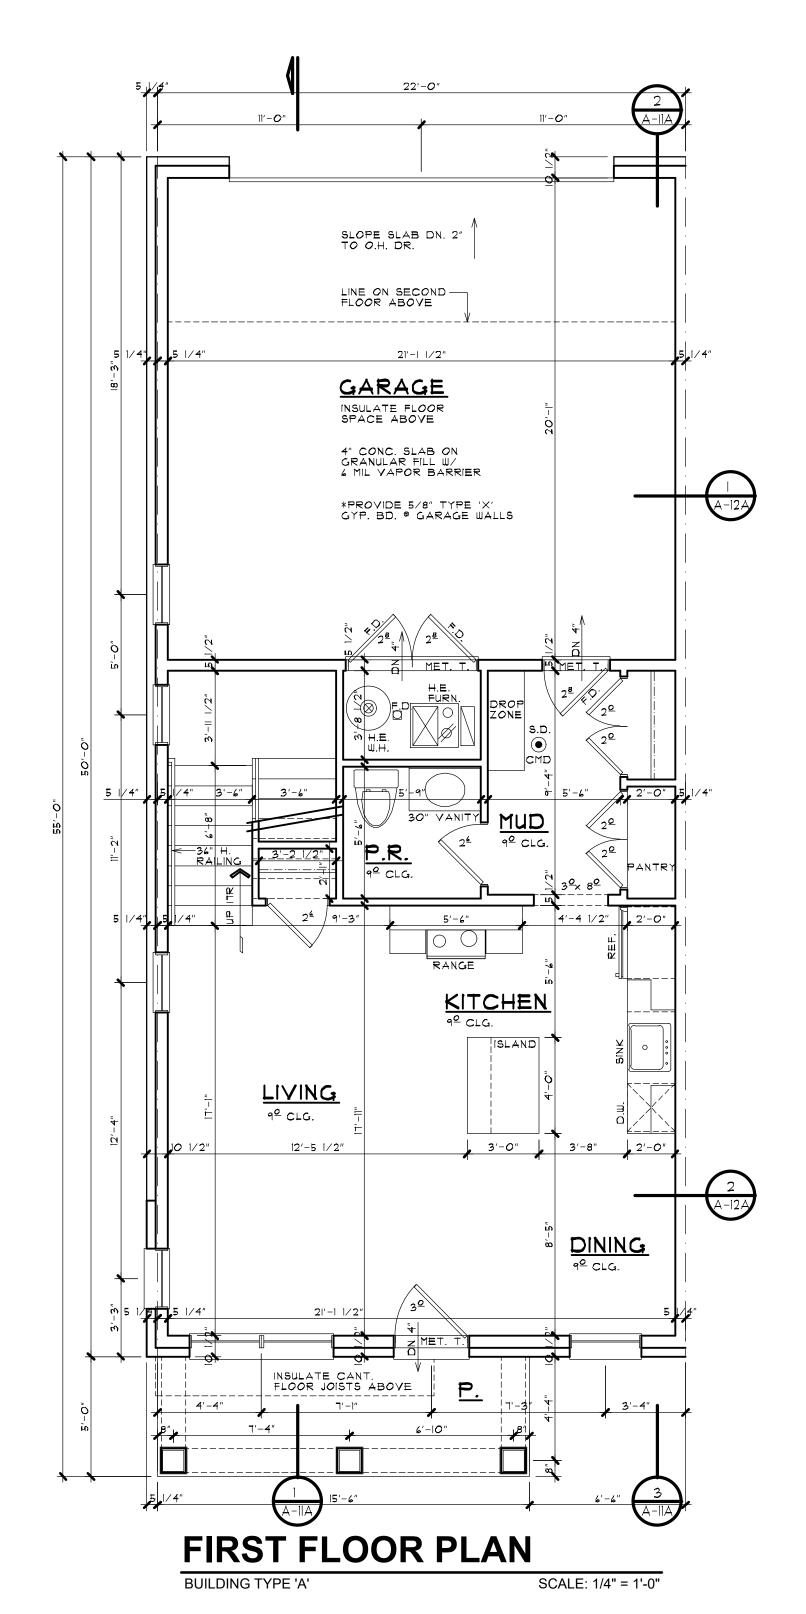

SQUARE FOOTAGE

581 SQ FT


964 SQ FT

1,545 SQ FT

IST FLOOR

2ND FLOOR

TOTAL

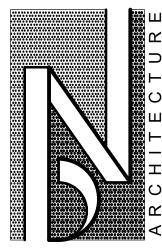

OMNHOME 'A'

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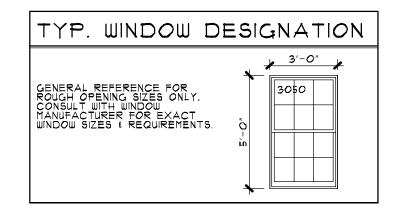
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WINDOW SILLS IN DWELLING UNITS, WHERE THE OPENING OF AN IN DWELLING UNITS, WHERE THE OPENING OF AN OPERABLE WINDOW IS LOCATED MORE THAN 12" ABOVE FINISHED GRADE OR SURFACE BELOW. THE LOWEST PART OF THE CLEAR OPENING OF THE WINDOW SHALL BE A MINIMUM OF 24 INCHES ABOVE THE FINISHED FLOOR OF THE ROOM IN WHICH THE WINDOW IS LOCATED. GLAZING BETWEEN THE FLOOR AND 24" SHALL BE FIXED OR HAVE OPENINGS THROUGH WINDOW IS A LINCH DIAMETER SPHERE CANNOT PASS WHICH A 4 INCH DIAMETER SPHERE CANNOT PASS. EXCEPTIONS: I. WINDOWS WHOSE OPENINGS WILL NOT ALLOW A 4" DIA. SPHERE TO PASS THROUGH THE OPENING WHERE THE OPENING IS IN ITS LARGEST OPENED POSITION. 2. OPENINGS THAT ARE PROVIDED WITH WINDOW GUARDS THAT COMPLY WITH ASTM F 2006 OR F 2090.

OVERHANGS & DRAINAGE PROVIDE GUTTERS & DOWNSPOUTS FOR DRAINAGE OF ROOF WATER. DOWNSPOUTS ARE TO BE CONNECTED TO STORM WATER COLLECTION SYSTEM. SEE CIVIL ENGINEER DWGs FOR CONNECTION DETAILS/LOCATIONS. DOWNSPOUT LOCATIONS ARE TO BE DETERMINED BY THE BUILDER. UNLESS NOTED OTHERWISE OVERHANG DIMENSIONS ARE 12" FROM SHEATHING. RAKE DIMENSIONS ARE 4" AT BRICK AND 6" AT SIDING.

STEEL LINTEL SCHEDULE LOOSE STEEL LINTELS FOR MASONRY - EXTERIOR ANGLES FOR BRICK OR STONE (NO FLOOR LOAD) LINTEL SIZE 5'-O" OR LESS 3 1/2" x 3 1/2" x 5/16" 7'-0" OR LESS 4" × 3 1/2" × 5/14" | 8'-0" | OR LESS | 5" x 3 1/2" x 5/14" ÖR LESS 5" x 3 1/2" x 3/8" | 10'-0" | OR LESS | 6" × 3 1/2" × 3/8"

NOTE: THIS SCHEDULE APPLIES UNLESS NOTED OTHERWISE ON THE PLANS AND/OR ELEVATIONS. NOTE: STEEL ANGLE LINTELS REQUIRE A SHOP COAT OF RUST-INHIBITIVE PAINT EXCEPT FOR LINTELS MADE OF CORROSION-RESISTANT STEEL.




EGRESS WINDOW EVERY SLEEPING ROOM SHALL HAVE AT LEAST ONE OPERABLE WINDOW OR EXTERIOR DOOR APPROVED FOR EMERGENCY EGRESS OR RESCUE. THE UNIT(S) MUST BE OPERABLE FROM THE INSIDE TO A FULL CLEAR OPENING WITHOUT THE USE OF SEPARATE TOOLS. WHERE WINDOWS ARE PROVIDED AS A MEANS OF EGRESS, OR RESCUE. THEY SHALL HAVE SILL HEIGHT OF NOT MORE THAN 44 INCHES ABOVE THE FLOOR. ALL EGRESS OR RESCUE WINDOWS FROM SLEEPING ROOMS MUST HAVE A MINIMUM NET CLEAR OPENING HEIGHT DIMENSION SHALL BE 24 NET CLEAR OPENING HEIGHT DIMENSION SHALL BE 24

GENERAL NOTES

INCHES AND WIDTH OF 20 INCHES.

- BEFORE CONSTRUCTION OBTAIN WINDOW & DOOR ROUGH OPENING SIZES FROM WINDOW/DOOR SUPPLIER . TRUSS DESIGNER/FABRICATOR SEE SHEET N-2 FOR ADDITIONAL NOTES & INFORMATION
- . DO NOT SCALE THESE DRAWINGS. USE CALCULATED DIMENSIONS. IF VARIATIONS OCCUR CONTACT ARCHITECT FOR CLARIFICATION. . SEE CIVIL ENGINEERS'S DWGs FOR ALL FINAL A/C UNIT, ELECTRICAL METER & GAS METER LOCATIONS.

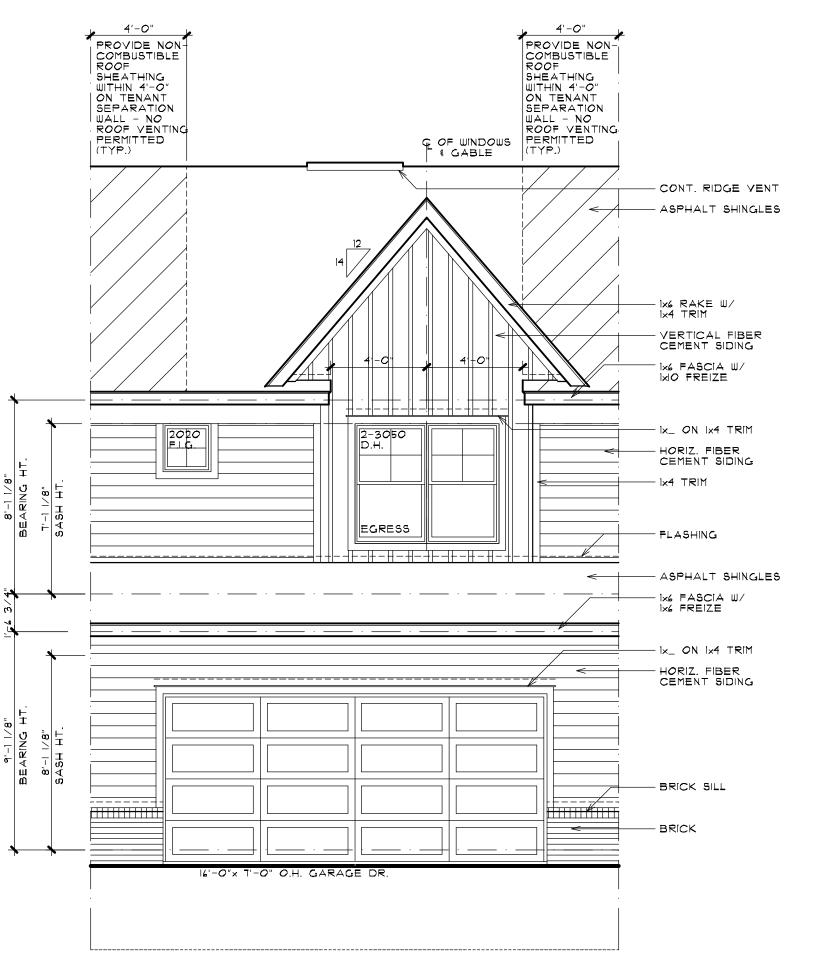



ELEVATION 'C'

SCALE: 1/4" = 1'-0"

SCALE: 1/4" = 1'-0"




6" RAKE-

LEFT SIDE ELEVATION

RIGHT SIDE OPPOSITE HAND SCALE: 1/4" = 1'-0"

ELEVATION 'A'

SCALE: 1/4" = 1'-0"

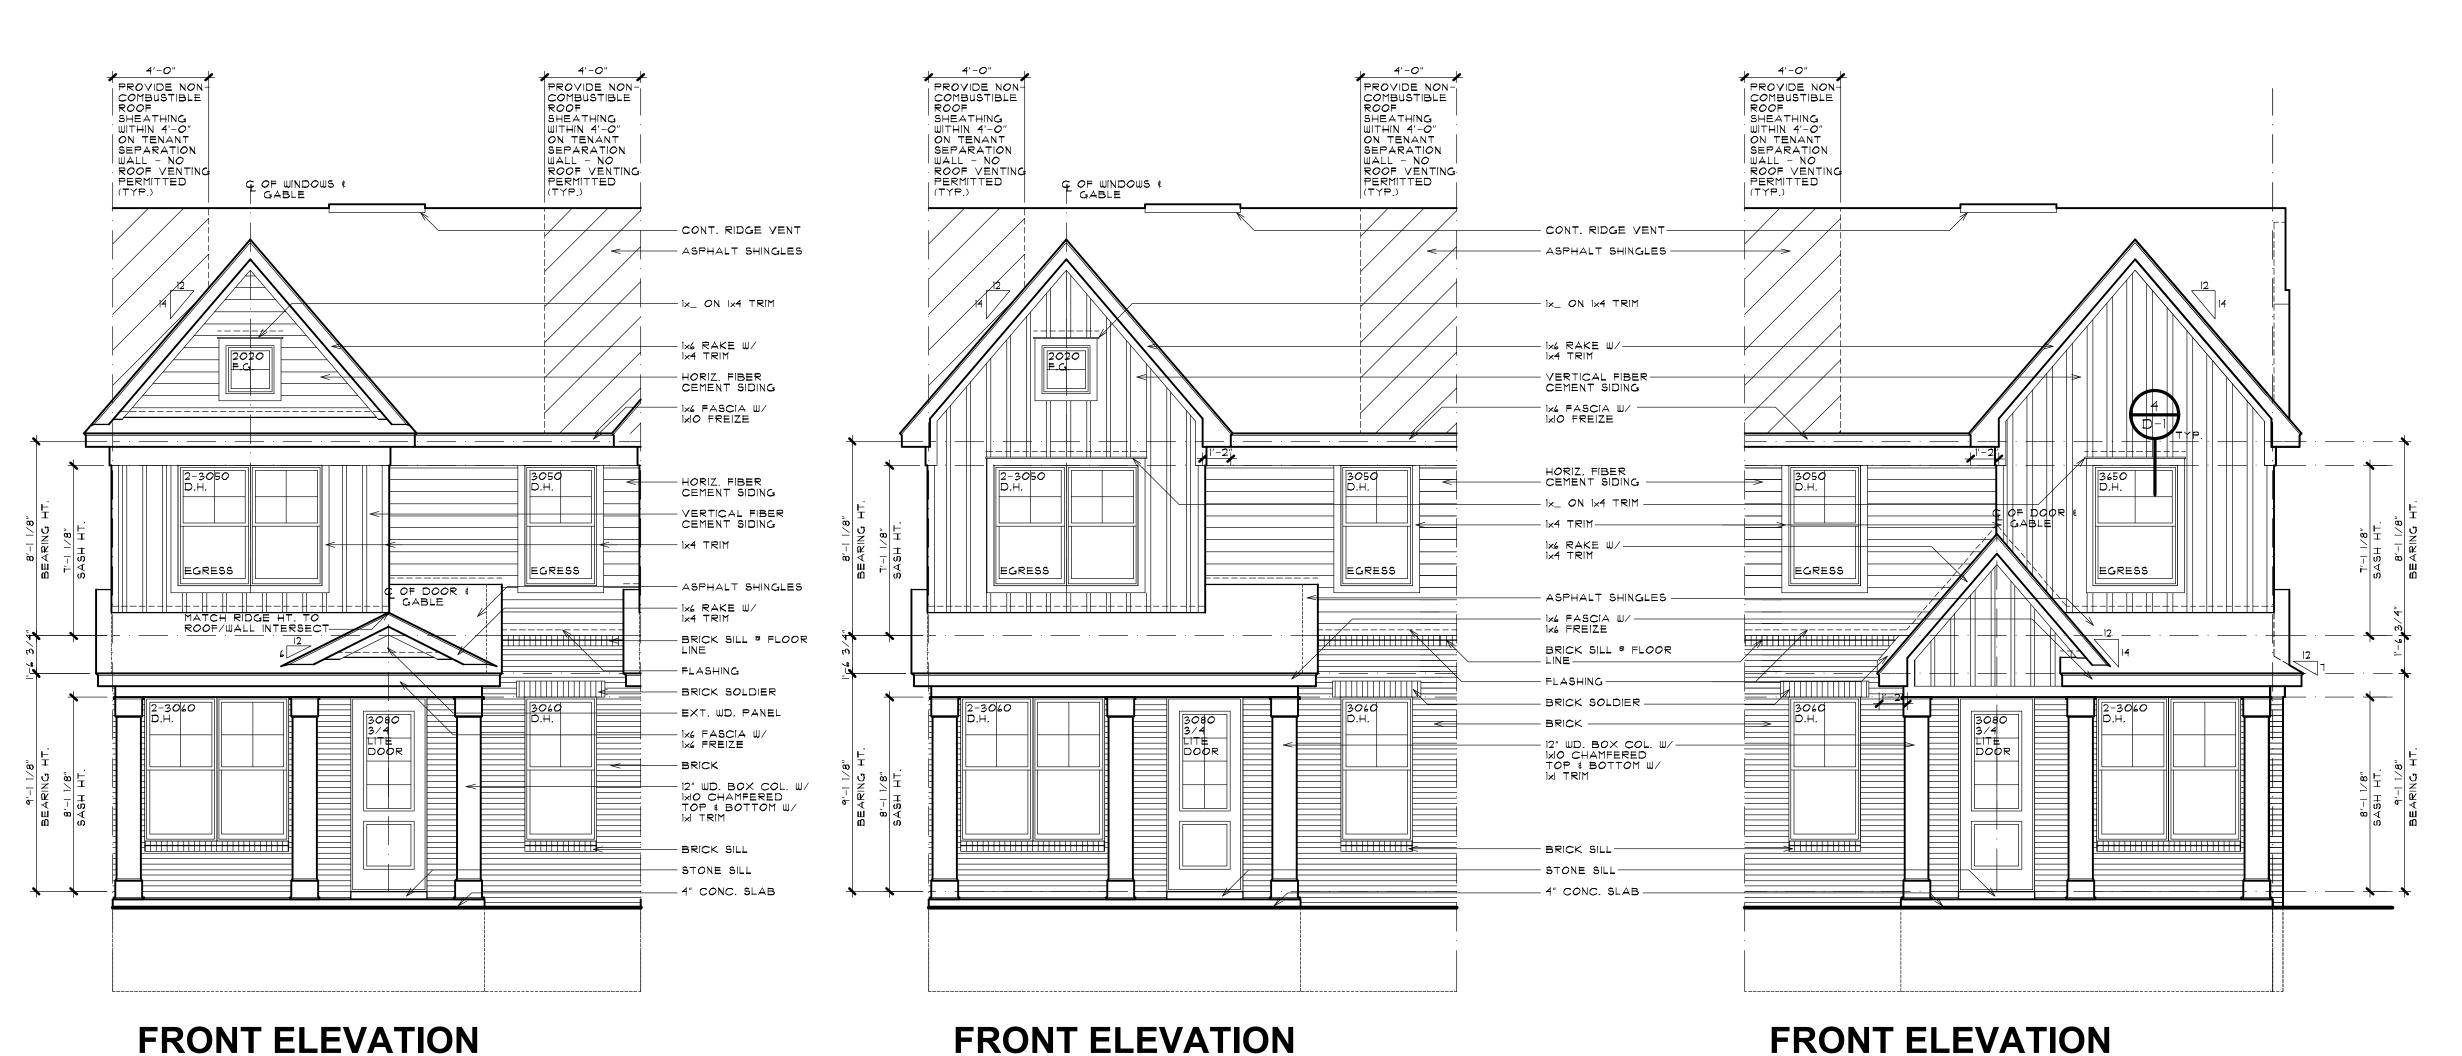

SCALE: 1/4" = 1'-0"


ELEVATION 'B'





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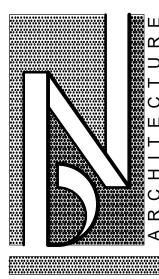
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BRIANNEEPER.COM
248. 259. 1784

BUILDING # WALLS SECTIONS
BUILDING TYPE 'A'

SUILDING TYPE 'A'

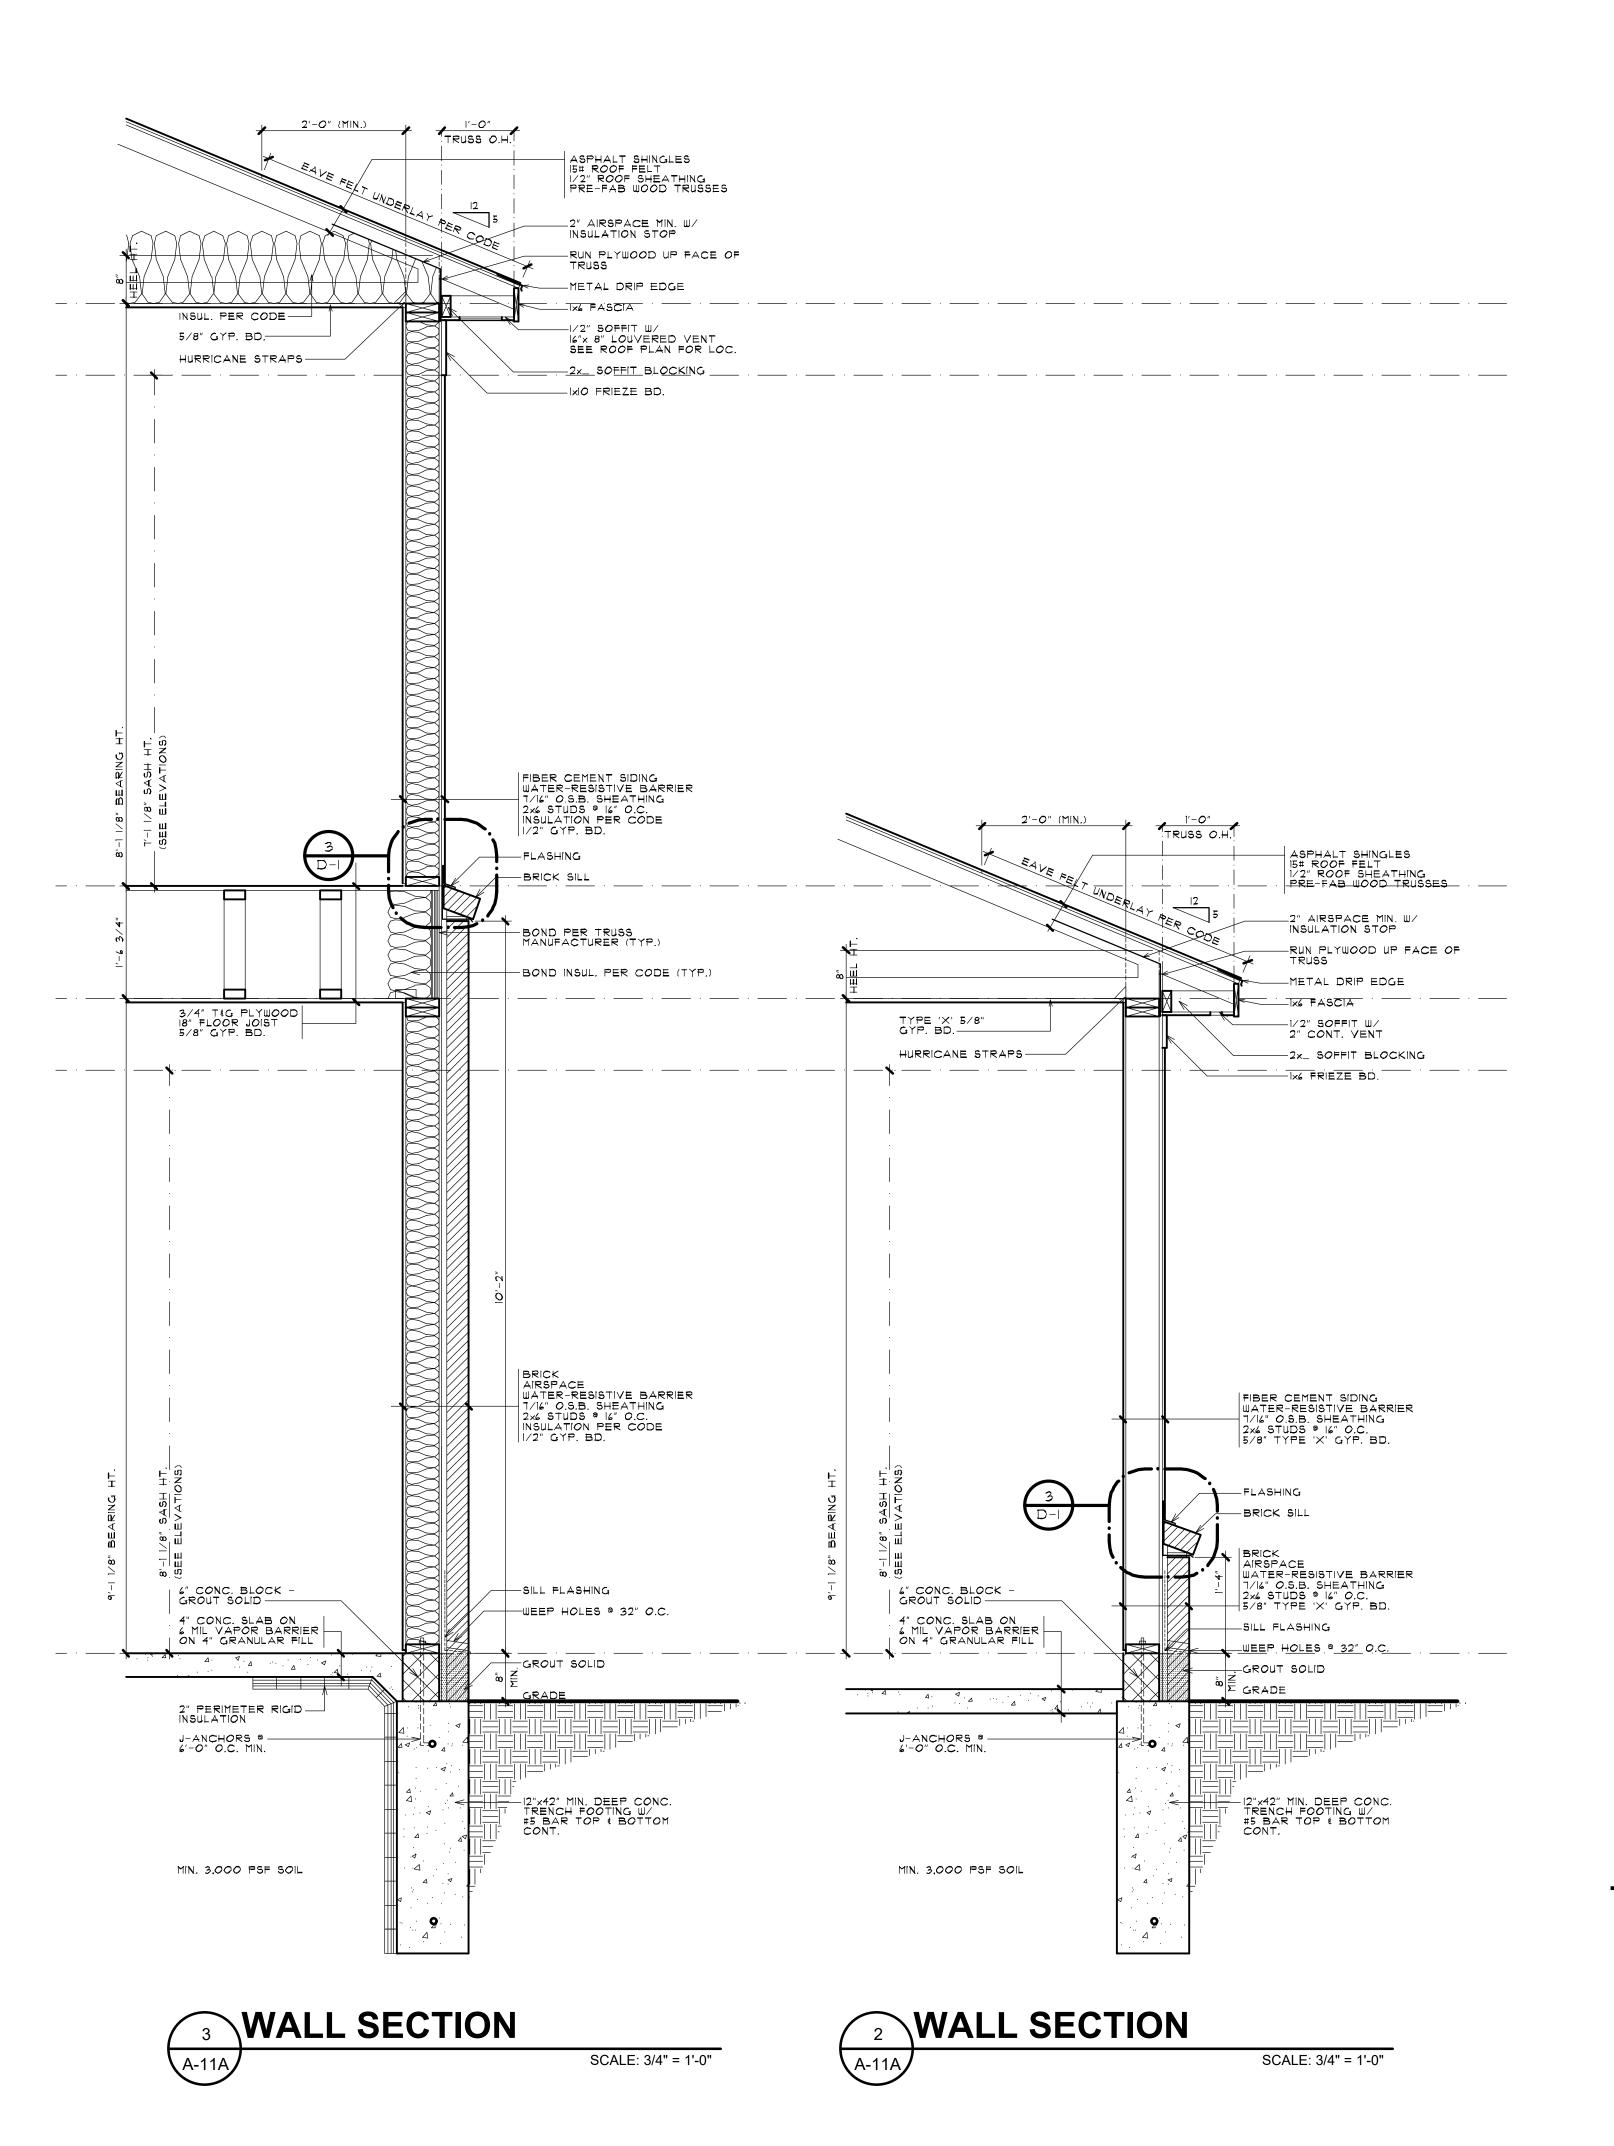BUILDING TYPE 'A'

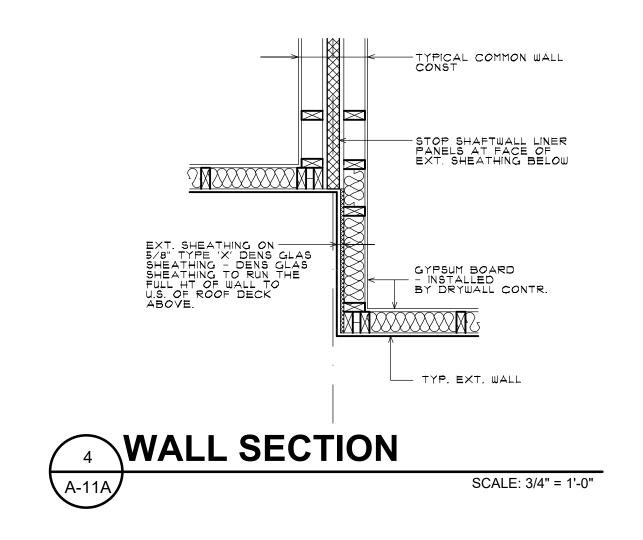TROY, MICHIGAN

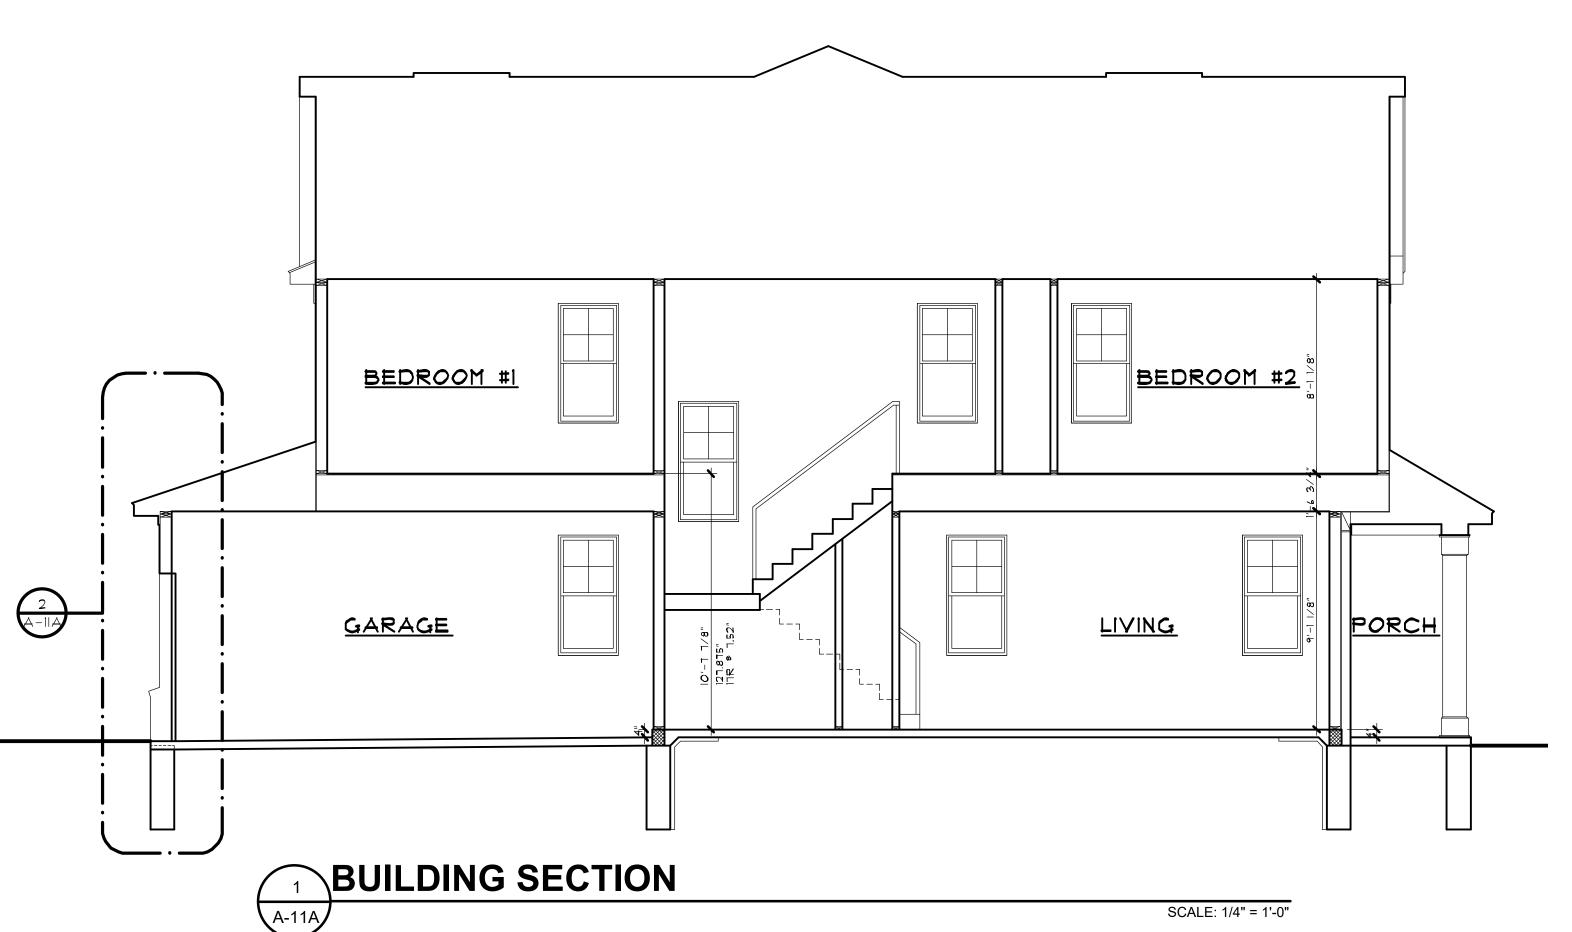PRELIMINARY
03-27-24

BIDS

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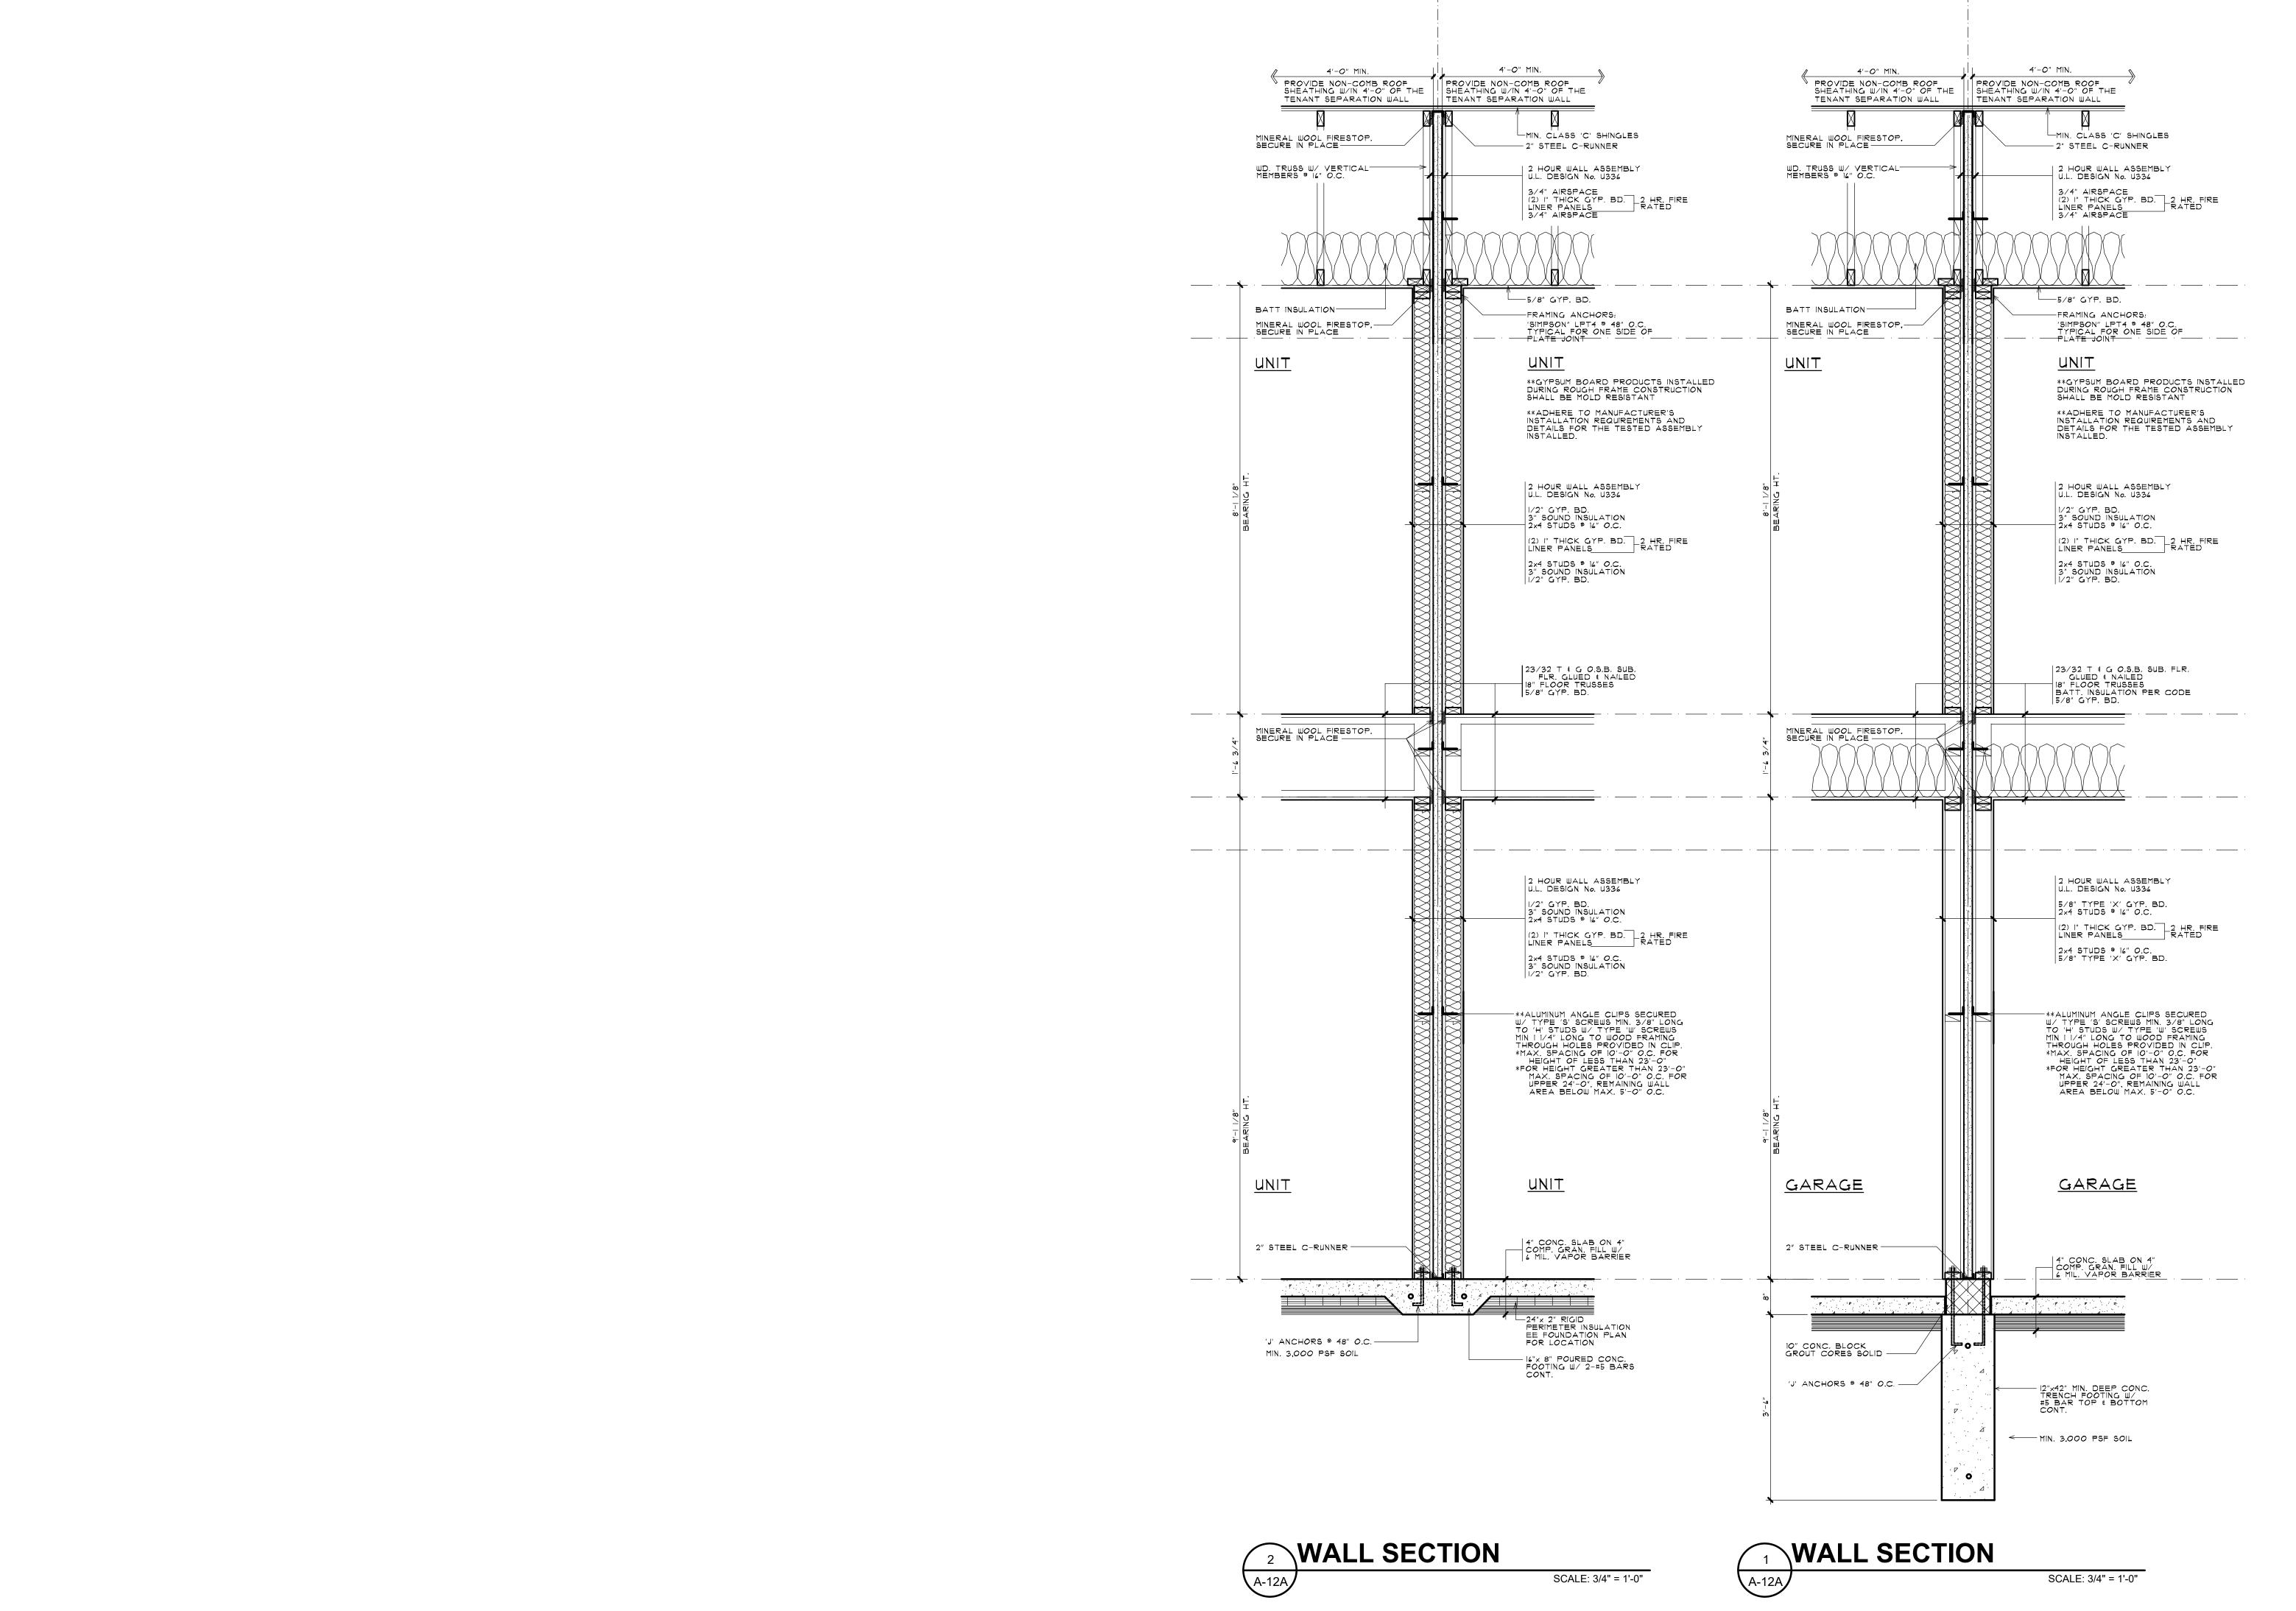
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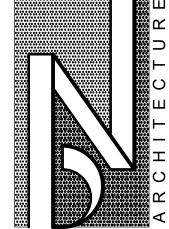
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BUILDING TYPE 'A'

JOHN R TOWNHOME DEV.
BUILDING TYPE 'A'

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A-12A



FRONT ELEVATION - BUILDING TYPE 'A'

5 - UNIT SCALE: 3/16" = 1'-0"



FRONT ELEVATION - BUILDING TYPE 'A'

6 - UNIT SCALE: 3/16" = 1'-0" ARCHITECTURE

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RENDERED FRONT BUILDING ELEVATIONS BUILDING TYPE 'A' PRELIMINARY

JOHN R TOWNHOME DE BUILDING TYPE 'A'

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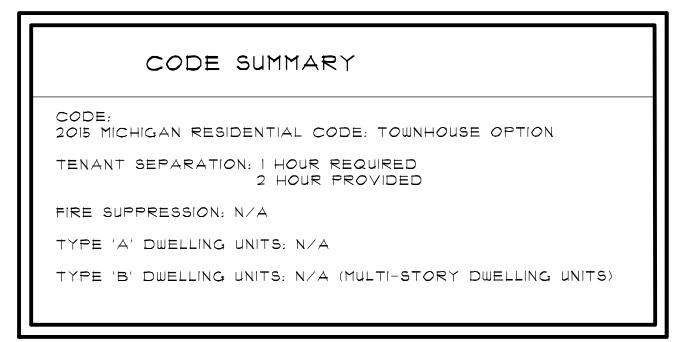
SHEET NUMBER

A-13A

JOHN R. TOWNHOME DEVELOPMENT

BUILDING TYPE 'B'

TROY, MICHIGAN



	SHEET INDEX
T-I	TITLE SHEET
ARCHITECTURAL DRAWINGS	
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A-2B	O.A. BUILDING FIRST & SECOND FLOOR PLANS - 6 UNIT
A-3B	O.A. BUILDING ROOF PLAN - 6 UNIT
A-4B	O.A. BUILDING ELEVATIONS - 6 UNIT
A-5B	DWELLING UNIT PLANS
A-6B	UNIT ELEVATIONS
A-1B	BUILDING SECTION & EXTERIOR WALL SECTIONS
A-8B	INTERIOR WALL SECTIONS
A-9B	RENDERED FRONT ELEVATIONS






ARCHITECT:

BRIAN NEEPER ARCHITECTURE P.C. 630 N. OLD WOODWARD, SUITE 203

BIRMINGHAM, MICHIGAN 48009 248. 259. 1784

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TITLE SHEET

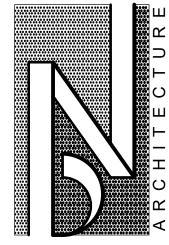JOHN R TOWNHOME DEV.
BUILDING TYPE 'B'
TROY, MICHIGAN

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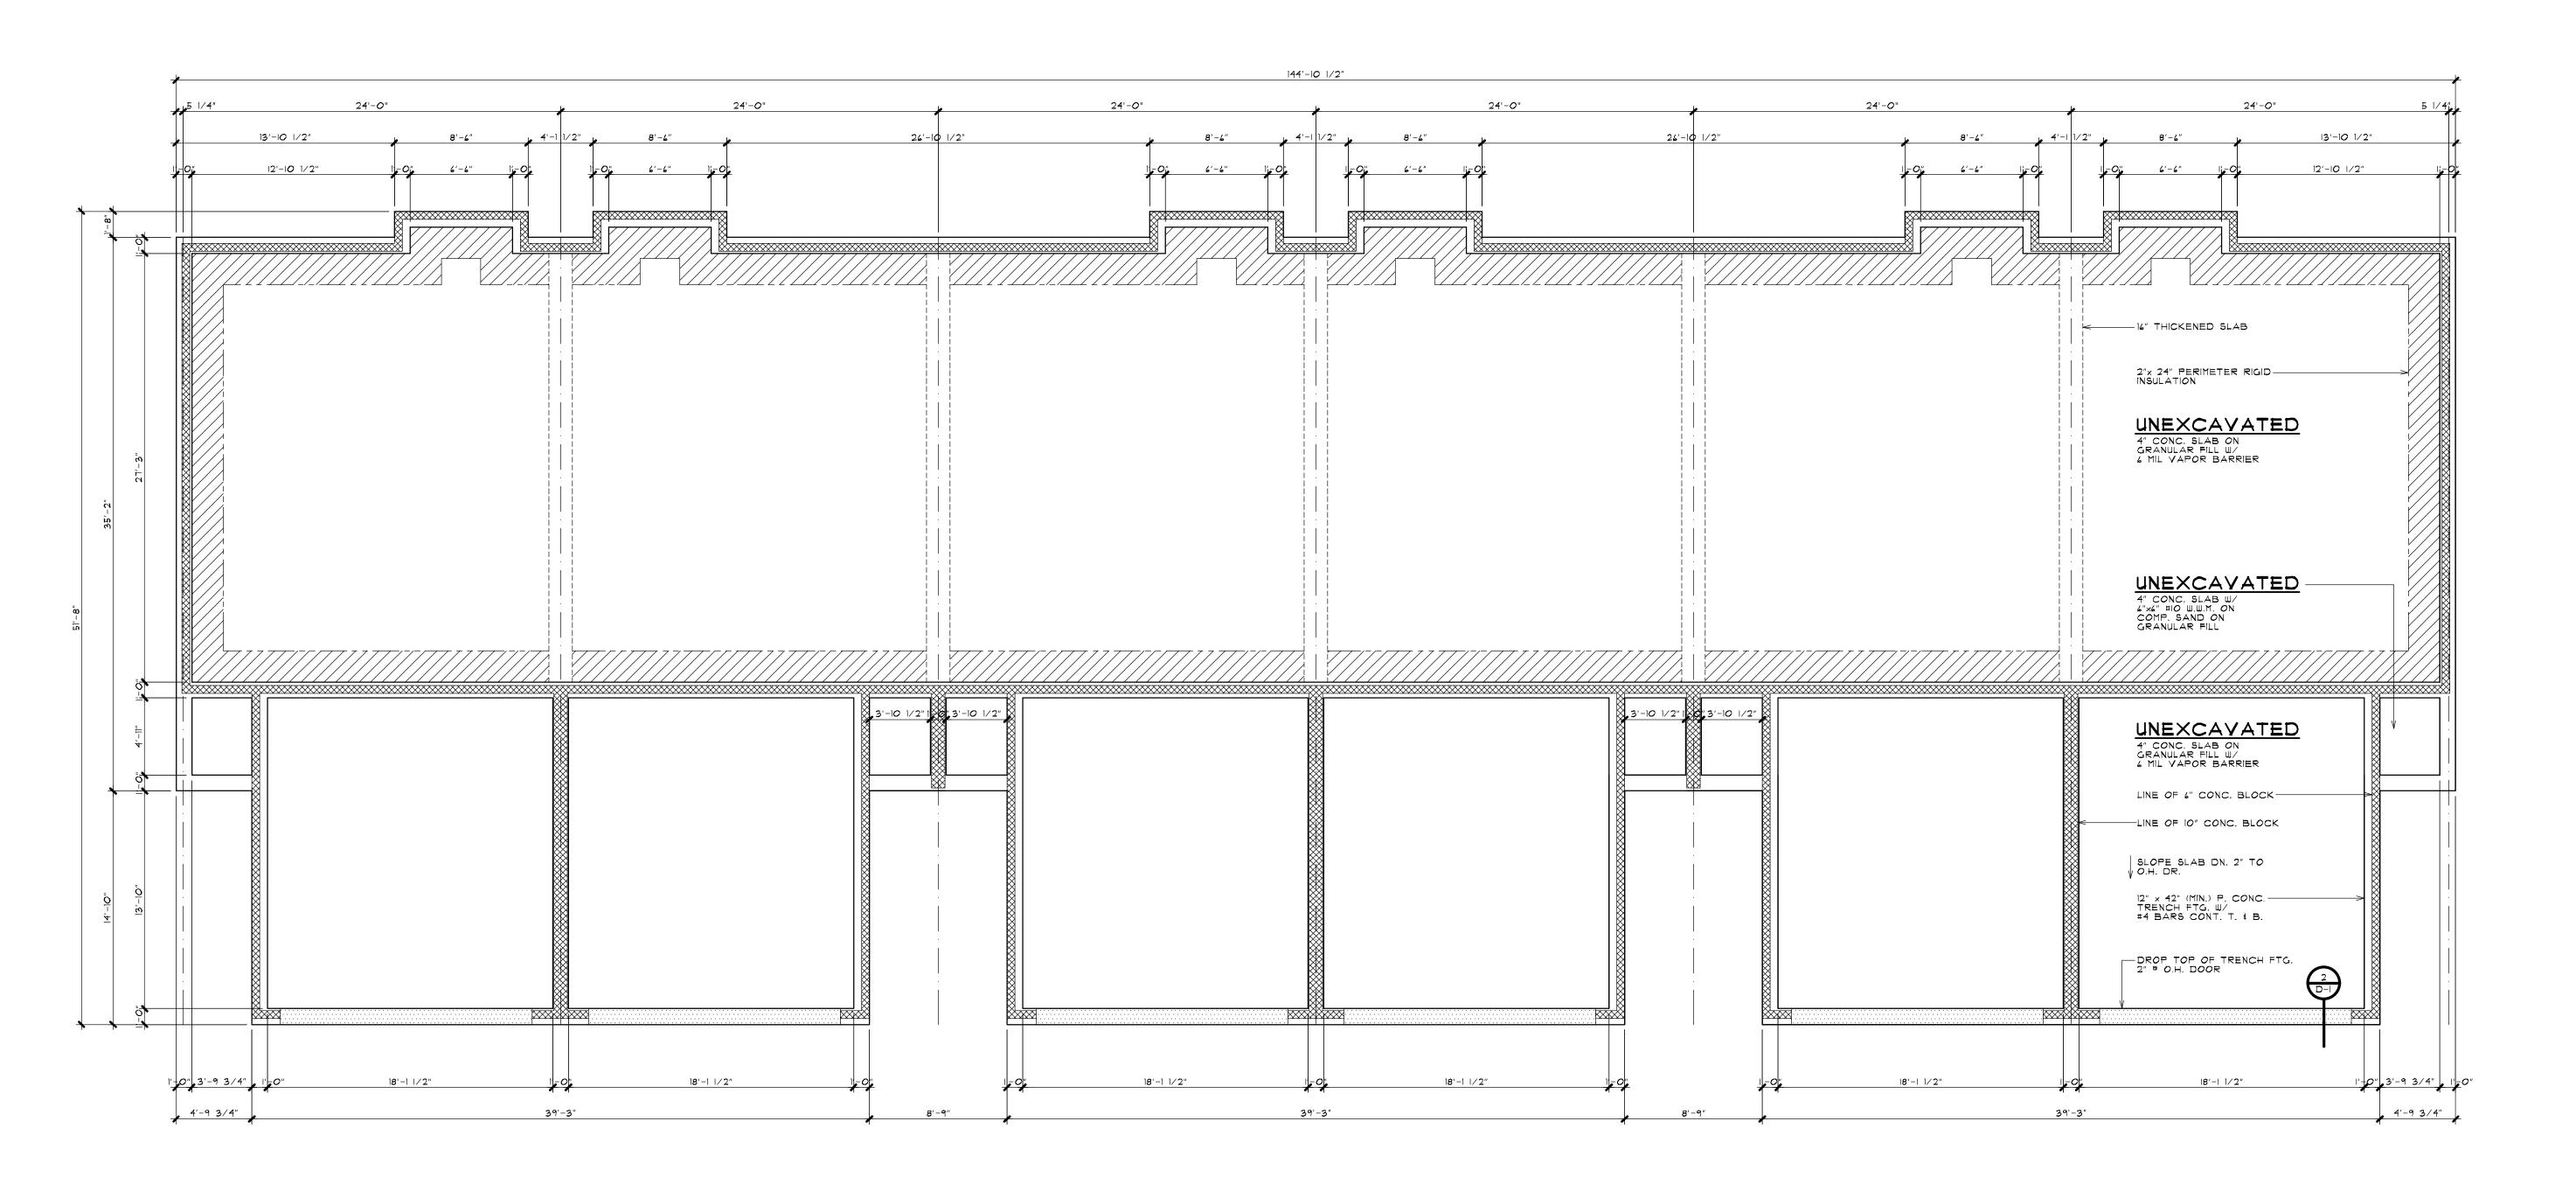
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FOUNDATION PLAN - BUILDING TYPE 'B'

6 - UNIT SCALE: 3/16" = 1'-0"

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FOUNDATION PLAN
BLDG, TYPE 'B'-6 UNI

JOHN R TOWNHOME DE BUILDING TYPE 'B'

TROY, MICHIGAN

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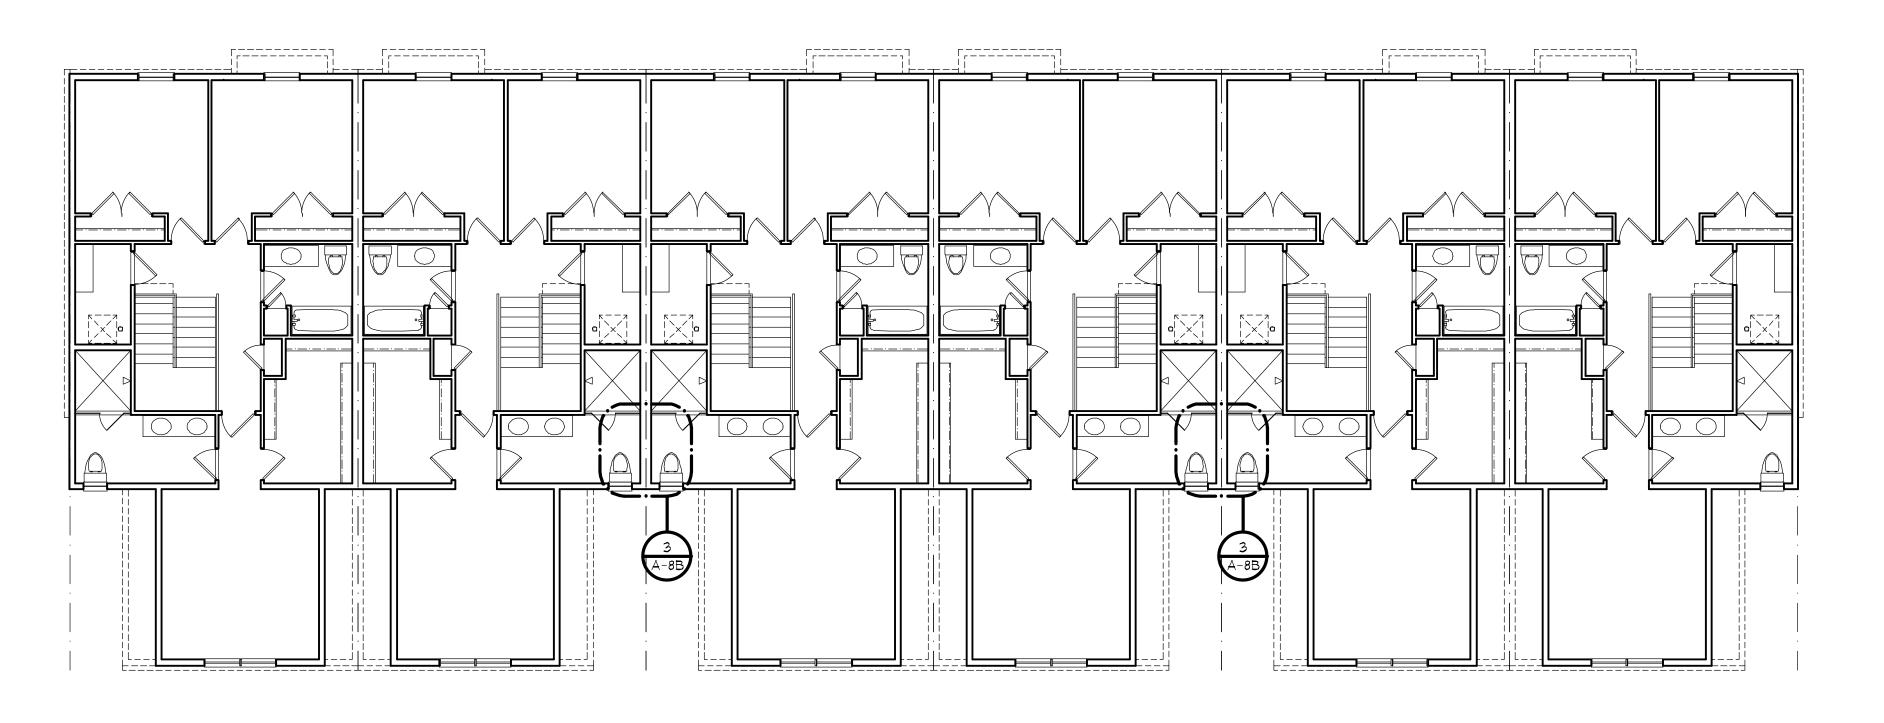
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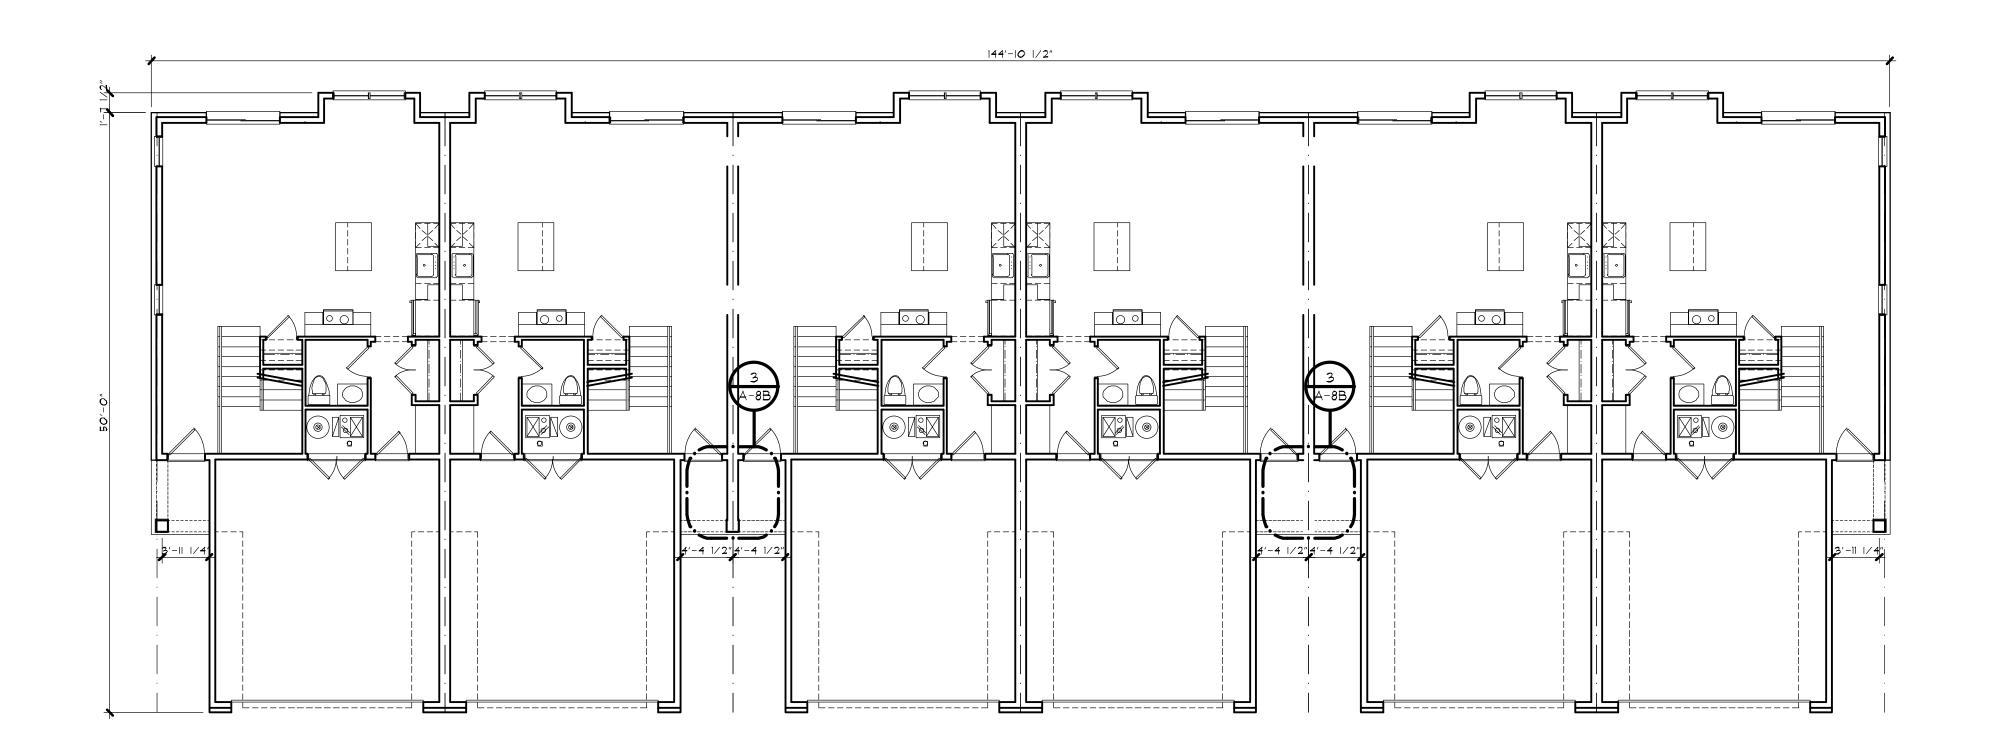
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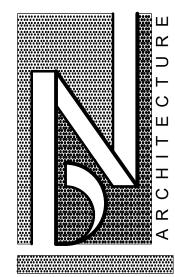






FIRST FLOOR PLAN - BUILDING TYPE 'B'

6 - UNIT SCALE: 1/8" = 1'-0"



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lst \$ 2nd FLOOR PLA BLDG, TYPE 'B'-6 Ul

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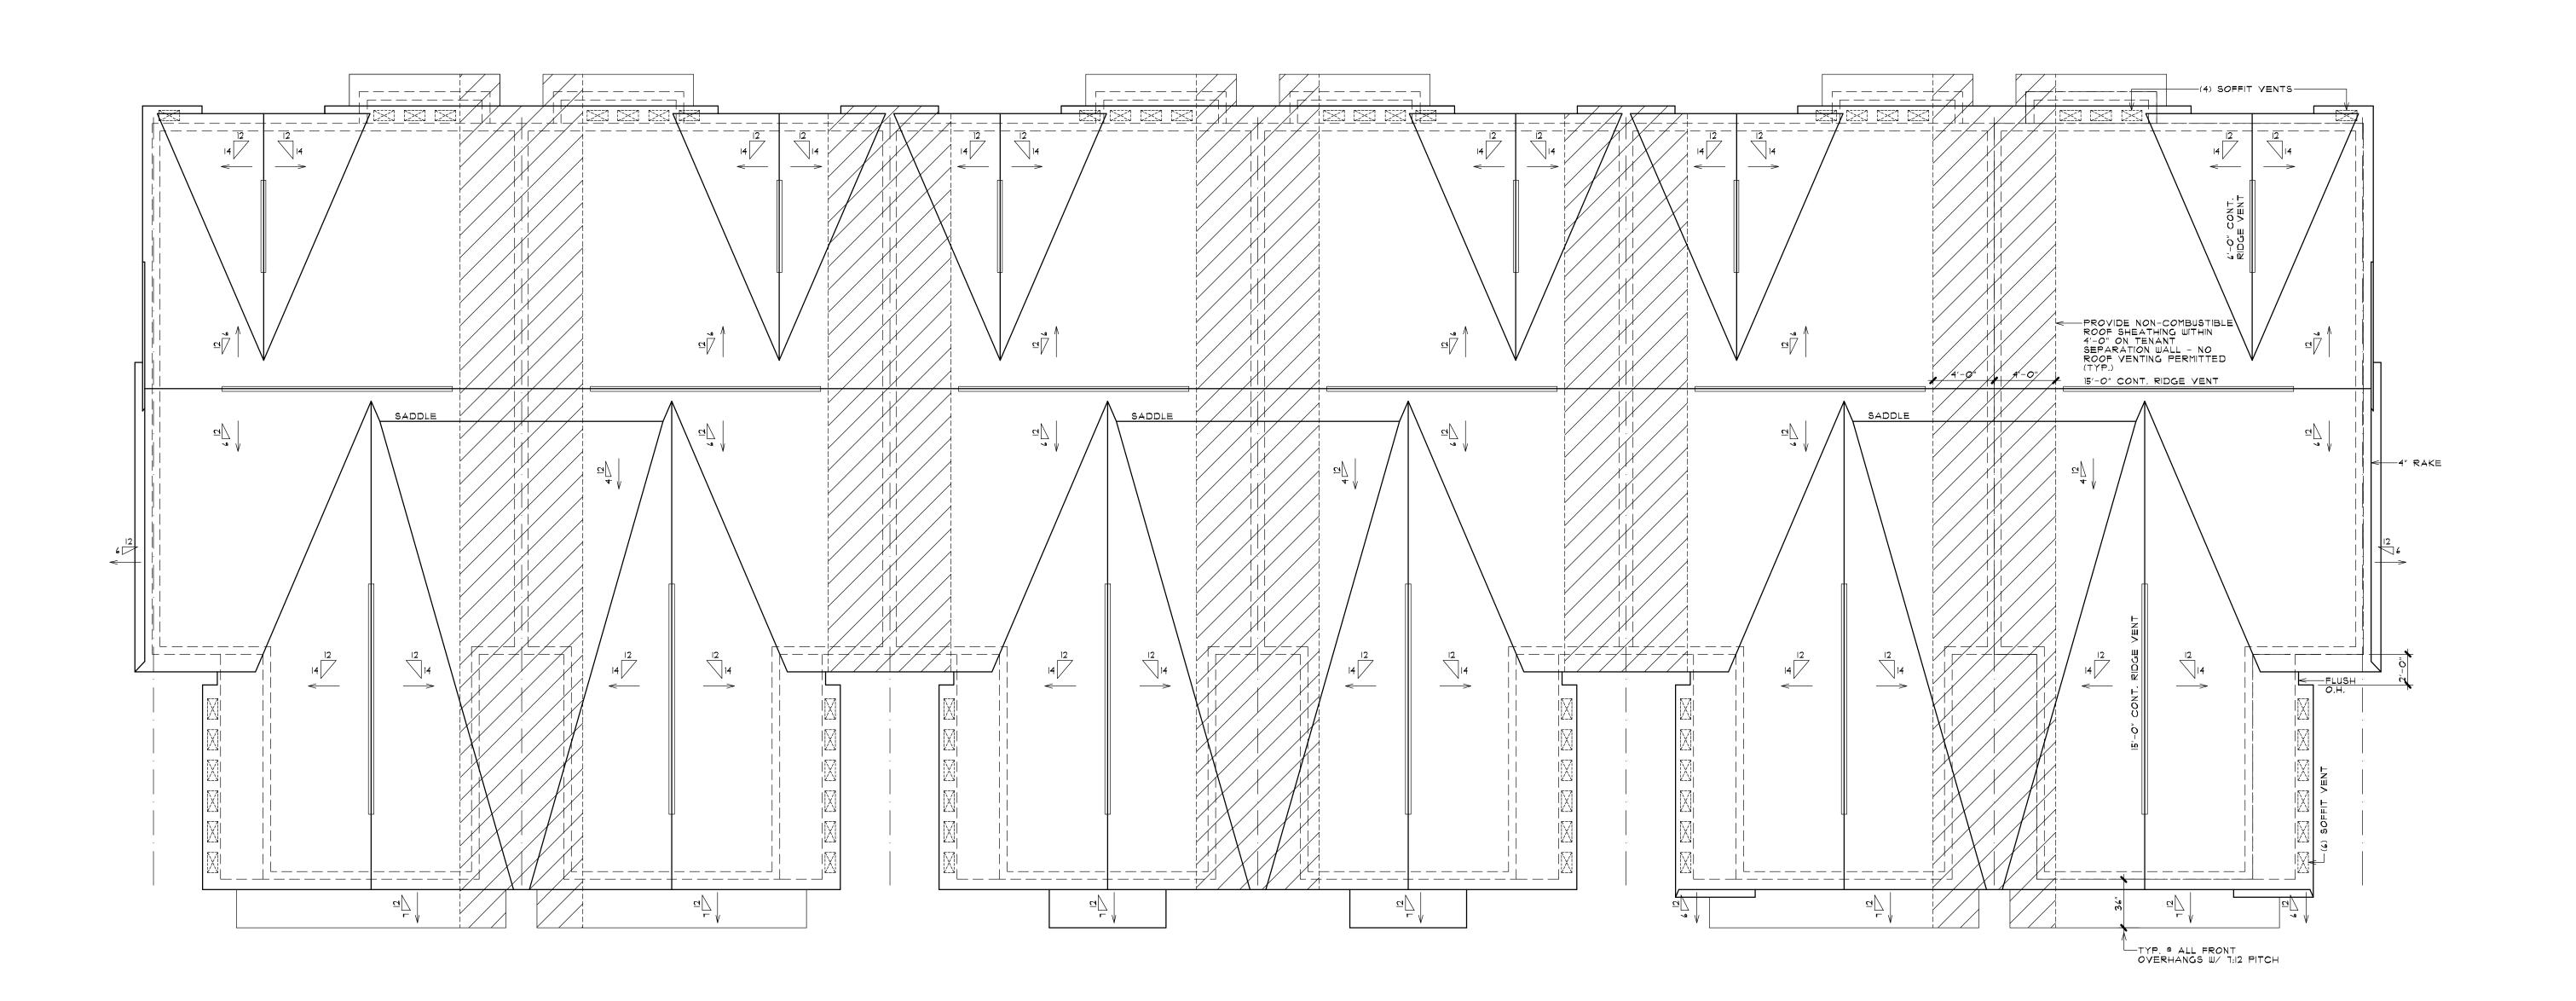
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TOTAL VENTING AT SOFFIT = 18 SQ.IN.

OVERHANGS & DRAINAGE

PROVIDE GUTTERS & DOWNSPOUTS FOR DRAINAGE OF ROOF WATER. DOWNSPOUTS ARE TO BE CONNECTED TO STORM WATER COLLECTION SYSTEM. SEE CIVIL ENGINEER DWGs FOR CONNECTION DETAILS/LOCATIONS. DOWNSPOUT LOCATIONS ARE TO BE DETERMINED BY THE



ROOF PLAN - BUILDING TYPE 'B'

6 - UNIT SCALE: 3/16" = 1'-0"

ATTIC AREA = <u>1.039</u> Sq.ft. (1/150) Vent area = <u>6.9</u> Sq.ft. x 144 = <u>**994**</u> Sq.in.

CONT. RIDGE TYPE @ 18 SQ.IN. PER FT. = 36 LIN.FT.

TOTAL VENTING AT RIDGE = <u>648</u> SQ.IN.

16"x 8" SOFFIT VENT ® **50** SQ.IN. PER UNIT = **10** UNITS

PROPOSED VENT AREA PER UNIT ® LOWER ROOF (DINING)

VENT AREA = O.II Sq.ft. x 144 = I6 Sq.in. 50% SOFFIT AND 50% RIDGE = 8 SQ.IN. EACH

VENT AREA PROVIDED ® RIDGE

OMNI-WALL VENT ® 9 SQ.IN. PER FT. = 2 LIN.FT. TOTAL VENTING AT RIDGE = 18 SQ.IN.

VENT AREA PROVIDED ® SOFFIT

CONTINUOUS SOFFIT TYPE 0 9 SQ.IN. PER FT. = 2 LIN.FT.

UNLESS NOTED OTHERWISE OVERHANG DIMENSIONS ARE 12" FROM SHEATHING. RAKE DIMENSIONS ARE 4" AT BRICK AND 6" AT SIDING.

ROOF BLDG. OWNHOME 'B'


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FRONT ELEVATION - BUILDING TYPE 'B'

6 - UNIT SCALE: 1/8" = 1'-0" ARCHIFCTURE

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D.A. BUILDING ELEVATIO BUILDING TYPE 'B' 6-UN

JOHN R TOWNHOME DEV
BUILDING TYPE 'B'
TROY, MICHIGAN

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STRUCTURAL NOTES:

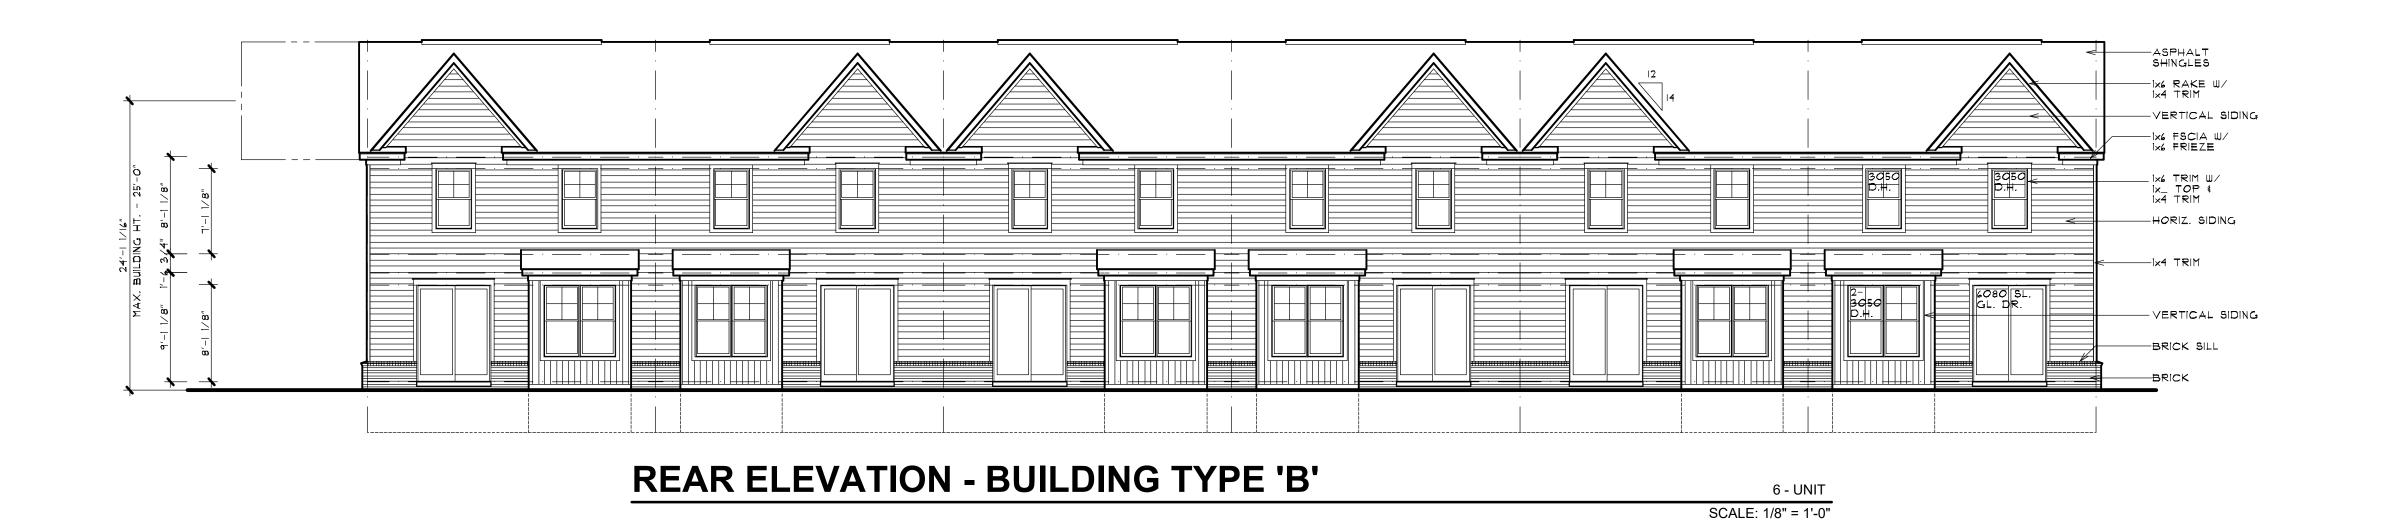(2) 2×8 Headers to bear on (1) one jack stud unless noted otherwise,

(2) 2x10 & LARGER HEADERS TO BEAR ON (2) TWO JACK STUDS UNLESS NOTED OTHERWISE.

ALL PRE-ENGINEERED HEADERS FRAMED PERPENDICULAR TO WALL LINE SHALL BEAR ON REQUIRED NUMBER OF STUDS TO MATCH WIDTH OF HEADER MATERIAL.

ALL PRE-ENGINEERED HEADERS FRAMED PARALLEL TO WALL LINE SHALL BEAR ON A MINIMUM (2) TWO JACK STUDS UNLESS NOTED OTHERWISE.

ALL PRE-ENGINEERED LUMBER HEADERS SHALL BE BUILT-UP FROM THE NUMBER OF HEADERS INDICATED ON DRAWINGS. ALL MEMBERS SHALL BE SECURED WITH NAILS OR BOLTS AS SPECIFIED BY THE MANUFACTURER FOR SIZES INDICATED.

MANUFACTURER FOR SIZES INDICATED.

ALL GIRDER TRUSSES TO BEAR ON (2) TWO STUDS MINIMUM OR AS REQUIRED TO MATCH NUMBER OF TRUSS PLYS, WHICH EVER IS

TRUSS FABRICATOR/CONTRACTOR TO PROVIDE ALL HANGERS W/MODEL No. CLEARLY STAMPED & LAYOUT DRAWINGS CLEARLY INDICATING LOCATION OF VARIOUS HANGERS REQUIRED.

CARPENTER CONTRACTOR TO INSTALL NAIL SIZES & NUMBER REQ'D. AS SPECIFIED FOR EACH TYPE OF HANGER.

LVL DESIGN VALUES FOR MODULUS OF ELASTICITY (E) SHALL BE 2,000,000 PSI (2.0 E)

WALL DIMENSION NOTE:

ALL WALL DIMENSIONS ARE TO THE ROUGH. INTERIOR PARTITIONS ARE 3 1/2" (2x4) UNLESS NOTED OR DIMENSIONED OTHERWISE. EXTERIOR FRAME WALLS INCLUDE 1/2" NOMINAL DIMENSION FOR EXTERIOR SHEATHING. EXTERIOR FRAME WALLS ARE 6" (2x6) UNLESS NOTED OR DIMENSIONED OTHERWISE. "BRICK LEDGE" BRICK OR STONE EXTERIOR WITH AIR SPACE IS 4 1/2" UNLESS NOTED OR DIMENSIONED OTHERWISE.

TRUSS NOTES:

FLOOR TRUSS MANUFACTURER TO DESIGN FOR ADDITIONAL DEAD LOAD OF NON-BEARING DOUBLE STUD WALL(S) AND STAGGER STUD WALL(S) CONSTRUCTION.

PROVIDE VERTICAL BLOCKING DETRUSS WEB AREA IF THERE IS SOLID BLOCKING ON THE FLOOR ABOVE.

ALL STRUCTURAL MEMBERS WHICH ARE REQUIRED TO HAVE A FIRERESISTANCE RATING AND WHICH SUPPORT MORE THAN TWO FLOORS OR ONE FLOOR AND ROOF, OR SUPPORT A LOADBEARING WALL OR A NONLOADBEARING WALL MORE THAN TWO STORIES IN HEIGHT, SHALL BE INDIVIDUALLY PROTECTED ON ALL SIDES FOR THE FULL LENGTH OR HEIGHT WITH MATERIALS HAVING THE REQUIRED FIRERESISTANCE RATING.

ELECTRICAL NOTES:

ALL RECESSED LIGHT ARE TO BE IC (INSULATION CONTACT) RATED.

ALL RECESSED FIXTURES ARE TO BE SEALED TO LIMIT AIR
LEAKAGE BETWEEN CONDITIONED AND UNCONDITIONED SPACES

PROVIDE GROUND-FAULT CIRCUIT-INTERRUPTER PROTECTION FOR
ALL 125-VOLT, SINGLE-PHASE, 15- AND 20-AMPERE RECEPTACLES
INSTALLED IN GARAGES AND UNFINISHED BASEMENTS AREAS
EXCEPT THOSE FOR FIRE OR BURGLAR ALARM SYSTEMS.

A MINIMUM OF 15% OF ALL PERMANENTLY INSTALLED LIGHTING FIXTURES MUST USE CFL BULBS OR OTHER HIGH EFFICIENCY LAMPS ALL INTERIOR TREADS AND LANDINGS MUST BE ILLUMINATED WITH NOT LESS THAN I FOOT CANDLE.


EXTERIOR STAIRWAYS SHALL BE PROVIDED WITH AN ARTIFICIAL LIGHT SOURCE LOCATED AT THE TOP OF THE LANDING.

MICHIGAN UNIFORM ENERGY CODE BUILDERS OPTIONS FOR COMPLIANCE: CLIMATE ZONE 5A

PROVIDE INSULATION AND PERFORMANCE VALUES AS PRESCRIBED IN SECTION 302 (PRESCRIPTIVE) 2009 M.U.E.C.

EXTERIOR ENCLOSURE	VALUE
WALL ASSEMBLIES	R-20
ROOF / CEILING	R-38
SLAB ON GRADE	R-10
CRAWL SPACE WALL (CONTINUOUS) CRAWL SPACE WALL (CAVITY)	R-10 R-13
BASEMENT WALL (CONTINUOUS)	R-10
BASEMENT WALL (CAVITY)	R-13
FENESTRATION / OPENINGS	U-0.35
(AREA WEIGHTED AVERAGE OF THE	R-2.85
TOTAL AREA OF FENESTRATION UNITS)	
* SEE TABLE 402.1.1 FOR FOOTNOTES	

B) PROVIDE A SIMULATED ENERGY PERFORMANCE ANALYSIS
(BY OTHERS) AS PRESCRIBED IN SECTION 405 (PERFORMANCE)
PROVIDE INSULATION AND FENESTRATION VALUES AS REQUIRED.

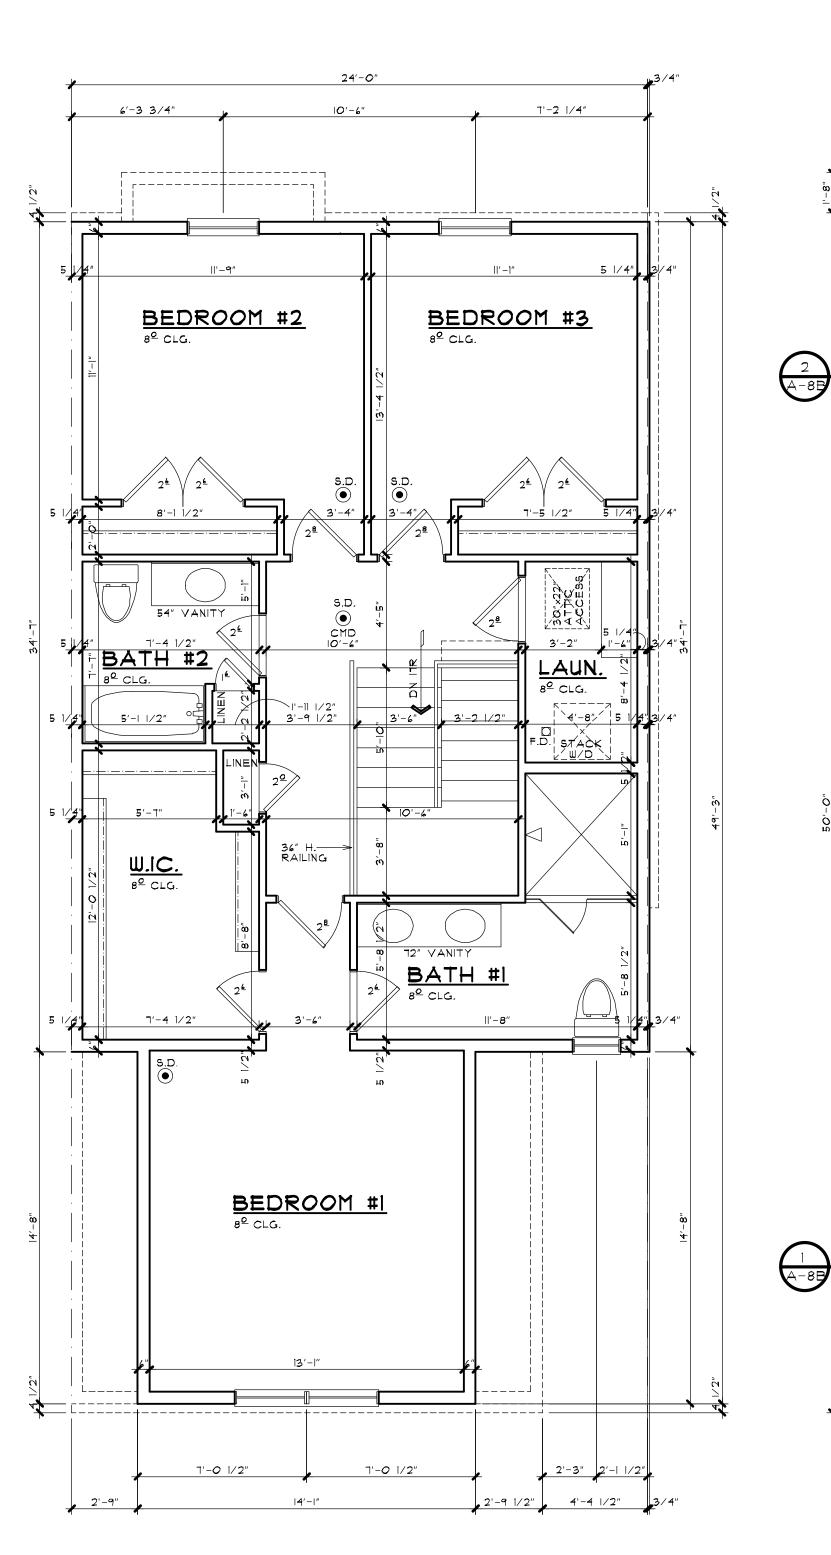

SECOND FLOOR PLAN

BUILDING TYPE 'B' SCALE: 1/4" = 1'-0"

FIRST FLOOR PLAN

19'-7 1/2"

BUILDING TYPE 'B'

9'-9 1/2"

DINING

ISLAND

5'-4" N

24 24 40.

18'-8 1/4"

GARAGE

INSULATE FLOOR SPACE ABOVE

SLOPE SLAB DN. 2" TO O.H. DR.

LINE ON SECOND -FLOOR ABOVE

*PROVIDE 5/8" TYPE 'X' GYP. BD. ® GARAGE WALLS

4" CONC. SLAB ON Granular fill W/ 6 Mil Vapor Barrier

9º CLG.


ZONE

SCALE: 1/4" = 1'-0"

4'-4 1/2"

LIVING

COLLABE EQOTACE			
SQUARE FOOTAGE			
ST FLOOR	650 SQ FT		
2ND FLOOR	1,037 SQ FT		
TOTAI	1487 SQ FT		

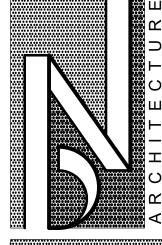

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IGN - PLANNING - INTERIORS
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BIRMINGHAM, MICHIGAN
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WELLING UNIT PLANS

LINE OF UNIT COMMON WALL SHARED ENTRIES

> JOHN R TOWNHOME DEV BUILDING TYPE 'B' TROY, MICHIGAN

PRELIMINARY
03-27-24
BIDS
PERMITS

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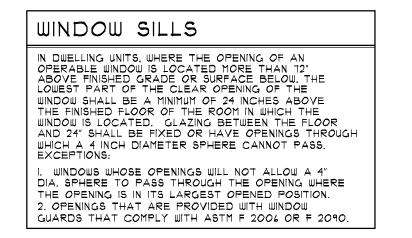
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OVERHANGS & DRAINAGE


PROVIDE GUTTERS & DOWNSPOUTS FOR DRAINAGE OF
ROOF WATER. DOWNSPOUTS ARE TO BE CONNECTED TO
STORM WATER COLLECTION SYSTEM. SEE CIVIL ENGINEER
DWGS FOR CONNECTION DETAILS/LOCATIONS. DOWNSPOUT
LOCATIONS ARE TO BE DETERMINED BY THE BUILDER.

UNLESS NOTED OTHERWISE OVERHANG DIMENSIONS ARE
12" FROM SHEATHING. RAKE DIMENSIONS ARE 4" AT BRICK
AND 6" AT SIDING.

STEEL LINTEL SCHEDULE LOOSE STEEL LINTELS FOR MASONRY - EXTERIOR ANGLES FOR BRICK OR STONE (NO FLOOR LOAD) MAX. CLEAR SPAN 5'-O" OR LESS 3 1/2" x 3 1/2" x 5/16" T'-O" OR LESS 4" x 3 1/2" x 5/16" 8'-O" OR LESS 5" x 3 1/2" x 5/16" 9'-O" OR LESS 5" x 3 1/2" x 3/8" 10'-O" OR LESS 6" x 3 1/2" x 3/8"

NOTE: THIS SCHEDULE APPLIES UNLESS NOTED OTHERWISE ON THE PLANS AND/OR ELEVATIONS.

NOTE: STEEL ANGLE LINTELS REQUIRE A SHOP COAT OF RUST-INHIBITIVE PAINT EXCEPT FOR LINTELS MADE OF CORROSION-RESISTANT STEEL.

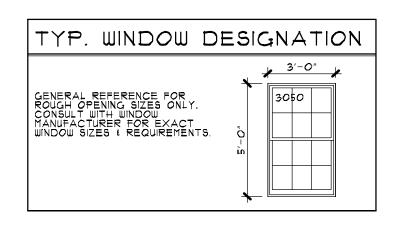


EVERY SLEEPING ROOM SHALL HAVE AT LEAST ONE OPERABLE WINDOW OR EXTERIOR DOOR APPROVED FOR EMERGENCY EGRESS OR RESCUE. THE UNIT(S) MUST BE OPERABLE FROM THE INSIDE TO A FULL CLEAR OPENING WITHOUT THE USE OF SEPARATE TOOLS. WHERE WINDOWS ARE PROVIDED AS A MEANS OF EGRESS, OR RESCUE. THEY SHALL HAVE SILL HEIGHT OF NOT MORE THAN 44 INCHES ABOVE THE FLOOR. ALL EGRESS OR RESCUE WINDOWS FROM SLEEPING ROOMS MUST HAVE A MINIMUM NET CLEAR OPENING HEIGHT DIMENSION SHALL BE 24 INCHES AND WIDTH OF 20 INCHES.

GENERAL NOTES


- BEFORE CONSTRUCTION OBTAIN WINDOW & DOOR ROUGH OPENING SIZES FROM WINDOW/DOOR SUPPLIER

 TRUSS DESIGNER/FABRICATOR SEE SHEET N-2 FOR ADDITIONAL NOTES & INFORMATION
- 3. DO NOT SCALE THESE DRAWINGS. USE CALCULATED DIMENSIONS, IF VARIATIONS OCCUR CONTACT ARCHITECT FOR CLARIFICATION.
- 4. SEE CIVIL ENGINEERS'S DWG: FOR ALL FINAL A/C UNIT. ELECTRICAL METER & GAS METER LOCATIONS.

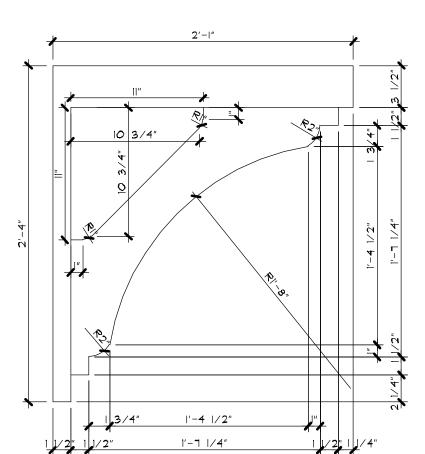

BRACKET DETAIL

SCALE: 1 1/2" = 1'-0"

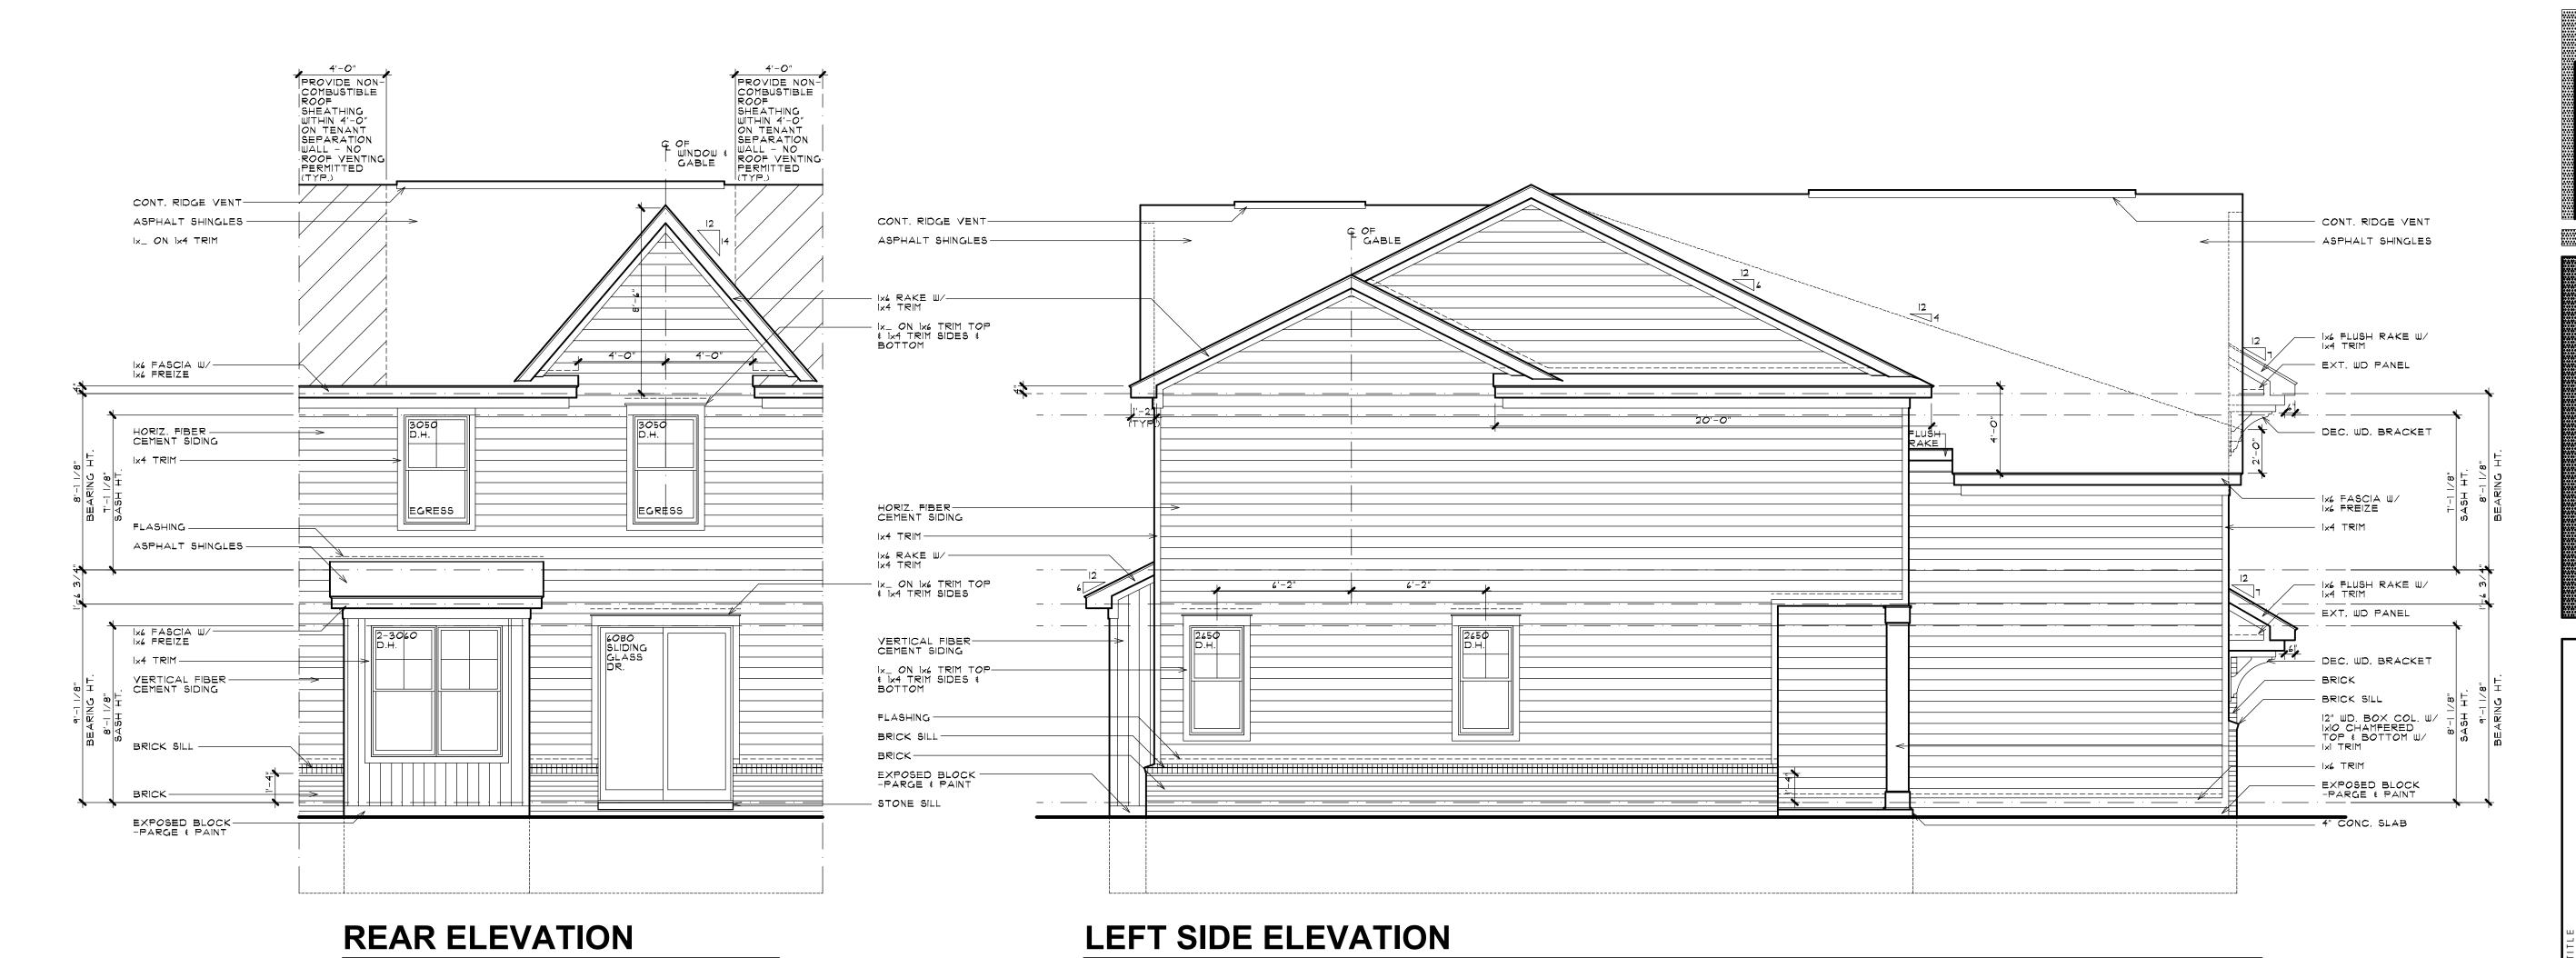

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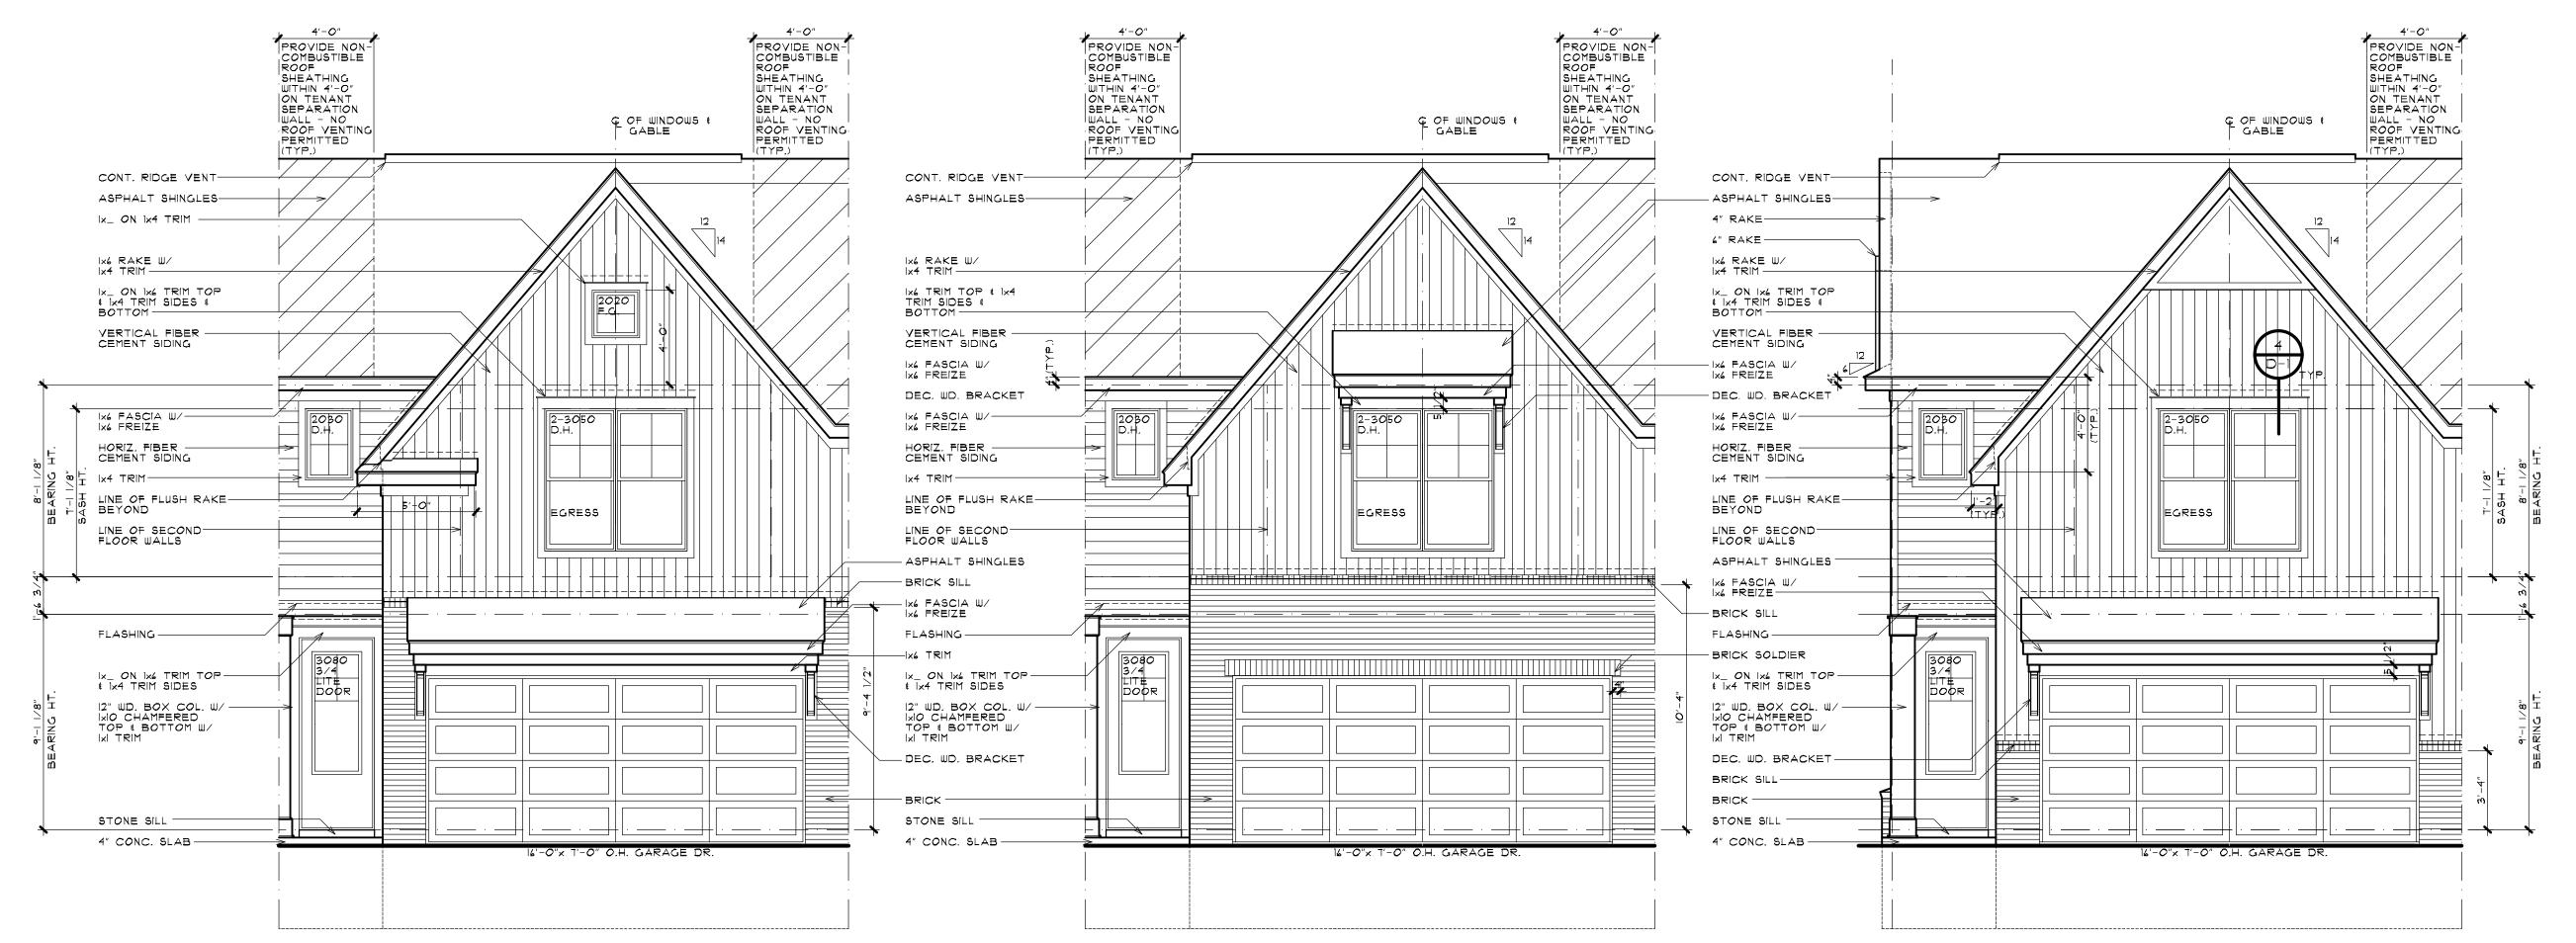
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SCALE: 1/4" = 1'-0"

SCALE: 1/4" = 1'-0"

FRONT ELEVATION

ELEVATION 'A'



FRONT ELEVATION

SCALE: 1/4" = 1'-0"

ELEVATION 'B'


RIGHT SIDE OPPOSITE HAND

SCALE: 1/4" = 1'-0"

SCALE: 1/4" = 1'-0"

FRONT ELEVATION

ELEVATION 'C'

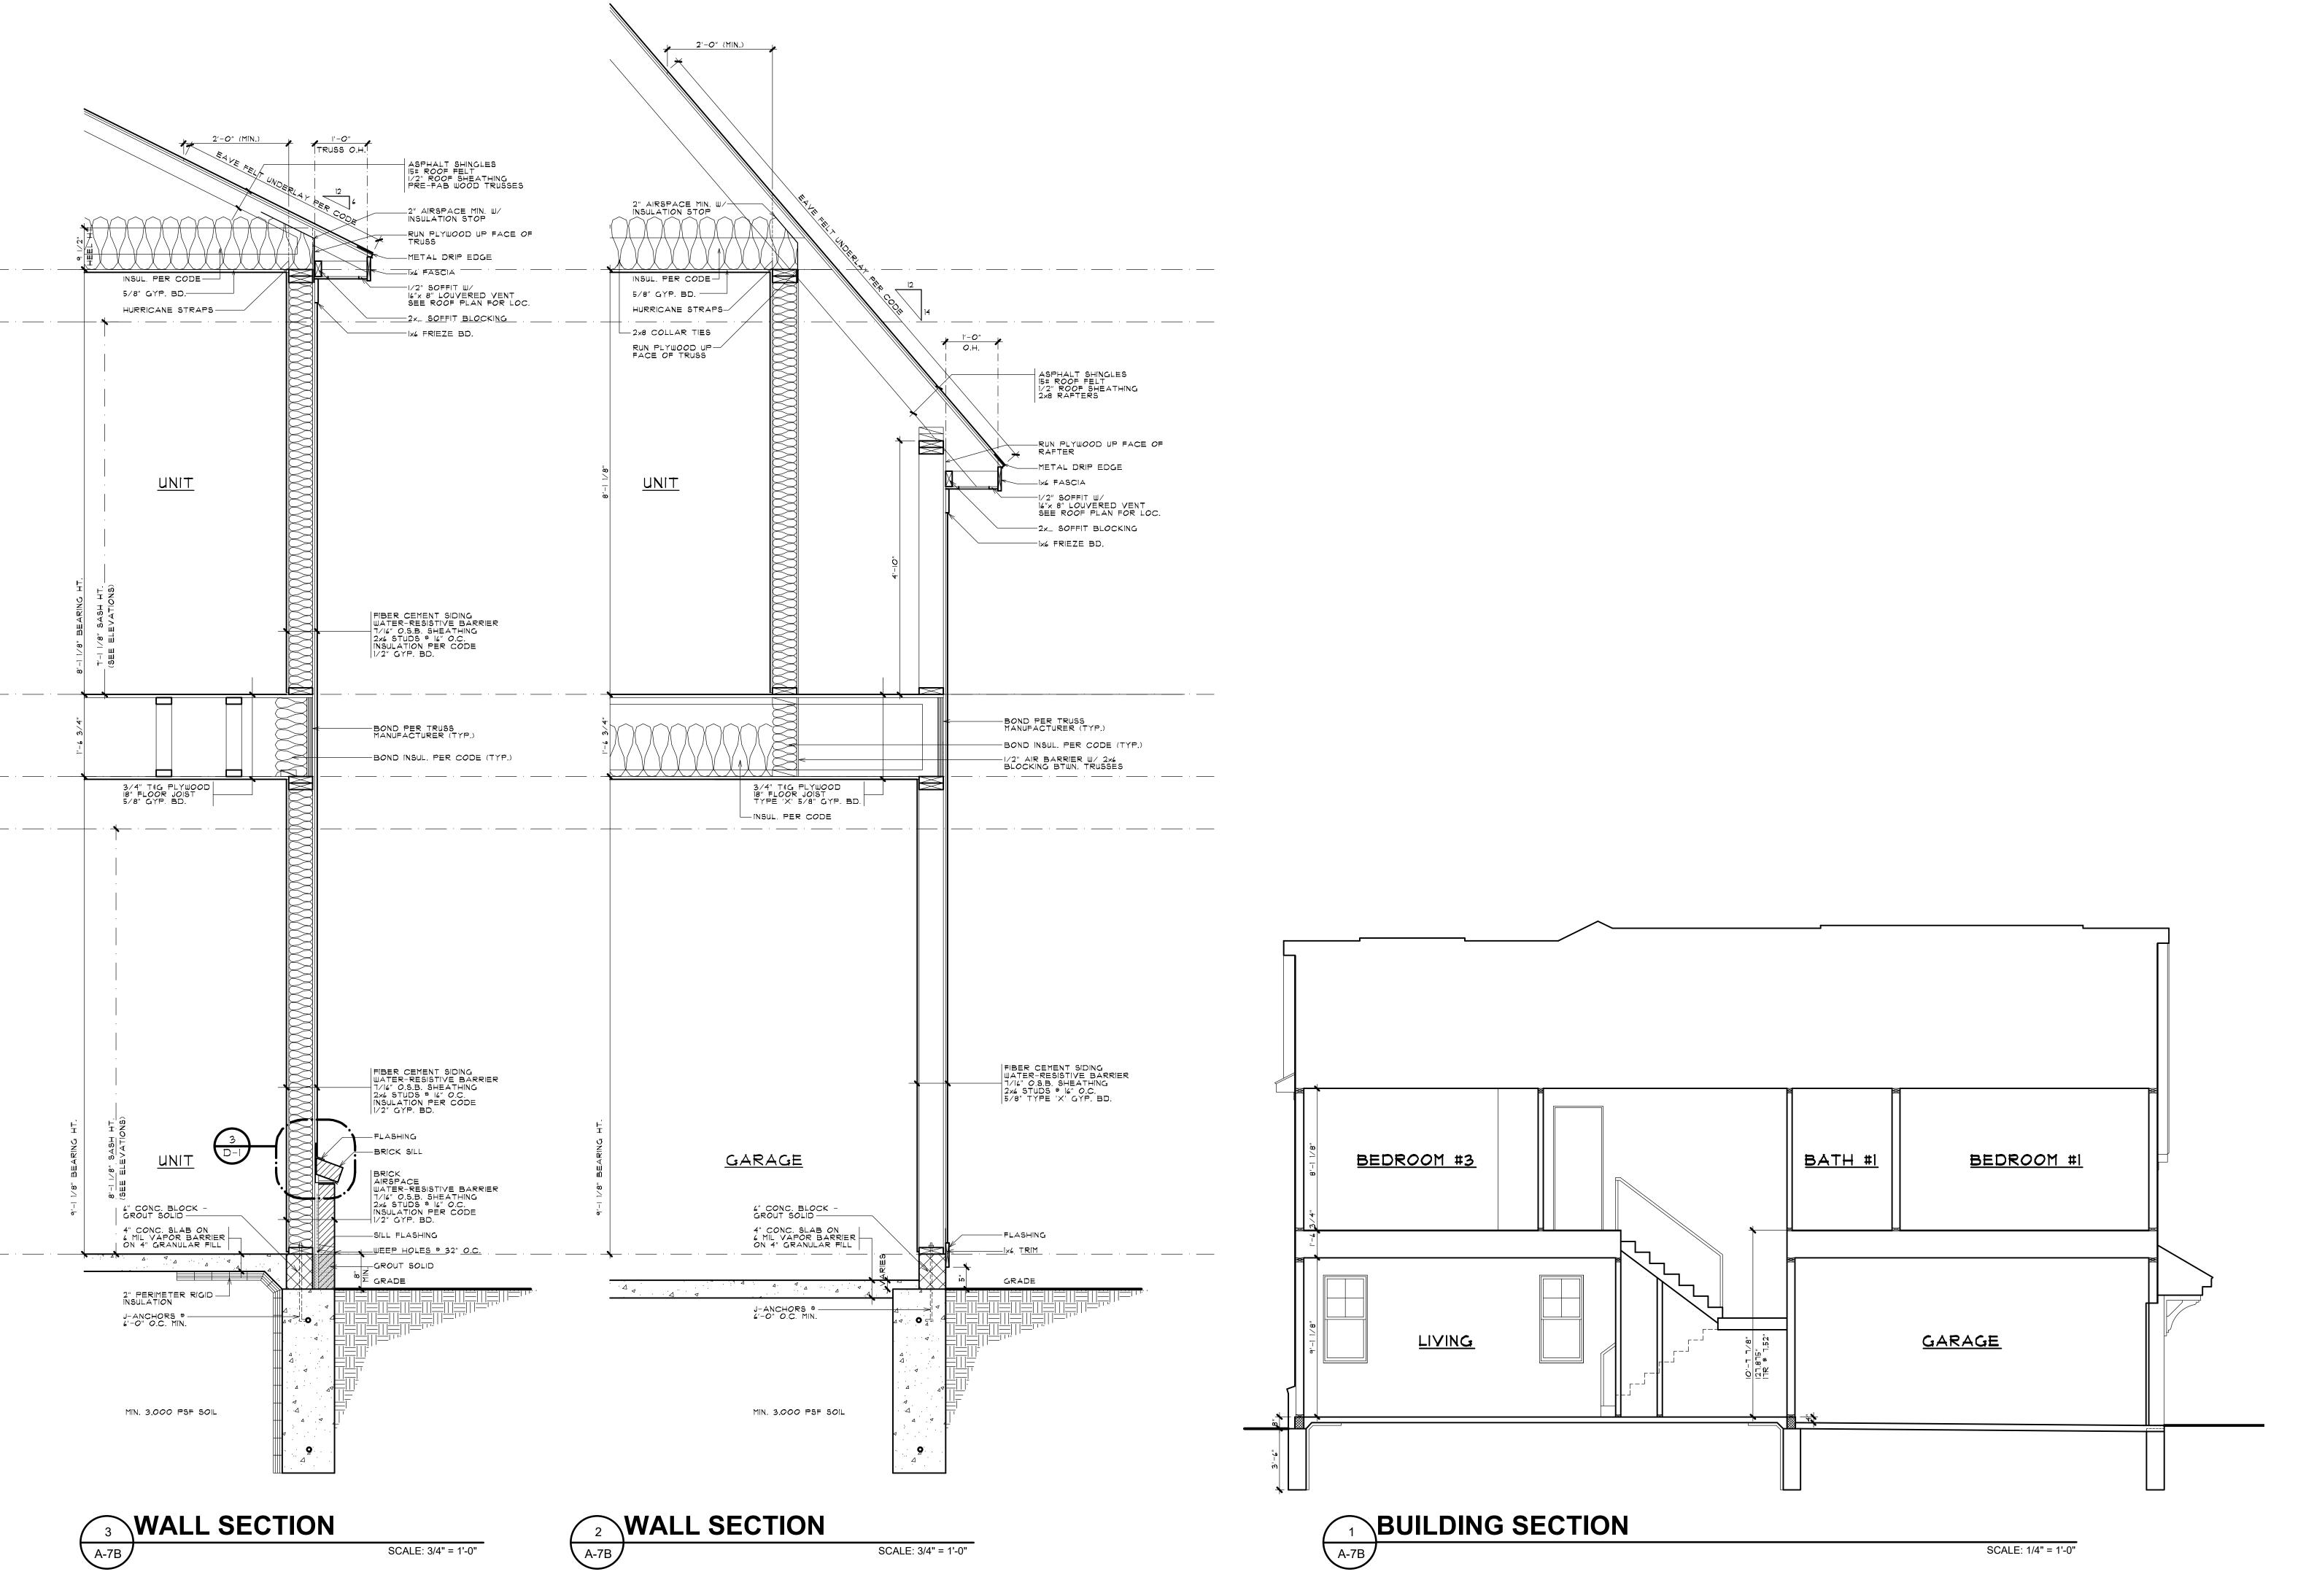

ARCHITECTURE

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BUILDING # WALL SECTIONS
BUILDING TYPE 'B' 6-UNIT

JOHN R TOWNHOME DEV.

BUILDING TYPE 'B'

TROY, MICHIGAN

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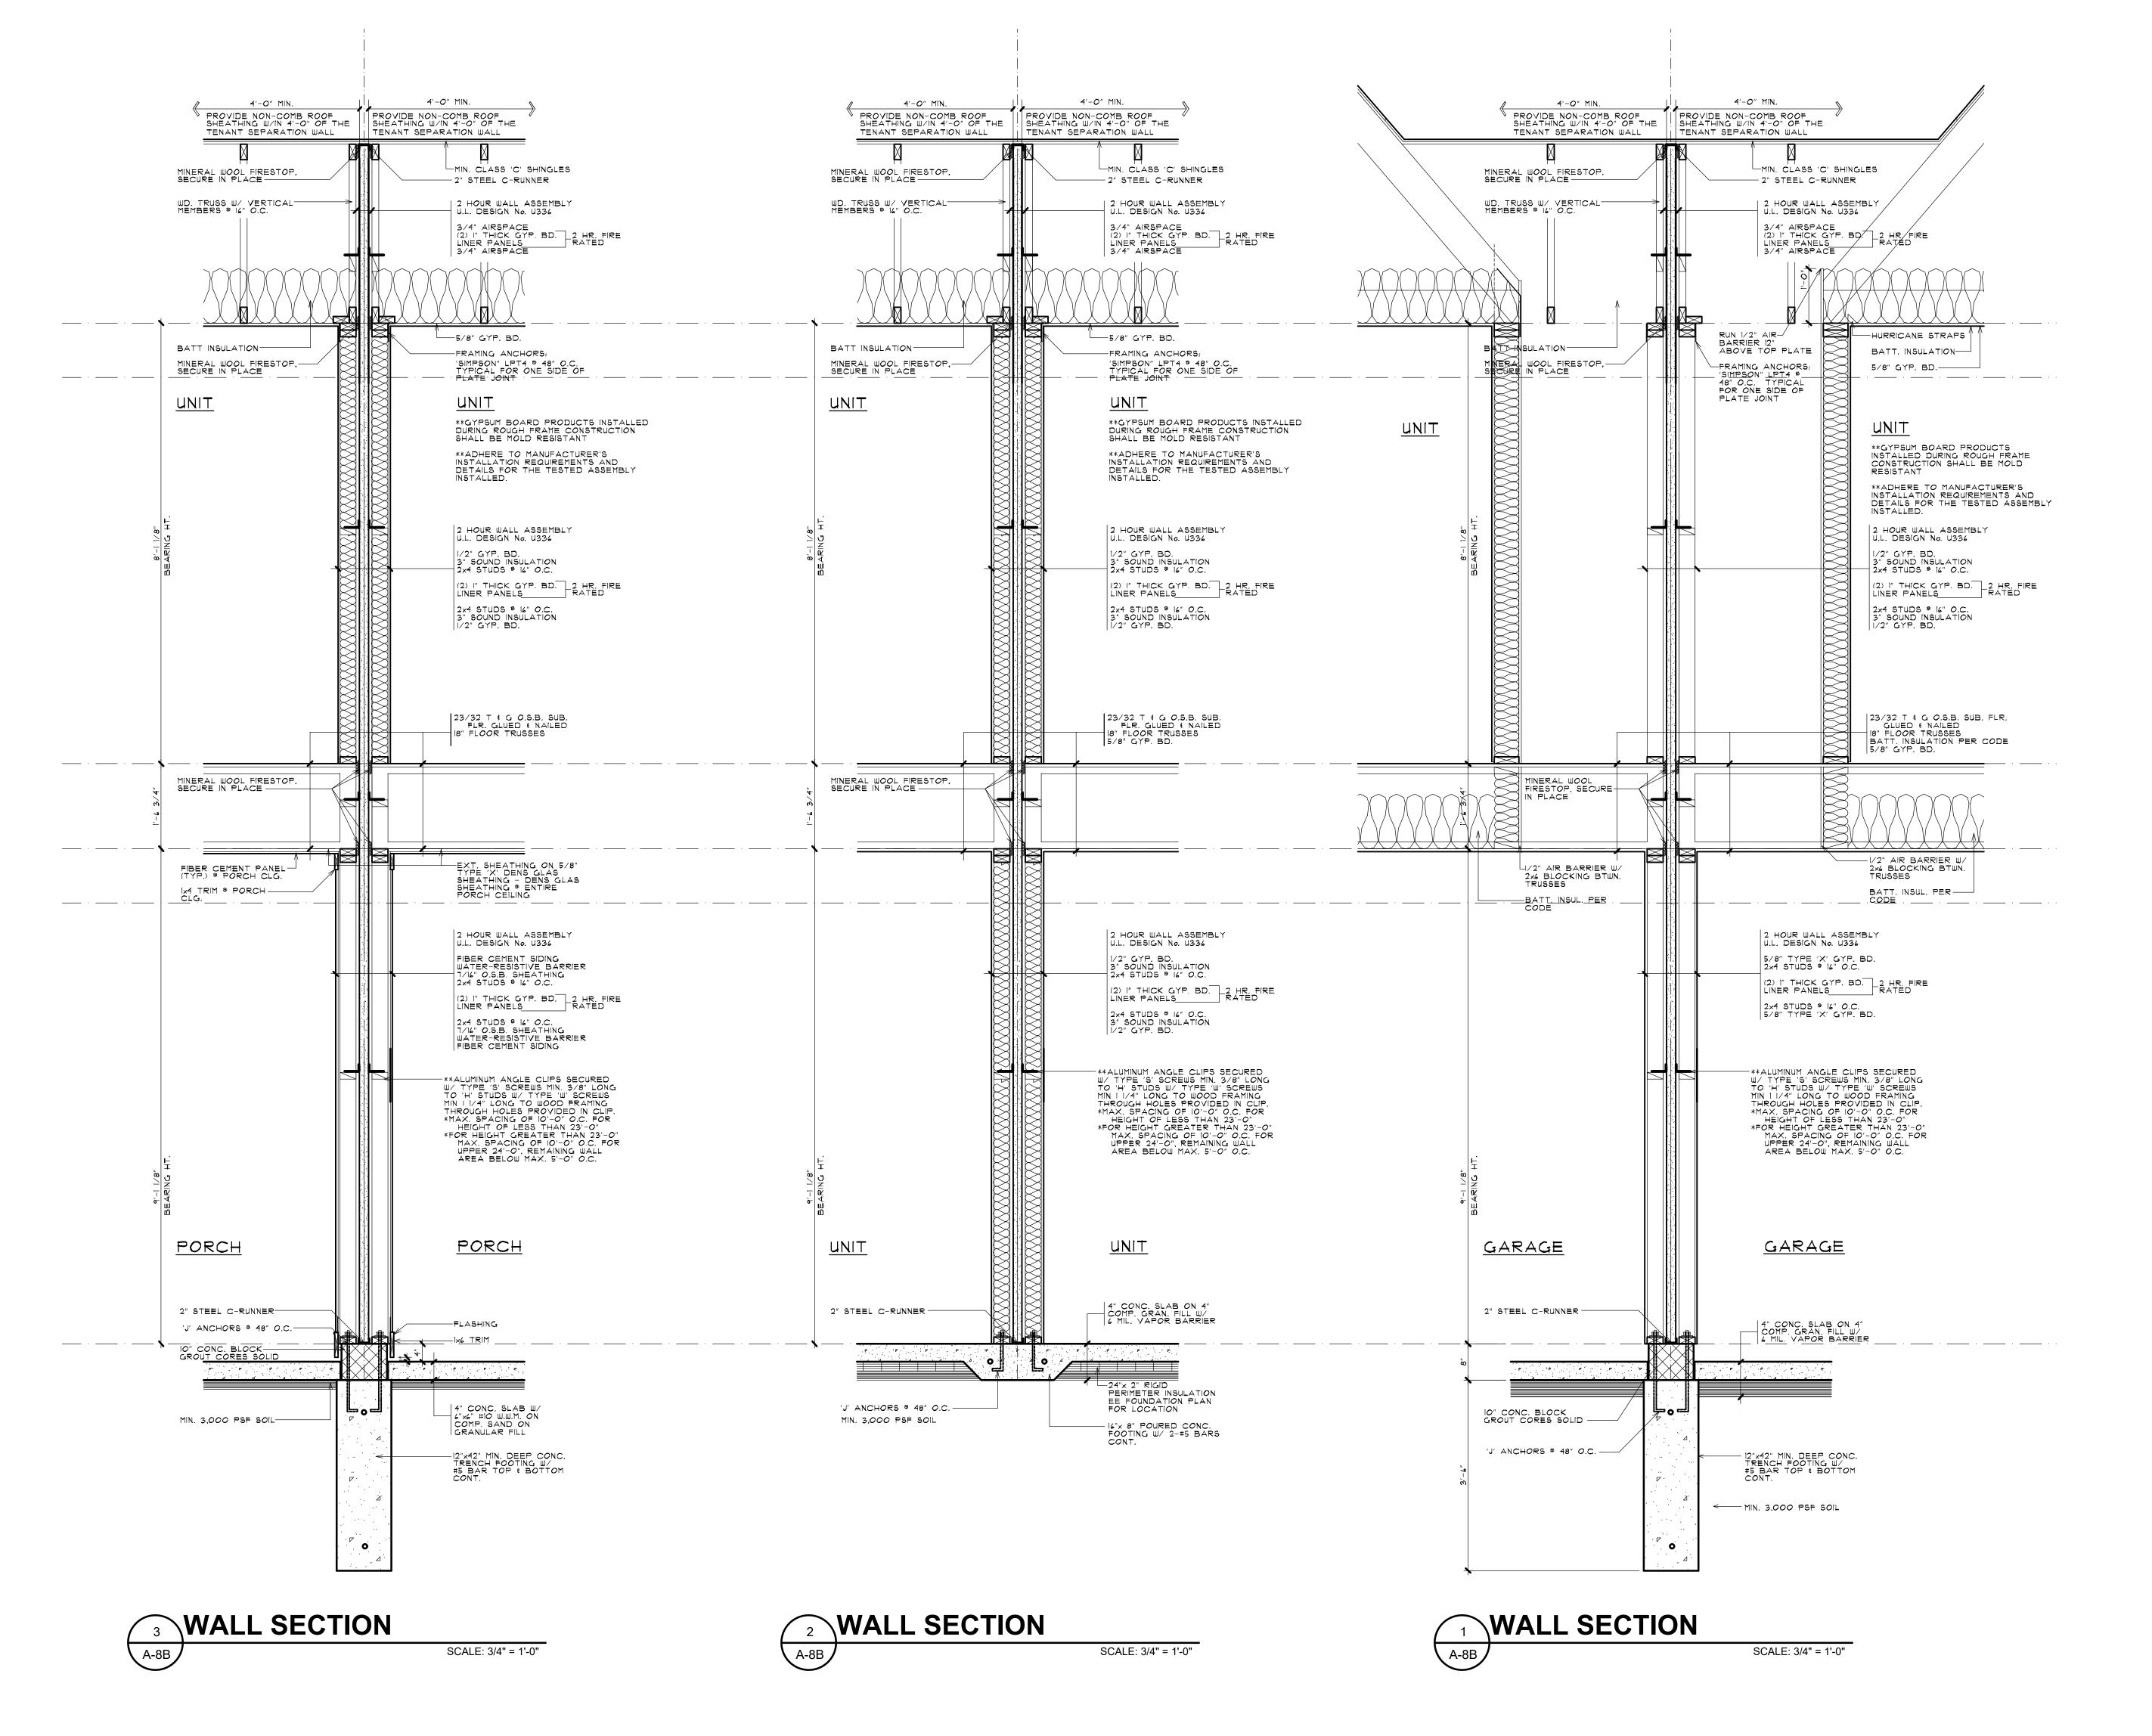
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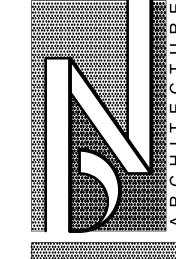
FRONT ELEVATION - BUILDING TYPE 'B'

6 - UNIT SCALE: 3/16" = 1'-0"



FRONT ELEVATION - BUILDING TYPE 'B'

6 - UNIT SCALE: 3/16" = 1'-0"



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RENDERED FRONT ELEVATIONS BUILDING TYPE 'B' 6-1

JOHN R TOWNHOME DEV.
BUILDING TYPE 'B'
TROY, MICHIGAN

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