

PLANNING COMMISSION MEETING AGENDA REGULAR MEETING

Marianna Perakis, Chair, Lakshmi Malalahalli, Vice Chair Toby Buechner, Carlton Faison, Tyler Fox, Michael W. Hutson, Tom Krent, Dave Lambert and John J. Tagle

May 28, 2024 7:00 P.M. Council Chambers

- 1. ROLL CALL
- 2. APPROVAL OF AGENDA
- 3. APPROVAL OF MINUTES May 14, 2024
- 4. PUBLIC COMMENT For Items Not on the Agenda

PLANNED UNIT DEVELOPMENT

5. PLANNED UNIT DEVELOPMENT (File Number PUD 020 JPLN2023-0021) — CONCEPT DEVELOPMENT PLAN (CDP) AND PRELIMINARY DEVELOPMENT PLAN (PD) APPROVAL — The Village of Hastings PUD, East side of Livernois, north of Square Lake, PIN 88-20-03-301-088, -023, -024, -025 and 88-20-03-351-004, Section 3, Presently zoned NN (Neighborhood Node "Q") and R-1B (One Family Residential) Zoning Districts.

PRELIMINARY SITE PLAN APPROVAL

6. PRELIMINARY SITE PLAN APPROVAL (JPLN2023-0031) –. Proposed Wattles Square Apartments, South side of Wattles and east of John R (PIN 88-20-24-100-039), Section 24, Zoned NN (Neighborhood Node "F") Zoning District.

SPECIAL USE APPROVAL

7. PUBLIC HEARING – SPECIAL USE APPROVAL AND PRELIMINARY SITE PLAN REVIEW (SU JPLN2024-0006) – Proposed Jax Kar Wash, South side of Long Lake, East of Livernois (102 East Long Lake Road), Section 15, Currently Zoned NN (Neighborhood Node "M") Zoning District.

NOTICE:People with disabilities needing accommodations for effective participation in this meeting should contact the City Clerk by e-mail at clerk@troymi.gov or by calling (248) 524-3317 at least two working days in advance of the meeting. An attempt will be made to make reasonable accommodations

OTHER ITEMS

- 8. PUBLIC COMMENT For Items on the Agenda
- 9. PLANNING COMMISSION COMMENT
- 10. ADJOURN

Chair Perakis called the Regular meeting of the Troy City Planning Commission to order at 7:02pm on May 14, 2024, in the Council Chamber of the Troy City Hall. Chair Perakis presented opening remarks relative to the role of the Planning Commission and procedure of tonight's meeting.

1. ROLL CALL

Present:

Toby Buechner
Carlton M. Faison
Tyler Fox
Michael W. Hutson
Tom Krent
David Lambert
Marianna Perakis

Absent:

Lakshmi Malalahalli

Also Present:

John J. Tagle

R. Brent Savidant, Community Development Director Ben Carlisle, Carlisle Wortman Associates Allan Motzny, Assistant City Attorney Jackie Ferencz, Planning Department staff

2. APPROVAL OF AGENDA

Resolution # PC-2024-05-22

Moved by: Fox Support by: Tagle

RESOLVED, To approve agenda as prepared.

Yes: All present (8)
Absent: Lakshmi Malalahalli

MOTION CARRIED

3. APPROVAL OF MINUTES – April 23, 2024

Resolution # PC-2024-05-23

Moved by: Lambert Support by: Buechner

RESOLVED, To approve the minutes of April 23, 2024 Regular meeting as submitted.

Yes: All present (8)
Absent: Lakshmi Malalahalli

MOTION CARRIED

PUBLIC COMMENT – For Items Not on the Agenda

SPECIAL USE APPROVAL

5. PUBLIC HEARING – SPECIAL USE APPROVAL AND PRELIMINARY SITE PLAN REVIEW (SU JPLN2024-0010) – Proposed Motor City Church addition and site improvements, South side of Wattles, East of Coolidge (1349 W. Wattles), Section 20, Currently Zoned R-1B (One-Family Residential) Zoning District.

Planning Commission member, John Tagle, recused himself. Motor City Church is a client of John Tagle Associates.

Ben Carlisle, of Carlisle Wortman Associates, presented on proposed Motor City Church addition and site improvements project.

Applicants, Michelle Sargent with John Tagle Associates and Dave Martin, Pastor of Motor City Church, spoke.

There was discussion by Board members related to:

- how a Special Use must be re-approved when there are changes
- parking
- tree placement

Chair Perakis opened the floor for public comment.

Chair Perakis closed the floor for public comment.

Resolution # PC-2024-05-24

Moved by: Fox Seconded by: Lambert

RESOLVED, That Special Use Approval and Preliminary Site Plan Approval for the proposed church addition and other site improvements, South side of Wattles, East of Coolidge (1349 W. Wattles), Section 20, Currently Zoned R-1B (One Family Residential) District, be **granted** with waivers for tree and excess parking.

Yes: All (8)

Absent: Lakshmi Malalahalli

Recused: John Tagle

MOTION CARRIED

Mr. Tagle returned to meeting at 7:35pm

PUBLIC HEARING – SPECIAL USE AND PRELIMINARY SITE PLAN REVIEW (SU JPLN2021-024) - Proposed Starbucks with drive through, North side of Big Beaver, West of John R (1735 E. Big Beaver), Section 23, Currently Zoned CB (Community Business) Zoning District.

Mr. Carlisle presented proposed Starbuck with drive through project.

There was discussion by Board members related to:

- Crosswalks
- Tree placement
- Speed tables
- Traffic Circulation

Applicants Jim Butler, PEA Group; Dennis Bostick, Troy Sports Center LLC; Brian Neeper, Brian Neeper Architecture presented their application.

Chair Perakis opened public comment

Chair Perakis closed public comment

Planning Commission Discussion

Resolution # PC-2024-05-25

Moved by: Fox

Seconded by: Buechner

RESOLVED, That Special Use Approval and Preliminary Site Plan Approval for the proposed Starbucks with drive through, North side of Big Beaver, West of John R (1735 E. Big Beaver), Section 23, Currently Zoned CB (Community Business) District, be **postponed** for the following reasons:

Applicant to provide:

- a photometric plan
- larger context circulation plan
- dumpster plans
- pedestrian safety improvements
- tree ordinance compliance plan

Yes: All (8)

Absent: Lakshmi Malalahalli

MOTION CARRIED

PRELIMINARY SITE PLAN APPROVAL

7. PRELIMINARY SITE PLAN APPROVAL (JPLN2023-0028) — Proposed John R Commons Townhome Development, West side of John R, North of Big Beaver (PIN 88-20-23-476-017), Section 23, Zoned MF (Multi-Family Residential) Zoning District.

Mr. Carlisle presented on Proposed John R Commons Townhome Development project

Applicants Greg Bono, PEA Group; Dennis Bostick, Troy Sports Center LLC; Greg Neeper, Brian Neeper Architecture, spoke on application.

Chair Perakis opened Public Comment

Chair Perakis closed Public Comment

Planning Commission Discussion

RESOLVED, That Preliminary Site Plan Approval, pursuant to Article 8 of the Zoning Ordinance, as requested for the proposed John R Gardens Townhome Development, located on the East side of John R, North of Big Beaver, Section 23, Zoned MF (Multi-Family Residential) District, be postponed for the following reasons:

Resolution # PC-2024-05-26

Moved by: Fox Seconded by: Tagle

Yes: All (8)

Absent: Lakshmi Malalahalli

MOTION CARRIED

OTHER ITEMS

- 8. PUBLIC COMMENT For Items on the Agenda
- 9. PLANNING COMMISSION COMMENT
- 10. <u>ADJOURN</u>

The Regular meeting of the Planning Commission adjourned at 9:22 p.m.

Respectfully submitted,	
Marianna J. Perakis, Chair	
Jackie Ferencz, Planning Department Staff	

G:\PLANNING COMMISSION MINUTES\2024 PC MINUTES\DRAFT\2024 05 14 Draft.docx

ITEM #5

DATE: May 22, 2024

TO: Planning Commission

FROM: R. Brent Savidant, Community Development Director

SUBJECT: PLANNED UNIT DEVELOPMENT (File Number PUD 020 JPLN2023-0021) -

CONCEPT DEVELOPMENT PLAN (CDP) AND PRELIMINARY DEVELOPMENT PLAN (PD) APPROVAL – The Village of Hastings PUD, East side of Livernois, north of Square Lake, PIN 88-20-03-301-088, -023, -024, -025 and 88-20-03-351-004, Section 3, Presently zoned NN (Neighborhood Node "Q") and R-1B

(One Family Residential) Zoning Districts

The applicant GFA Development, Inc. seeks Conceptual Development Plan (CDP) and Preliminary Development Plan (PDP) approval for the Village of Hastings Planned Unit Development (PUD). The project features a total of 33 residential units comprised of 4 different housing types (single family detached, ranch style detached, single family attached and duplex). The Planning Commission is a recommending body for this application.

The Planning Commission considered the item on April 9, 2024 and passed the following resolution:

Resolution # PC-2024-04-018

Moved by: Fox

Seconded by: Buechner

RESOLVED, To postpone The Village of Hastings PUD, East side of Livernois, North of Square Lake, to allow the applicant to make improvements and provide updated elevations for the ranch style homes as specified in the Site Plan Review Design Standards, Section 8.06 of the Zoning Ordinance, as well as provide signage for the EVA, and address any outstanding items as identified in the Planning Consultant report dated March 15, 2024.

Yes: Buechner, Faison, Fox, Krent, Malalahalli, Perakis, Tagle

No: Hutson, Lambert

MOTION CARRIED

The attached report prepared by Carlisle/Wortman Associates, Inc. (CWA), the City's Planning Consultant, summarizes the project as revised. CWA prepared the report with input from various City departments including Planning, Engineering, Public Works and Fire. City Management supports the findings of fact contained in the report and the recommendations included therein.

Attachments:

- 1. Maps
- 2. Minutes from April 9, 2024 Planning Commission Regular meeting (excerpt)
- 3. Report prepared by Carlisle/Wortman Associates, Inc.
- 4. PUD Application/Site Plan
- 5. Public comment submitted after April 9, 2024 Planning Commission meeting.

G:\PUDs\PUD 020 JPLN2023-0021 VILLAGE OF HASTINGS\PC Memo 05 28 2024.doc

PLANNED UNIT DEVELOPMENT (File Number PUD 020 JPLN2023-0021) — CONCEPT DEVELOPMENT PLAN (CDP) AND PRELIMINARY DEVELOPMENT PLAN (PD) APPROVAL — The Village of Hastings PUD, East side of Livernois, north of Square Lake, PIN 88-20-03-301-088, -023, -024, -025 and 88-20-03-351-004, Section 3, Presently zoned NN (Neighborhood Node "Q") and R-1B (One Family Residential) Zoning Districts

Resolution # PC-2024-05-

Moved by: Seconded by

WHEREAS, The applicant GFA Development, Inc. seeks Conceptual Development Plan (CDP) and Preliminary Development Plan (PDP) approval for the Village of Hastings Planned Unit Development (PUD), located on the east side of Livernois, north of Square Lake, in Section 3, approximately 6.05 acres in area; and

WHEREAS, The Village of Troy PUD features 3 detached single-family homes, 8 ranch style single family homes, 18 two-story attached homes and 4 single family duplex homes, for a total of 33 residential units; and

WHEREAS, The proposed development accomplishes a sufficient number of the Standards of Approval as per Section 11.03.B.


BE IT RESOLVED, That the Planning Commission recommends to City Council that Concept Development Plan Approval and Preliminary Development Plan Approval for the proposed Village of Hastings, be granted, subject to the following design considerations:

Yes:
No:
Absent:

MOTION CARRIED/FAILED

TROY

GIS Online

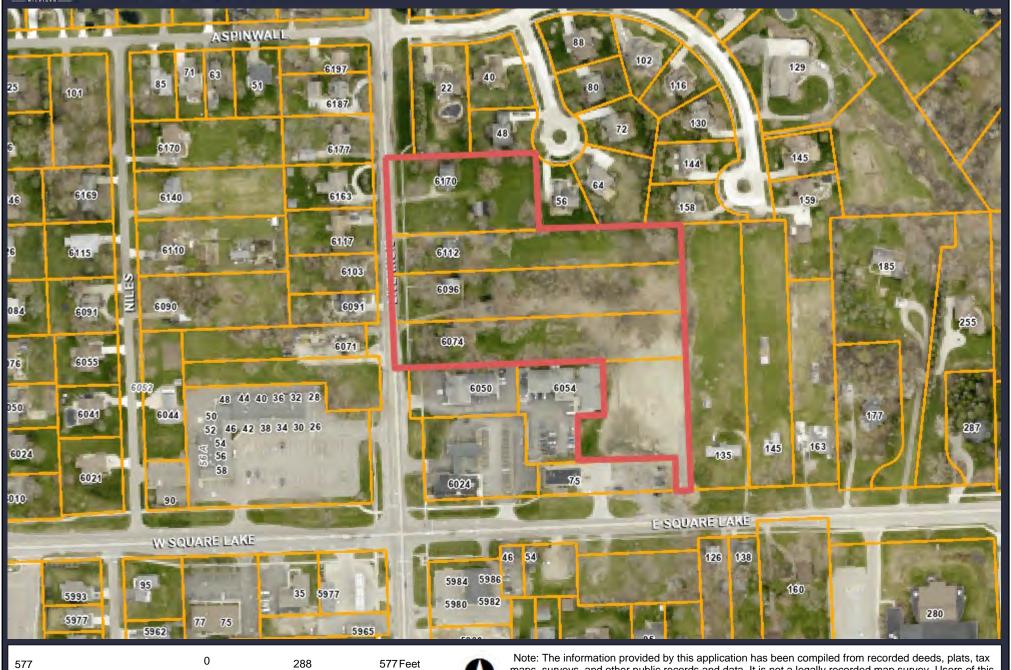

maps, surveys, and other public records and data. It is not a legally recorded map survey. Users of this data are hereby notified that the source information represented should be consulted for verification.

GIS Online (R-1B) ASPINWALL (R-1B) (R-1B) 61(17 (R-1B) 60.74 48 44 (NN) Node Q (NN) Node (52 46 42 38 34 30 26 9.0 E SQUARE L'AKE W SQUARE LAKE (NN) Node Q (R-1B) (R-1B) 5984 5986 (NN) Node Q 5980 5982 (RT)





Note: The information provided by this application has been compiled from recorded deeds, plats, tax maps, surveys, and other public records and data. It is not a legally recorded map survey. Users of this data are hereby notified that the source information represented should be consulted for verification.

PLANNED UNIT DEVELOPMENT

7. PUBLIC HEARING - PLANNED UNIT DEVELOPMENT (File Number PUD 020 JPLN2023-0021) - CONCEPT DEVELOPMENT PLAN (CDP) AND PRELIMINARY DEVELOPMENT PLAN (PDP) APPROVAL - The Village of Hastings PUD, East Side of Livernois, North of Square Lake, (PIN 88-20-03-301-088, -023, -024, -025 and 88-20-03-351-004), Section 3, Presently Zoned NN (Neighborhood Node "Q") and R-1B (One Family Residential) Zoning Districts

Mr. Carlisle provided a brief background of The Village of Hastings PUD application. He stated the applicant removed the privacy fence between the existing older homes and the adjacent new housing units and reduced the number of duplex units to two (2). Mr. Carlisle said the applicant has not provided building materials or an architectural color scheme. He asked the Planning Commission to hold a public hearing and consider public testimony. He said as part of the deliberations, the Planning Commission should consider if the project is consistent with the Master Plan, whether it meets the Site Plan Review Design Standards and whether it meets the PUD Standards.

In summary, Mr. Carlisle said any approval of the PUD application should be subject to the conditions as identified in his report dated March 15, 2024.

Applicant Gary Abitheira gave a PowerPoint presentation. He addressed the reduction of units, reorientation of entrance doors on units 9 through 12, the City Traffic Consultant report, traffic volume data from the RCOC (Road Commission of Oakland County) website, internal vehicular circulation, comparisons of density with previously approved PUD developments and the missing middle ranch style homes he is proposing. Mr. Abitheira walked through the PUD Standards one by one to substantiate how he feels the application meets the PUD Standards.

There was discussion, some comments related to:

- Applicant to keep the historic nature of the older homes, place them on the market for sale and incorporate such terms in the PUD Agreement.
- Walkability of the site.
- EVA (Emergency Vehicle Access); access and signage.
- Extension of sidewalk along Square Lake.
- Potential to provide a pedestrian crosswalk on Square Lake.
- Potential for additional green space in detention area.
- Circulation improvements requested by the City Traffic Consultant OHM; applicant has met.
- Trash pickup arrangement.
- Public amenities.
- Sustainability features.
- Design of ranch units as relates to the Site Plan Review Design Standards.
- Building materials and color scheme.
- Patios and/or decks on units.
- Inconsistency of building and lot dimension designations on the site plan.

It was the consensus of the Board members that the application does not meet the PUD Standard that references *innovative* and creative site and building designs, solutions and materials, and that the applicant could focus more on the Site Plan Review Design Standards.

It was clarified that the Long Lake and Crooks PUD development is the development that Ms. Dufrane referenced in a previous meeting stating it set a high bar for approval of a PUD development.

PUBLIC HEARING OPENED

- Michael Johnson, 450 E Square Lake; expressed support for the development, that
 any additional traffic that might be generated is negligible, concerns expressed by
 community and Board members have been addressed by applicant.
- Mary Rettig, 6860 Westaway; addressed definitions applied to different styles of housing units, square footage of units, concerns with parking and traffic.
- Allyson Wyckhuyse, 56 Telford; addressed orientation of her home as relates to the development and proposed public amenities.
- Sheila Lenz-Shomo, 6464 Fredmoor; addressed concerns with traffic, acceleration and deceleration lanes, density, internal vehicular circulation, and application meeting PUD Standards.
- Nanette Gearhart, 6197 Livernois; voiced opposition to the development, addressed concerns with parking and transition to existing neighborhood, would prefer the byright proposal of single family residential.
- Leasa Williams, 159 Telford; voiced opposition to the PUD application, would prefer the by-right proposal of single family residential.
- Jeff Williams, 159 Telford; addressed PUD Standards that he feels application has not met.
- Ann Coleman, 6091 Livernois; addressed PUD Standards that she feels application
 has not met, support by-right proposal of single family residential.
- Dave Pampreen, 6408 Canmoor; addressed density of application in comparison to surrounding residential, concerns with artesian well allegedly on site.
- John Malott, 72 Telford; addressed comments of residents he surveyed within differential distances of the proposed PUD development, in support of the by-right proposal of single family residential.
- Deboral Louzecky, 6327 Donaldson; voiced opposition of the PUD development, prefer by-right proposal of single family residential, addressed PUD Standards that she feels are not met, concerns with residents west of Square Lake losing property.

PUBLIC HEARING CLOSED

Mr. Carlisle stated an application to develop single family residential at this site has not been submitted nor has it been through the site plan approval process. He said at this point it is not clear how many units might be allowed under the R-1B zoning classification.

Several board members shared comments as relates to a single family residential byright development in comparison to the proposed PUD development. Mr. Abitheira stepped forward to ask the Board's consideration in postponing the item because of the lateness of the meeting and that it would allow him the opportunity to improve the architectural design of the ranch style homes.

Resolution # PC-2024-04-018

Moved by: Fox

Seconded by: Buechner

RESOLVED, To postpone The Village of Hastings PUD, East side of Livernois, North of Square Lake, to allow the applicant to make improvements and provide updated elevations for the ranch style homes as specified in the Site Plan Review Design Standards, Section 8.06 of the Zoning Ordinance, as well as provide signage for the EVA, and address any outstanding items as identified in the Planning Consultant report dated March 15, 2024.

Yes: Buechner, Faison, Fox, Krent, Malalahalli, Perakis, Tagle

No: Hutson, Lambert

MOTION CARRIED



117 NORTH FIRST STREET SUITE 70 ANN ARBOR, MI 48104 734.662.2200 734.662.1935 FAX

Date: October 10, 2023

December 19, 2023 February 21, 2024 March 15, 2024 May 14, 2024

PUD and Preliminary Development Plan Approval Review For City of Troy, Michigan

Applicant: GFA Development Inc

Project Name: Village of Hastings

Plan Date: January 24, 2024

Location: East side of Livernois, north of Square Lake

Zoning: R-1B, Single Family Residential (approx. 4.9 acres) & NN-Q

Neighborhood Node, (approx. 1.1 acres)

Proposed Zoning: Planned Unit Development

Action Requested: PUD and Preliminary Development Plan Approval Review

BACKGROUND

An application has been submitted to conditionally rezone a +/-6.0 acre site to PUD in order to construct thirty (30) new residential units and preserve three (3) existing homes on site. Eight (8) will be ranch style single-family homes, eighteen (18) will be two-story attached row homes, and four (4) will be single-family duplex homes. The site currently has four (4) existing single-family homes of which three (3) will be preserved and incorporated into the entire development. The site includes five (5) parcels. Approximately 4.9 acres of the site is currently zoned R-1B, which does not permit multi-family residential; while approximately 1.1 acres of the site is zoned Neighborhood Node, which does allow multi-family residential.

The subject site is located on the east side of Livernois, north of Square Lake. Access is via a new twenty-eight (28) foot wide private road off Livernois along with an emergency vehicle access road off Square Lake in the southeast corner of the development. The 30-units will be distributed in the format outlined below:

- Four (4) one (1) unit detached ranches. Four (4) units total.
- Two (2) two (2) unit attached ranches. Four (4) units total.
- Three (3) five (5) unit multi-unit row homes. Fifteen (15) units total.
- One (1) three (3) unit multi-unit row homes. Three (3) units total.
- > Two (2) two (2) unit single-family duplex homes. Four (4) units total.
- ➤ Three (3) existing (1) unit single family homes. Three (3) units total.

Total of Units: 30 new units + 3 existing units = 33 units.


All duplex and multi-unit row homes are two stories. One (1) duplex unit measures roughly 1,900 square feet and one (1) row home unit measures roughly 2,000 square feet.

The following benefits have been noted by the applicant:

- 1. Preservation of three existing homes built.
- 2. Offer multiple styles of housing.
- 3. Emergency Vehicle Access from Square Lake Road.
- 4. 1.3 acres of open space including communal sport court, putting green, and butterfly garden.
- 5. Landscaping will be viable, interesting, and inviting to encourage outdoor recreation and exercise.
- 6. Extensive interior sidewalks to promote walkability.
- 7. Maximum Building Height shall not exceed 2 stories or 30' in height.
- 8. Maximum lot area covered by buildings will be 18%.

If the PUD is recommended for approval by the Planning Commission, a PUD Agreement will be drafted between the applicant and the City Attorney's office prior to consideration by the City Council.

Location of Subject Site:

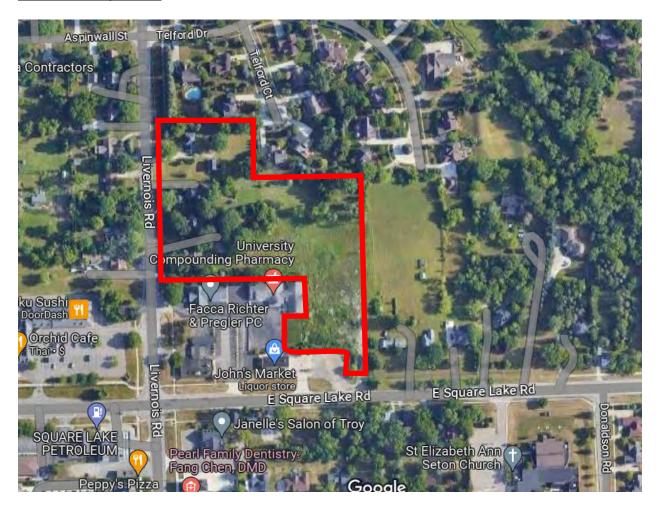

Current Zoning:

R-1B, Single Family Residential & NN-Q Neighborhood Node.

Proposed Uses of Subject Parcels:


Thirty-three (33) multi-family and single-family dwelling units.

Current Use of Subject Properties:

Single Family Homes and undeveloped land.

Surrounding Property Details:

Direction	Zoning	Use
North	R-1B	Single Family Housing
South	NN-Q	Commercial / Office
East	R-1B	Single Family Housing
West	R-1B / NN-Q	Single Family Housing / Commercial

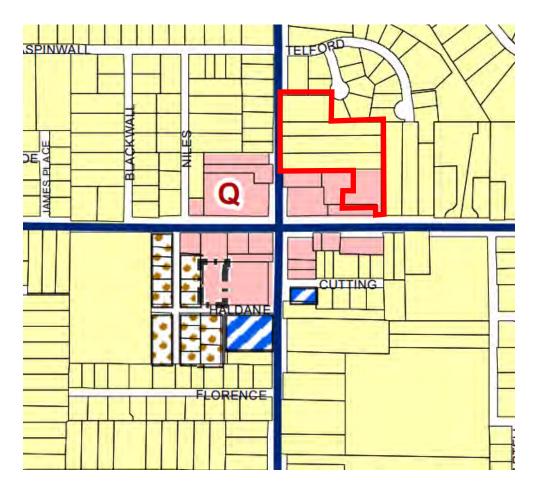

The site includes a mix of zoned R1-B (one family residential) and NN, Neighborhood Node Zoning. Uses along this portion of Livernois and Square Lake Road are primarily low intensity office and retail located near the intersection. Institutional uses exist along Square Lake Road with Troy Preschool to the west of the intersection and Saint Elizabeth Ann Seton Church to the east of the intersection. Newer dense multi-family housing does exist south of the intersection along Livernois.

PUD PROCESS

A Planned Unit Development project is viewed as an integrated development concept. To that end, the provisions of this Article are not intended to be used as a device for avoiding the zoning requirements that would otherwise apply, but rather to allow flexibility and mixture of uses, and to improve the design, character and quality of new development. The use of a Planned Unit Development to permit variations from other requirements of this Ordinance shall only be approved when such approval results in improvements to the public health, safety and welfare in the area affected, and in accordance with the intent of this Article.

The approval of a Planned Unit Development (PUD) is a three-step process:

Step 1-Concept Plan: The first step shall be application for and approval of a Concept Development Plan, which requires a legislative enactment amending the zoning district map so as to reclassify the property as a Planned Unit Development. A proposed Development Agreement shall be included and incorporated with the Concept Development Plan, to be agreed upon and approved coincident with said Plan. The Concept Development Plan and Development Agreement shall be approved by the City Council following the recommendation of the Planning Commission. Such action, if and when approved, shall confer upon the applicant approval of the Concept Development Plan and shall rezone the property to PUD in accordance with the terms and conditions of the Concept Development Plan approval.

Step 2- Preliminary Development Plan Approval: The second step of the review and approval process shall be the application for and approval of a Preliminary Development Plan (preliminary site plan) for the entire project, or for any one or more phases of the project. City Council shall have the final authority to approve and grant Preliminary Development Plan approvals, following a recommendation by the Planning Commission.

Step 3- Final Development Plan Approval: The third step of the review and approval process shall be the review and approval of a Final Development Plan (final site plan) for the entire project, or for any one or more phases of the project, and the issuance of building permits. Final Development Plans for Planned Unit Developments shall be submitted to the Zoning Administrator for administrative review, and the Zoning Administrator, with the recommendation of other appropriate City Departments, shall have final authority for approval of such Final Development Plans.

The applicant is seeking a recommendation of approval for their Preliminary Development Plan.


PUD INTENT

As set forth in Section 11.01, the intent of the Planned Unit Development option is to permit flexibility in the design and use of residential and non-residential land which, through the implementation of an overall development plan, when applicable to the site, will:

- 1. Encourage developments that will result in a long-term contribution to social, environmental and economic sustainability in the City of Troy.
- 2. Permit development patterns that respond to changing public and private needs.
- 3. Encourage flexibility in design and use that will result in a higher quality of development and a better overall project than would be accomplished under conventional zoning, and which can be accommodated without sacrificing established community values.
- 4. Provide for the long-term protection and/or preservation of natural resources, natural features, and/or historic and cultural resources.
- 5. Promote the efficient use and conservation of energy.
- 6. Encourage the use, redevelopment and improvement of existing sites where current ordinances do not provide adequate protection and safeguards for the site or its surrounding areas, or where current ordinances do not provide the flexibility to consider redevelopment, replacement, or adaptive re-use of existing structures and sites.
- 7. Provide for enhanced housing, employment, recreation, and shopping opportunities for the citizens of Troy.
- 8. Ensure the compatibility of design and use between various components within the PUD and with neighboring properties and uses. 9. Ensure development that is consistent with the intent of the Master Plan.

PREVIOUS PLANNING COMMISSION REVIEWS

The following 14-unit townhome development was approved in 2018:

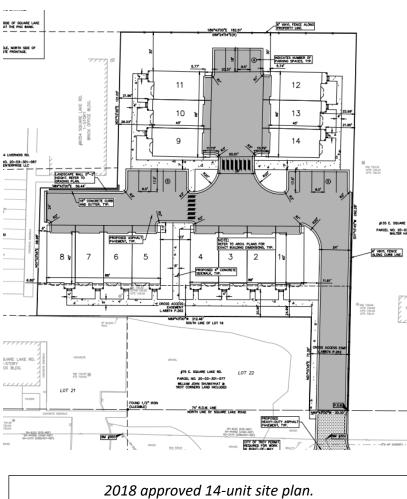


The applicant is revising the approved site layout shown above and expanding the project to the northwest.

The Concept Plan was first reviewed by the Planning Commission in July 2022. Discussion included:

- Previously approved development, housing types, timing and validity of approval, currently in engineering process
- Existing homes; historical in nature, and listed in Historic Preservation Chapter
- Neighborhood Node "Q" toured by Planning Commission and City Council
- Public benefit, preservation of two existing homes, housing types offered
- Intent of PUD development: provide flexibility from Zoning Ordinance regulations to allow a more creative and negotiable product

- Planning Commission members expressed opposition to 3-story tall buildings
- Applicant was encouraged to:
 - o Create more green space
 - o Retain "old Troy" feel of neighborhood
 - o Create a community feel; a village
 - o Create a different and unique development
 - Let element of historical homes shine on their own


On January 9, 2024, the Planning Commission considered a revised plan. After public commentary and lengthy deliberation, a vote to recommend approval of the plan to the City Council failed 4-5. No further action was taken.

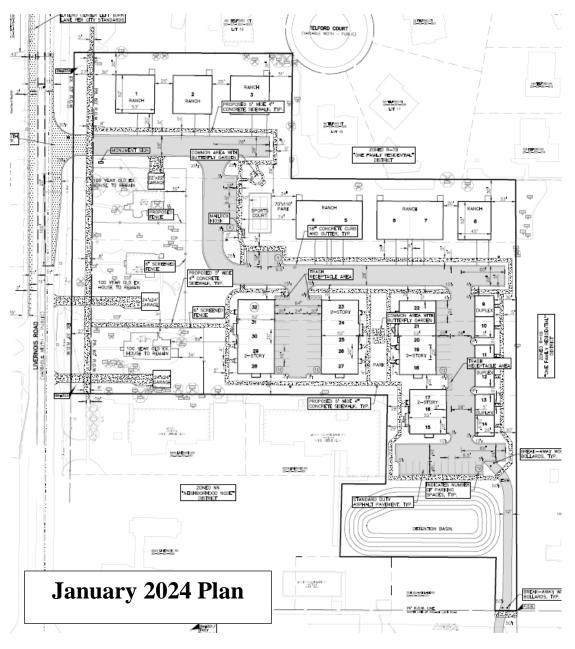

REVISED PLANS

The applicant requested to submit a revised plan for further Planning Commission consideration. Per further discussion at the January 9, 2024 meeting, the applicant provided the following revisions in March 2024:


- Removal of the proposed privacy fence between the existing older homes and the adjacent new housing units.
- Reduction of two (2) units. Revisions include the removal of two (2) duplex units on the east side of the development.
- The four (4) remaining duplex units have a new footprint and layout.

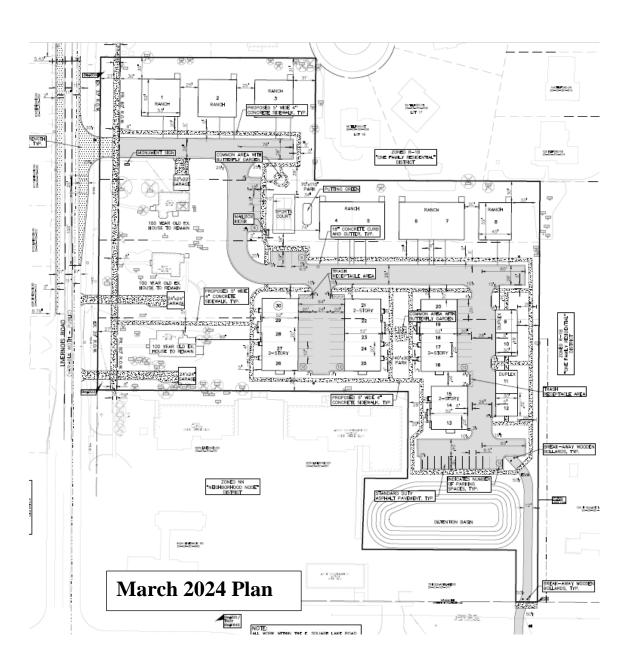

The applicant brought the revised site plans to the Planning Commission meeting on April 9, 2024. Discussion at this meeting included:

- Preserving historic nature of older homes through terms in the PUD agreement
- Walkability of the site; extension of sidewalks and inclusion of crosswalks
- EVA (Emergency Vehicle Access); access and signage
- Additional green space, public amenities, and sustainability features
- Trash pickup arrangement
- Design, materials, and color scheme of units
- Inconsistency of building and lot dimension designations on the site plan

On May 14, 2024, the applicant submitted newly revised plans to the City's Planning Department. Through these revised plans, the applicant has addressed several concerns raised at the April 9th meeting, such as EVA access and signage, crosswalks, and the trash pickup arrangement. However, some concerns were not addressed, such as additional green space, public amenities, and sustainability features. These points are discussed further throughout this report.

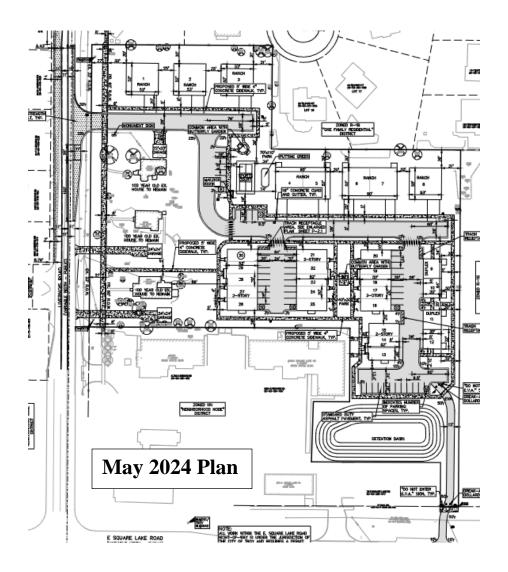

NATURAL FEATURES

Topography: A topographic survey has been provided on sheet P-1.0. The site is

relatively flat with the exception of the southeast corner where a natural

depression exists and will be converted into the detention basin.

Wetlands: There are no state regulated wetlands on the site.

Floodplain: The site is not located within a flood hazard zone.

Woodlands: A tree inventory and replacement plan have been provided on Sheet T.1.0-

T.1.1. The applicant surveyed a total of 305 trees on site. The composition of trees is predominantly woodland and invasive species with a small amount of landmark trees. Invasive species include silver maples, box elder, black walnut, elm, white mulberry, american elm, norway maple, catalpa, white poplar, green ash and cottonwood. Of the 305 on-site trees, 44 woodland trees and 5 landmark trees will be saved. Preserved trees will be primarily along the borders of the site and adjacent to the three (3)

existing homes.

Replacement Details					
Protected Tree	Inches Removed	Replacement Required			
Landmark	172 inches	172 inches			
Woodland	329 inches	165 inches			
Protected Tree	Inches Preserved	Credit			
Landmark	94 inches	188 inches			
Woodland	440 inches 880 inches				
Protected Replacement Required	337 Inches				
Preservation Credit	1,068 Inches				
Total	0 inches of replacement required				
_		·			
Total Tree Mitigation	0 inches of replacement required				

Items to be Addressed: None.

SITE ARRANGEMENT/SETBACKS/HEIGHT CONSIDERATION

The applicant is proposing to construct thirty (30) new residential units and maintain three (3) existing houses on site. Eight (8) new units will be ranch style single-family homes, eighteen (18) will be two-story attached row homes, and four (4) will be single-family duplex homes. The site currently has four (4) existing single-family homes of which three (3) will be preserved and incorporated into the entire development.

A detention basin is proposed for the southeastern portion of the site, which will be bordered by neighboring properties to the south and west, the site emergency vehicle access drive to the east, and on-site parking to the north. The plans include two (2) outdoor recreational areas: the northern central portion of the site features a sports court, butterfly garden, and putting green; and the southern central portion features a 420 square foot park with butterfly garden.

We note that our previous reports raised concerns about inconsistent setbacks found on the site plans. The applicant has addressed and alleviated these concerns with the latest site plan submitted on May 14, 2024. The applicant has shifted Units 13, 14, and 15, one-foot to the west to provide a compliant 30-foot rear setback.

Items to be Addressed: None.

PARKING

Section 13.06.G of the Zoning Ordinance requires:

	Required	Provided	Complies		
Multiple-Family Residential					
1 space per each efficiency dwelling unit 2 spaces per each dwelling unit	2*33 units= 66 spaces	25 surface lot spaces 42 driveway spaces 30 garage spaces = 97 total	Complies		

Items to be Addressed: None

SITE ACCESS AND CIRCULATION

Vehicular Access

The site will be accessed from Livernois Road via a two-lane entry. There is a one-lane Emergency Vehicular Access (EVA) proposed from Square Lake Road into the southeastern portion of the development. Based on Planning Commission comments on April 9, 2024, the applicant has provided signage around the EVA to inform that this lane is meant for emergency vehicles only.

Pedestrian Circulation

Five (5) foot wide sidewalks are shown throughout the development providing pedestrian connection to multiple units and open space amenities. To address concerns raised at the April 9, 2024 Planning Commission meeting, the applicant has also provided three (3) crosswalks in areas expected to have heavier pedestrian traffic. One (1) crosswalk connects the sidewalk south of the sports court to the adjacent sidewalk north of Unit 30. On the south side of the main road,

two (2) more crosswalks are provided where the sidewalk ends for vehicular entry into each parking lot.

Items to be Addressed: None.

LANDSCAPING

A landscaping plan has been provided on Sheets L-1.0 and L-1.1. The following table discusses the development's compliance with the landscape requirements set forth in Section 13.02.

	Required	Compliance		
Greenbelt Planting				
Livernois: 1 tree per 30 feet of frontage	463 / 30 = 15	15	Complies	
Property Lines				
North (Residential): 1 large evergreen tree per 10 lineal feet OR 1 narrow evergreen tree per 3 lineal feet	297-feet along western half / 10 = 30 trees	30 large evergreen trees	Complies	
	305-feet along eastern half / 10 = 31 trees	31 large evergreen trees	Complies	
East (Residential): 1 large evergreen tree per 10 lineal feet OR 1 narrow evergreen tree per 3 lineal feet	170-feet along northern quarter/3 = 57 trees	57 narrow evergreen trees	Complies	
	586-feet along southern three quarters/3 = 195 trees	195 narrow evergreen trees	Complies	
South (Office):				
Not required	N/A	2 trees	N/A	
Parking Lot				
1 tree per 8 surface lot parking spaces	25 / 8 = 3 trees	None in parking lot; but 52 provided along the road	Complies	
Subdivision and Site Condominium Landscaping				
1 tree per 50 lineal feet of public or private road frontage	1,281 LF / 50= 26 trees	52 trees	Complies	

Overall			
Site landscaping: A minimum of 20% of the site area shall be comprised of landscape material	20%	26%	Complies

Trash Pickup

Ranch home residents will utilize private trash cans which shall be set along the road for pickup. Then, four (4) trash receptacles are provided within the parking lots for residents in the ROW and duplex style units. The four (4) trash receptacles are dispersed in a manner convenient for all units. We note that initially only three (3) trash receptacles were proposed on-site, and the applicant added a fourth trash receptacle following the April 9th Planning Commission meeting.

Items to be Addressed: None.

TRAFFIC

In an August 23rd, 2023 memo, OHM has reviewed traffic.

Traffic Counts:

Land Use	Number	ITE	Number of Site Generation Trips								
	of Units	Land	AM Peak Hour			PM	Peak H	lour	Daily		
		Use	In	Out	Total	In	Out	Total	In	Out	Total
		Code									
Single	6	210	1	5	6	4	3	7	38	38	76
Family											
Detached											
Single	38	215	4	10	14	11	8	19	120	120	240
Family											
Attached											
Site To	otals – 44 ui	nits	5	15	20	15	11	26	158	158	316

OHM Conclusion

Traffic volumes are closely correlated with the number of residential units. Essentially all the trips generated by the Village of Hastings development will be delivered directly to Livernois Road, an arterial roadway, which will increase slightly over current conditions. The traffic generated by the proposed development would be minimal, adding less than 30 vehicle trips during the peak ("busiest") hour. This equates to approximately one vehicle every 2-3 minutes during the peak hours. The traffic impact of this site on the adjacent road network is negligible and would be imperceptible to the majority of road users.

Items to be Addressed: None.

PHOTOMETRICS

The types of fixtures and footcandle measurements proposed are compliant with lighting standards. In regard to fixture height, the applicant notes: "No fixture to be mounted greater than 25 feet above grade. Fixtures at sports court to be no more than 15 feet above grade."

Items to be Addressed: None.

FLOOR PLAN AND ELEVATIONS

Floor Plans

Ranch Unit:

The front façade of the ranch allows entry into the unit via the front door and through the garage. The unit features three (3) bedrooms, two (2) restrooms, a great room, kitchen, nook area, and laundry room. Ranch units can be built with either a 2-car garage or 3-car garage. The applicant has confirmed that this choice shall be made by the buyer at the time of sale. Ranch units with a 3-car garage will be slightly larger in width and will include a covered patio in the rear yard.

Ranch Duplex Unit:

Each ranch duplex unit is accessed via the front door or the 2-car garage. The unit includes (3) bedrooms, two (2) restrooms, a great room, kitchen, nook area, laundry room, and mud room.

2-story Duplex Unit:

The first floor of each 2-story duplex unit includes a 2-car garage, mechanical equipment area, and stairs. The main door entrance is located on the side of the unit. The second floor includes the living room, kitchen, laundry area, two (2) bedrooms, and one (1) restroom.

Multi-Unit ROW Homes/Townhouse:

The first floor of these units is where the 19' x 20' garage, living room, dining area, kitchen, pantry, and one (1) restroom are located. The second floor includes three (3) bedrooms, two (2) restrooms, and a laundry room. One (1) restroom is located in a common area and the other is solely accessible through the primary bedroom.

Elevations

The maximum proposed height of all housing units is 30 feet tall.

Building Materials

Overall, the same general building materials are proposed for all housing types at this development. These materials include asphalt shingles, brick veneer, board and batten siding, painted wood trim, and insulated vinyl windows. The only notable differences in materials are that the ROW homes also contain limestone veneer and the ranch duplexes have a couple of small areas with metal roofing. Colored renderings indicate that all housing types shall have a similar color scheme, including shades of red, orange, brown, white, gray, and black.

We note that since the April 9th Planning Commission meeting, the applicant has revised aspects of the building design to address architectural concerns. The "snout nose" appearance of the ranch units has been reduced, and more windows and architectural details have been incorporated to enhance natural light and building appearance. See the latest colored renderings below.

Rendering of Detached Ranch Unit, Dated May 14, 2024.



Rendering of Ranch Duplex Unit, Dated May 14, 2024.



Rendering of 2-story Duplex Unit, Dated May 14, 2024.



Rendering of Multi-Unit Townhouse, Dated May 14, 2024.



In light of these changes, we recommend the Planning Commission evaluate the proposed architecture in accordance with Site Plan Review Design Standards of Section 8.06.

Items to be Addressed: Planning Commission to evaluate proposed architecture in accordance with Site Plan Review Design Standards of Section 8.06.

PUD STANDARDS

As set forth in section 11.03, Standards for Approval, it should be demonstrated that the following standards will be met, as reasonably applicable to the site:

- The applicant shall demonstrate that through the use of the PUD option, the development will accomplish a sufficient number of the following objectives, as are reasonably applicable to the site, providing:
- 2. A mixture of land uses that would otherwise not be permitted without the use of the PUD provided that other objectives of this Article are also met.
- 3. A public improvement or public facility (e.g. recreational, transportation, safety and security) which will enhance, add to or replace those provided by public entities, thereby furthering the public health, safety and welfare.
- 4. A recognizable and material benefit to the ultimate users of the project and to the community, where such benefit would otherwise be infeasible or unlikely to be achieved absent these regulations.
- 5. Long-term protection and preservation of natural resources, natural features, and historic and cultural resources, of a significant quantity and/or quality in need of protection or preservation, and which would otherwise be unfeasible or unlikely to be achieved absent these regulations.
- 6. A compatible mixture of open space, landscaped areas, and/or pedestrian amenities.
- 7. Appropriate land use transitions between the PUD and surrounding properties.
- 8. Design features and techniques, such as green building and low impact design, which will promote and encourage energy conservation and sustainable development.
- 9. Innovative and creative site and building designs, solutions and materials.
- 10. The desirable qualities of a dynamic urban environment that is compact, designed to human scale, and exhibits contextual integration of buildings and city spaces.
- 11. The PUD will reasonably mitigate impacts to the transportation system and enhance non-motorized facilities and amenities.
- 12. For the appropriate assembly, use, redevelopment, replacement and/ or improvement of existing sites that are occupied by obsolete uses and/or structures.
- 13. A complementary variety of housing types that is in harmony with adjacent uses.
- 14. A reduction of the impact of a non-conformity or removal of an obsolete building or structure.
- 15. A development consistent with and meeting the intent of this Article, which will promote the intent of the Master Plan or the intent of any applicable corridor or sub-area plans. If conditions have changed since the Plan, or any applicable corridor or sub-area plans were adopted, the uses shall be consistent with recent development trends in the area.
- 16. Includes all necessary information and specifications with respect to structures, heights, setbacks, density, parking, circulation, landscaping, amenities and other design and layout features, exhibiting a due regard for the relationship of the development to the surrounding properties and uses thereon, as well as to the relationship between the various elements within the proposed Planned Unit Development. In determining whether these relationships have been appropriately addressed, consideration shall be given to the following:
 - a. The bulk, placement, and materials of construction of the proposed structures and other site improvements.
 - b. The location and screening of vehicular circulation and parking areas in relation to surrounding properties and the other elements of the development.

- c. The location and screening of outdoor storage, loading areas, outdoor activity or work areas, and mechanical equipment.
- d. The hours of operation of the proposed uses.
- e. The location, amount, type and intensity of landscaping, and other site amenities.
- 17. Parking shall be provided in order to properly serve the total range of uses within the Planned Unit Development. The sharing of parking among the various uses within a Planned Unit Development may be permitted. The applicant shall provide justification to the satisfaction of the City that the shared parking proposed is sufficient for the development and will not impair the functioning of the development, and will not have a negative effect on traffic flow within the development and/or on properties adjacent to the development.
- 18. Innovative methods of stormwater management that enhance water quality shall be considered in the design of the stormwater system. 18. The proposed Planned Unit Development shall be in compliance with all applicable Federal, State and local laws and ordinances, and shall coordinate with existing public facilities.

SITE PLAN REVIEW STANDARDS

Site Plan review standards provide the Planning Commission with direction when reviewing the proposed site plan and design features of this development.

Section 8.06 outlines Site Plan Review Design Standards.

- 1. Development shall ensure compatibility to existing commercial districts and provide a transition between land uses.
 - a. Building design shall enhance the character of the surrounding area in relation to building and parking placement, landscape and streetscape features, and architectural design.
 - b. Street fronts shall provide a variety of architectural expression that is appropriate in its context and prevents monotony.
 - c. Building design shall achieve a compatible transition between areas with different height, massing, scale, and architectural style.
- 2. Development shall incorporate the recognized best architectural building design practices.
 - a. Foster a lasting impact on the community through the provision of high quality design, construction, and detailing.
 - b. Provide high quality, durable materials, such as but not limited to stone, brick, glass, and metal. E.I.F.S. or material equivalent shall only be used as an accent material.
 - c. Develop buildings with creativity that includes balanced compositions and forms.
 - d. Design roofs that are appropriate to the architectural style of the building and create an appropriate visual exterior mass of the building given the context of the site.

- e. For commercial buildings, incorporate clearly defined, highly visible customer entrances using features such as canopies, porticos, arcades, arches, wing walls, ground plane elements, and/or landscape planters.
- f. Include community amenities that add value to the development such as patio/ seating areas, water features, art work or sculpture, clock towers, pedestrian plazas with park benches or other features located in areas accessible to the public.
- 3. Enhance the character, environment and safety for pedestrians and motorists.
 - a. Provide elements that define the street and the pedestrian realm.
 - b. Create a connection between the public right of way and ground floor activities.
 - c. Create a safe environment by employing design features to reduce vehicular and pedestrian conflict, while not sacrificing design excellence.
 - d. Enhance the pedestrian realm by framing the sidewalk area with trees, awnings, and other features.
 - e. Improve safety for pedestrians through site design measures.

SUMMARY

The Planning Commission has seen several revisions of the proposed project. We recommend the Planning Commission discuss whether the current proposal is consistent with the Master Plan, whether it meets the site plan design standards, and whether it meets the PUD standards.

Sincerely,

CARLISLE/WORTMAN ASSOC., INC. Benjamin R. Carlisle, AICP, LEED AP

President

CARLISLE/WORTMAN ASSOC., INC.

Shana Kot

Community Planner

600-2 빞


UL OR O

PLANNED UNIT DEVELOPMENT CONCEPT DEVELOPMENTAL PLAN

THE VILLAGE OF HASTINGS

PART OF THE SW 1/4 OF SECTION 3, T. 02N., R. 11E., CITY OF TROY, OAKLAND COUNTY, MICHIGAN

PERMIT / APPROVAL SUMMARY DATE SUBMITTED DATE APPROVED PERMIT / APPROVAL

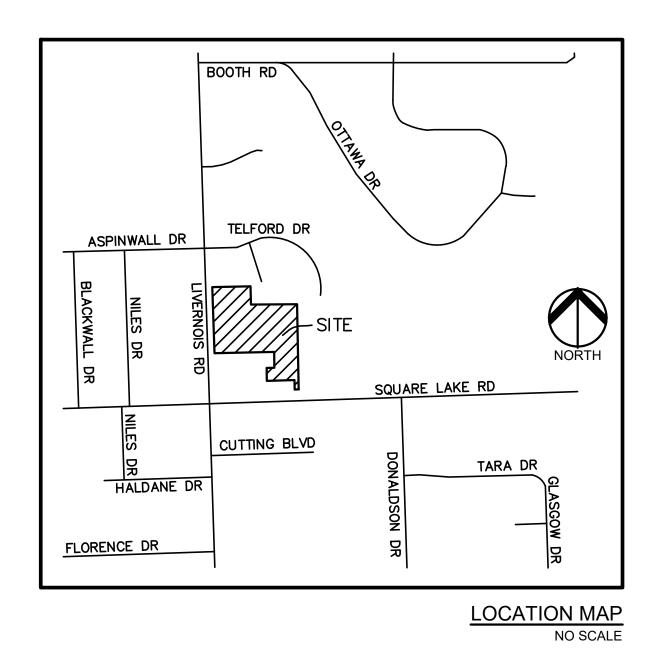

GROUP

DESIGN TEAM

OWNER/APPLICANT/DEVELOPER

GFA DEVELOPMENT, INC. PEA GROUP 986 ELMSFORD DRIVE 1849 POND RUN TROY, MI 48083 AUBURN HILLS, MI 48326 CONTACT: GARY ABITHEIRA CONTACT: JOHN B. THOMPSON, PE PHONE: 248.840.2828 PHONE: 844.813.2949 EMAIL: GABITHEIRA@WIDEOPENWEST.COM EMAIL: JTHOMPSON@PEAGROUP.COM

ARCHITECT

MOISEEV/GORDON ASSOCIATES, INC. 4351 DELEMERE COURT ROYAL OAK, MI 48073 CONTACT: ANDREW MOISEEV, RA PHONE: 248.549.4500

EMAIL: ANDREWM@MGA-ARCHITECTS.NET

PEA GROUP 45 W. GRAND RIVER AVE., STE. 501 DETROIT, MI 48226 CONTACT: KIMBERLY DIETZEL, RLA PHONE: 844.813.2949 EMAIL: KDIETZEL@PEAGROUP.COM

LANDSCAPE ARCHITECT

CIVIL ENGINEER



T-1.1	TREE PRESERVATION LIST
	ARCHITECTURAL PLANS
A100	FIRST FLOOR UNIT PLAN
A200	ELEVATIONS
A300	3D VIEWS
A100	FIRST FLOOR UNIT PLAN
A200	ELEVATIONS - OPTION A
A200	ELEVATIONS - OPTION B
A300	3D VIEWS - OPTION A
A300	3D VIEWS - OPTION B
A100	FIRST FLOOR UNIT PLAN
A200	ELEVATIONS
A300	3D VIEWS
A101	FIRST FLOOR UNIT PLANS
A102	STANDARD SECOND FLOOR UNIT PLANS
A200	STANDARD NORTH & SOUTH ELEVATIONS
A201	STANDARD EAST & WEST ELEVATION
A400	STANDARD AXONMETRIC VIEWS
A100	FIRST FLOOR PLAN
A101	SECOND FLOOR PLAN
A200	ELEVATIONS
A300	3D VIEWS

INDEX OF DRAWINGS

NUMBER TITLE

COVER SHEET

TOPOGRAPHIC SURVEY

PRELIMINARY SITE PLAN

ADDITIONAL SITE DETAILS

PRELIMINARY GRADING PLAN


PRELIMINARY LANDSCAPE PLAN

PRELIMINARY UTILITY PLAN


TREE PRESERVATION PLAN

LANDSCAPE DETAILS

TRASH VEHICLE CIRCULATION PLAN

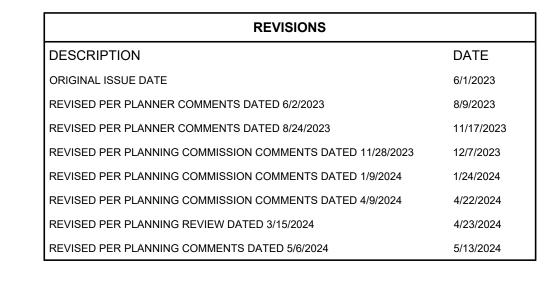



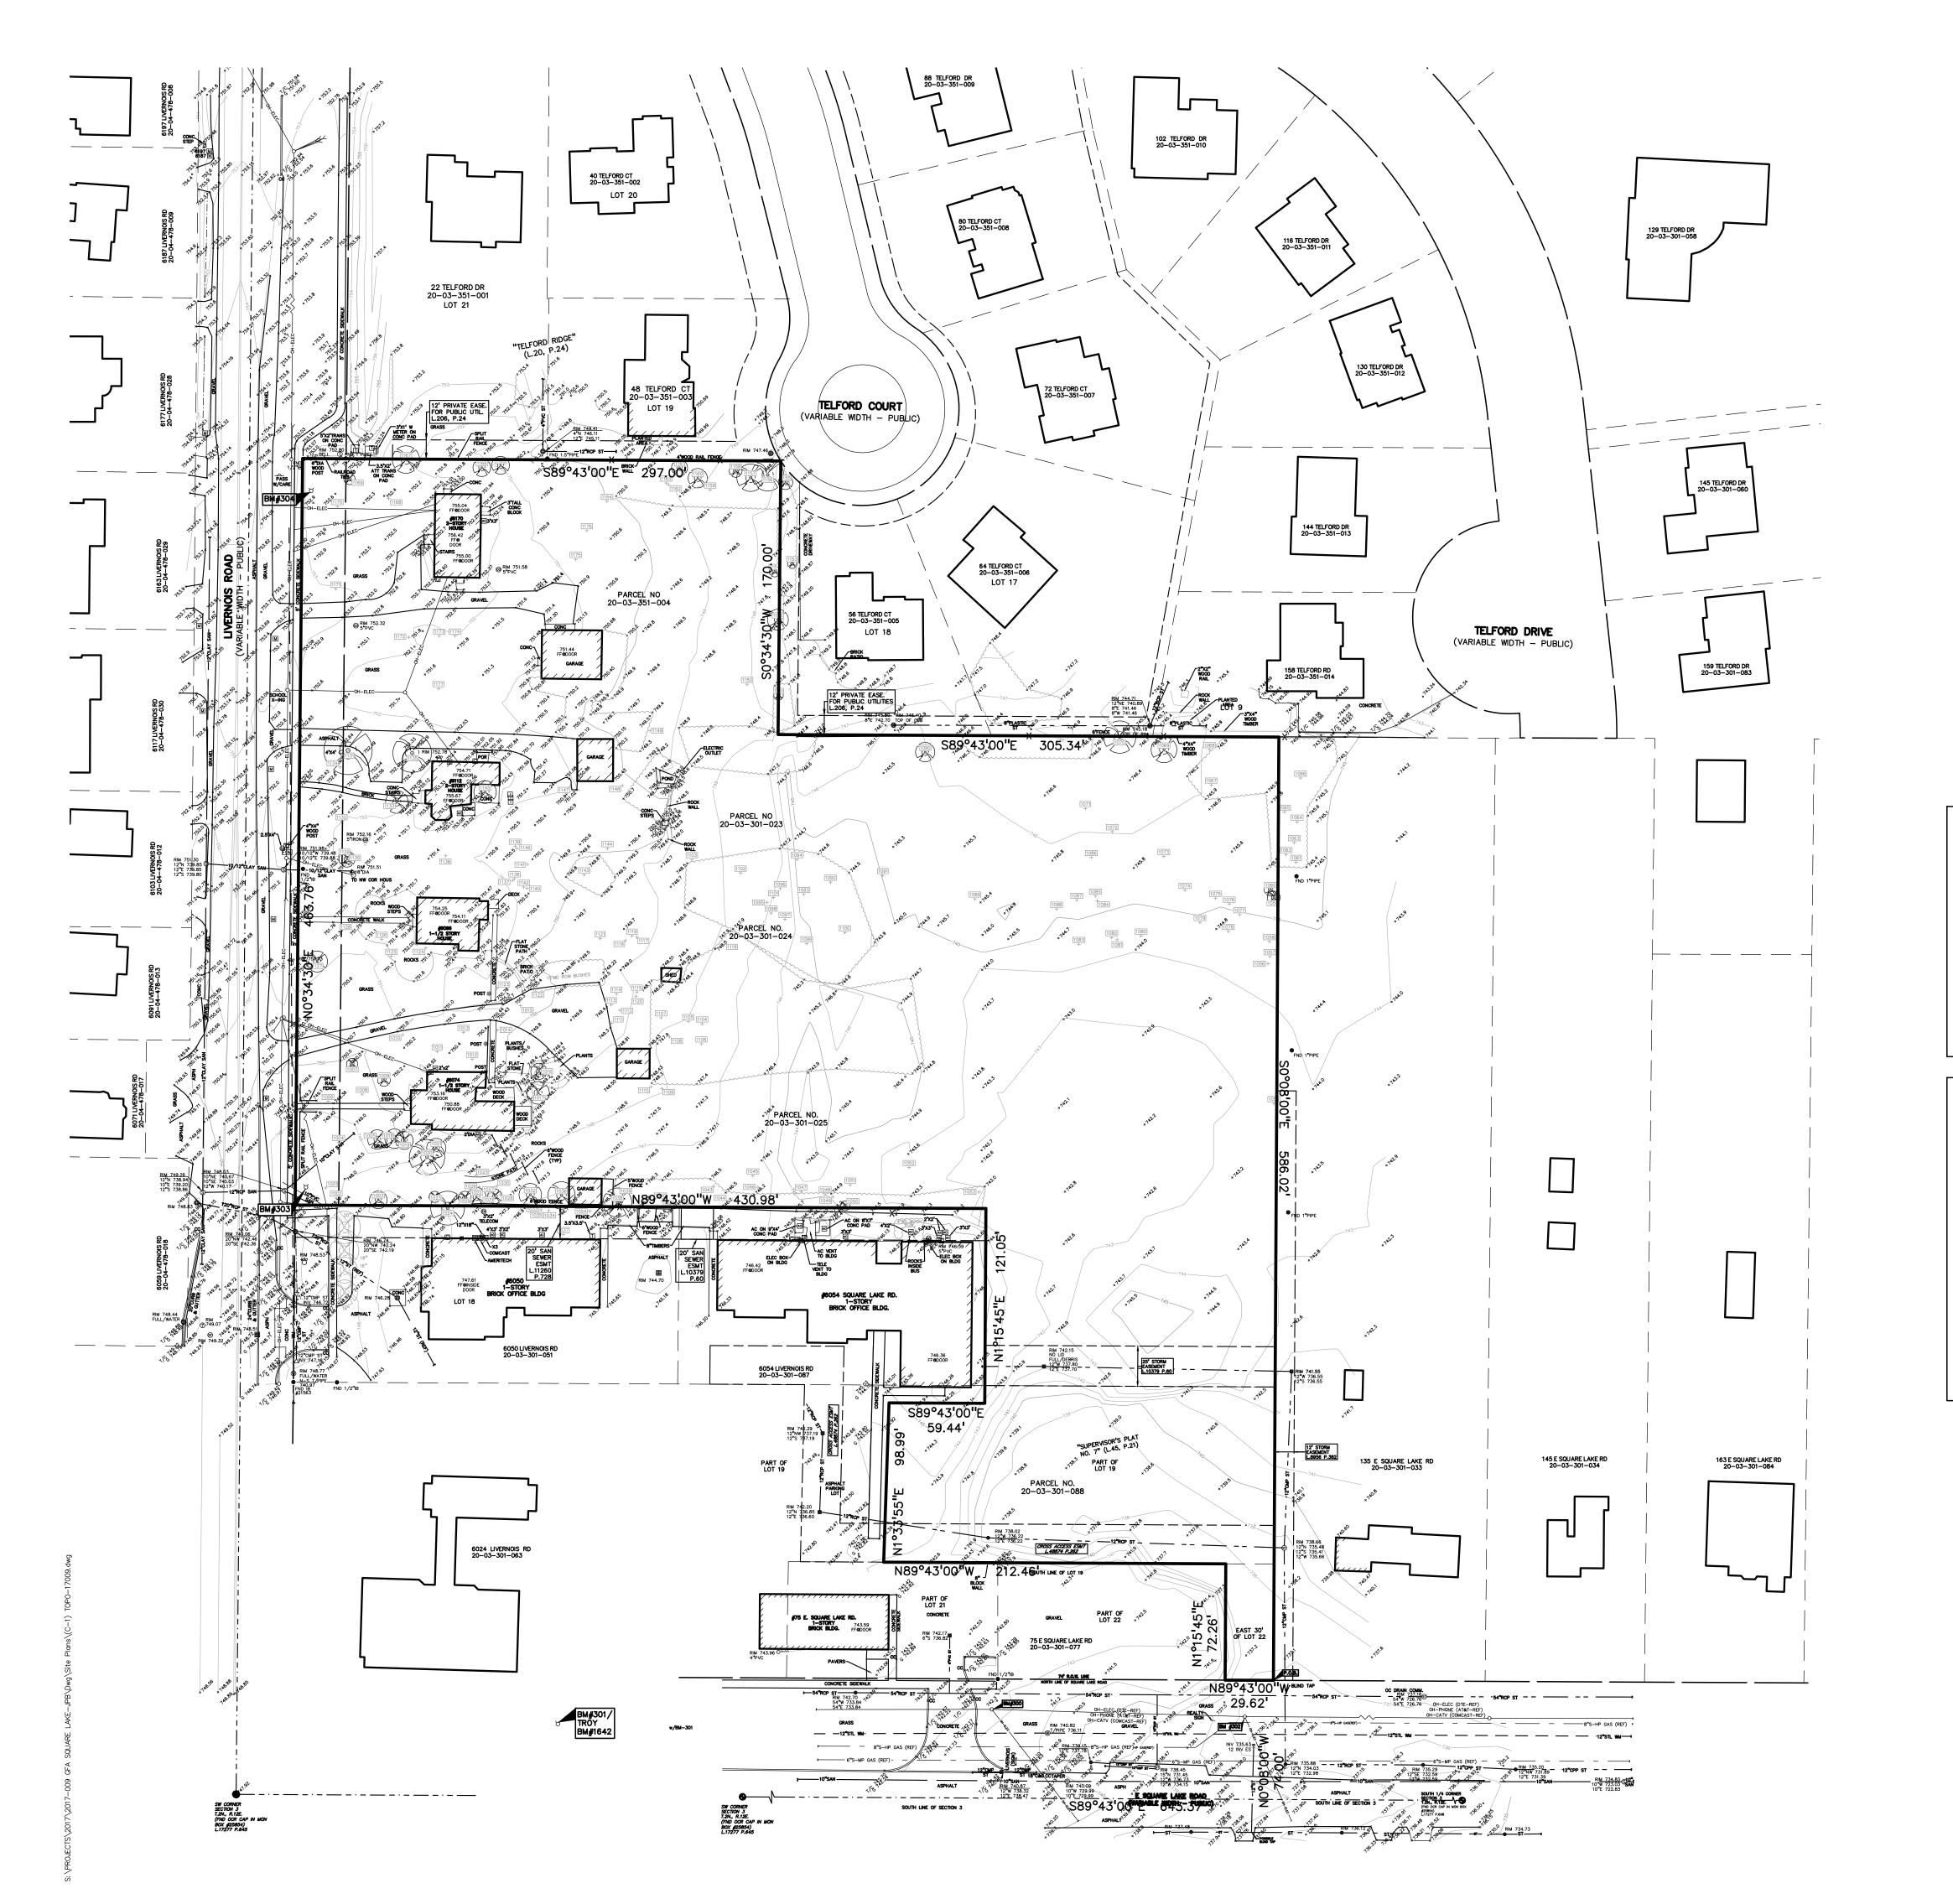

LEGEND

IRON FOUND MAIL FOUND

Ø NAIL & CAP SET

BRASS PLUG SET MONUMENT FOUND MONUMENT SET

R RECORDED M MEASURED

SEC. CORNER FOUND C CALCULATED

-OH-ELEC-W-O- ELEC., PHONE OR CABLE TV O.H. LINE, POLE & GUY WIRE -UG-CATV-TV- UNDERGROUND CABLE TV, CATV PEDESTAL

-⊠-UG-PHONE-①--- TELEPHONE U.G. CABLE, PEDESTAL & MANHOLE -UG-ELEC-E-E-E- ELECTRIC U.G. CABLE, MANHOLE, METER & HANDHOLE — GAS MAIN, VALVE & GAS LINE MARKER — WATERMAIN, HYD., GATE VALVE, TAPPING SLEEVE & VALVE SANITARY SEWER, CLEANOUT & MANHOLE — - - ST STORM SEWER, CLEANOUT & MANHOLE SQUARE, ROUND & BEEHIVE CATCH BASIN, YARD DRAIN POST INDICATOR VALVE WATER VALVE BOX/HYDRANT VALVE BOX, SERVICE SHUTOFF

M T I MAILBOX, TRANSFORMER, IRRIGATION CONTROL VALVE UNIDENTIFIED STRUCTURE SPOT ELEVATION -----670 ------ CONTOUR LINE -X-X-X- FENCE ☆ STREET LIGHT

✓ ASPH. ✓

CONC. →

── SIGN

GRAVEL SHOULDER __GRAVEL__ THE THE THE WETLAND

REFERENCE DRAWINGS

PRELIMINARY ALTA/NSPS SURVEY, PEA JOB NO. 2017-009, DATED JANUARY 24, 2018 CABLE COMCAST MAP NO. 1319-404, DATED 4/03/07

ELECTRIC DTE MAP 316-404 & 319-404, DATED 2/15/2017 AT&T SKETCH VIA EMAIL, DATED 01/15/2017 PHONE CONSUMERS ENERGY QUARTER SECTION MAP NO. 02-61-03-3, DATED 10-16-14

CITY OF TROY GIS ONLINE SANITARY SEWER CITY OF TROY GIS ONLINE SEWER & WATER CITY OF TROY GIS ONLINE STORM SEWER

CITY OF TROY GIS ONLINE OAKLAND COUNTY WATER RESOURCES COMMISSION - KING DRAIN MAP SHEET #11 SW SECTION 3 KING DRAIN, OAKLAND COUNTY DRAIN COMMISSIONER JOB NO. 880119, SHEET NO. 3, DATED 5-10-93, AS-BUILT 5-1-98

STORM DRAIN SYSTEMS, SHEET 011, WATER RESOURCES

GROUP www.peagroup.com





CAUTION!! THE LOCATIONS AND ELEVATIONS OF EXISTING UNDERGROUND UTILITIES AS SHOWN ON THIS DRAWING ARE ONLY APPROXIMATE. NO GURANTEE IS EITHER EXPRESSED OR IMPLIED AS TO THE COMPLETENESS OR ACCURACY THEREOF. THE CONTRACTOR SHALL BE EXCLUSIVELY RESPONSIBLE FOR DETERMINING THE EXACT UTILITY LOCATIONS AND ELEVATIONS PRIOR TO THE START OF CONSTRUCTION.

Legal Description (Combined Parcel Per PEA Group)

Containing 6.313 acres of land more or less.

Part of Lots 19 and 22 of "Supervisors Plat No. 7" as recorded in Liber 45 on pages 21 and 21A, Oakland County Records, together with part of the Southwest 1/4 of Section 3, Town 2 North, Range 11 East, City of Troy, Oakland County Michigan and being more particularly described as Commencing at the Southwest Corner of said Section 3; thence along the south line of said section, S89°43'00"E, 643.50 feet; thence N00°08'00"W, 74.00 feet to the north line of East Square Lake Road, 74' half width, and the Point of Beginning; thence along said north line, N89°43'00"W, 29.62 feet; thence N01°15'45"E, 72.26 feet to the north line of said Lot 22, said line also being the south line of said Lot 19; thence along said south line N89°43'00"W, 212.46 feet; thence N01°33'55"E, 98.99 feet; thence S89°43'00"E, 59.44 feet; thence N01°15'45"E, 121.05 feet to the easterly extension of the north line of Lot 18 of said Supervisors Plat; thence along said line, N89°43′00″W, 430.98 feet to the east line of Livernois Road, 33′ half width; thence along said east line, N00°34'30"E, 463.76 feet to the easterly extension of the south line of "Telford Ridge" as recorded in Liber 206, page 24 Oakland County Records; thence along said south line, S89°43'00"E, 297.00 feet to the west line of said Telford Ridge; thence along said west line, S00°34'30"W, 170.00 feet to the south line of said Telford Ridge, said line also being the north line of the south 660 feet of the southwest 1/4 of said Section 3; thence along said south line, S89°43'00"E, 305.34 feet to the west line of tax parcel 20-03-301-033; thence along said west line,S00°08'00"E, 586.02 feet to the aforementioned north line of East Square Lake Road and the Point of Beginning.

BENCHMARKS

(CITY OF TROY DATUM)

BM #300
SET BENCHTIE IN SOUTHEAST FACE OF POWER LIGHT POLE, NORTH SIDE OF SQUARE LAKE ROAD APPROX. 70' SOUTHEAST OF SOUTHEAST BUILDING CORNER OF JOHN'S MARKET AT EAST SIDE OF DRIVE ENTRANCE. ELEV. - 743.36

BM #301 - CITY OF TROY BM #1642 ARROW ON A HYDRANT LOCATED ON THE NORTH SIDE OF SQUARE LAKE ROAD, APPROX. 200' EAST OF LIVERNOIS ROAD AT THE PNC BANK. ELEV. - 750.08

BM #302
FOUND BOAT SPIKE IN SOUTH FACE OF UTILITY POLE, NORTH SIDE OF SQUARE LAKE ROAD, AT THE CENTERLINE OF 30' WIDE SITE FRONTAGE. ELEV — 737.51

ARROW ON HYDRANT, EAST SIDE OF LIVERNOIS, APPROX. 75' SOUTHWEST OF #6074 LIVERNOIS.

ELEV - 750.66

ARROW ON HYDRANT, EAST SIDE OF LIVERNOIS, APPROX. 80' WEST OF #6170 LIVERNOIS. ELEV - 755.18

DEVELOPMENT, 3301 MIRAGE DRIVE TROY, MI 48083

PROJECT TITLE

THE VILLAGE **OF HASTINGS** PART OF THE SW 1/4 OF SECTION 3, T. 02N., R. 11E.,


REVISIONS REV. PER COMMENTS 6/2/2023 8/9/2023 REV. PER COMMENTS 8/24/2023 11/17/2023 REV. PER PC COMMENTS 11/28/2023 12/7/2023 REV. PER PC COMMENTS 1/9/2024 1/24/2024 REV. PER PC COMMENTS 4/9/2024 4/22/2024 REV. PER REVIEW 3/15/2024 4/23/2024 REV. PER PLANNING 5/6/2024


ORIGINAL ISSUE DATE: JUNE 1, 2023

DRAWING TITLE

TOPOGRAPHIC SURVEY

PEA JOB NO.	2017-009
P.M.	KR
DN.	EH
DES.	EH
DRAWING NUMBER:	

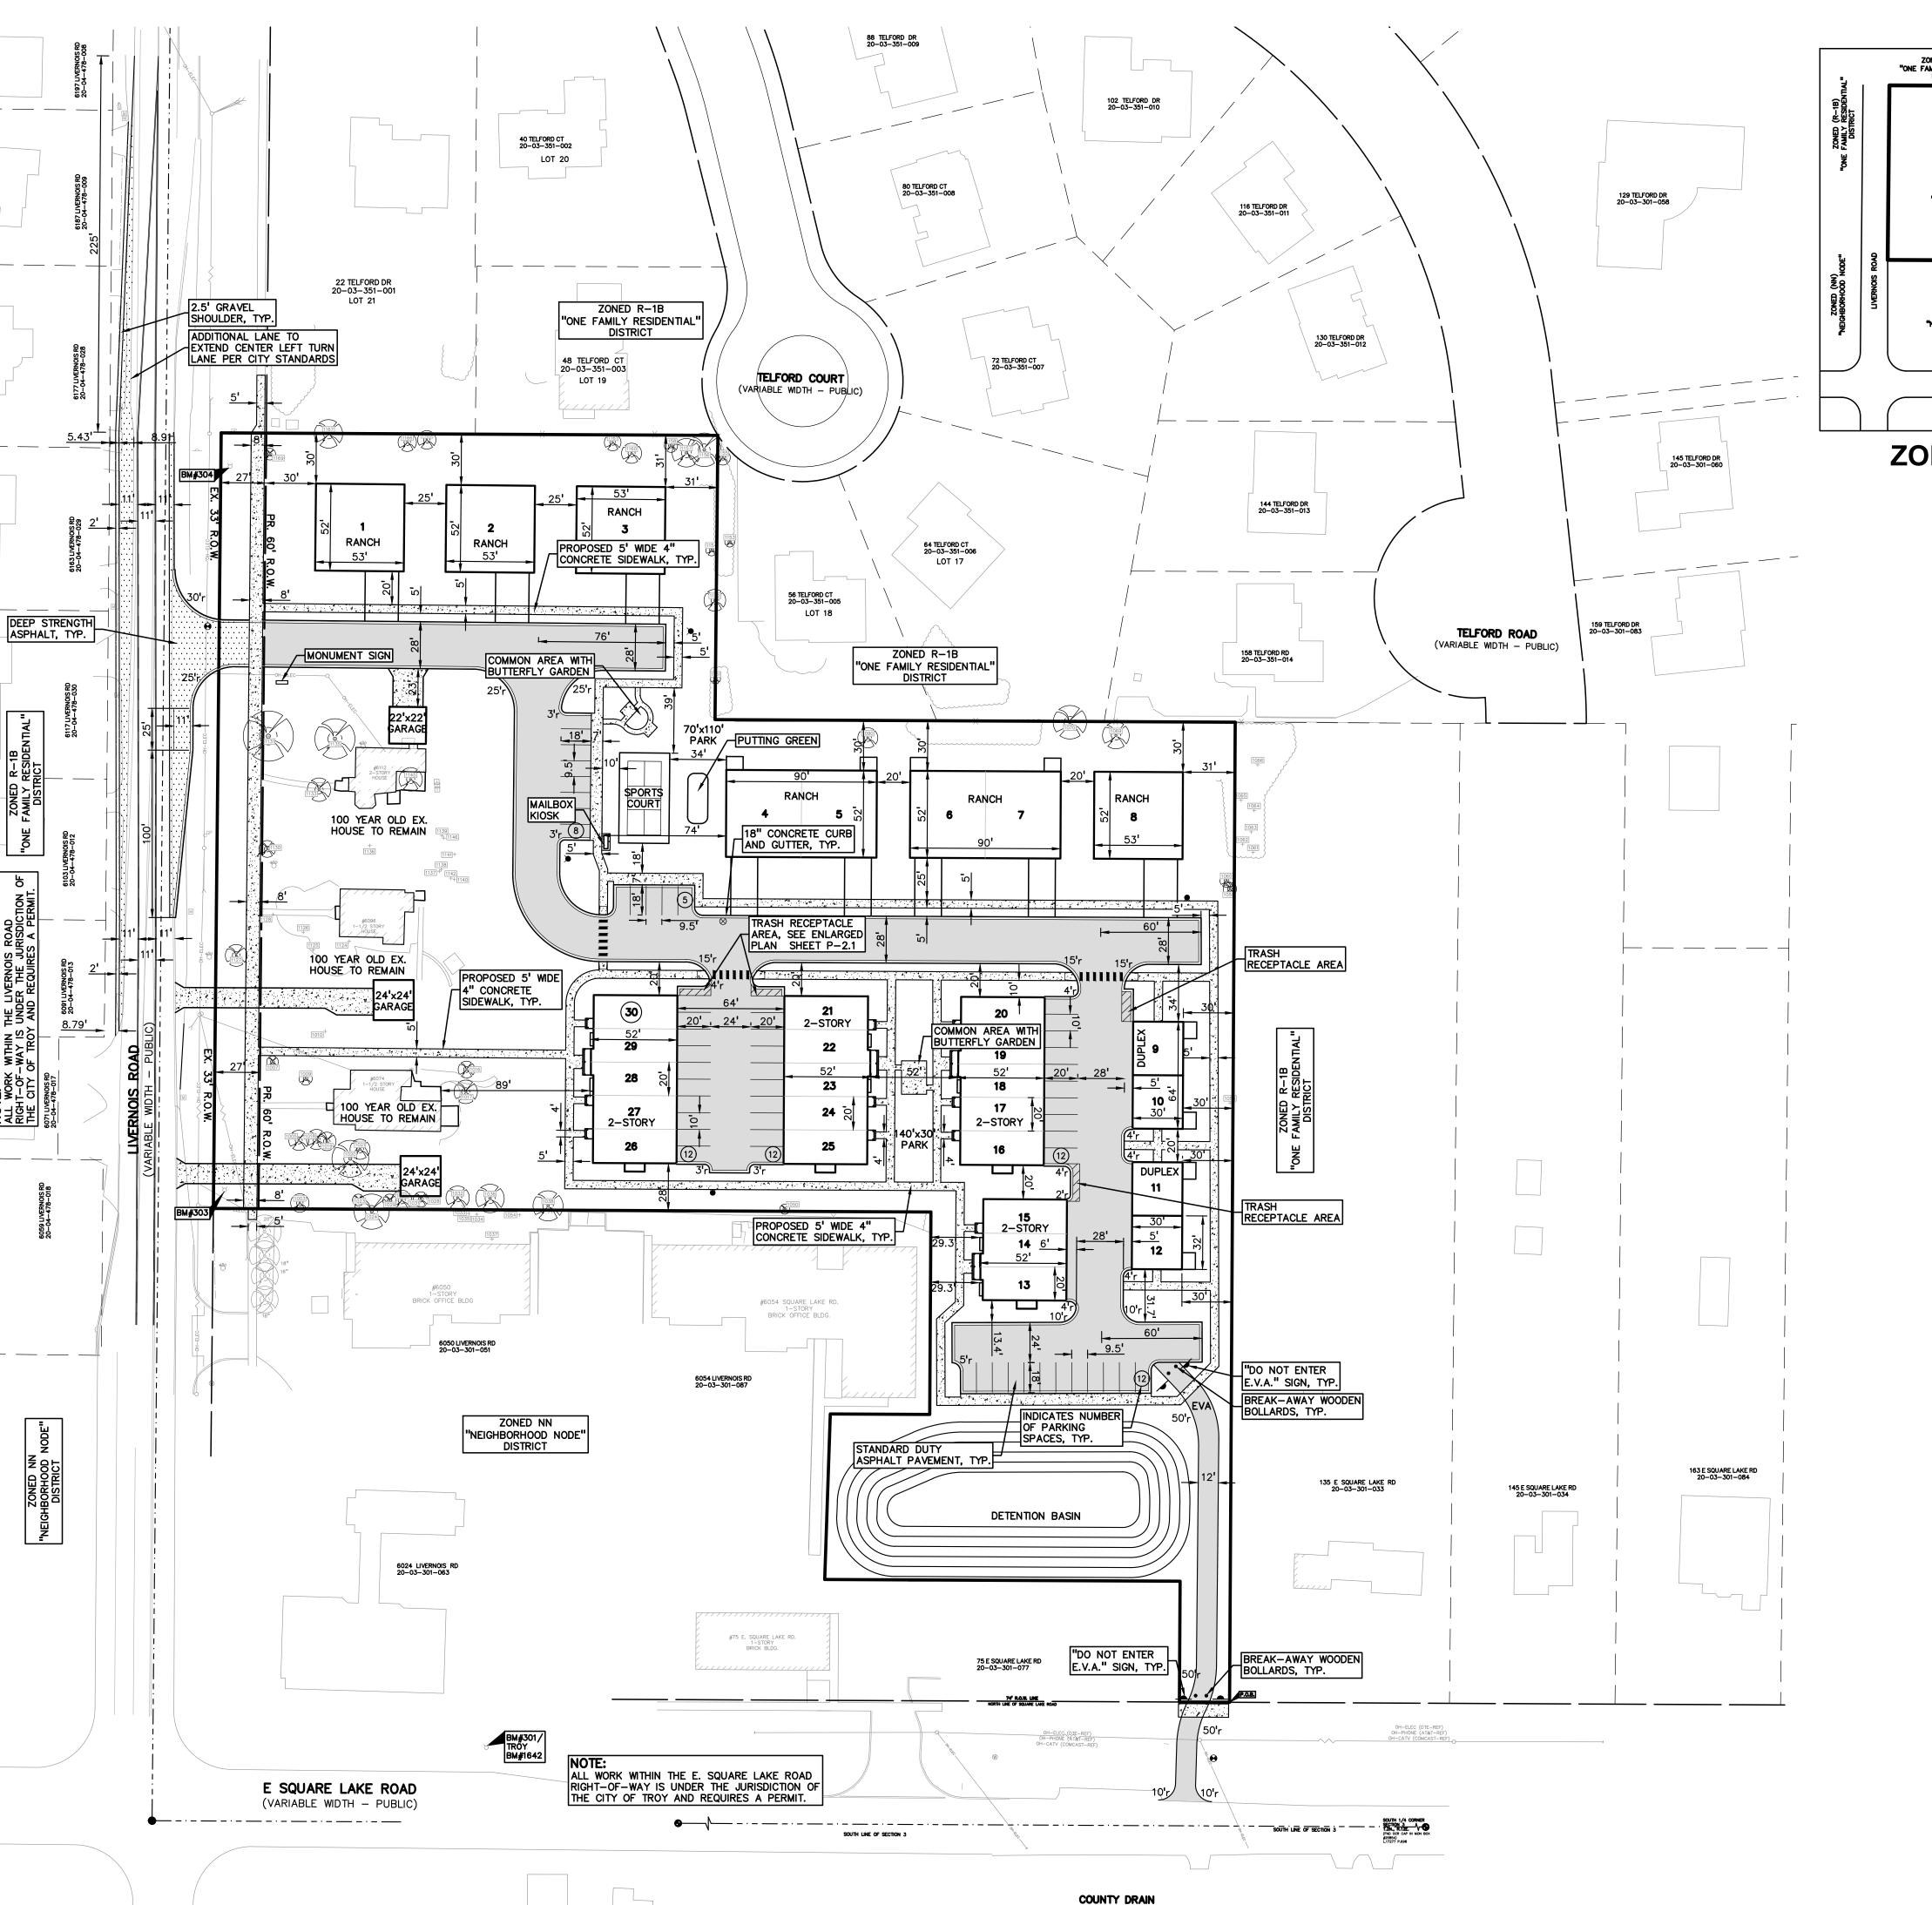


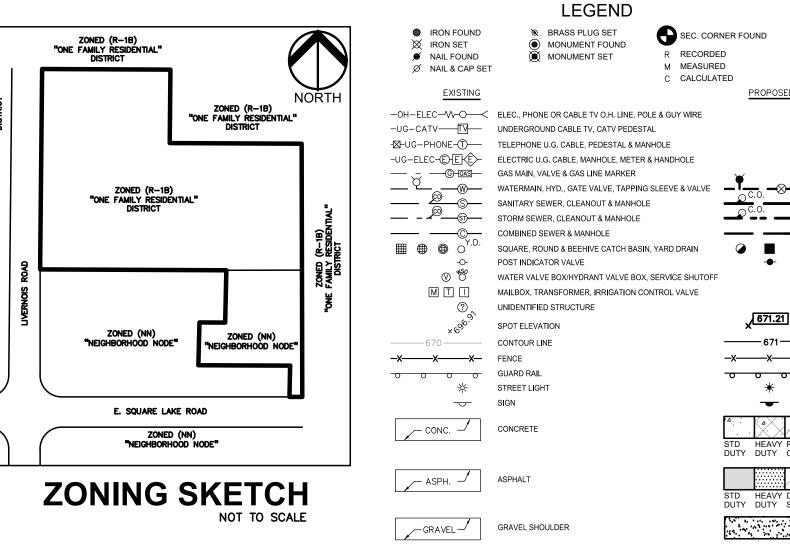

GROUP www.peagroup.com 671 -x----x---x-0 0 0



t: 844.813.2949

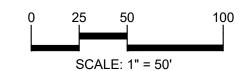



CAUTION!!

THE LOCATIONS AND ELEVATIONS OF EXISTING UNDERGROUND UTILITIES AS SHOWN ON THIS DRAWING ARE ONLY APPROXIMATE. NO GUARANTEE IS EITHER EXPRESSED OR IMPLIED AS TO THE COMPLETENESS OR ACCURACY THEREOF. THE CONTRACTOR SHALL BE EXCLUSIVELY RESPONSIBLE FOR DETERMINING THE EXACT UTILITY LOCATIONS AND ELEVATIONS PRIOR TO THE START OF CONSTRUCTION. SITE DATA: LOCATION OF PROJECT:
LIVERNOIS ROAD, NORTH OF SQUARE LAKE ROAD SIZE OF PROPERTY: 6.31 ACRES GROSS, 6.05 ACRES NET PROPOSED USE OF PROPERTY: THREE (3) EXISTING HOMES TO REMAIN, EIGHT (8) RANCH STYLE SINGLE FAMILY HOMES, EIGHTEEN (18) 2 STORY ATTACHED SINGLE FAMILY HOMES, FOUR (4) SINGLE FAMILY DUPLEX HOMES. PROPOSED ZONING: PUD, PLANNED RESIDENTIAL DEVELOPMENT SURROUNDING PROPERTY DETAILS: ZONING R-1B, ONE-FAMILY RESIDENTIAL DISTRICT SINGLE-FAMILY HOMES COMMERCIAL SINGLE-FAMILY HOMES NEIGHBORHOOD NODE Q R-1B, ONE-FAMILY RESIDENTIAL DISTRICT WEST NEIGHBORHOOD NODE Q COMMERCIAL REQUIRED AND PROVIDED LOT DIMENSIONS: 10'(NN) & 40'(R-1B) SETBACK 30' SETBACK FRONT 30'(NN) & 45'(R-1B) SETBACK 30' SETBACK REAR SIDES N/A(NN) & 12.5(R-1B) SETBACK 29.3' SETBACK MAXIMUM HEIGHT 4 STORIES/55'(NN), 30 FEET, 2 STORY 2.5 STORIES/30'(R-1B) OPEN SPACE LOT COVERAGE BY ALL BLDGS 30%(NN)

SECTION 3, T. 02N., R. 11E., 25 SURFACE LOT SPACES + 42 DRIVEWAY SPACES + 30 GARAGES SPACES = 97 PARKING SPACES PROJECT AND SITE DESCRIPTION:
PROPOSED DEVELOPMENT OF A 33-UNIT RESIDENTIAL CONDOMINIUM LOCATED ON
LIVERNOIS ROAD NORTH OF SQUARE LAKE ROAD. THE SITE CONSISTS OF 26 ATTACHED
UNITS AND 4 DETACHED SINGLE FAMILY UNITS, ACCOMPANYING THE DEVELOPMENT IS THE PRESERVATION OF 3 CENTENNIAL SINGLE FAMILY HOUSES. ACCESS TO ALL UNITS WILL BE VIA CONNECTION TO LIVERNOIS ROAD, WITH TWO OF THE PRESERVED HOUSES HAVING DIRECT ACCESS TO LIVERNOIS, AND AN EMERGENCY VEHICLE ACCESS (EVA) WILL BE

NATURAL RESOURCES:
THE SITE CURRENTLY HAS MODERATE TREE COVER.

FOR THIS PROPERTY.

THE PROPERTY IS NOT LOCATED WITHIN THE FLOOD HAZARD AREA INDICATED BY FLOOD INSURANCE RATE MAP (FIRM) NO. 26125C0532F DATED: SEPTEMBER 29, 2006 (ZONE X).

PROVIDED TO SQUARE LAKE ROAD. THE PROPOSED RESIDENTIAL USE IS PERMITTED

BY-RIGHT IN THE (NN) NEIGHBORHOOD NODE Q DISTRICT AND THE R-1B PORTION OF THE SITE. DUE TO THE MIXED HOUSING PRODUCTS AND MIXED ZONING A PUD IS PROPOSED

2 SPACES PER DWELLING UNIT = 2 SPACES x 30 UNITS = 60 REQUIRED PARKING SPACES

PER THE 2022 SEMCOG WETLAND DATA, THE SITE CONTAINS NO WETLANDS. ACCESS AND CIRCULATION:

VEHICULAR ACCESS AND CIRCULATION: VEHICULAR ACCESS TO ALL UNITS WILL BE VIA A PRIVATE ROAD OFF OF LIVERNOIS ROAD. THE NEW ROAD WILL HAVE A TWENTY-EIGHT (28) FOOT WIDE ACCESS AGREEMENT. AN EVA WILL BE PROVIDED TO SQUARE LAKE ROAD.

PEDESTRIAN ACCESS AND CIRCULATION: SIDEWALKS ARE PROVIDED AT BUILDING ENTRANCES TO PARKING FIELDS. THIS WILL BE A WALK FRIENDLY DEVELOPMENT WITH CIRCULATION THROUGHOUT THE DEVELOPMENT WITH CONNECTIONS TO LIVERNOIS ROAD VIA THE EVA.

<u>UTILITIES:</u>
UTILITIES ARE PLACED WITHIN EASEMENTS APPROVED AS TO SIZE AND LOCATION BY THE

ALL SITES ARE SERVED BY PUBLIC WATER, SANITARY SEWER, STORM WATER AND DETENTION/RETENION SYSTEMS CONSTRUCTED TO CITY STANDARDS, AT THE EXPENSE OF THE DEVELOPER. EASEMENTS OVER THESE SYSTEMS SHALL BE CONVEYED AND RECORDED BEFORE OCCUPANCY PERMITS ARE ISSUED FOR DWELLING UNITS.

100-YEAR DETENTION IS PROPOSED WITH A RESTRICTED OUTLET DISCHARGING THROUGH CITY OF TROY STORM SEWER.

CLIENT

GFA DEVELOPMENT, 3301 MIRAGE DRIVE TROY, MI 48083

PROJECT TITLE

THE VILLAGE **OF HASTINGS** PART OF THE SW 1/4 OF


REVISIONS	
REV. PER COMMENTS 6/2/2023	8/9/2023
REV. PER COMMENTS 8/24/2023	11/17/2023
REV. PER PC COMMENTS 11/28/2023	12/7/2023
REV. PER PC COMMENTS 1/9/2024	1/24/2024
REV. PER PC COMMENTS 4/9/2024	4/22/2024
REV. PER REVIEW 3/15/2024	4/23/2024
REV. PER PLANNING 5/6/2024	5/13/2024

ORIGINAL ISSUE DATE: JUNE 1, 2023

DRAWING TITLE


PRELIMINARY SITE PLAN

2017-009 PEA JOB NO. JBT KMB DES. DSK DRAWING NUMBER:

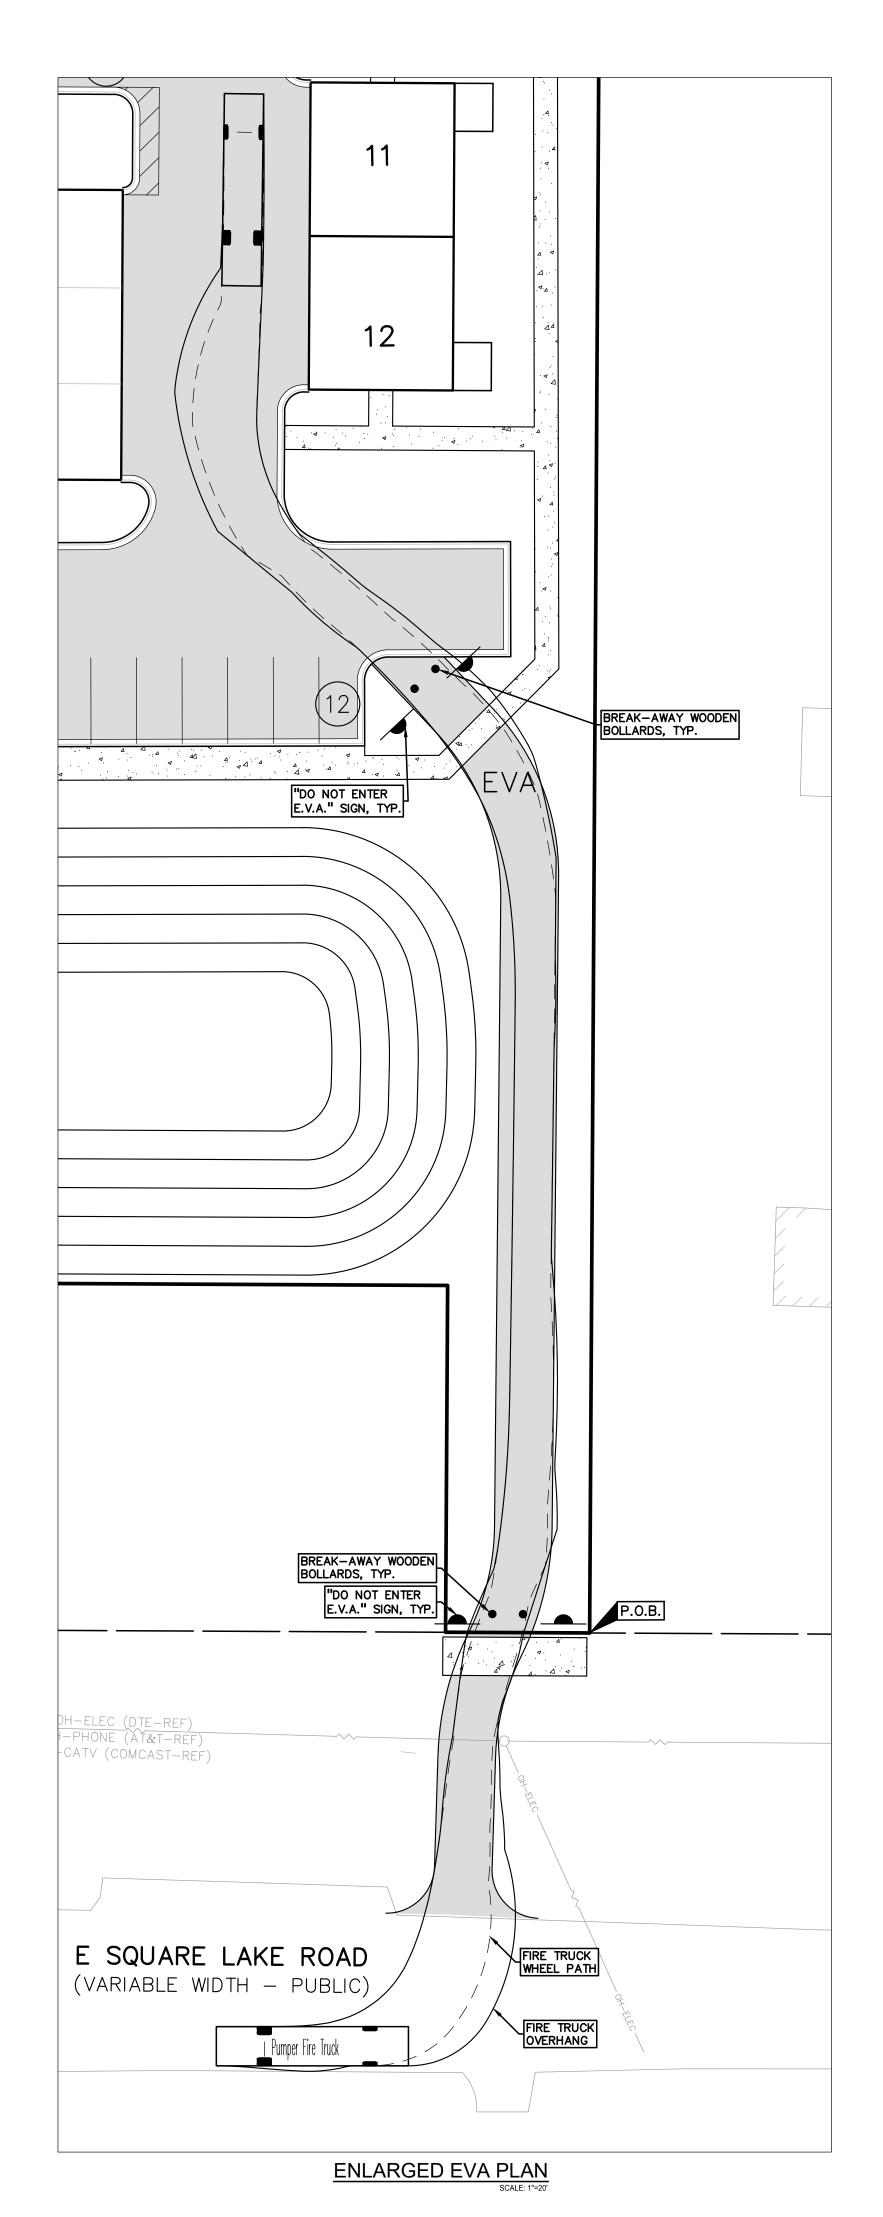



EXAMPLE EVA PHOTO

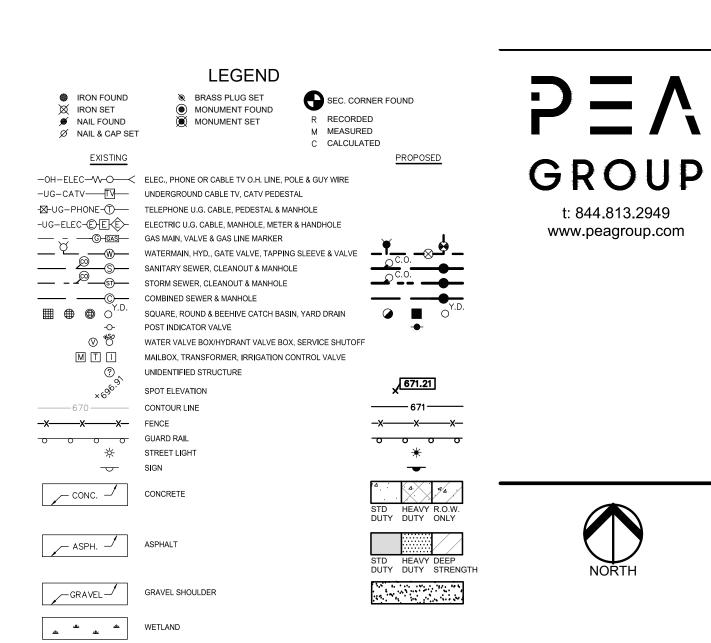




t: 844.813.2949



CAUTION!!
THE LOCATIONS AND ELEVATIONS OF EXISTING UNDERGROUND UTILITIES AS SHOWN ON THIS DRAWING ARE ONLY APPROXIMATE. NO GUARANTEE IS EITHER EXPRESSED OR IMPLIED AS TO THE COMPLETENESS OR ACCURACY THEREOF. THE CONTRACTOR SHALL BE EXCLUSIVELY RESPONSIBLE FOR DETERMINING THE EXACT UTILITY LOCATIONS AND ELEVATIONS PRIOR TO THE START OF CONSTRUCTION.

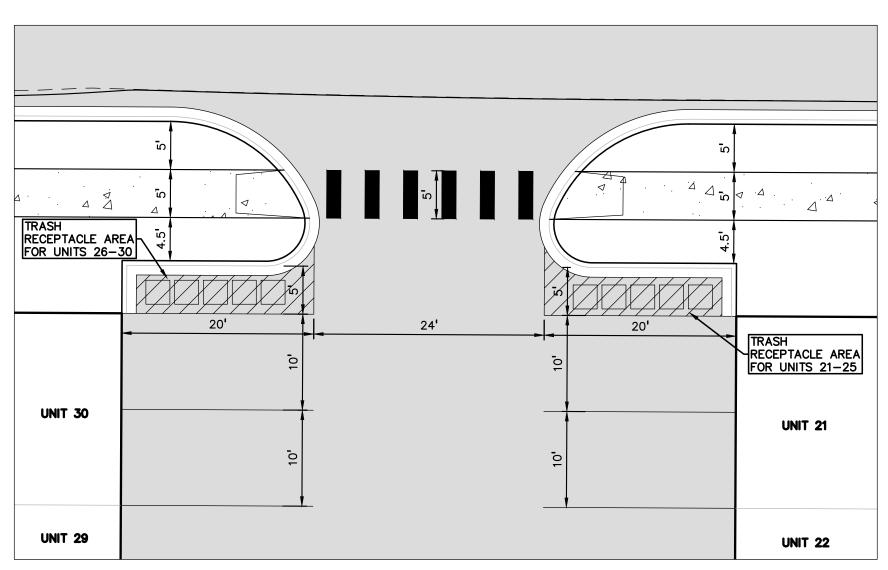

ENLARGED TRASH RECEPTACLE AREA PLAN
SCALE: 1"=10"

CLIENT GFA
DEVELOPMENT,
INC.
3301 MIRAGE DRIVE
TROY, MI 48083


PROJECT TITLE THE VILLAGE OF HASTINGS PART OF THE SW 1/4 OF SECTION 3, T. 02N., R. 11E., TROY, MI


REVISIONS	
REV. PER COMMENTS 6/2/2023	8/9/20
REV. PER COMMENTS 8/24/2023	11/17/20
REV. PER PC COMMENTS 11/28/2023	12/7/20
REV. PER PC COMMENTS 1/9/2024	1/24/20
REV. PER PC COMMENTS 4/9/2024	4/22/20
REV. PER REVIEW 3/15/2024	4/23/20
REV. PER PLANNING 5/6/2024	5/13/20

ORIGINAL ISSUE DATE: JUNE 1, 2023

ADDITIONAL SITE DETAILS

PEA JOB NO.	2017-009
P.M.	JB1
DN.	KME
DES.	DSk
DRAWING NUMBER:	

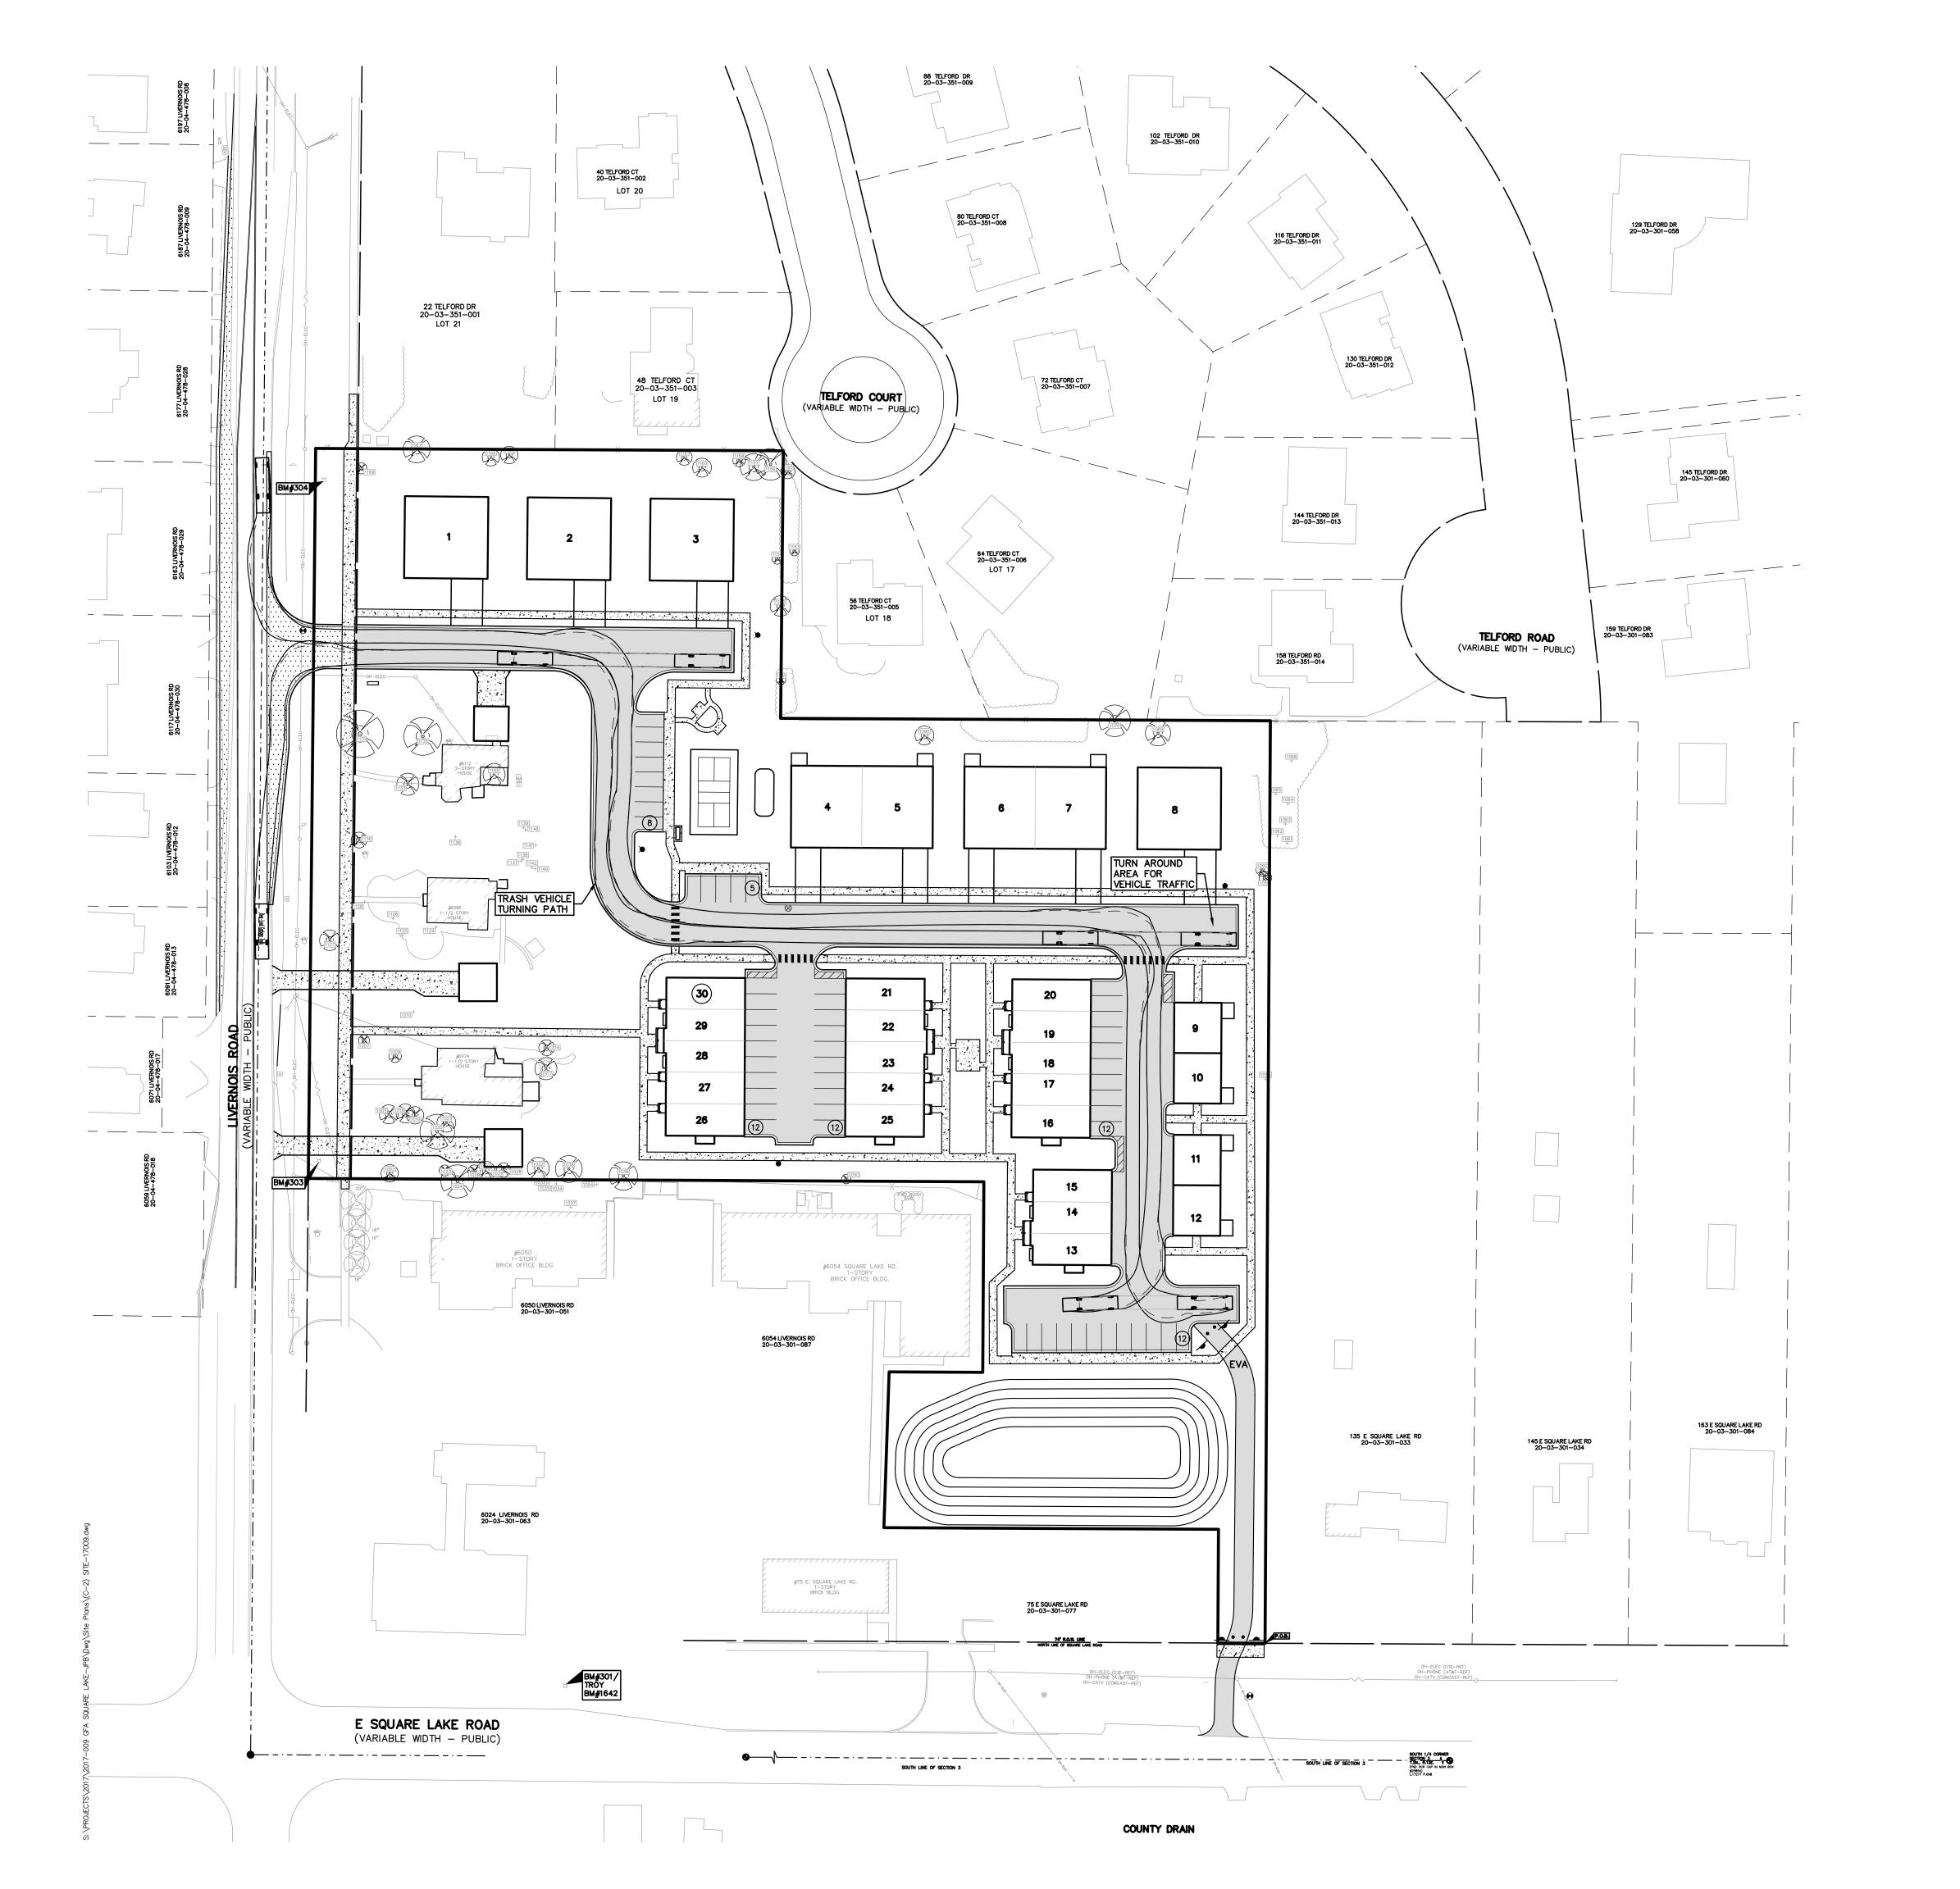

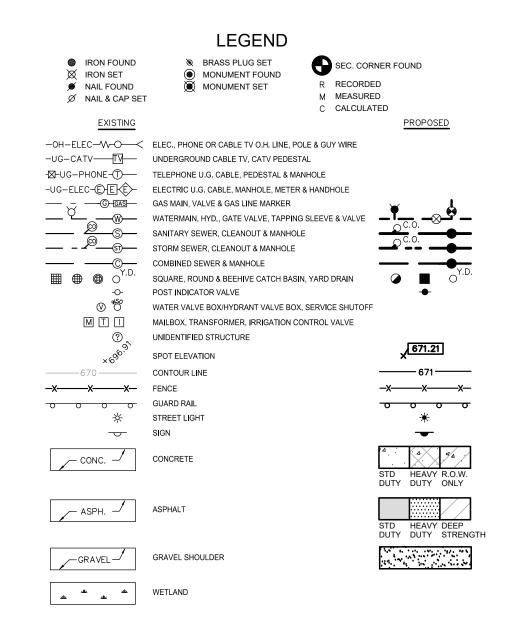



Rear—Load Garbage Truck Overall Length Overall Width Overall Body Height Min Body Ground Clearance Track Width Lock—to—lock time Curb to Curb Turning Radius

REAR-LOAD GARBAGE TRUCK

THE VILLAGE OF HASTINGS PART OF THE SW 1/4 OF SECTION 3, T. 02N., R. 11E., TROY, MI

GROUP

t: 844.813.2949

www.peagroup.com

SCALE: 1" = 50'


THE LOCATIONS AND ELEVATIONS OF EXISTING UNDERGROUND UTILITIES AS SHOWN ON THIS DRAWING ARE ONLY APPROXIMATE. NO GUARANTEE IS EITHER EXPRESSED OR IMPLIED AS TO THE COMPLETENESS OR ACCURACY THEREOF. THE CONTRACTOR SHALL BE EXCLUSIVELY RESPONSIBLE FOR DETERMINING THE EXACT UTILITY LOCATIONS AND ELEVATIONS PRIOR TO THE START OF CONSTRUCTION.

REVISIONS	
REV. PER COMMENTS 6/2/2023	8/9/2023
REV. PER COMMENTS 8/24/2023	11/17/2023
REV. PER PC COMMENTS 11/28/2023	12/7/2023
REV. PER PC COMMENTS 1/9/2024	1/24/2024
REV. PER PC COMMENTS 4/9/2024	4/22/2024
REV. PER REVIEW 3/15/2024	4/23/2024
REV. PER PLANNING 5/6/2024	5/13/2024

ORIGINAL ISSUE DATE:
JUNE 1. 2023

TRASH VEHICLE
CIRCULATION
PLAN

PEA JOB NO.	2017-009
P.M.	JBT
DN.	KME
DES.	DSk
DRAWING NUMBER:	

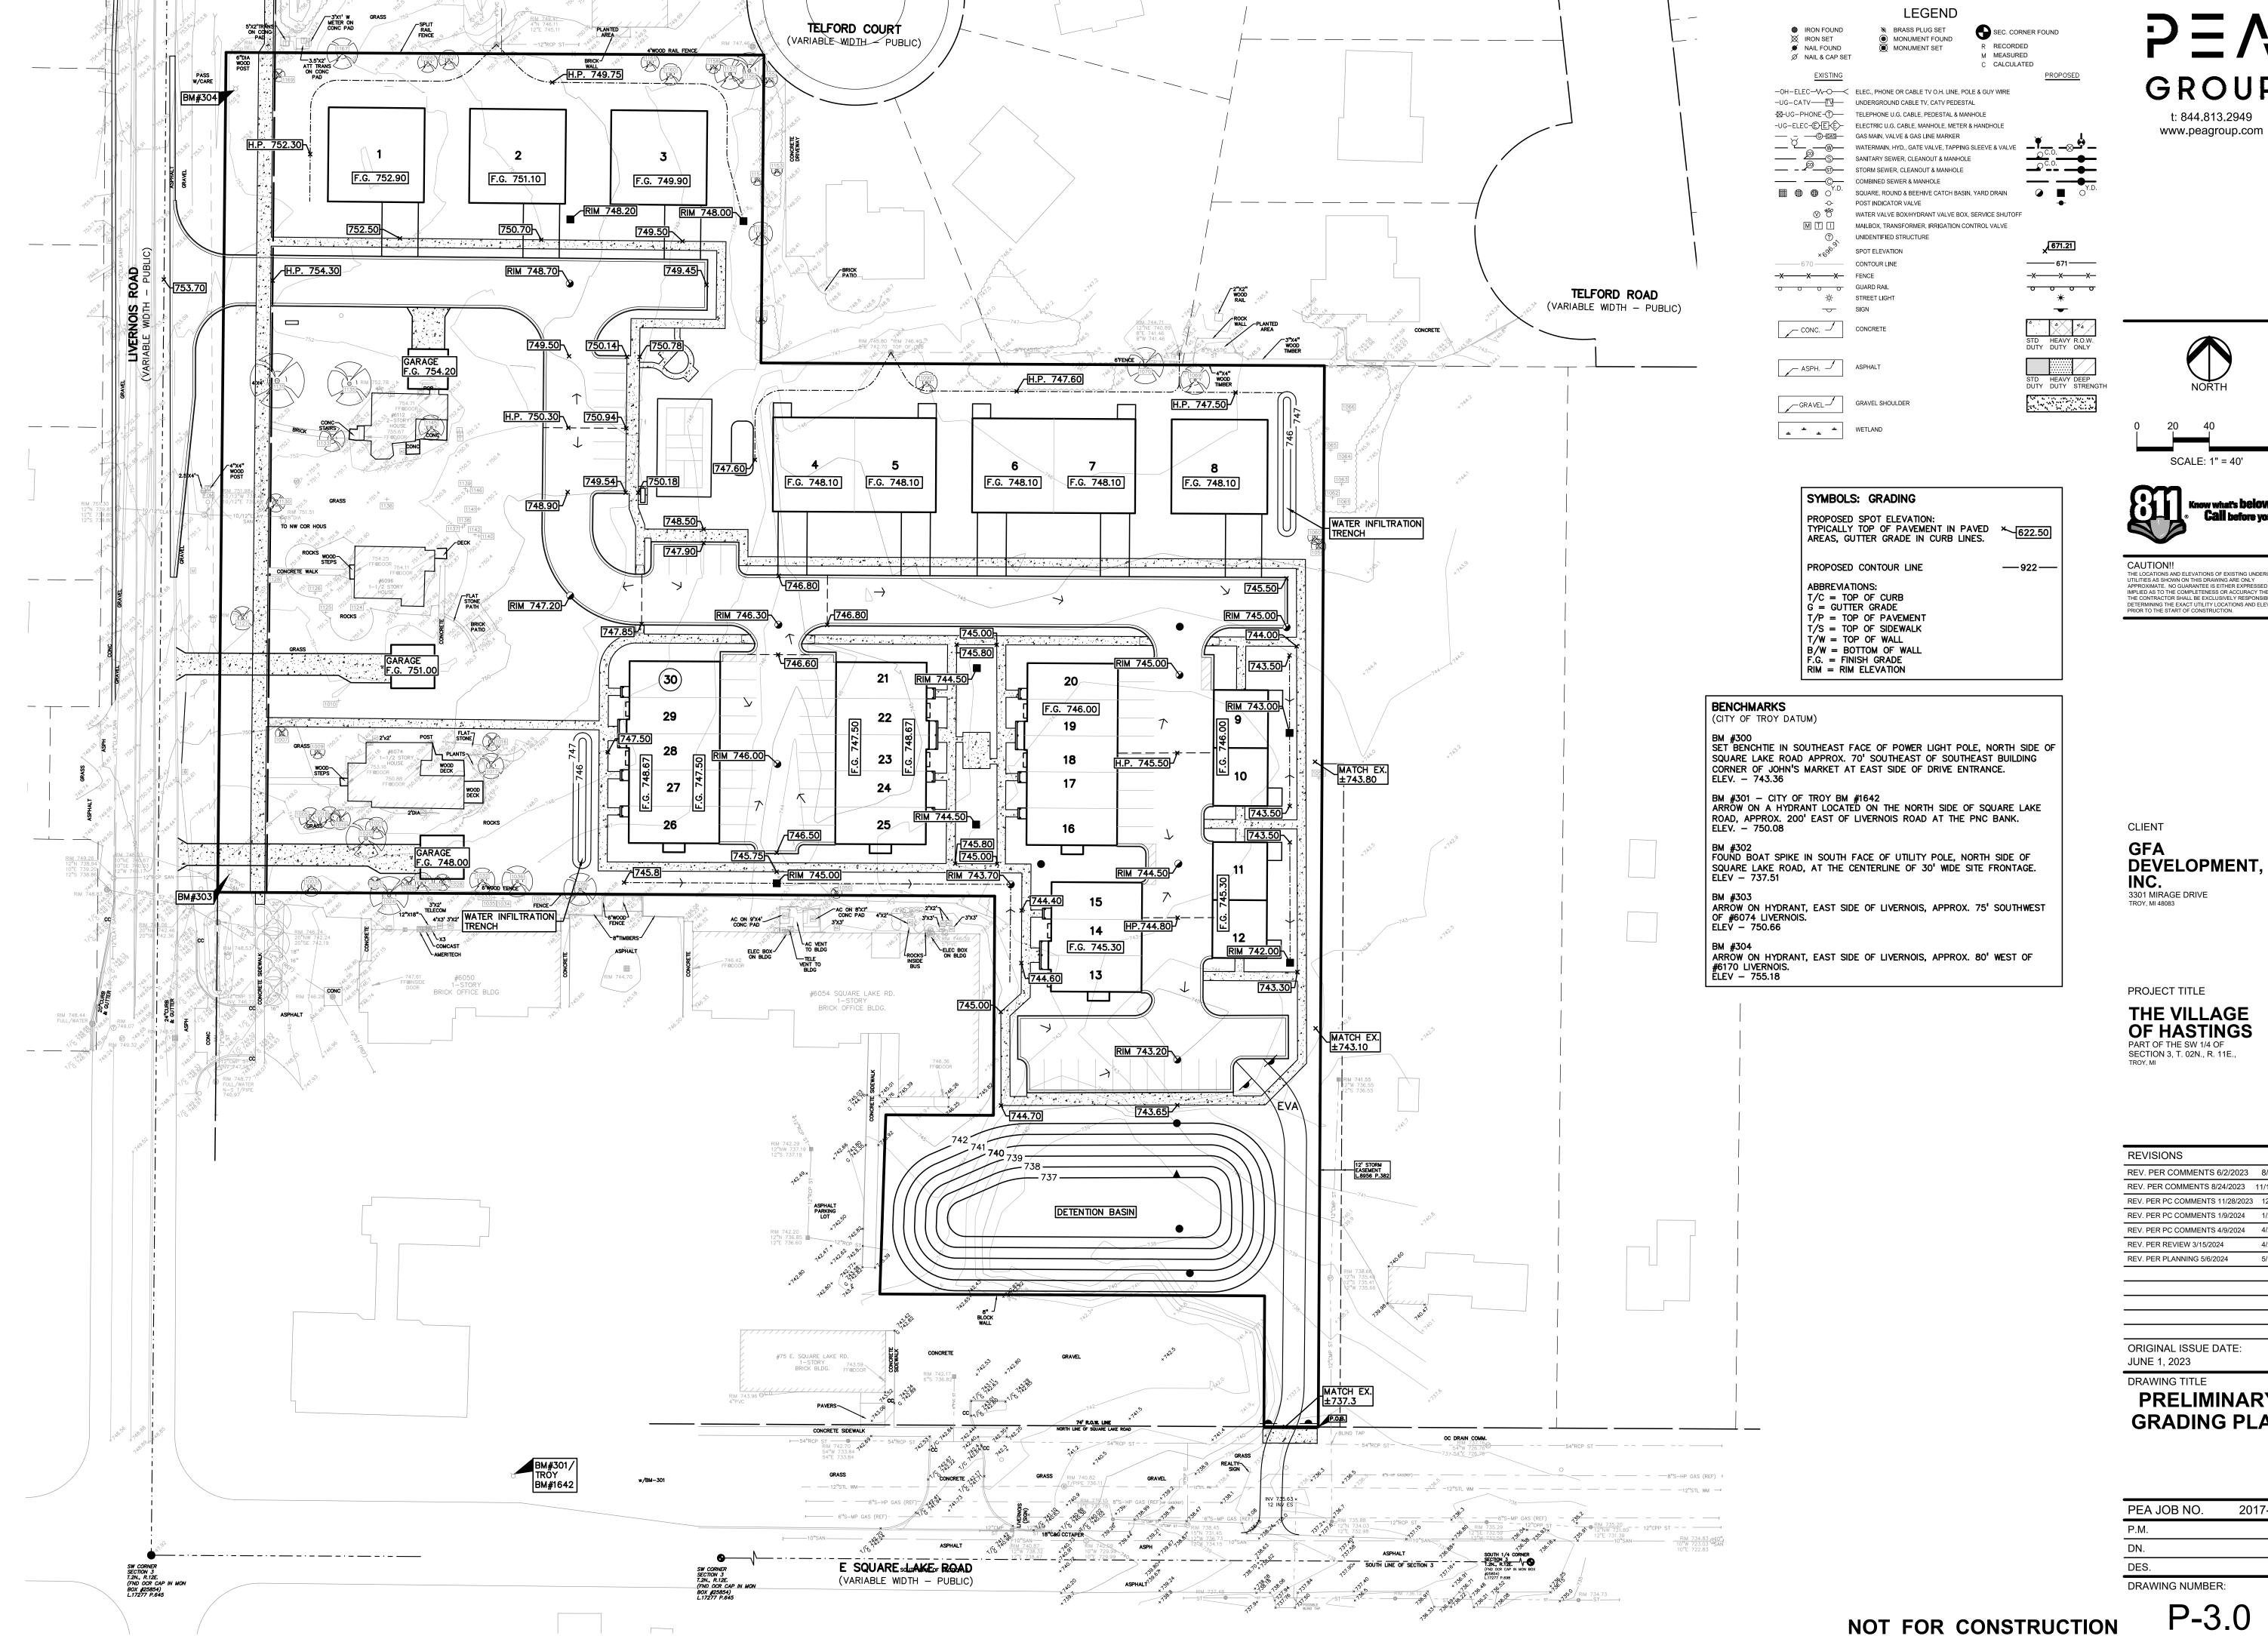

GROUP t: 844.813.2949







THE LOCATIONS AND ELEVATIONS OF EXISTING UNDERGROUND UTILITIES AS SHOWN ON THIS DRAWING ARE ONLY APPROXIMATE. NO GUARANTEE IS EITHER EXPRESSED OR IMPLIED AS TO THE COMPLETENESS OR ACCURACY THEREOF. THE CONTRACTOR SHALL BE EXCLUSIVELY RESPONSIBLE FOR DETERMINING THE EXACT UTILITY LOCATIONS AND ELEVATIONS PRIOR TO THE START OF CONSTRUCTION.

GFA
DEVELOPMENT,
INC.
3301 MIRAGE DRIVE
TROY, MI 48083

THE VILLAGE OF HASTINGS PART OF THE SW 1/4 OF SECTION 3, T. 02N., R. 11E., TROY, MI


REVISIO	NS	
REV. PER	COMMENTS 6/2/2023	8/9/2023
REV. PER C	OMMENTS 8/24/2023	11/17/2023
REV. PER PO	C COMMENTS 11/28/2023	12/7/2023
REV. PER PO	C COMMENTS 1/9/2024	1/24/2024
REV. PER PO	C COMMENTS 4/9/2024	4/22/2024
REV. PER RI	EVIEW 3/15/2024	4/23/2024
REV. PER PI	_ANNING 5/6/2024	5/13/2024


ORIGINAL ISSUE DATE:

PRELIMINARY

GRADING PLAN


PEA JOB NO.	2017-009
P.M.	JBT
DN.	KMB
DES.	DSK
DRAWING NUMBER	i

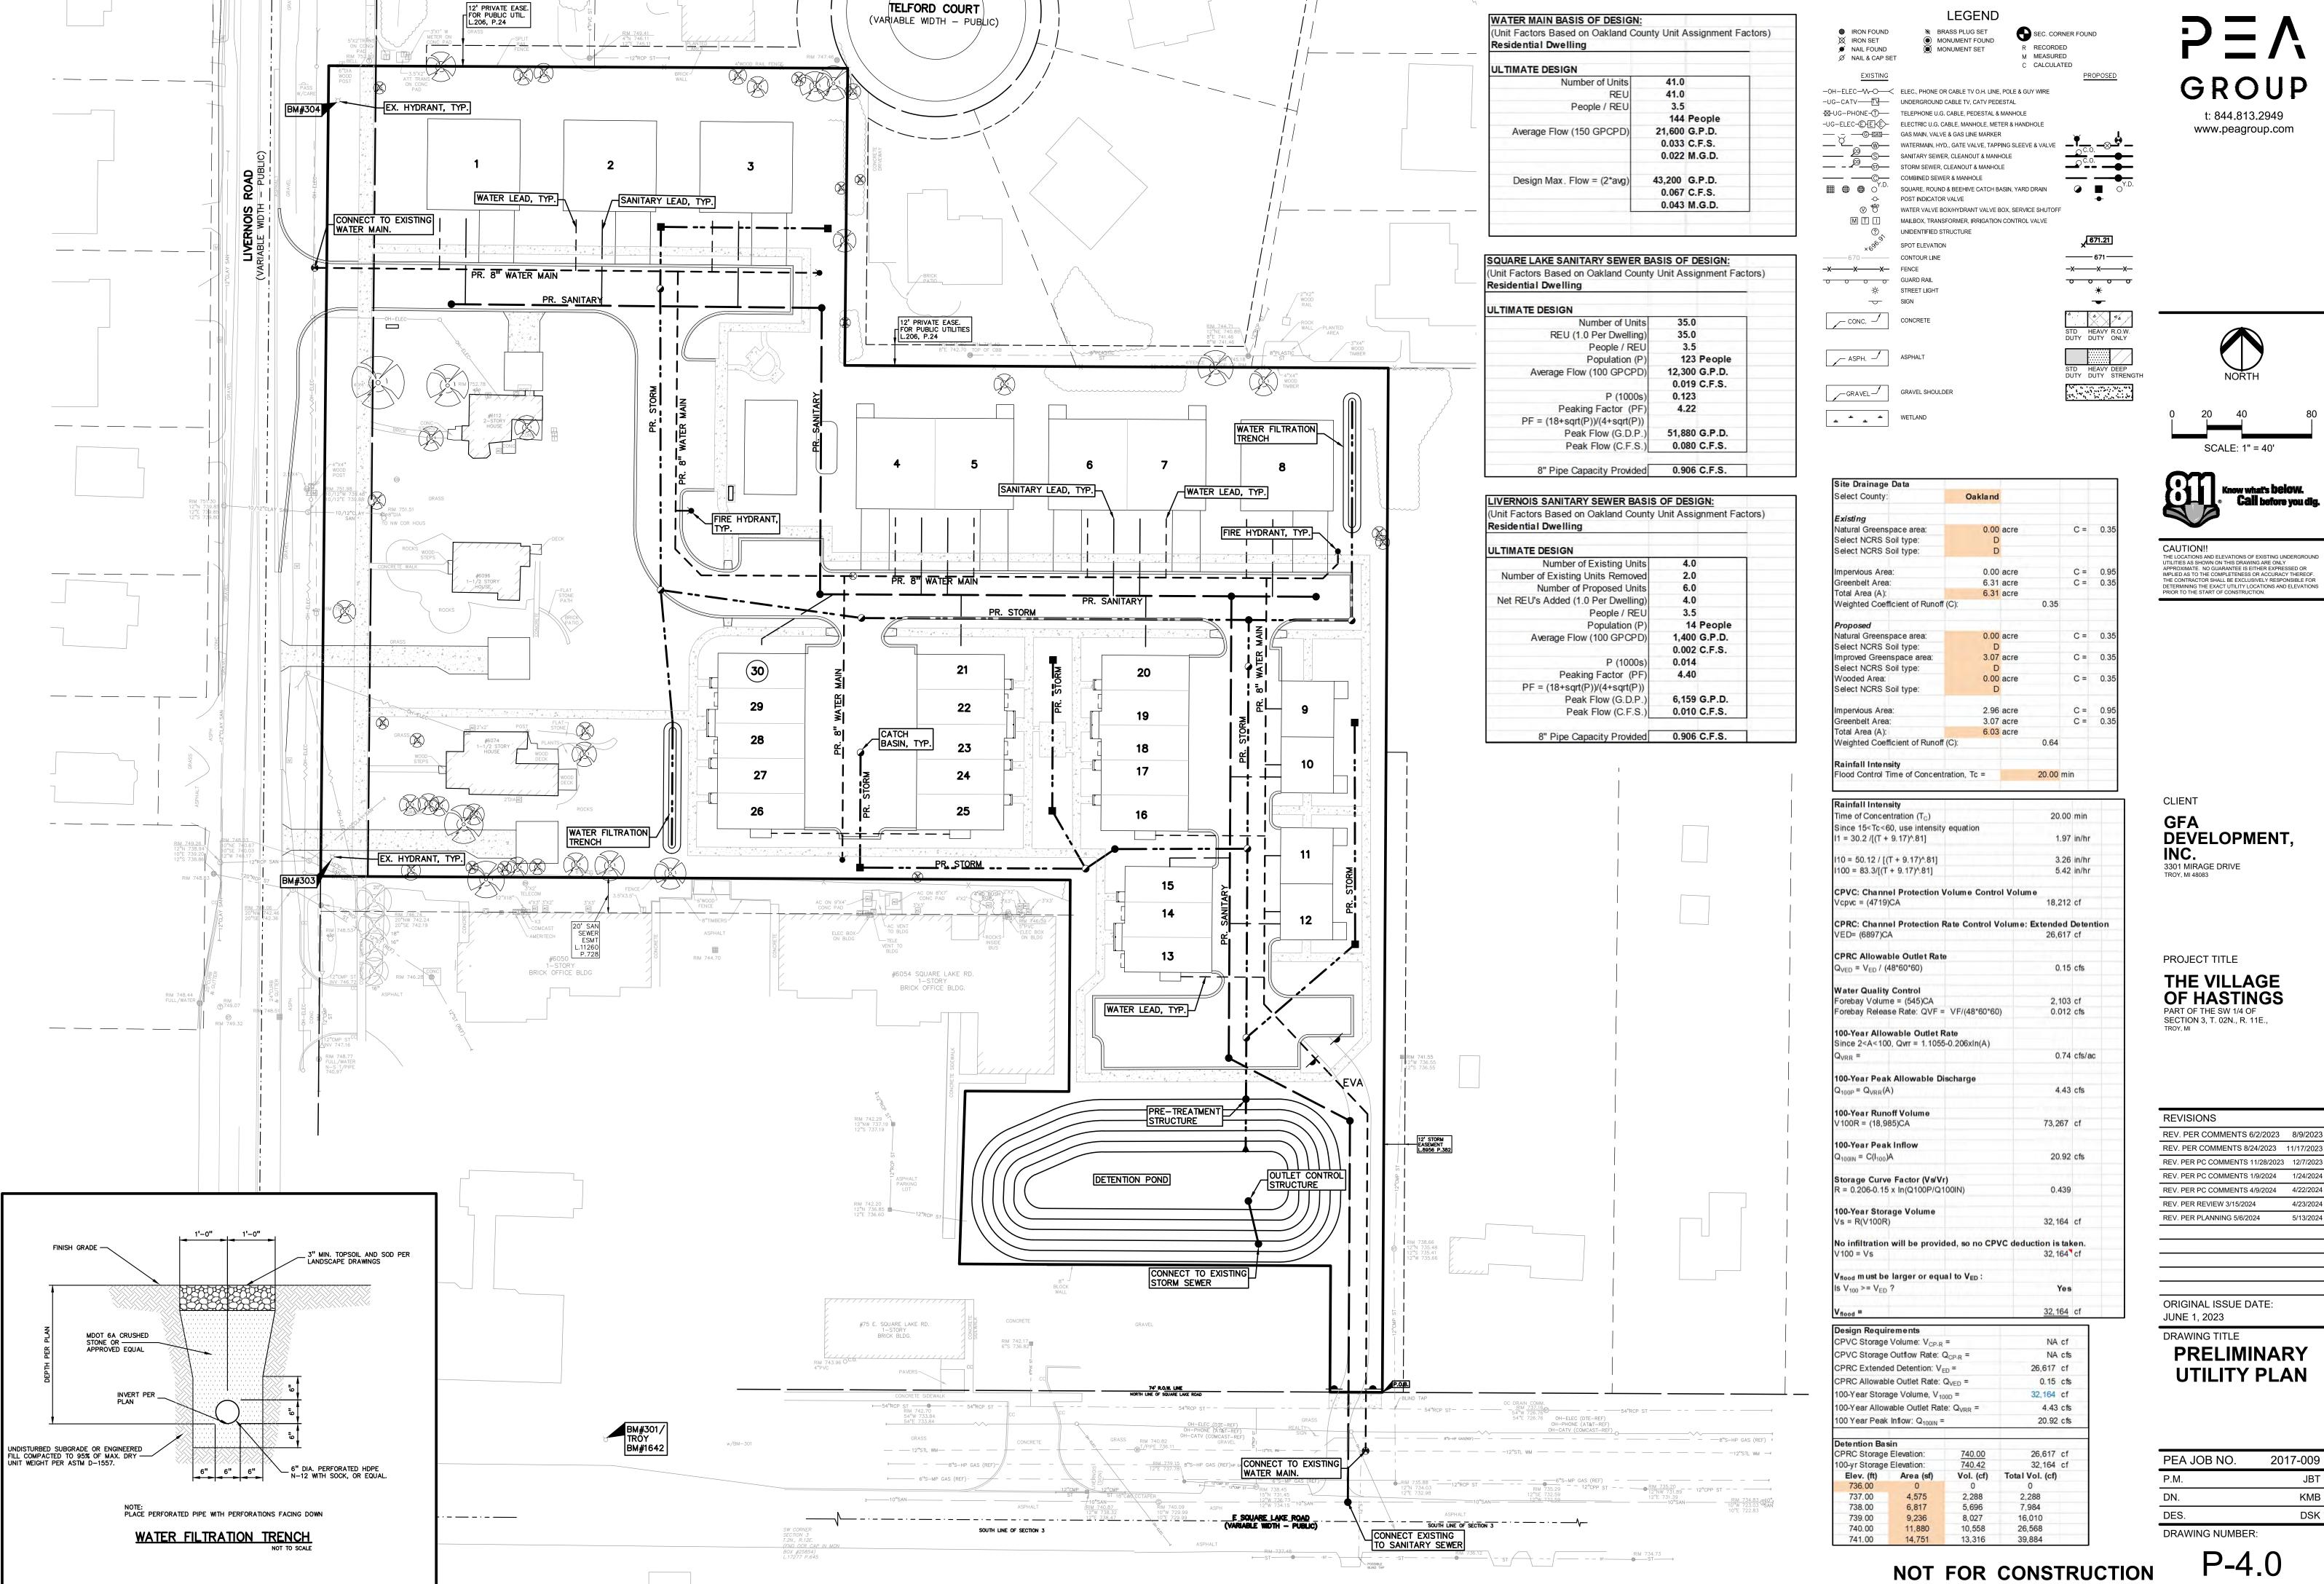


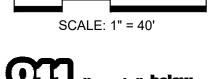


EVISIONS	
EV. PER COMMENTS 6/2/2023	8/9/2023
EV. PER COMMENTS 8/24/2023	11/17/2023
EV. PER PC COMMENTS 11/28/2023	12/7/2023
EV. PER PC COMMENTS 1/9/2024	1/24/2024
EV. PER PC COMMENTS 4/9/2024	4/22/2024
EV. PER REVIEW 3/15/2024	4/23/2024
EV. PER PLANNING 5/6/2024	5/13/2024


2017-009 JBT KMB

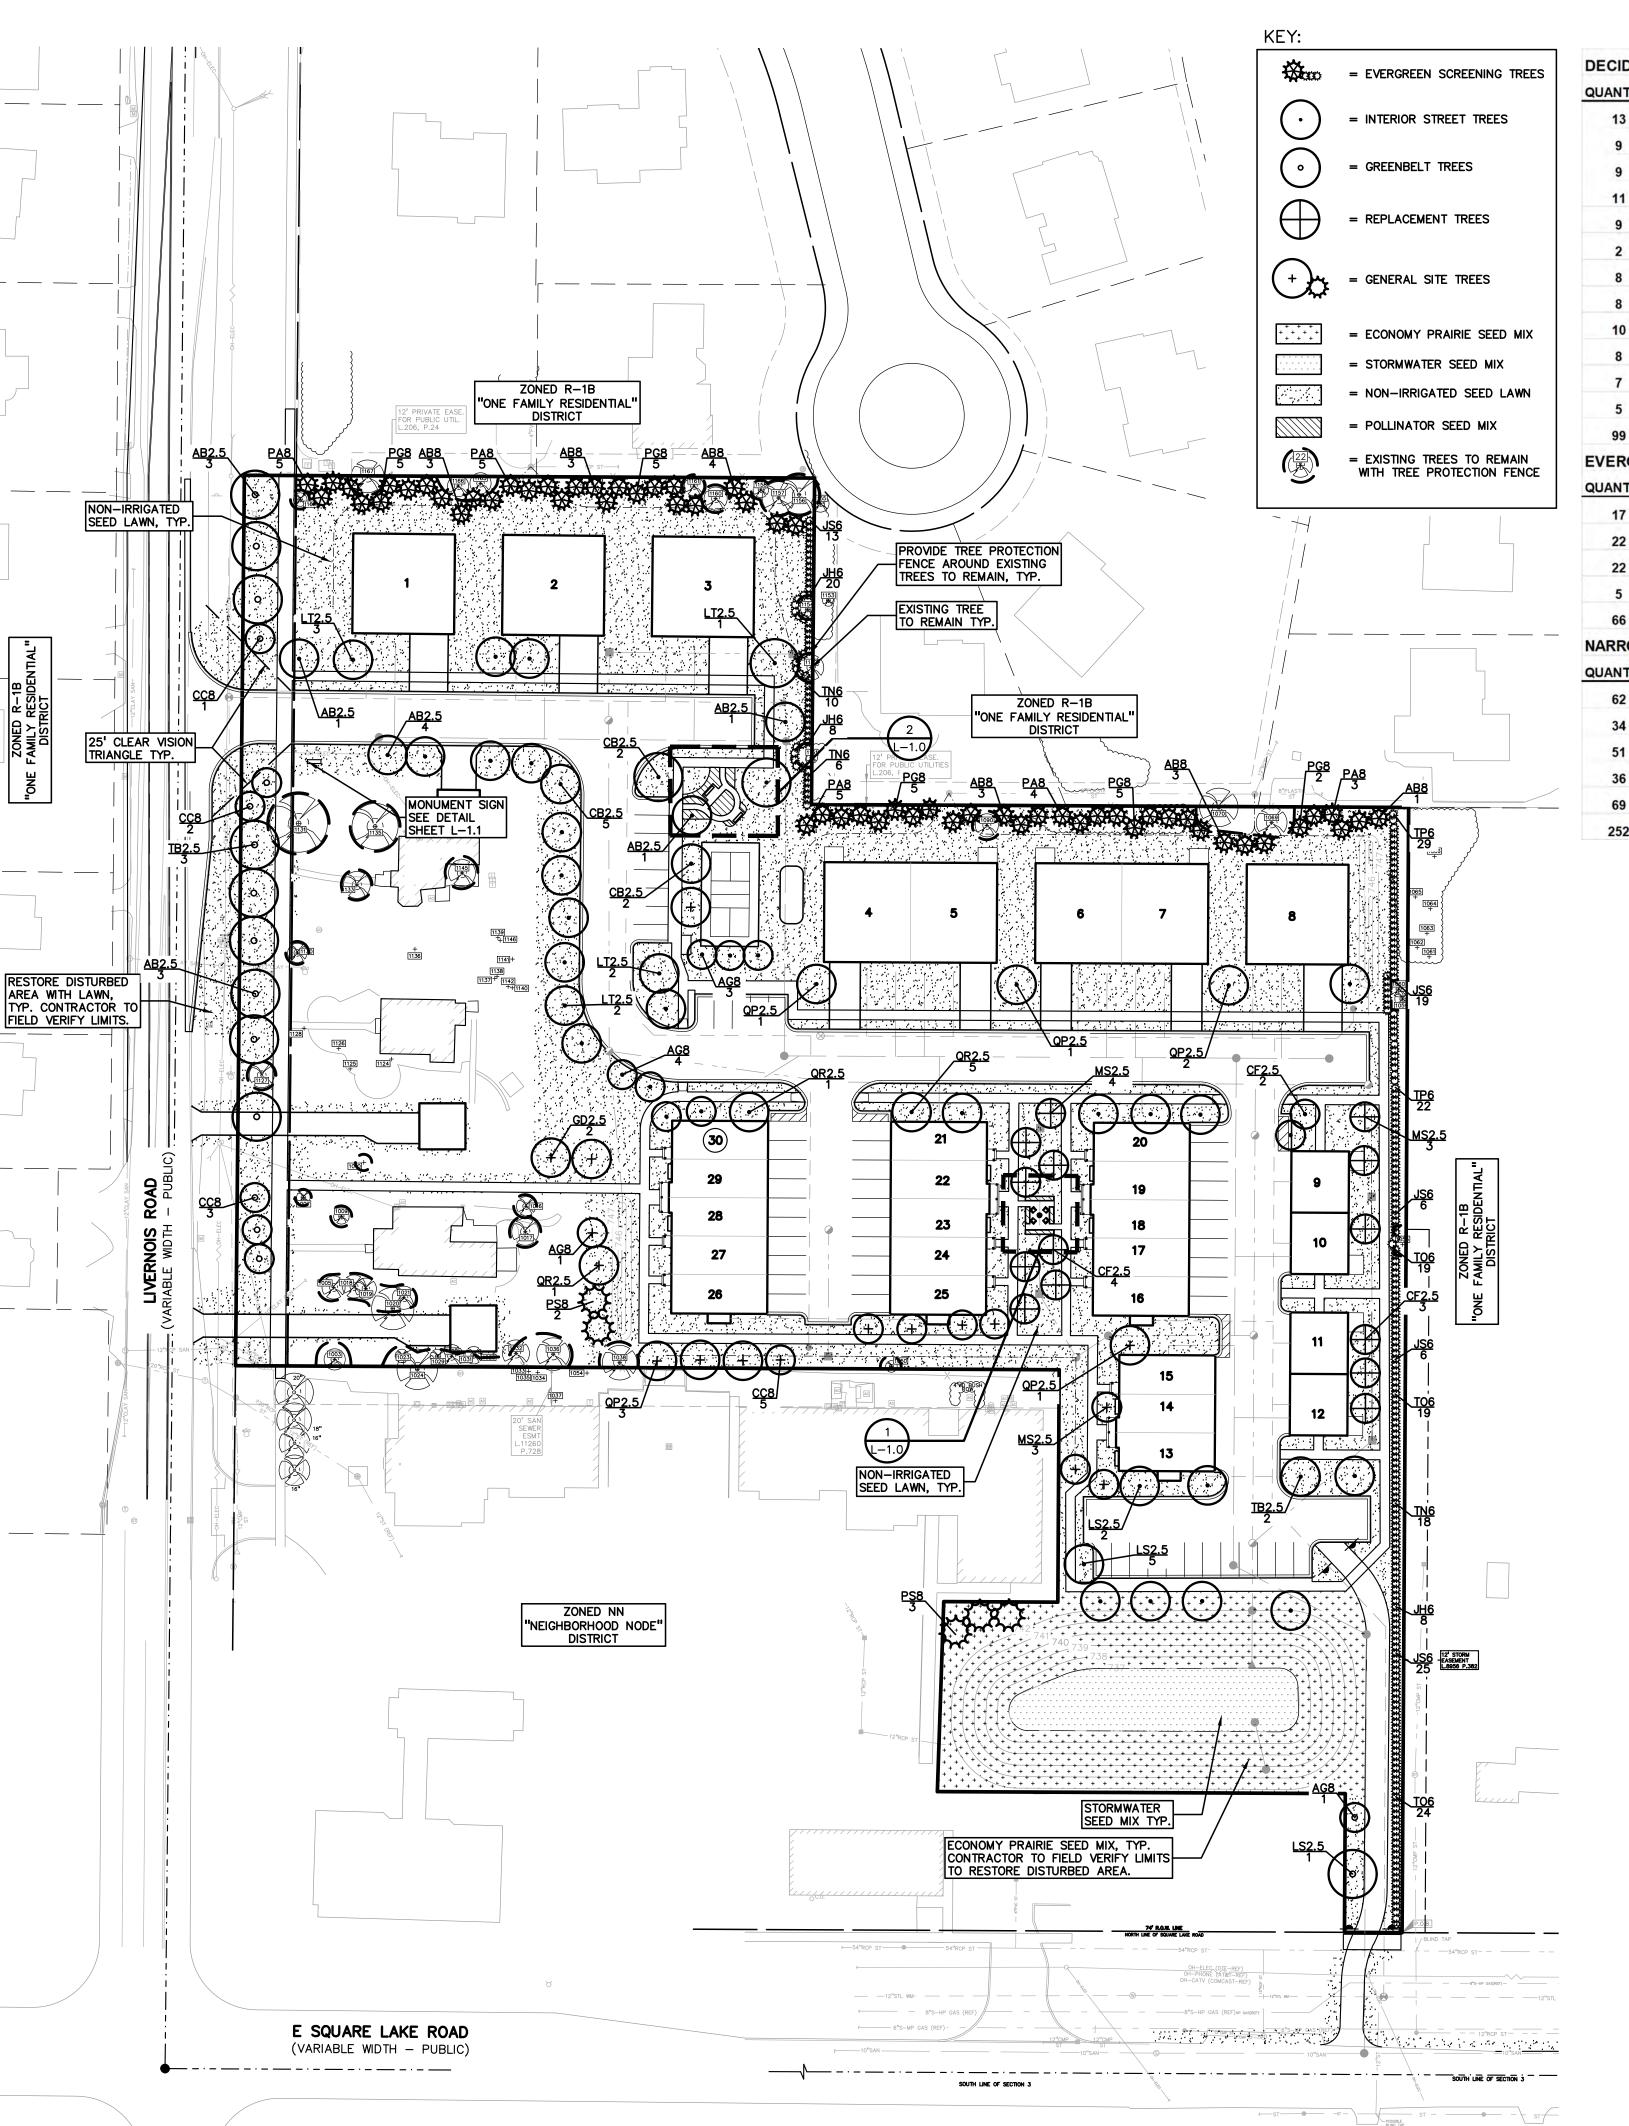

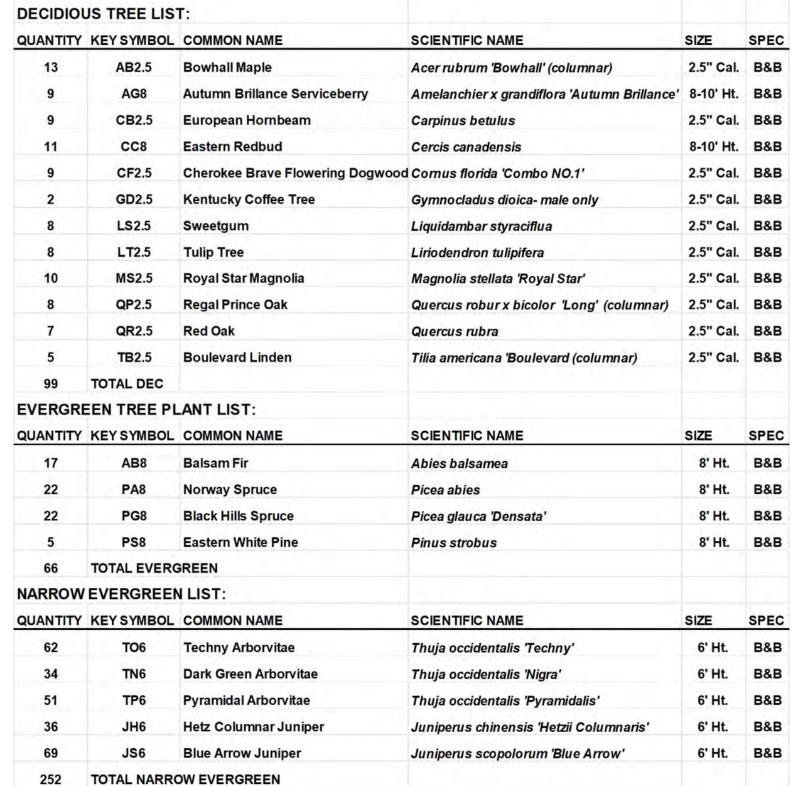

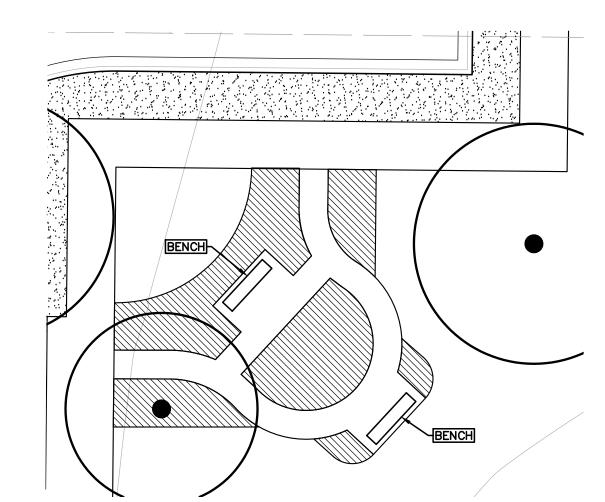

BUTTERFLY GARDEN SCALE: 1'' = 10'-0''

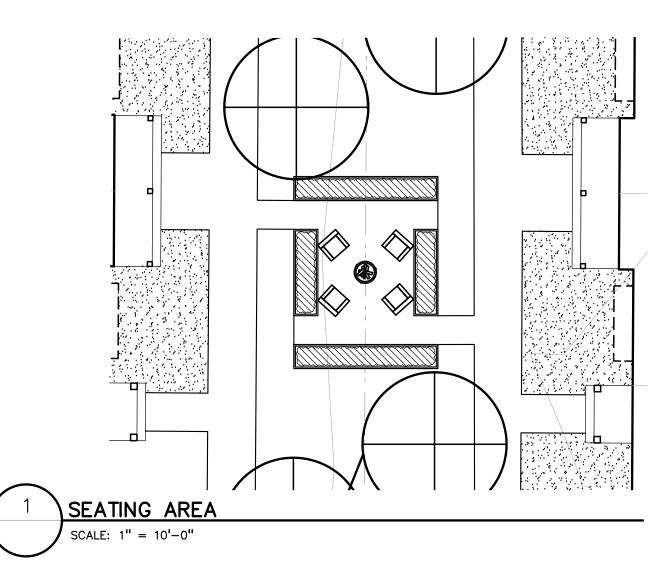

PER CITY OF TROY ZONING ORDINANCE - FORM BASE DISTRICT (NN) NEIGHBORHOOD NODE Q; SITE TYPE NN:B; BUILDING FORM C

<u>5.03 C—1a. = GENERAL SITE LANDSCAPE:</u> REQUIRED: 15% OF SITE AREA SHALL BE LANDSCAPE MATERIAL 274,863.6 SF * 15% = 41,229.5 SQ FT REQUIRED

PROVIDED: 71,465 SQ FT LANDSCAPE (26%)

13.02 B. = SCREENING BETWEEN USES:
REQUIRED: ABUTS R-1B USE SPACE TO THE NORTH AND EAST REQUIRES SCREEN ALT. 1 (1 NARROW EVG. / 3') OR ALT. 2 (1 LARGE EVG. TREE / 10 LF)

NORTH PROPERTY LINE -WESTERN SEGMENT 297 LF AND EASTERN SEGMENT 305 LF. ALT. 2; 297 LF / 10 = 30 AND 305 LF / 10 = 31 LARGE EVG.PROVIDED: WESTERN SEGMENT: 30 8' HT LARGE EVG. TREES EASTERN SEGMENT: 31 8' HT LARGE EVG. TREES

EAST PROPERTY LINE -NORTHERN SEGMENT 170 LF AND SOUTHERN SEGMENT 586 LF. ALT 1; 170 LF / 3 = 57 AND 586 LF / 3 = 195 NARROW EVG. PROVIDED: NORTHERN SEGMENT: 57, 6' HT. NARROW EVG. / 3' OC. SOUTHERN SEGMENT: 195, 6' HT. NARROW EVG. / 3' OC.

13.02 F. INTERIOR STREET TREES: REQUIRED: 1 TREE PER 50 LF OF INTERIOR STREETS 1281 LF / 50 = 26 TREES REQUIRED (EACH SIDE) PROVIDED: 52 PROPOSED TREES

<u>13.02 D2. GREENBELT;</u> REQUIRED: 1 TREE / 30 LF OF FRONTAGE TO PUBLIC RD. LIVERNOIS ROAD - 463 LF FRONTAGE / 30 = 15 TREES E. SQUARE LAKE ROAD -42 LF FRONTAGE /30 = 2 TREES

PROVIDED: LIVERNOIS ROAD: 15 TREES E. SQUARE LAKE ROAD: 2 TREES

REPLACEMENT TREES: SEE SHT. T-1.0 AND T-1.1 FOR EXISTING TREE LIST AND TREE RESERVATION PLAN.

REQUIRED: 35" DBH TO REPLACE REMOVED REGULATED TREES PROVIDED: 14 TREES AT 2.5" (14 * 2.5 = 35") PROVIDED

GENERAL PLANTING NOTES:

- LANDSCAPE CONTRACTOR SHALL VISIT SITE, INSPECT EXISTING SITE CONDITIONS AND REVIEW PROPOSED PLANTING AND RELATED WORK. IN CASE OF DISCREPANCY BETWEEN PLAN AND PLANT LIST, PLAN SHALL GOVERN QUANTITIES. CONTACT LANDSCAPE ARCHITECT WITH ANY CONCERNS.
- CONTRACTOR SHALL VERIFY LOCATIONS OF ALL ON SITE UTILITIES PRIOR TO BEGINNING CONSTRUCTION ON HIS/HER PHASE OF WORK. ELECTRIC, GAS, TELEPHONE, CABLE TELEVISION MAY BE LOCATED BY CALLING MISS DIG 1-800-482-7171. ANY DAMAGE OR INTERRUPTION OF SERVICES SHALL BE THE RESPONSIBILITY OF CONTRACTOR. CONTRACTOR SHALL COORDINATE ALL RELATED ACTIVITIES WITH OTHER TRADES ON THE JOB AND SHALL REPORT ANY UNACCEPTABLE JOB CONDITIONS TO OWNER'S REPRESENTATIVE PRIOR TO COMMENCING.
- ALL PLANT MATERIAL TO BE PREMIUM GRADE NURSERY STOCK AND SHALL SATISFY AMERICAN ASSOCIATION OF NURSERYMEN STANDARD FOR NURSERY STOCK. ALL LANDSCAPE MATERIAL SHALL BE NORTHERN GROWN, NO. 1. GRADE.
- CONTRACTOR IS RESPONSIBLE FOR VERIFYING ALL QUANTITIES SHOWN ON LANDSCAPE PLAN PRIOR TO PRICING THE WORK.
- OWNER'S REPRESENTATIVE RESERVES THE RIGHT TO REJECT ANY PLANT MATERIAL NOT MEETING SPECIFICATIONS.
- 6. ALL SINGLE STEM SHADE TREES TO HAVE STRAIGHT TRUNKS AND SYMMETRICAL CROWNS.
- ALL SINGLE TRUNK SHADE TREES TO HAVE A CENTRAL LEADER; TREES WITH FORKED OR IRREGULAR TRUNKS WILL NOT BE
- 8. ALL MULTI STEM TREES SHALL BE HEAVILY BRANCHED AND HAVE SYMMETRICAL CROWNS. ONE SIDED TREES OR THOSE WITH THIN OR OPEN CROWNS SHALL NOT BE ACCEPTED.
- ALL EVERGREEN TREES SHALL BE HEAVILY BRANCHED AND FULL TO THE GROUND, SYMMETRICAL IN SHAPE AND NOT SHEARED
- FOR THE LAST FIVE GROWING SEASONS. 10. ALL TREES TO HAVE CLAY OR CLAY LOAM BALLS, TREES WITH
- SAND BALLS WILL BE REJECTED. 1. NO MACHINERY IS TO BE USED WITHIN THE DRIP LINE OF EXISTING TREES; HAND GRADE ALL LAWN AREAS WITHIN THE DRIP LINE OF EXISTING TREES.
- 12. ALL TREE LOCATIONS SHALL BE STAKED BY LANDSCAPE CONTRACTOR AND ARE SUBJECT TO THE APPROVAL OF THE LANDSCAPE ARCHITECT PRIOR TO INSTALLATION OF THE PLANT
- 13. IT IS MANDATORY THAT POSITIVE DRAINAGE IS PROVIDED AWAY FROM ALL BUILDINGS.
- 14. ALL PLANTING BEDS SHALL RECEIVE 3" SHREDDED HARDWOOD BARK MULCH WITH PRE EMERGENT, SEE SPECIFICATIONS. SHREDDED PALETTE AND DYED MULCH WILL NOT BE ACCEPTED.
- 15. ALL LANDSCAPED AREAS SHALL RECEIVE 3" COMPACTED TOPSOIL.
- 16. SEE SPECIFICATIONS FOR ADDITIONAL COMMENTS, REQUIREMENTS, PLANTING PROCEDURES AND WARRANTY STANDARDS.
- 7. FOR NON-LAWN SEED MIX AREAS, AS NOTED ON PLAN, BRUSH MOW ONCE SEASONALLY FOR INVASIVE SPECIES CONTROL.
- 18. CONTRACTOR SHALL NOT INSTALL PLANTS UNDER BUILDING OVERHANG AND SHALL NOTIFY LANDSCAPE ARCHITECT IF DRAWINGS CONFLICT WITH BUILDING OVERHANGS.
- 19. TREES SHALL NOT CONFLICT/ BLOCK PROPOSED REGULATORY/ DIRECTION SIGNAGE, MONUMENT SIGNS, ADDRESS OR LIGHT POLES. SHIFT TREES AS NECESSARY TYP.

www.peagroup.com







SCALE: 1" = 50'



CAUTION!! THE LOCATIONS AND ELEVATIONS OF EXISTING UNDERGROUND UTILITIES AS SHOWN ON THIS DRAWING ARE ONLY APPROXIMATE. NO GUARANTEE IS EITHER EXPRESSED OR IMPLIED AS TO THE COMPLETENESS OR ACCURACY THEREOF. THE CONTRACTOR SHALL BE EXCLUSIVELY RESPONSIBLE FOR DETERMINING THE EXACT UTILITY LOCATIONS AND ELEVATIONS PRIOR TO THE START OF CONSTRUCTION.

DEVELOPMENT, INC.

PROJECT TITLE

3301 MIRAGE DRIVE TROY, MI 48083

THE VILLAGE **OF HASTINGS** SECTION 3, T. 02N., R. 11E.,

	REVISIONS	
	REV. PER COMMENTS 6/2/2023	8/9/202
	REV. PER COMMENTS 8/24/2023	11/17/202
	REV. PER PC COMMENTS 11/28/2023	12/7/202
	REV. PER PC COMMENTS 1/9/2024	1/24/202
	REV. PER PC COMMENTS 4/9/2024	4/22/202
	REV. PER REVIEW 3/15/2024	4/23/202
·	REV. PER PLANNING 5/6/2024	5/13/202
	•	

ORIGINAL ISSUE DATE: JUNE 1, 2023

DRAWING TITLE

PRELIMINARY LANDSCAPE PLAN

PEA JOB NO.	2017-009
P.M.	JBT
DN.	LAW
DES.	LAW
DRAWING NUMBER:	

Side Oats Grama

Prairie Sedge Mix

Canada Wild Rye

Switch Grass

Little Bluestem

Indian Grass

Common Oat

Common Milkweed

Butterfly Weed

Partridge Pea

Sand Coreopsis

False Sunflower

Wild Bergamot

Yellow Coneflower

Black-Eyed Susan

Showy Goldenrod

Smooth Blue Aster

New England Aster

Foxglove Beard Tongue

Common Mountain Mint

Wild Lupine

Broad-leaved Purple Coneflower

Annual Rye

Economy Prairie Seed Mix Stantec Native Plant Nursery 574-586-2412 stantec.com/native-plant-nursery

Botanical Name <u>Common Name</u> Permanent Grasses/Sedges/Rushes: Big Bluestem

Andropogon gerardii Bouteloua curtipendula Carex spp. Elymus canadensis Panicum virgatum Schizachyrium scoparium Sorghastrum nutans

Temporary Cover: Avena sativa Lolium multiflorum

Forbs & Shrubs: Asclepias syriaca Asclepias tuberosa Chamaecrista fasciculata Coreopsis lanceolata

Echinacea purpurea Heliopsis helianthoides Lupinus perennis Monarda fistulosa Penstemon digitalis Pycnanthemum virginianum Ratibida pinnata Rudbeckia hirta Solidago speciosa Symphyotrichum laeve Symphyotrichum novae-angliae Stormwater Seed Mix Stantec Native Plant Nursery 574-586-2412 stantec.com/native-plant-nursery

<u>Botanical Name</u> Permanent Grasses/Sedges/Rushes: Bolboschoenus fluviatilis Carex cristatella Carex lurida Carex vulpinoidea Elymus virginicus Glyceria striata

Schoenoplectus tabernaemontani

Juncus effusus

Leersia oryzoides

Panicum virgatum

Scirpus atrovirens

Scirpus cyperinus

|Temporary Cover:

Lolium multiflorum

Avena sativa

Alisma spp.

Bidens spp.

Iris virginica

Crested Oval Sedge Bottlebrush Sedge Brown Fox Sedge Virginia Wild Rye Fowl Manna Grass Common Rush Rice Cut Grass Switch Grass Softstem Bulrush Dark Green Rush Wool Grass

Common Name

River Bulrush

Common Oat Annual Rye

Forbs & Shrubs: Water Plantain (Various Mix) Asclepias incarnata Swamp Milkweed Bidens (Various Mix) Helenium autumnale Sneezeweed Blue Flag Lycopus americanus Common Water Horehound Mimulus ringens Monkey Flower Oligoneuron riddellii Riddell's Goldenrod Penthorum sedoides Ditch Stonecrop Pinkweed (Various Mix) Polygonum spp. Sweet Black-Eyed Susan Rudbeckia subtomentosa Rudbeckia triloba Brown-Eyed Susan Sagittaria latifolia Common Arrowhead Senna hebecarpa Wild Senna Symphyotrichum novae-angliae New England Aster Thalictrum dasycarpum Purple Meadow Rue

Solar Pollinator Habitat Mix Stantec Native Plant Nursery 574-586-2412 stantec.com/native-plant-nursery <u>Botanical Name</u>

Common Name Permanent Grasses: Bouteloua curtipendula Side-Oats Grama

Carex bicknellii Copper-Shouldered Oval Sedge Koeleria macrantha June Grass Schizachyrium scoparium Little Bluestem Sporobolus heterolepis Prairie Dropseed

Temporary Cover: Avena sativa

Solidago nemoralis

Zizia aurea

PLAN FOR

QUANTITY

PLAN VIEW

SECTION VIEW

SCALE: 1'' = 2'-0''

PERENNIAL PLANTING DETAIL

Symphyotrichum ericoides

SPECIES SEE PLAN FOR

QUANTITY

Common Oat

Old-Field Goldenrod

Golden Alexanders

PLANT PERENNIALS EQUAL DISTANCE IN

UNLESS NOTED OR GRAPHICALLY SHOWN

3" SHREDDED BARK MULCH. DO NOT

PILE MULCH AGAINST PLANT STEMS

SHOVEL CUT EDGE OR ALUMINUM

EDGING AS INDICATED ON PLAN

- SPECIFIED PLANTING MIX

NOTE: REMOVE ALL CONTAINERS PRIOR

ALL SPACING IS TO BE TRIANGULAR

ALL DIRECTIONS

OTHERWISE


TO PLANTING

Heath Aster

Allium cernuum Nodding Onion Aquilegia canadensis Wild Columbine Asclepias syriaca Common Milkweed Chamaecrista fasciculata Partridge Pea Coreopsis lanceolata Sand Coreopsis Dalea purpurea Purple Prairie Clover Liatris aspera Rough Blazing Star Lupinus perennis v. occidentalis Wild Lupine Monarda punctata Horse Mint Penstemon hirsutus Hairy Beard Tongue

BRICK MASONRY VENEER MANUF: BELDEN BRICK COLOR: BELCREST 500 LIMESTONE: 3'-0" LONG LIMESTONE SUBMIT SAMPLE FOR CAP. END CAP TO TAPER APPROVAL 3 SIDES. SEAL JOINTS WITH EPOXY SEALANT. SUBMIT SHOP DRAWINGS FOR REVIEW FOR - RIGID COPPER FLASHING APPROVAL 2½" LIMESTONE RECESSED - 4" THICK BRICK VENEER SIGN PANEL WITH STUD MOUNTED DIMENSIONAL C.M.U. BLOCK WITH #4 LETTERING. REFER TO -REBAR AT 12" O.C. WITH SIGN CONTRACTOR FOR GROUT FILLED CELLS LETTERING SPECS. HORIZONTAL JOINT PANEL ANCHORS. ATTACH - REINFORCED LADDER. TO TOPS AND BOTTOM OF EVERY 2 COURSES LIMESTONE SIGN PANEL AND CMU BLOCK. SUBMIT - MORTAR FILLED BACK UP SAMPLES FINISH GRADE -5" THICK LIMESTONE BASE WITH 1" CHAMFER 1" THICK MIN. MORTAR SETTING BED CAST-IN-PLACE CONCRETE FOUNDATION #5 REBAR @ 12" O.C. COMPACTED SUBGRADE 95% MOD. PROCTOR

MASONRY WALL DETAIL SCALE: 1/8'' = 1'-0''

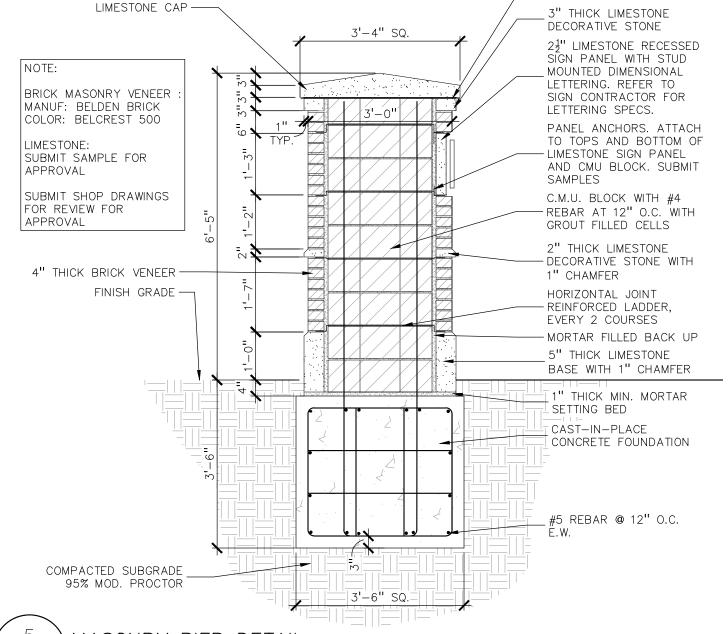

MASONRY PIER DETAIL SCALE: 1/8'' = 1'-0''

TREE PROTECTION DETAIL

SCALE: 1'' = 3'-0''

STAKING/GUYING

MIN. TYP.

SCALE: 1'' = 3'-0''

LOCATION

TREE PROTECTION WILL BE ERECTED PRIOR TO START OF CONSTRUCTION ACTIVITIES AND SHALL REMAIN IN PLACE UNTIL CONSTRUCTION IS COMPLETE NO PERSON MAY CONDUCT ANY ACTIVITY WITHIN THE DRIP LINE OF ANY TREE DESIGNATED TO REMAIN; INCLUDING, BUT NOT LIMITED TO PLACING SOLVENTS, BUILDING MATERIAL, CONSTRUCTION EQUIPMENT OR

SOIL DEPOSITS WITHIN DRIP LINES GRADE CHANGES MAY NOT OCCUR WITHIN THE DRIP

LINE OF PROTECTED TREES DURING CONSTRUCTION, NO PERSON SHALL ATTACH ANY DEVICE OR WIRE TO ANY REMAINING TREE

ALL UTILITY SERVICE REQUESTS MUST INCLUDE NOTIFICATION TO THE INSTALLER THAT PROTECTED TREES MUST BE AVOIDED. ALL TRENCHING SHALL OCCUR OUTSIDE OF THE PROTECTIVE FENCING

TREES LOCATED ON ADJACENT PROPERTY THAT MAY BE AFFECTED BY CONSTRUCTION ACTIVITIES MUST BE

TREES TO BE PRESERVED SHALL BE IDENTIFIED WITH

FLAGGING PRIOR TO THE TREE CLEARING OPERATIONS PROVIDE FENCE AROUND CRITICAL ROOT ZONE OF

FENCE SHALL BE PLACED IN A CIRCLE WITH A MINIMUM RADIUS OF 1' PER 1" DIAMETER OF THE

TREE MEASURED AT 4.5' ABOVE GROUND

4'HIGH PROTECTIVE FENCING WITH STEEL POSTS — 10' O.C. - EXISTING SOIL

CAUTION!! THE LOCATIONS AND ELEVATIONS OF EXISTING UNDERGROUND UTILITIES AS SHOWN ON THIS DRAWING ARE ONLY APPROXIMATE. NO GUARANTEE IS EITHER EXPRESSED OR IMPLIED AS TO THE COMPLETENESS OR ACCURACY THEREOF. THE CONTRACTOR SHALL BE EXCLUSIVELY RESPONSIBLE FOR DETERMINING THE FACEL HILL IN COCATIONS AND ELEVATIONS. DETERMINING THE EXACT UTILITY LOCATIONS AND ELEVATION PRIOR TO THE START OF CONSTRUCTION.

PEA

GROUP

t: 844.813.2949

www.peagroup.com

LYNN A.

WHIPPLE

LAND8CAPE

ARCHITEC

STAKE JUST BELOW BRANCHES WITH 2"-3" WIDE NYLON OR PLASTIC STRAPS. CONNECT FROM TREE TO STAKE AND ALLOW FOR FLEXIBILITY. REMOVE AFTER (1) ONE YEAR. (DO NOT USE WIRE & HOSE) THREE 2"X2" HARDWOOD STAKES OR STEEL T-POSTS DRIVEN A MIN. OF 18" DEEP FIRMLY INTO SUBGRADE PRIOR TO BACKFILLING SHREDDED HARDWOOD BARK MULCH TO DRIPLINE. 3" DEEP AND LEAVE 3" CIRCLE OF CLIENT BARE SOIL AROUND TREE TRUNK. DO NOT PLACE MILICH IN CONTACT WITH TREE TRUNK. FORM SAUCER WITH 4" HIGH DEVELOPMENT, CONTINUOUS RIM

PLANT SO THAT TOP OF ROOT BALL IS

POORLY DRAINED SOILS

FLUSH TO GRADE OR 1-2" HIGHER IF IN

- FINISH GRADE SPECIFIED PLANTING MIX, WATER & TAMP TO - REMOVE AIR POCKETS, AMEND SOIL PER SITE CONDITIONS & TREE REQUIREMENTS EXPOSE ROOT FLARE OF TREE. CONTRACTOR MAY HAVE TO REMOVE EXCESS SOIL FROM -TOP OF ROOTBALL. REMOVE ALL BURLAP

FROM TOP $\frac{1}{3}$ OF ROOTBALL. DISCARD ALL NON-BIODEĞRADABLE MATERIAL OFF SITE _PLACE ROOTBALL ON UNEXCAVATED OR TAMPED SOIL

EVERGREEN TREE PLANTING DETAIL

PROJECT TITLE THE VILLAGE **OF HASTINGS** PART OF THE SW 1/4 OF SECTION 3, T. 02N., R. 11E.,

REVISIONS

REV. PER COMMENTS 6/2/2023 8/9/2023

REV. PER COMMENTS 8/24/2023 11/17/2023

REV. PER PC COMMENTS 11/28/2023 12/7/2023

REV. PER PC COMMENTS 1/9/2024 1/24/2024

ORIGINAL ISSUE DATE:

LANDSCAPE

DETAILS

JUNE 1, 2023

DRAWING TITLE


3301 MIRAGE DRIVE

TROY, MI 48083

LIMESTONE PIER CAP WITH 1" OVERHANG VERTICAL EXPANSION JOINT BETWEEN WALL AND PIER - REFER TO DETAIL BRICK MASONRY BRICK MASONRY PIER WALL BELOW LIMESTONE WALL CAP WITH 1" OVERHANG

MASONRY WALL AND PIER PLAN ENLARGEMENT SCALE: 1/8'' = 1'-0''

BELOW

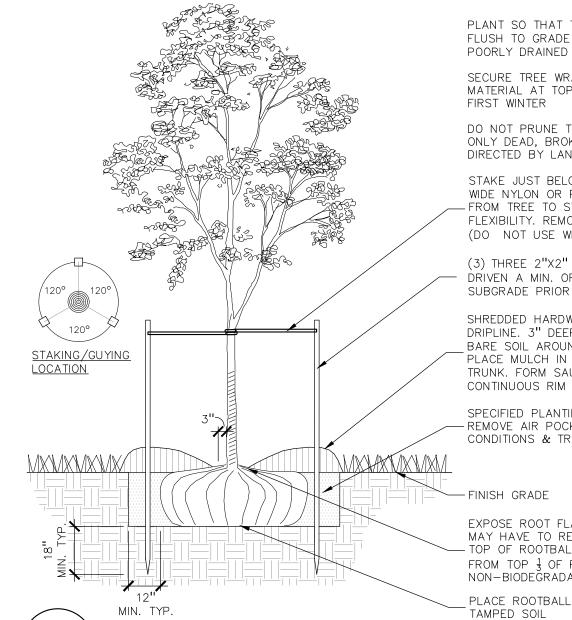

DECIDUOUS TREE PLANTING DETAIL

SCALE: 1'' = 3'-0''

PLANT SO THAT TOP OF ROOT BALL IS FLUSH TO GRADE OR 1-2" HIGHER IF IN POORLY DRAINED SOILS SECURE TREE WRAP WITH BIODEGRADABLE MATERIAL AT TOP & BOTTOM, REMOVE AFTER

DO NOT PRUNE TERMINAL LEADER PRUNE ONLY DEAD, BROKEN BRANCHES AS DIRECTED BY LANDSCAPE ARCHITECT

STAKE JUST BELOW BRANCHES WITH 2"-3" WIDE NYLON OR PLASTIC STRAPS. CONNECT FROM TREE TO STAKE AND ALLOW FOR FLEXIBILITY. REMOVE AFTER (1) ONE YEAR. (DO NOT USE WIRE & HOSE)

(3) THREE 2"X2" HARDWOOD STAKES DRIVEN A MIN. OF 18" DEEP FIRMLY INTO SUBGRADE PRIOR TO BACKFILLING

SHREDDED HARDWOOD BARK MULCH TO DRIPLINE. 3" DEEP AND LEAVE 3" CIRCLE OF BARE SOIL AROUND TREE TRUNK. DO NOT PLACE MULCH IN CONTACT WITH TREE TRUNK. FORM SAUCER WITH 4" HIGH

SPECIFIED PLANTING MIX, WATER & TAMP TO - REMOVE AIR POCKETS, AMEND SOIL PER SITE CONDITIONS & TREE REQUIREMENTS

EXPOSE ROOT FLARE OF TREE. CONTRACTOR MAY HAVE TO REMOVE EXCESS SOIL FROM

PEA JOB NO. 2017-009 - TOP OF ROOTBALL. REMOVE ALL BURLAP FROM TOP $\frac{1}{3}$ OF ROOTBALL. DISCARD ALL JBT P.M. NON-BIODEGRADABLE MATERIAL OFF SITE DN. LAW PLACE ROOTBALL ON UNEXCAVATED OR DES. LAW DRAWING NUMBER:

PLANT SO THAT TOP OF ROOT BALL IS

SHREDDED HARDWOOD BARK MULCH 3"

DEEP AND LEAVE 3" CIRCLE OF BARE

SPECIFIED PLANTING MIX. WATER AND

REMOVE ALL BURLAP FROM TOP $\frac{1}{3}$ OF

NON-BIODEGRADABLE MATERIAL OFF SITE

PLACE ROOTBALL ON UNEXCAVATED OR

TAMP TO REMOVE AIR POCKETS

-ROOTBALL DISCARD ALL

TAMPED SOIL

SOIL AROUND TRUNK. DO NOT PLACE

MULCH IN CONTACT WITH TRUNK

FLUSH TO GRADE OR 1-2" HIGHER IF

DO NOT COVER TOP OF ROOTBALL

FORM SAUCER WITH 4" HIGH

IN POORLY DRAINED SOILS

WITH SOIL

CONTINUOUS RIM

-FINISH GRADE

VARIES ON CONTAINER

SHRUB PLANTING DETAIL

OR BALL SIZE

SCALE: 1'' = 2'-0''

ALUMINUM EDGE DETAIL SCALE: 1/2'' = 1'-0''

SURE-LOC E-Z EDGE ALUMINUM EDGING OR APPROVED EQUAL WITH BLACK FINISH BED MEDIA - COMPACTED SUBGRADE **EDGING NOTES:**


MANUFACTURER: SURE-LOC (OR APPROVED EQUAL) PHONE#: 1.800.787.3562 PRODUCT: E-Z EDGE


FINISH: BLACK 2. 4 - 6' SECTIONS ALUMINUM EDGING (24 TOTAL LF), 12 SPIKES PER BOX 3. SLIDE ENDS TOGETHER, OVERLAP MATERIAL 4", AND INSERT STAKE AT 45° ANGLE FOR

4. STAKE SHALL SECURELY ENGAGE EDGING AND SHALL BE ENTIRELY BELOW TOP OF SURFACE OF EDGING 5. INSTALL AS PER MANUFACTURER'S SPECIFICATIONS WITH TOP OF EDGING $\frac{1}{4}$ " ABOVE COMPACTED FINISH GRADE. FINISH GRÂDE TO BE COMPACTED ON

CONNECTION BETWEEN SECTIONS

BOTH SIDES OF EDGING TO MAINTAIN STABILITY

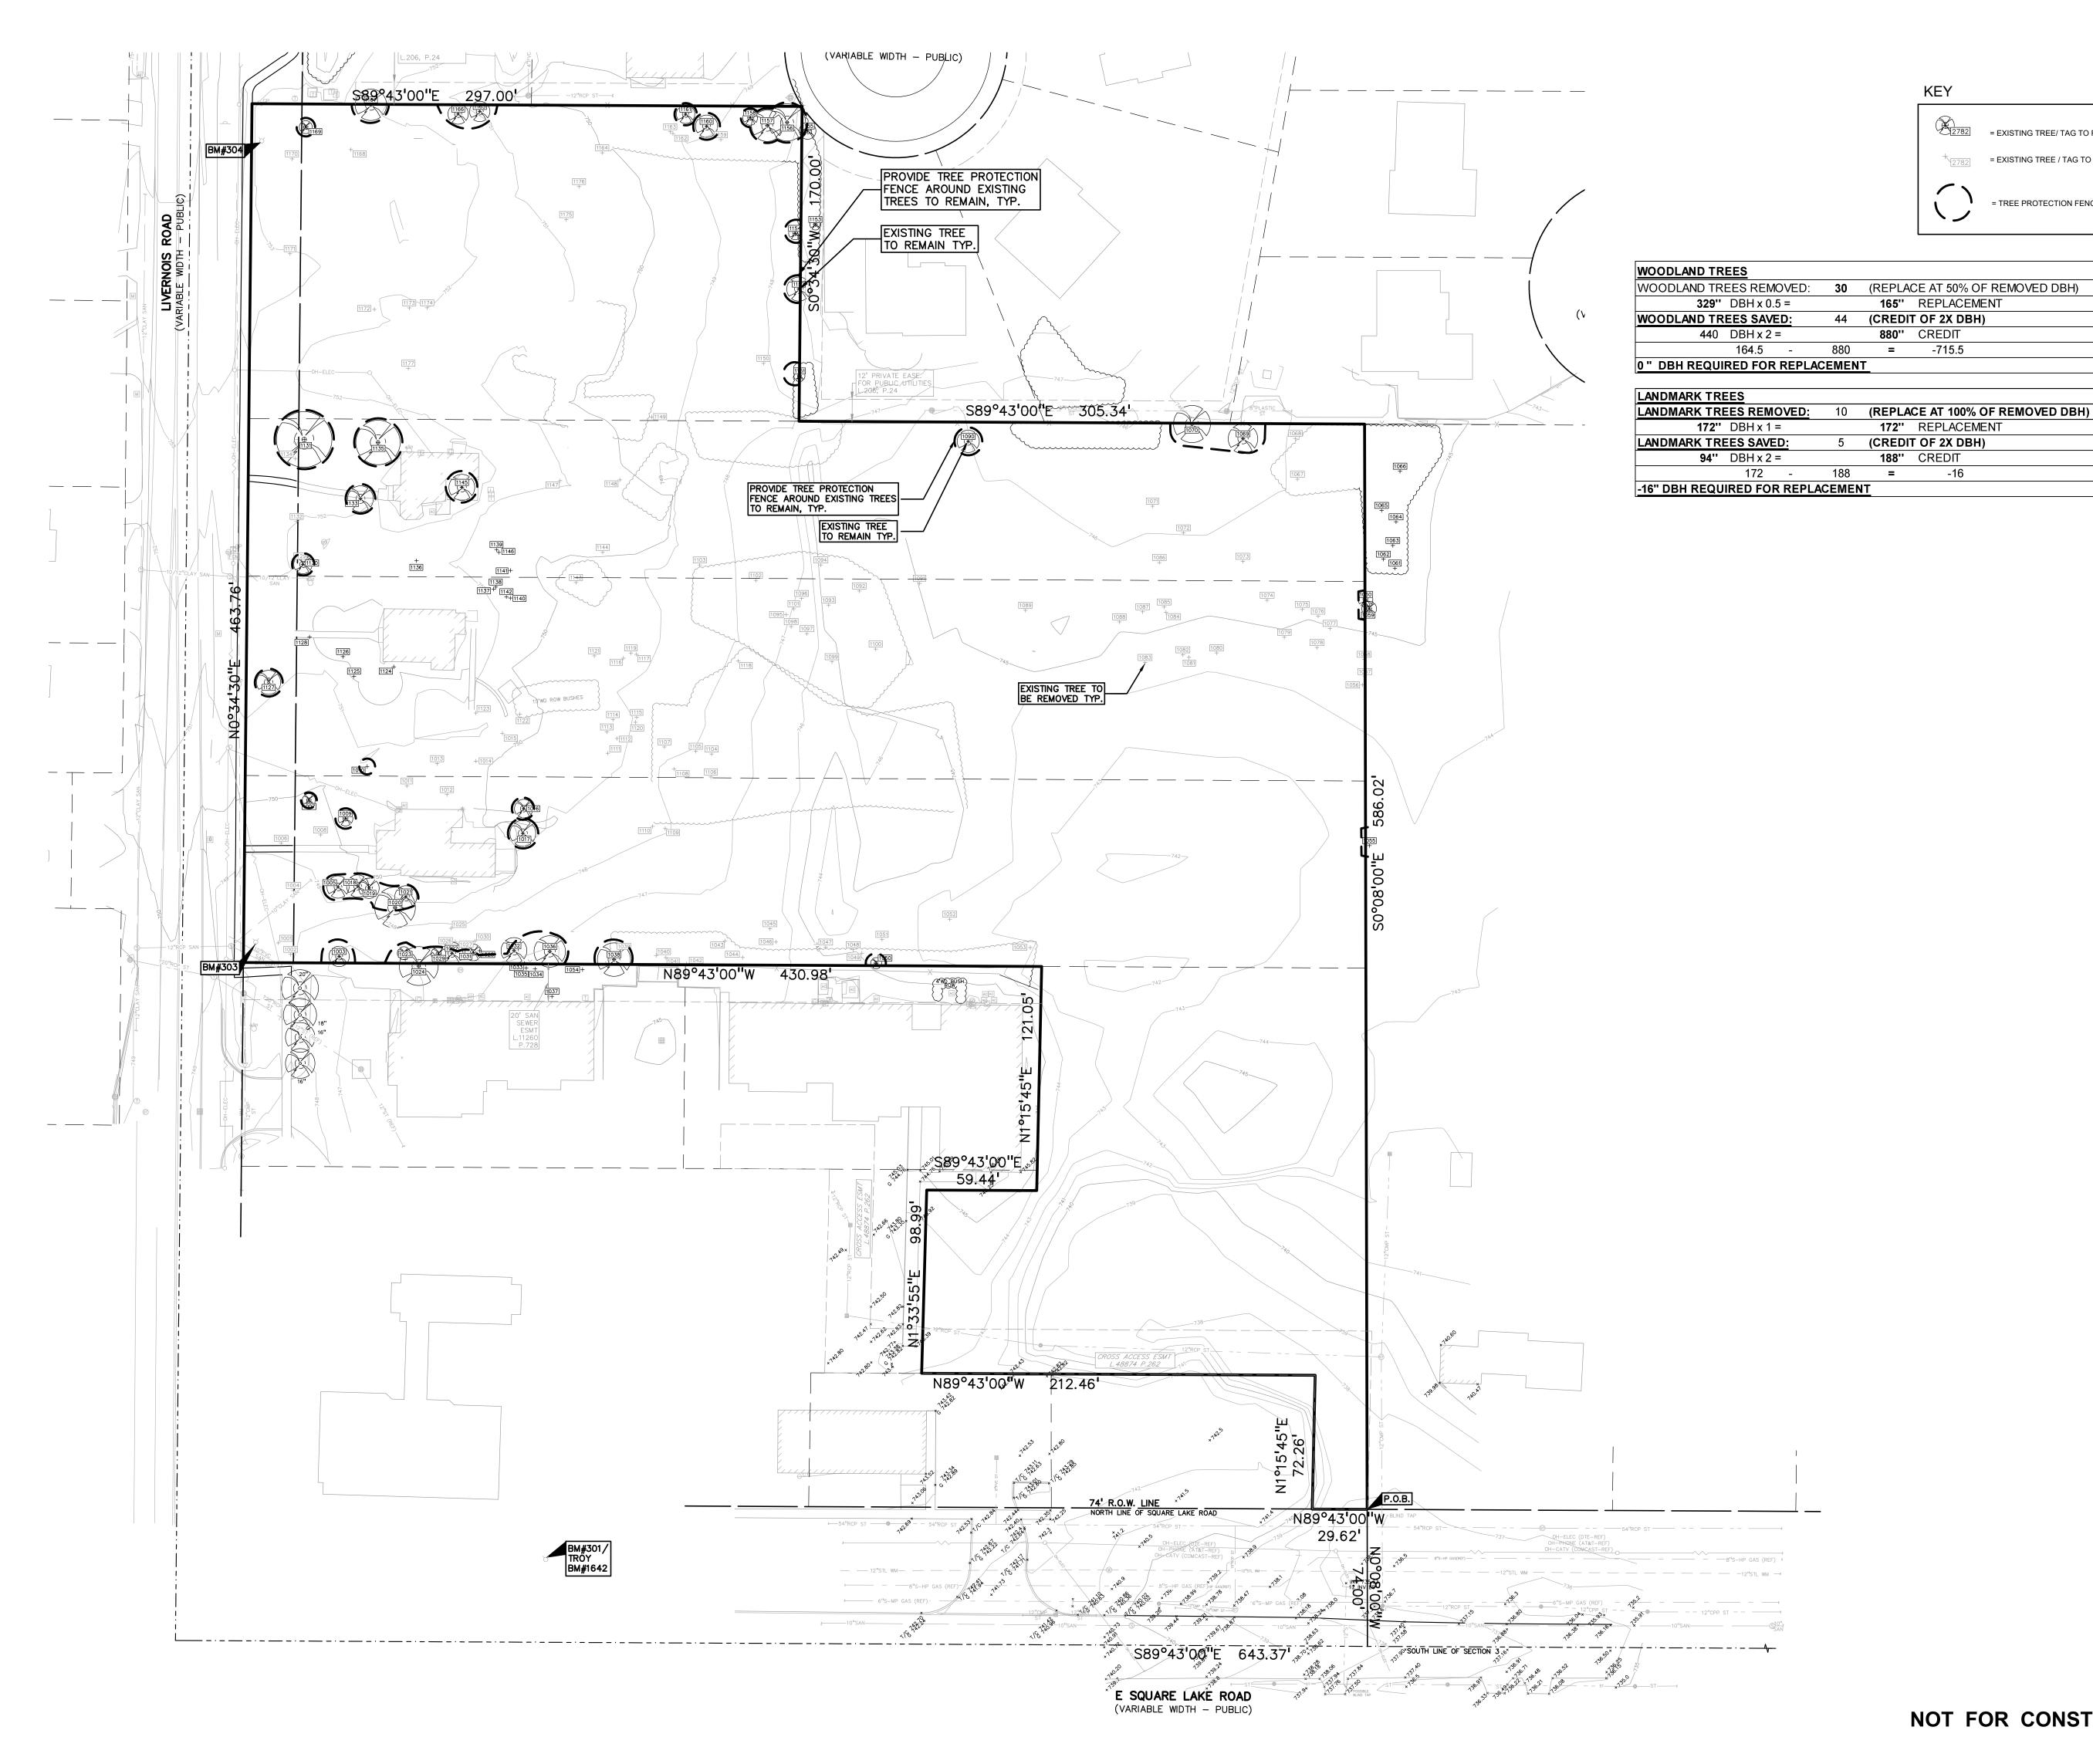


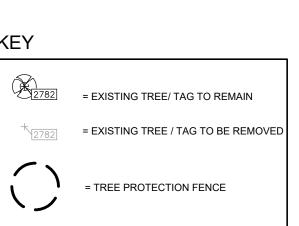







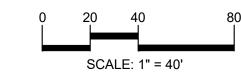



CAUTION!!

THE LOCATIONS AND ELEVATIONS OF EXISTING UNDERGROUND UTILITIES AS SHOWN ON THIS DRAWING ARE ONLY APPROXIMATE. NO GUARANTEE IS EITHER EXPRESSED OR IMPLIED AS TO THE COMPLETENESS OR ACCURACY THEREOF. THE CONTRACTOR SHALL BE EXCLUSIVELY RESPONSIBLE FOR DETERMINING THE EXACT UTILITY LOCATIONS AND ELEVATIONS PRIOR TO THE START OF CONSTRUCTION.

CLIENT GFA
DEVELOPMENT,
INC.
3301 MIRAGE DRIVE
TROY, MI 48083

PROJECT TITLE THE VILLAGE OF HASTINGS PART OF THE SW 1/4 OF SECTION 3, T. 02N., R. 11E., TROY, MI

REVISIONS REV. PER COMMENTS 6/2/2023 8/9/2023 REV. PER COMMENTS 8/24/2023 11/17/2023 REV. PER PC COMMENTS 11/28/2023 12/7/2023 REV. PER PC COMMENTS 1/9/2024 1/24/2024

ORIGINAL ISSUE DATE: JUNE 1, 2023

TREE **PRESERVATION PLAN**

PEA JOB NO.	2017-00
P.M.	JB
DN.	LAV
DES.	LAV
DRAWING NUMBER:	

							_		_		_								
TAG 1	CODE	DBH 6	COMMON NAME American Elm	LATIN NAME Ulmus americana	Poor	NOTE	CLASS INVASIVE	SAVE / REMOVE	ON-SITE	TAG 104	BX	DBH 7	Box elder	Acer negundo	Very Poor	NOTE	CLASS INVASIVE	SAVE / REMOVE O	ON-SITE
2	E	7	American Elm	Ulmus americana	Very Poor		INVASIVE	S	Y	105	BX	9	Box elder	Acer negundo	Very Poor		INVASIVE	S	Y
3	CT BW	11 13	Cottonwood Black Walnut	Populus deltoides Juglans nigra	Poor Very Poor		INVASIVE WOODLAND	S S	Y	106 107	BX BX	12 17	Box elder Box elder	Acer negundo Acer negundo	Poor Poor		INVASIVE INVASIVE	S S	Y
5	В	8	Basswood	Tilia americana	Fair		WOODLAND	S	Y	108	BX	9	Box elder	Acer negundo	Poor		INVASIVE	S	Y
6	BX B	8	Box elder Basswood	Acer negundo Tilia americana	Very Poor Fair		INVASIVE WOODLAND	S S	Y	109 110	B B	12 10	Basswood Basswood	Tilia americana Tilia americana	Fair Fair		WOODLAND WOODLAND		Y
8	BX	6	Box elder	Acer negundo	Poor		INVASIVE	S	Y	111	В	12	Basswood	Tilia americana	Fair		WOODLAND	S	Y
10	E E	9	American Elm American Elm	Ulmus americana Ulmus americana	Fair Fair		INVASIVE INVASIVE	S S	Y	112 113	B B	10 8	Basswood Basswood	Tilia americana Tilia americana	Fair Fair		WOODLAND WOODLAND	_	Y
11	В	6	Basswood	Tilia americana	Poor		WOODLAND	S	Y	114	В	8	Basswood	Tilia americana	Fair		WOODLAND	S	Y
12	BX	9	American Elm Box elder	Ulmus americana Acer negundo	Fair Poor		INVASIVE INVASIVE	S S	Y	115 116	BX BX	8	Box elder Box elder	Acer negundo Acer negundo	Fair Fair		INVASIVE INVASIVE	S S	N N
14	BX	7	Box elder	Acer negundo	Poor		INVASIVE	S	Y	117	PW	6	White Poplar	Populus alba	Good		INVASIVE	S	N
15 16	E E	7	American Elm American Elm	Ulmus americana Ulmus americana	Very Poor Fair		INVASIVE INVASIVE	S S	Y	1001 1002	BS AU	10 15	Blue Spruce Austrian Pine	Picea pungens Pinus nigra	Poor Fair		WOODLAND WOODLAND		$\frac{\lambda}{\lambda}$
17	E CT	9	American Elm	Ulmus americana	Fair		INVASIVE	S	Y	1003 1004	SC B	11 23	Scotch Pine Basswood	Pinus sylvestris Tilia americana	Fair Good		WOODLAND		Y ¥
18 19	NM	11	Cottonwood Norway Maple	Populus deltoides Acer platanoides	Poor Fair		INVASIVE INVASIVE	S S	Y	1004	SM	12	Silver Maple	Acer saccharinum	Fair		LANDMARK INVASIVE	S	Y
20 21	E BX	12 12	American Elm Box elder	Ulmus americana Acer negundo	Poor Very Poor		INVASIVE INVASIVE	S S	Y	1006 1007	NS WS	14	Norway Spruce White Spruce	Picea Abies Picea glauca	Fair Poor		WOODLAND WOODLAND		¥
22	E	9	American Elm	Ulmus americana	Poor		INVASIVE	S	Y	1008	NM	27	Norway Maple	Acer platanoides	Good		INVASIVE	R	¥
23	E CT	7 11	American Elm Cottonwood	Ulmus americana Populus deltoides	Fair Good		INVASIVE INVASIVE	S S	Y	1009	WS TH	14 7	White Spruce Thornapple/Hawthorne	Picea glauca Cragaegus spp.	Fair Poor		WOODLAND WOODLAND	+	Y
25	В	9	Basswood	Tilia americana	Poor		WOODLAND	S	Y	1011	TH	11	Thornapple/Hawthorne	Cragaegus spp.	Poor		WOODLAND	S	Y
26 27	CT BX	8 7	Cottonwood Box elder	Populus deltoides Acer negundo	Poor Poor		INVASIVE INVASIVE	S S	Y	1012 1013	SU NM	17 10	Sugar Maple Norway Maple	Acer saccharum Acer platanoides	Fair Fair		LANDMARK INVASIVE	S R	Y ¥
28	E	10	American Elm	Ulmus americana	Good		INVASIVE	S	Y	1014	NM	13	Norway Maple	Acer platanoides	Good		INVASIVE	R	¥
29 30	B	13 7	American Elm Basswood	Ulmus americana Tilia americana	Fair Poor		INVASIVE WOODLAND	S S	Y	1015 1016	NM WS	11 10	Norway Maple White Spruce	Acer platanoides Picea glauca	Good Poor		INVASIVE WOODLAND	S	Y
31	NM	15	Norway Maple	Acer platanoides	Good		INVASIVE	S	Y	1017 1018	SU SC	14 12	Sugar Maple Scotch Pine	Acer saccharum	Very Poor	dead	WOODLAND		Y
32	NM B	15 7	Norway Maple Basswood	Acer platanoides Tilia americana	Very Poor Poor		INVASIVE WOODLAND	S S	Y	1018	NM	11	Norway Maple	Pinus sylvestris Acer platanoides	Fair Good		WOODLAND INVASIVE	S S	Y
34 35	В	10 11	Basswood Basswood	Tilia americana Tilia americana	Poor		WOODLAND	S	Y	1020 1021	SM SC	22 20	Silver Maple Scotch Pine	Acer saccharinum Pinus sylvestris	Fair Good		INVASIVE LANDMARK	S	Y
36	E	6	American Elm	Ulmus americana	Poor Fair		WOODLAND INVASIVE	S S	Y	1022	NM	12	Norway Maple	Acer platanoides	Fair		INVASIVE	S	Y
37 38	E BC	9	American Elm Wild Black Cherry	Ulmus americana Prunus serotina	Poor Fair		INVASIVE WOODLAND	S S	Y	1023 1024	SC NM	7 21	Scotch Pine Norway Maple	Pinus sylvestris Acer platanoides	Fair Good		WOODLAND INVASIVE	S S	Y N
39	E	6	American Elm	Ulmus americana	Poor		INVASIVE	S	Y	1025	SC	13	Scotch Pine	Pinus sylvestris	Fair		WOODLAND		¥
40	B	7 9	Basswood Basswood	Tilia americana Tilia americana	Poor Fair		WOODLAND WOODLAND	S S	Y	1026 1027	NM NM	8 10	Norway Maple Norway Maple	Acer platanoides Acer platanoides	Good Good		INVASIVE INVASIVE	R	¥
42	В	8	Basswood	Tilia americana	Poor		WOODLAND	S	Y	1028	NM	10	Norway Maple	Acer platanoides	Good		INVASIVE	S	Y
43	B B	8 6	Basswood Basswood	Tilia americana Tilia americana	Very Poor Very Poor		WOODLAND WOODLAND	S S	Y	1029 1030	NM NM	8 9	Norway Maple Norway Maple	Acer platanoides Acer platanoides	Good Good		INVASIVE INVASIVE	S R	Y ¥
45	BC	10	Wild Black Cherry	Prunus serotina	Good		WOODLAND	S	Y	1031	NM	9	Norway Maple	Acer platanoides	Good		INVASIVE	S	Y
46	B B	8	Basswood Basswood	Tilia americana Tilia americana	Very Poor Fair		WOODLAND WOODLAND	S S	Y	1032 1033	BX BX	14 11	Box elder Box elder	Acer negundo Acer negundo	Fair Fair		INVASIVE INVASIVE	S S	Y N
48	В	8	Basswood	Tilia americana	Very Poor		WOODLAND	S	Y	1034	AU	16	Austrian Pine	Pinus nigra	Fair		WOODLAND	+	N
49 50	В	11 7	Basswood Basswood	Tilia americana Tilia americana	Poor Poor		WOODLAND WOODLAND	S S	Y	1035 1036	NM AU	17	Norway Maple Austrian Pine	Acer platanoides Pinus nigra	Good Very Poor	dead	INVASIVE WOODLAND	S S	N Y
51	В	7	Basswood	Tilia americana	Fair		WOODLAND	S	Y	1037 1038	NM BX	12 18	Norway Maple Box elder	Acer platanoides Acer negundo	Fair Fair		INVASIVE INVASIVE	S S	N
52 53A	GA	7	Basswood Green Ash	Tilia americana Fraxinus pennsylvanica	Fair Very Poor		WOODLAND INVASIVE	S S	Y	1030	₩C	6	White Cedar	Thuja occidentalis	Good		WOODLAND	-	¥
53B 54	E	9	American Elm American Elm	Ulmus americana Ulmus americana	Fair		INVASIVE INVASIVE	S S	Y	1040 1041	WC BX	6 10	White Cedar Box elder	Thuja occidentalis Acer negundo	Fair Fair		WOODLAND INVASIVE	R R	¥
55	BW	8	Black Walnut	Juglans nigra	Poor Fair		WOODLAND	S	Y	1042	NM	12	Norway Maple	Acer platanoides	Good		INVASIVE	R	¥
56 57	B	11 10	Basswood American Elm	Tilia americana Ulmus americana	Fair Fair		WOODLAND INVASIVE	S	Y	1043 1044	SM SC	12 11	Silver Maple Scotch Pine	Acer saccharinum Pinus sylvestris	Fair Very Poor	dead	INVASIVE WOODLAND	R R	¥
58	В	12	Basswood	Tilia americana	Fair		WOODLAND	S	Y	1045	SM	43	Silver Maple	Acer saccharinum	Fair		INVASIVE	R	¥
59 60	BX BX	7	Box elder Box elder	Acer negundo Acer negundo	Poor Poor		INVASIVE INVASIVE	S S	Y	1046 1047	NM SM	8 16	Norway Maple Silver Maple	Acer platanoides Acer saccharinum	Good Fair		INVASIVE INVASIVE	R R	Ż Ż
61	CT	11	Cottonwood	Populus deltoides	Poor		INVASIVE	S	Y	1048 1049	SC SC	14 14	Scotch Pine Scotch Pine	Pinus sylvestris Pinus sylvestris	Poor Poor		WOODLAND WOODLAND		¥
62 63	NM B	12 10	Norway Maple Basswood	Acer platanoides Tilia americana	Good Fair		INVASIVE WOODLAND	S S	Y	1050	SM	6	Silver Maple	Acer saccharinum	Fair		INVASIVE	S R	Y
64 65	CT	21 10	Cottonwood Basswood	Populus deltoides Tilia americana	Good Fair		INVASIVE WOODLAND	S S	Y	1051 1052	SM NM	22 8	Silver Maple Norway Maple	Acer saccharinum Acer platanoides	Good Very Poor		INVASIVE INVASIVE	R R	¥
66	В	12	Basswood	Tilia americana	Fair		WOODLAND	S	Y	1053	SM	30	Silver Maple	Acer saccharinum	Poor		INVASIVE	R	¥
67 68	CT NM	12 7	Cottonwood Norway Maple	Populus deltoides Acer platanoides	Poor Poor		INVASIVE INVASIVE	S S	Y	1054 1055	SU	7	Sugar Maple Thornapple/Hawthorne	Acer saccharum Cragaegus spp.	Good Very Poor	x2 dead	WOODLAND WOODLAND	+	N Y
69	NM	15	Norway Maple	Acer platanoides	Good		INVASIVE	S	Y	1056	SC	13	Scotch Pine	Pinus sylvestris	Fair		WOODLAND	R	¥
70 71	BX B	9	Box elder Basswood	Acer negundo Tilia americana	Poor Fair		INVASIVE WOODLAND	S S	Y	1057 1058	SC SC	12 13	Scotch Pine Scotch Pine	Pinus sylvestris Pinus sylvestris	Fair Fair		WOODLAND WOODLAND		¥ Y
72	BX	7	Box elder	Acer negundo	Poor		INVASIVE	S	Y	1059	BX	8	Box elder	Acer negundo	Fair	v2	INVASIVE	S	Y
73 74	BX B	7 13	Box elder Basswood	Acer negundo Tilia americana	Poor Fair		INVASIVE WOODLAND	S S	Y	1060 1061	BX BS	6	Box elder Blue Spruce	Acer negundo Picea pungens	Fair Fair	x2	INVASIVE WOODLAND	S S	N N
75	В	12	Basswood	Tilia americana	Fair		WOODLAND	S	Y	1062 1063	NS NS	6	Norway Spruce Norway Spruce	Picea Abies Picea Abies	Fair Fair		WOODLAND WOODLAND		N N
76 77	В	11	Basswood Basswood	Tilia americana Tilia americana	Fair Fair		WOODLAND WOODLAND	S S	Y	1064	NS	7	Norway Spruce	Picea Abies	Good		WOODLAND	S	N
78 79	BX CT	9 14	Box elder Cottonwood	Acer negundo Populus deltoides	Fair Fair		INVASIVE INVASIVE	S S	Y	1065 1066	NS SC	6 17	Norway Spruce Scotch Pine	Picea Abies Pinus sylvestris	Fair Fair		WOODLAND WOODLAND	+	N N
80	В	7	Basswood	Tilia americana	Fair Fair		WOODLAND	S	Y	1067	CŦ	25	Cottonwood	Populus deltoides	Good		INVASIVE	R	¥
81 82	CT B	12 7	Cottonwood Basswood	Populus deltoides Tilia americana	Fair Poor		INVASIVE WOODLAND	S S	Y	1068 1069	W P BW	21 16	(Eastern) White Pine Black Walnut	Pinus strobus Juglans nigra	Fair Good		LANDMARK WOODLAND		Y Y
83	В	7	Basswood	Tilia americana	Poor		WOODLAND	S	Y	1070	AU	20	Austrian Pine	Pinus nigra	Good	:44 4 lai a l	LANDMARK	S	Y
84 85	CT BX	12 8	Cottonwood Box elder	Populus deltoides Acer negundo	Fair Poor		INVASIVE INVASIVE	S S	Y	1071 1072	MH SH	16 16	Bitternut Hickory Shagbark Hickory	Carya cordiformis Carya ovata	Good &	hickory hickory	LANDMARK LANDMARK		¥ Y
86	PW	14	White Poplar	Populus alba	Good		INVASIVE	S	Y	1073 1074	SH SC	8	Shagbark Hickory Scotch Pine	Carya ovata Pinus sylvestris	Very Poor	hickory	WOODLAND	R	¥
87 88	BX E	8	Box elder American Elm	Acer negundo Ulmus americana	Poor Poor		INVASIVE INVASIVE	S S	Y	1075	SC	12 10	Scotch Pine	Pinus sylvestris	Fair Fair		WOODLAND WOODLAND		¥
89	BX	11	Box elder	Acer negundo	Poor		INVASIVE	S	Y	1076 1077	SC SC	10 9	Scotch Pine Scotch Pine	Pinus sylvestris Pinus sylvestris	Fair Fair		WOODLAND WOODLAND	+	¥
90 91	E E	10 8	American Elm American Elm	Ulmus americana Ulmus americana	Good Fair		INVASIVE INVASIVE	S S	Y	1078	SC	9	Scotch Pine	Pinus sylvestris	Fair		WOODLAND	R	¥
92 93	BX BX	11 13	Box elder Box elder	Acer negundo	Poor		INVASIVE	S	Y	1079 1080	SC SC	8 14	Scotch Pine Scotch Pine	Pinus sylvestris Pinus sylvestris	Fair Fair		WOODLAND WOODLAND	+	Ż Ż
93	B	13 14	Box elder Basswood	Acer negundo Tilia americana	Poor Very Poor		INVASIVE WOODLAND	S S	Y	1081	SC	8	Scotch Pine	Pinus sylvestris	Fair		WOODLAND	R	¥
95 96A	BX B	16 9	Box elder Basswood	Acer negundo Tilia americana	Poor Poor		INVASIVE WOODLAND	S S	Y	1082 1083	SC SC	13 16	Scotch Pine Scotch Pine	Pinus sylvestris Pinus sylvestris	Fair Fair	×1	WOODLAND WOODLAND	+	¥
96B	В	9	Basswood	Tilia americana	Poor		WOODLAND	S	Y	1084	SM	10	Silver Maple	Acer saccharinum	Good		INVASIVE	R	¥
97 98	BX BX	10 11	Box elder Box elder	Acer negundo Acer negundo	Poor Very Poor		INVASIVE INVASIVE	S S	Y	1085 1086	SC BT	9 9	Scotch Pine Butternut	Pinus sylvestris Juglans cinerea	Fair Good		WOODLAND LANDMARK		Ż Ż
99	СТ	11	Cottonwood	Populus deltoides	Fair		INVASIVE	S	Y	1087	SM SM	10	Silver Maple	Acer saccharinum	Fair		INVASIVE	R	¥ ¥
100	RO B	8 7	Red Oak Basswood	Quercus rubra Tilia americana	Poor Fair		WOODLAND WOODLAND	S S	Y	1088 1089	BX	16 12	Silver Maple Box elder	Acer saccharinum Acer negundo	Good Fair		INVASIVE INVASIVE	R R	¥
102	BX	12	Box elder	Acer negundo	Poor		INVASIVE	S	Y	1090 1091	BS SM	12 12	Blue Spruce Silver Maple	Picea pungens Acer saccharinum	Good Fair		WOODLAND INVASIVE	S R	Y ¥
103	BX	l 8	Box elder	Acer negundo	Poor		INVASIVE	S	ı Y	ı ı∪∀l	ı ⊘ı∨ ı	 	Unvernitable	, toor savorialiiliili	ı raıf l		■ 114 V / \ >1 V E	, K	+

WOODLAND TREE	ES REMOV	ED: 30	(REPLAC	CE AT 50% OF R	EMOVED DBH)
329 '' D)BH x 0.5 =		165''	REPLACEMENT	Τ
WOODLAND TREE	S SAVED:	44	(CREDIT	OF 2X DBH)	
440 D)BH x 2 =		880''	CREDIT	
	164.5	- 880	=	-715.5	
A !! DELL DECLUDE		DI AOENTEN	_		
0" DBH REQUIRE	ED FOR RI	EPLACEMEN	<u>T</u>		
·		EPLACEMEN	<u>T</u>		
LANDMARK TREE	:s			CE AT 4009/ OE	DEMOVED DDLI
LANDMARK TREE LANDMARK TREE	<u>S</u> S REMOV		(REPLA		REMOVED DBH)
LANDMARK TREE LANDMARK TREE	:s			CE AT 100% OF REPLACEMENT	
LANDMARK TREE LANDMARK TREE	<u>S</u> S REMOV DBH x 1 =		(REPLAC		
LANDMARK TREE LANDMARK TREE 172" D LANDMARK TREE	<u>S</u> S REMOV DBH x 1 =	ED: 10	(REPLAC	REPLACEMENT	
LANDMARK TREE LANDMARK TREE 172" D LANDMARK TREE	S REMOV BH x 1 =	ED: 10	(REPLAC 172'' (CREDIT	REPLACEMENT OF 2X DBH)	

LATIN NAME

Acer platanoides

Çatalpa speciosa

Acer negundo

Acer platanoides

Acer negundo

Acer negundo

Acer platanoides

Acer platanoides

Acer negundo

Picea pungens

Cragaegus-spp.

Acer platanoides

Acer platanoides

Acer saccharinum

Acer platanoides

Acer negundo

Acer negundo

Acer platanoides

Acer platanoides

Acer platanoides

Acer platanoides

Acer platanoides

Acer negundo

Acer platanoides

Acer platanoides

Juglans nigra

Juglans cinerea

Ulmus americana

Pinus sylvestris

Ulmus americana

Acer platanoides

Picea pungens

Acer platanoides

Morus alba

Acer platanoides

Quercus alba

Pinus strobus

Acer saccharinum

Picea glauca

Acer-platanoides

Picea glauca

Morus alba

Acer platanoides

Acer platanoides

Acer platanoides

Ulmus americana

Ulmus americana

Acer saccharinum

Pinus sylvestris

Pinus sylvestris

Picea pungens

Aesculus glabra

Acer saccharinum

Liriodendron tulipifera

Morus alba

Acer saccharinum

Thuja occidentalis

Acer platanoides

Picea pungens

Picea pungens

Picea pungens

Pinus strobus

Quercus alba

Abies balsamea

Acer saccharinum

Picea glauca

Abies balsamea

Abies balsamea

Picea glauca

Acer saccharinum

Picea glauca

Malus sylvestris

Acer negundo

Acer saccharinum

^oseudotsuga menziesii

Picea pungens

Acer saccharinum

Pyrus communis

P-yrus-communis

Pyrus communis

Acer saccharinum

Pinus resinosa

Malus sylvestris

(NO REPLACEMENT REQUIRED FOR EXEMPT TREES)

Norway Maple

Çatalpa

Box-elder

Norway Maple

Box elder

Box elder

Norway Maple

Norway Maple

Box elder

Blue Spruce

Thomapple/Hawthome

Norway Maple

Norway Maple

Silver Maple

Norway Maple

Box elder

Box elder

Norway Maple

Norway Maple

Norway Maple

Norway Maple

Norway Maple

Box elder

Norway Maple

Norway Maple

Black Walnut

Butternut

American Elm

Şcotch Pine

American Elm

Norway Maple

Blue Spruce

Norway Maple

Norway Maple

White Mulberry

Norway Maple

White Oak

Silver Maple

(Eastern) White Pine

White Spruce

Norway-Maple

White Spruce

White Mulberry

Norway Maple

Norway Maple

Norway Maple

American Elm

American Elm

Silver Maple

Scotch Pine

Scotch Pine

Blue Spruce

Ohio Buckeye

Silver Maple

Tulip Poplar

White Mulberry

Silver Maple

White Cedar

Norway Maple

Blue Spruce

Blue Spruce

Blue Spruce

(Eastern) White Pine

White Ōak

Balsam Fir

Silver Maple

White Spruce

Balsam Fir

Balsam Fir

White Spruce

Silver Maple

White Spruce

Domestic Apple

Box elder

Silver Maple

Douglas Fir

Blue Spruce

Silver Maple

Pear

Pear

Silver Maple

Red-Pine

Domestic Apple

10 (Eastern) White Pine

SAVED EXEMPT TREES: **EXEMPT TREES ON SITE:**

TAG | CODE | DBH | COMMON NAME |

9

9

12

10

13

45

8

20

10

44

12

20

24

24

15

20

14

15

14

12

24

12

11

17

15

14

6

20

14

11

39

44

12

28

13

9

20

8

26

12

10

13

20

11

17

15

26

13

14

25

12

13

1094

1095

1096

1097

1098

1099

1100

1101

1102

1103

1104

1105

1106

1107

1108

1109

1110

1111

1112

1113

1114

1115

1116

1117

1118

1121

1122

1123

1124

1125

1126

1130

1131

1132

1134

1135

1136

1137

1138

1139

1140

1141

1142

1143

1144

1146

1147

1148

1149

1150

1151

1152

1153

1154

1155

1156

1157

1158

1159

1160

1161

1162

1163

1164

1166

1167

1168

1169

1170

1171

1175

1176

1177

₽X

₿X

₽X

NM

NM

BX

NM

MM

NM

вх

 BW

1119 | BT | 20

1120 E | 15

SC

NM

BS

NM

NM

1127 MW 13

WP

WP

NM

MW

NM

NM

NM

SM

SG

\$€

ОВ

ŦP:

₩₩

WC

BS

ВŜ

WP

BF

SM

WŞ

8F

WS

ΑP

вх

DF

SM

BS

₩₽

1172 | PR | 5

SM

RP

ΑP

1173 PR

1174 PR

₩Ş

SM

WO

SM

NM

SM

1145 BS

WS

1128 NM

1129 WO

1133 WS

AT 50% OF REMOVED DBH)
REPLACEMENT
OF 2X DBH)
CREDIT
-715.5
E AT 100% OF REMOVED DBH)
E AT 100% OF REMOVED DBH) REPLACEMENT
-
REPLACEMENT
REPLACEMENT DF 2X DBH)
REPLACEMENT OF 2X DBH) CREDIT
REPLACEMENT DF 2X DBH) CREDIT

CONDITION

Good

Ciencel

Pair

Clood

 $P_{(\mathcal{H})}$

Poor

l'mir

(icac)d

Poor

Cicod

Poor

Good

Cicocd

Good

Good

lair

Fair

Circuit

Ciercod

Good

Ciond

Good

l'uir

-icocod

Good

Good

Lair

Good

l'air

Good

Good

Good

Clood

Good

Fair

Good

liair

Good

Good

Good

Fair

Good

Poor

Fair

Good

Good

Good

Good

Good

Good

1

Pair

Fair

Good

Pair

Fair

Good

Good

Good

Good

Good

Good

Fair

Fair

Poor

I air

Pair

Pair

Poor

Fair

Good

l'air

Very Poor

l'uir

trunk damage

NOTE

x 1

×1

x 1

o/s 10 ft E

INVASIVE

INVASIVE

WOODLAND

WOODLAND

INVASIVE

INVASIVE

INVASIVE

INVASIVI?

INVASIVI:

INVASIVE

INVASIVE

HVASHVE

INVASIVE

INVASIVE

INVASIVE

INVASIVE

INVASIVI

INVASIVE

CHANGOOW

INVASIVE

INVASIVE

INVASIVE

WOODLAND

INVASIVE

INVASIVE

INVASIVE

INVASIVE

CHAN, KICKNOW

WOODLAND

INVASIVE

(1111), K((()())

WOODLAND

INVASIVE

LANDMARK |

INVASIVE

INVASIVE

INVASIVE

INVASIVE

INVASIVE

INVASIVE

INVASIVE

W()()I)I,ANII)

LANDMARK

WOODLAND

WOODLAND

INVASIVE

(1/1/A. ICIC)() W

INVASIVE

INVASIVE

WOODLAND

INVASIVE

WOODLAND

WOODLAND

WOODLAND

LANDMARK

.ANDMARK

WOODLAND

INVASIVI:

WOODLAND

WOODLAND

(11/1A, 1(1()())W

WOODLAND

INVASIVE

WOODLAND

WOODLAND

INVASIVE

INVASIVE

WOODLAND

W()()())

INVASIVE

ANDMARK

LANDMARK

INVASIVE

WOODLAND

| domestic pear | \\(\)(\)(\)|\\\\\\\)

domestic-pear

domestic pear

ANDMARK I

-ANDMARK-

CLASS | SAVE / REMOVE | ON-SITE

₽

R

15

₽

H.

R

₽

R

₽

R

₽

R

R

₽

14

₽

R

R

₽

R

R

₩

R

 \mathbf{s}

 \mathbf{S}

 $^{\rm S}$

 \mathbf{s}

S

 $^{\rm S}$

 \mathbf{s}

S

 \mathbf{S}

 $^{\rm S}$

15

₩

¥

¥

¥

¥

¥

¥

	t: 844.813.2	949
W	ww.peagrou	p.com
.111	E OF MIC	11000
THE P		0,11
3.0	LYNN A.	
*	WHIPPLE	701
-4:	LANDSCAP ARCHITECT	TINE
- 9	No.4758	J. F.
2.37	-w	2.3

PΞΛ

GROUP





CAUTION!! THE LOCATIONS AND ELEVATIONS OF EXISTING UNDERGROUND UTILITIES AS SHOWN ON THIS DRAWING ARE ONLY APPROXIMATE. NO GUARANTEE IS EITHER EXPRESSED OR IMPLIED AS TO THE COMPLETENESS OR ACCURACY THEREOF. THE CONTRACTOR SHALL BE EXCLUSIVELY RESPONSIBLE FOR DETERMINING THE EXACT UTILITY LOCATIONS AND ELEVATIONS PRIOR TO THE START OF CONSTRUCTION.

DEVELOPMENT, 3301 MIRAGE DRIVE

PROJECT TITLE THE VILLAGE **OF HASTINGS** SECTION 3, T. 02N., R. 11E.,

REVISIONS	
REV. PER COMMENTS 6/2/2023	8/9/2023
REV. PER COMMENTS 8/24/2023	11/17/2023
REV. PER PC COMMENTS 11/28/2023	12/7/2023
REV. PER PC COMMENTS 1/9/2024	1/24/2024

ORIGINAL ISSUE DATE: JUNE 1, 2023


DRAWING TITLE

TREE PRESERVATION LIST

PEA JOB NO.	2017-009
P.M.	JBT
DN.	KAD
DES.	KAD
DRAWING NUMBER:	

NOT FOR CONSTRUCTION

¥

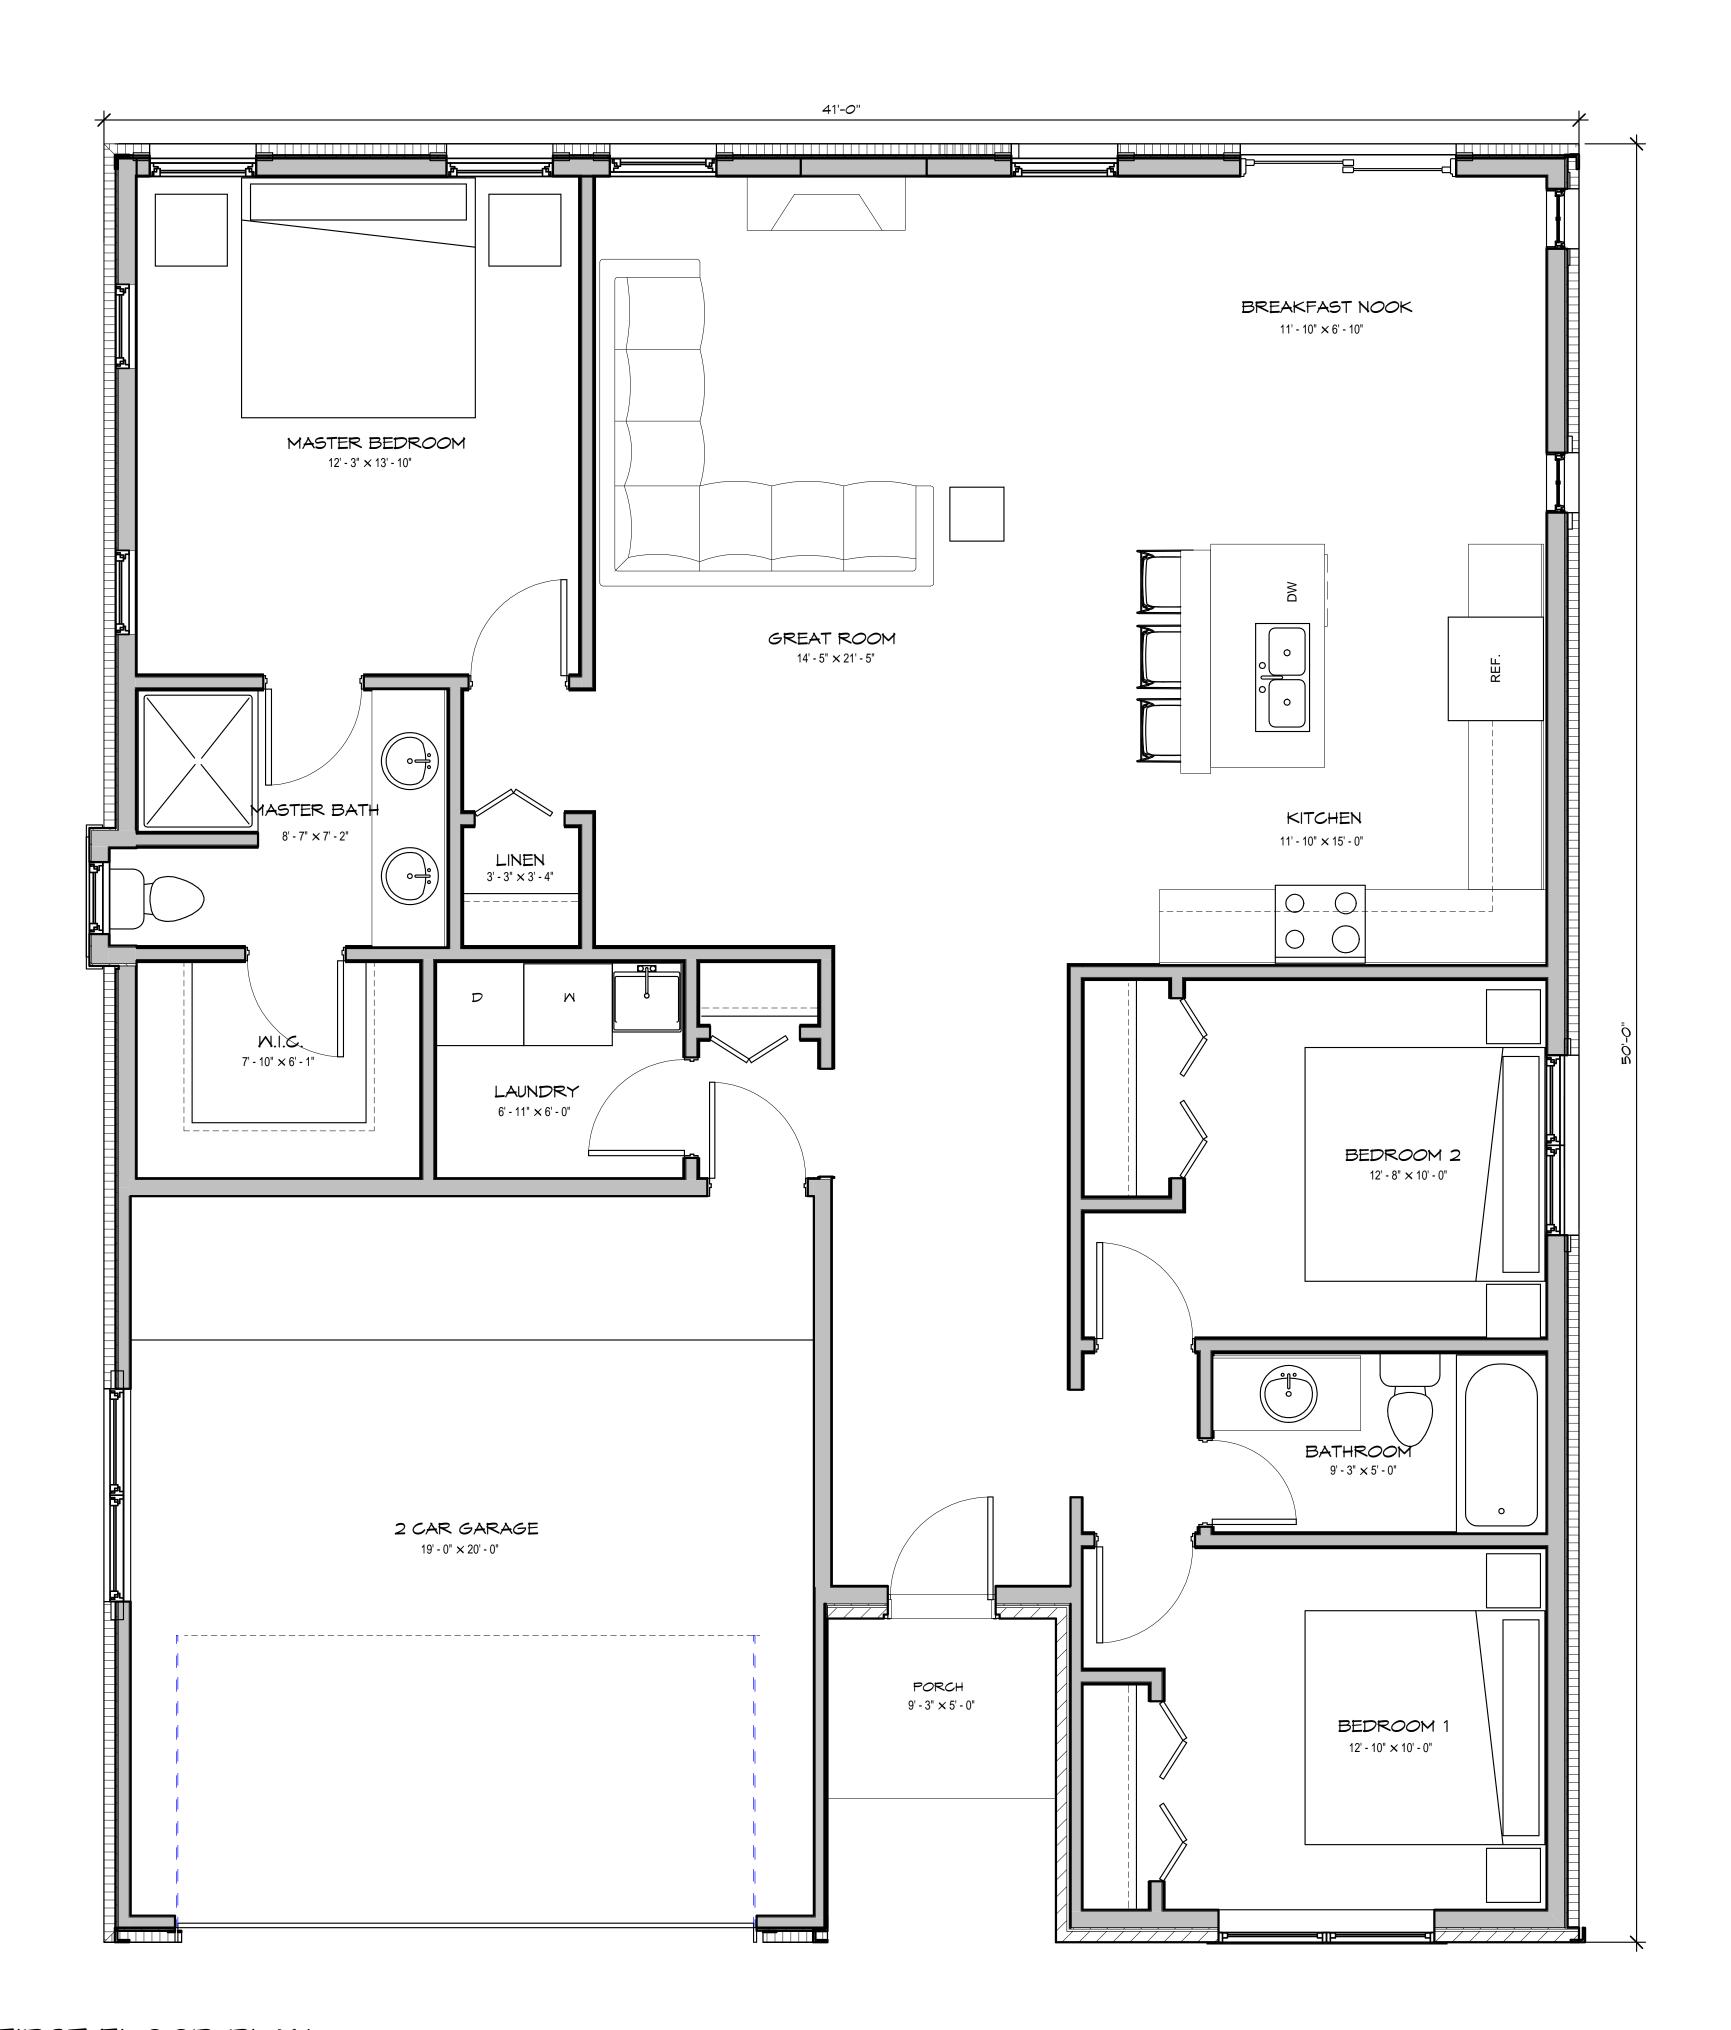

FIRST FLOOR PLAN

Scale: 3/8" = 1'-0"



Moiseev/Gordon Associates, Inc. 4351 Delemere Court Royal Oak, MI 48073

248.549.4500 voice 248.549.7300 facs.

www.mga-architects.net

Copyright

© 2024
Moiseev/Gordon Associates, Inc.
Use of these drawings is limited
to the client for the subject project.
Common law copyright is reserved
by the Architect.

Use figured dimensions only. Do not scale the drawings.

Client:

GFA Development -Ranch Unit

Project Title:

VILLAGE OF HASTINGS

Troy, MI

Sheet Title:

FIRST FLOOR UNIT PLAN

Project Number: 22312
Drawn By: AJM, JS
Checked By: AJM
Approved By: AJM
Date: 06-16-2023

Issued: Owner's Review


Owner's Review 06-16-23
Owner's Review 11-09-23
Site Plan Approval 04-29-24


Sheet Number:


A100



5/13/2024 5:48:59

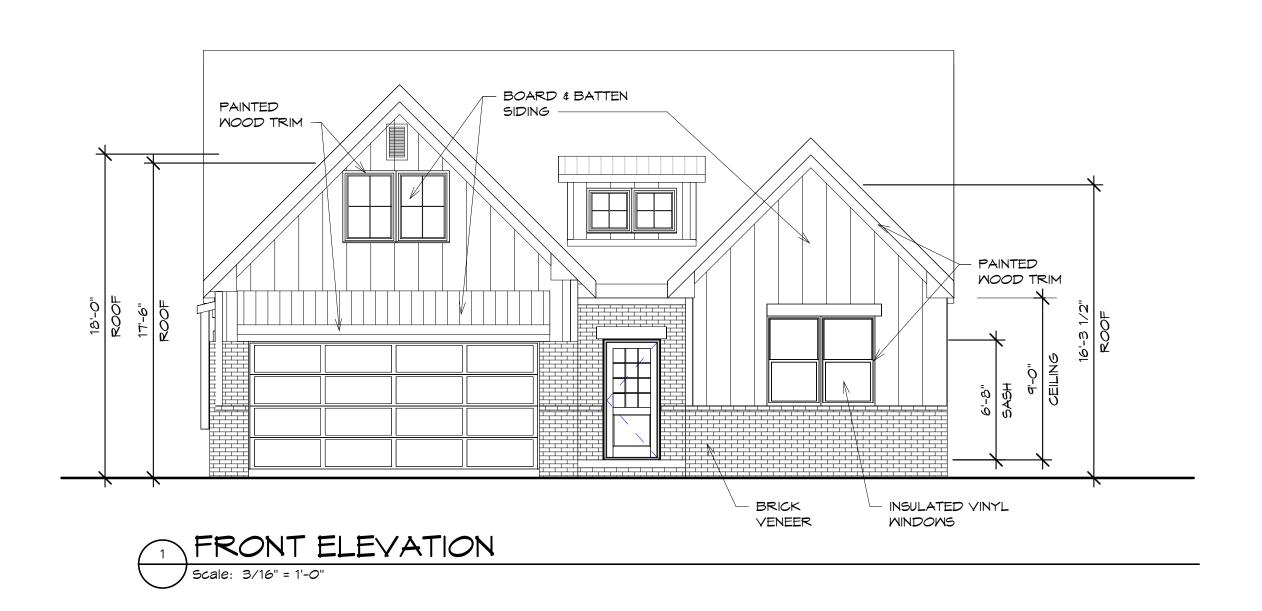


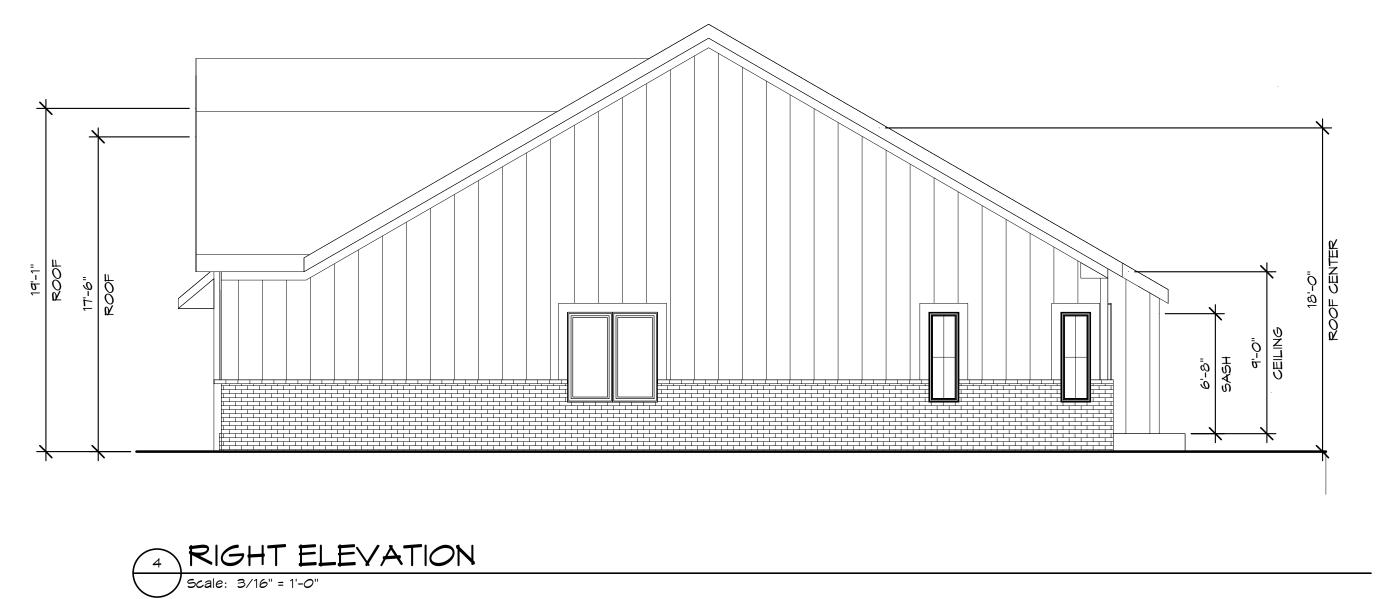

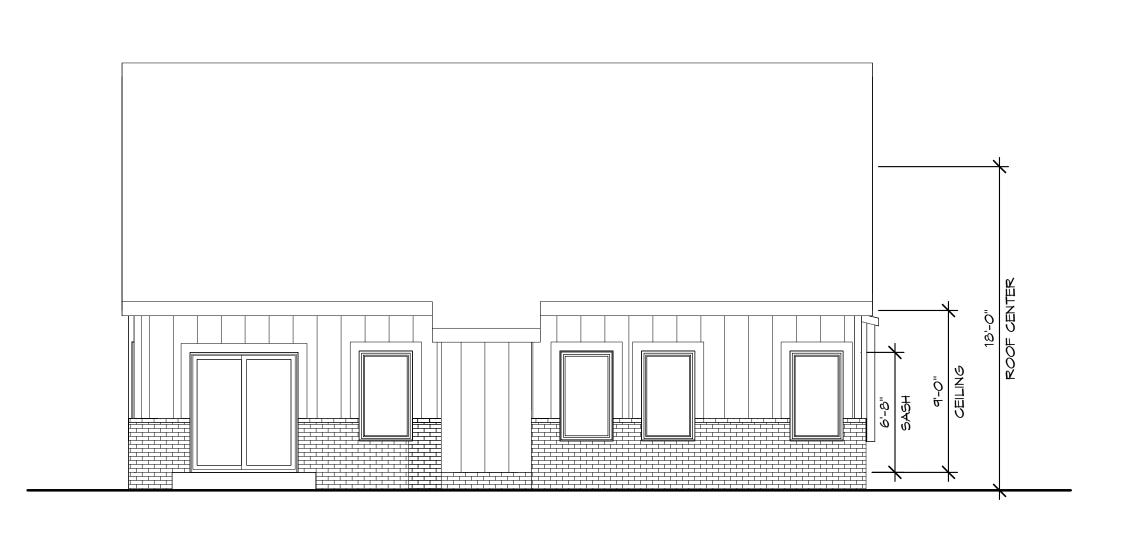

2 REAR ELEVATION

Scale: 3/16" = 1'-0"

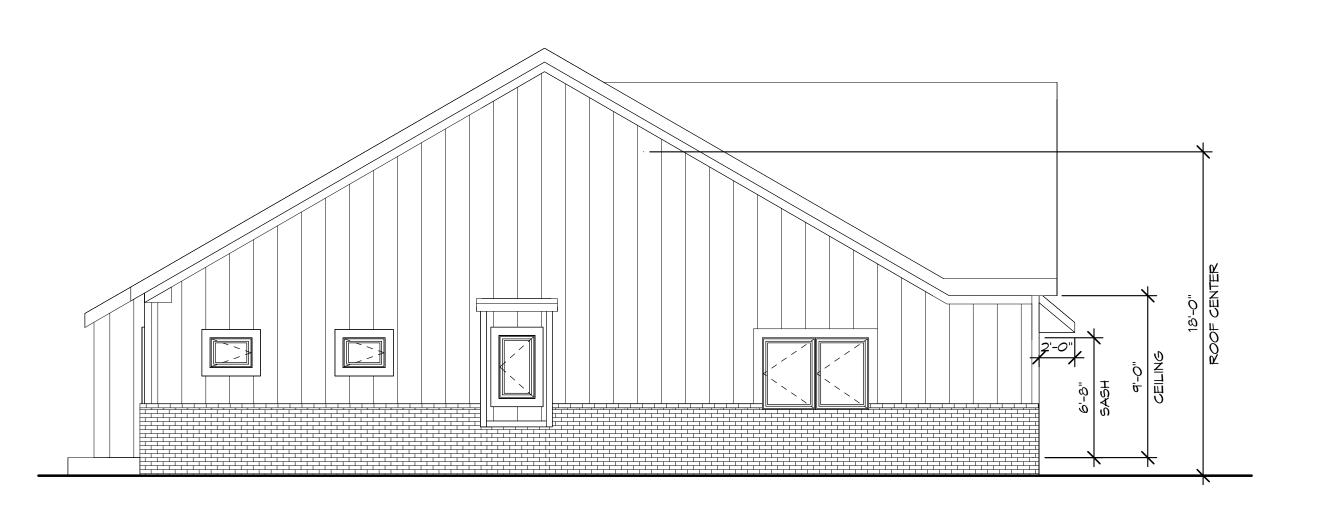





Moiseev/Gordon Associates, Inc. 4351 Delemere Court Royal Oak, MI 48073

248.549.4500 voice 248.549.7300 facs.

www.mga-architects.net

Copyright © 2024

© 2024
Moiseev/Gordon Associates, Inc.
Use of these drawings is limited
to the client for the subject project.
Common law copyright is reserved
by the Architect.

Use figured dimensions only. Do not scale the drawings.

Client:

GFA
Development Ranch Unit

Project Title:

VILLAGE OF HASTINGS

Troy, MI

Sheet Title: ELEVATIONS -OPTION A

Project Number: 22312
Drawn By: AJM, JS
Checked By: AJM
Approved By: AJM
Date:06-16-2023

Issued:


Review 08-04-16
Owner's Review 06-16-23
Owner's Review 11-09-23
Site Plan Approval 05-14-24


Sheet Number






5/14/2024 8:57:33 AM

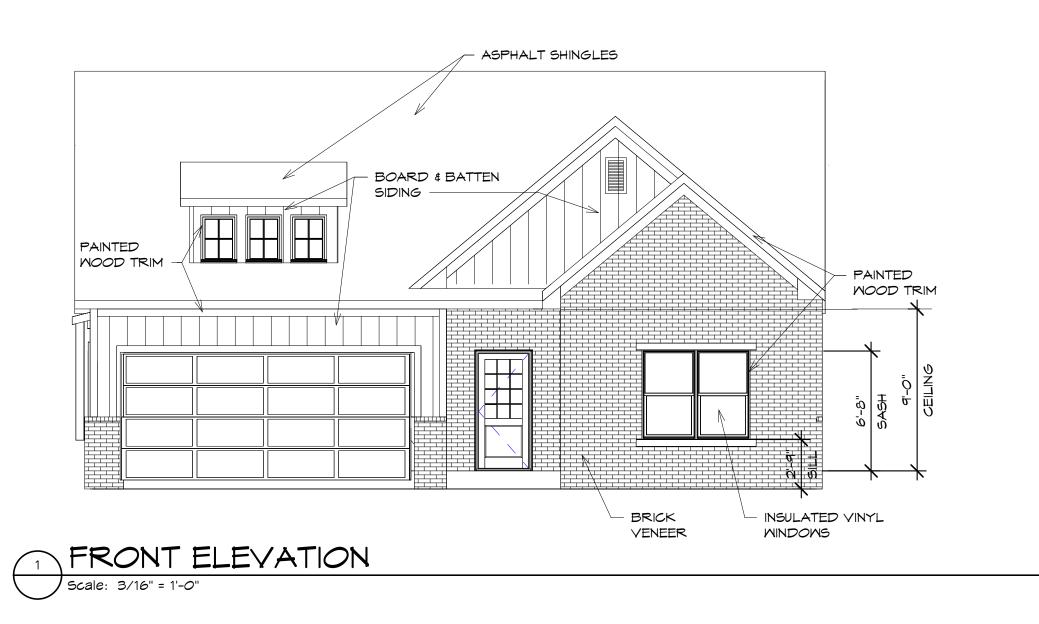

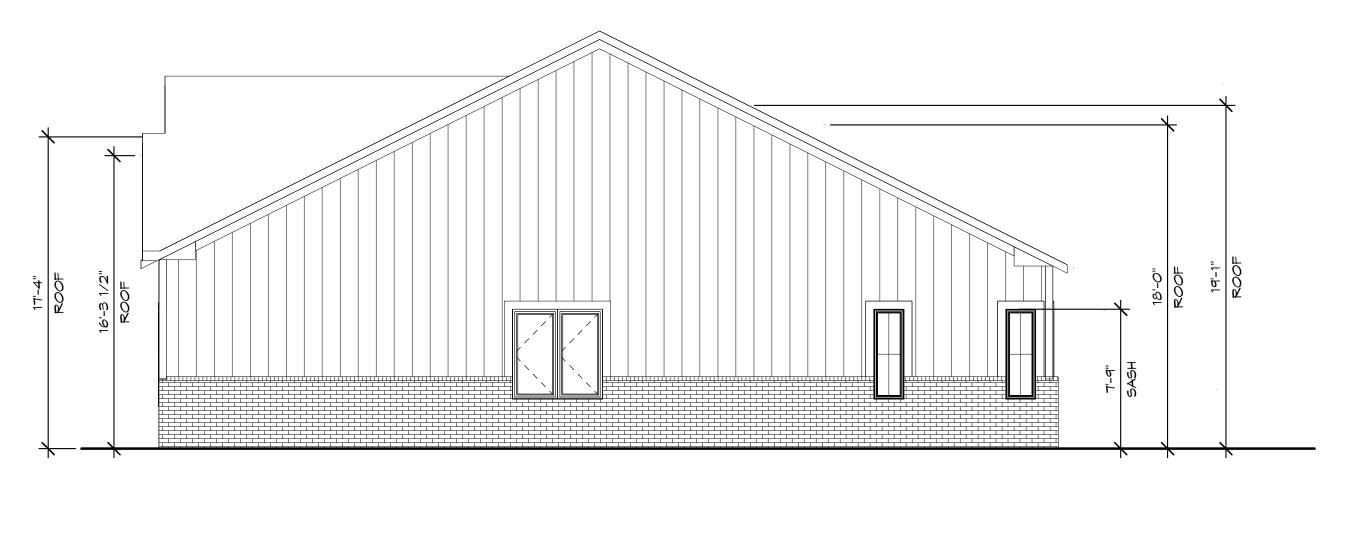


4 RIGHT ELEVATION

Scale: 3/16" = 1'-0"

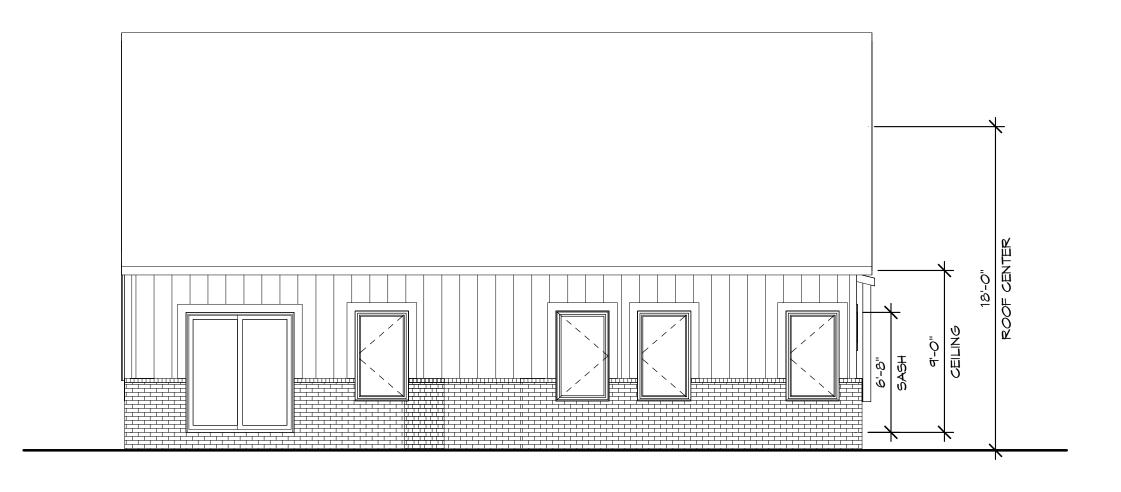

2 REAR ELEVATION

Scale: 3/16" = 1'-0"

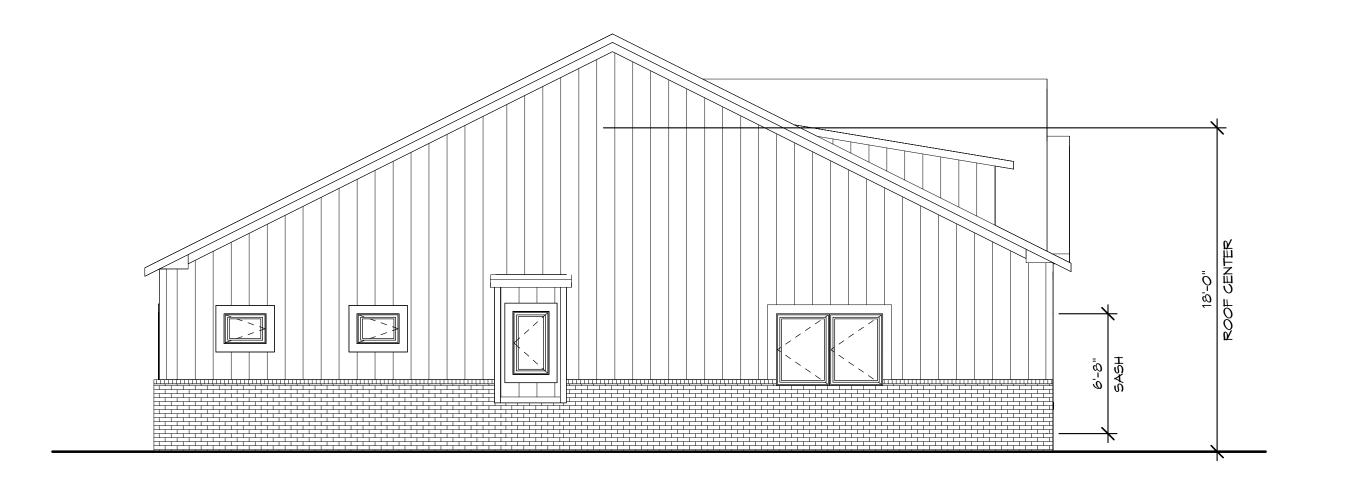

3 LEFT ELEVATION

Scale: 3/16" = 1'-0"



Moiseev/Gordon Associates, Inc. 4351 Delemere Court Royal Oak, MI 48073

248.549.4500 voice 248.549.7300 facs.

www.mga-architects.net

Copyright

© 2024
Moiseev/Gordon Associates, Inc.
Use of these drawings is limited
to the client for the subject project.
Common law copyright is reserved
by the Architect.

Use figured dimensions only. Do not scale the drawings.

Client:

GFA Development -Ranch Unit

Project Title:

VILLAGE OF HASTINGS

Troy, MI


Sheet Title:
ELEVATIONS OPTION B

Project Number: 22312
Drawn By: AJM, JS
Checked By: AJM
Approved By: AJM
Date: 06-16-2023

Issued:
Review 08-04-16
Owner's Review 06-16-23
Owner's Review 11-09-23
Site Plan Approval 04-29-24

Sheet Number:



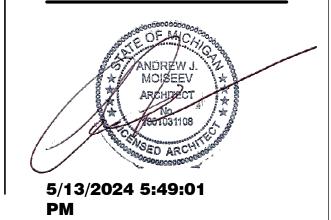











Moiseev/Gordon Associates, Inc. 4351 Delemere Court Royal Oak, MI 48073

248.549.4500 voice 248.549.7300 facs.

www.mga-architects.net

Copyright © 2024

Moiseev/Gordon Associates, Inc.
Use of these drawings is limited
to the client for the subject project.
Common law copyright is reserved
by the Architect.

Use figured dimensions only. Do not scale the drawings.

Client:

GFA Development -Ranch Unit

Project Title:

VILLAGE OF HASTINGS

Troy, MI

Sheet Title: 3D VIEWS -OPTION A

Project Number: 22312
Drawn By: JS
Checked By: AJM
Approved By: AJM
Date:06-16-2023


06-16-23

11-09-23

Issued:

Owner's Review Owner's Review Site Plan Approval 05-14-24



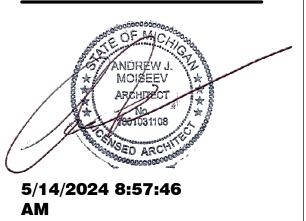





3D VIEW 2



3D VIEW 3



3D VIEW 4

Moiseev/Gordon Associates, Inc. 4351 Delemere Court Royal Oak, MI 48073

248.549.4500 voice 248.549.7300 facs.

www.mga-architects.net

Copyright

Moiseev/Gordon Associates, Inc.
Use of these drawings is limited
to the client for the subject project.
Common law copyright is reserved
by the Architect.

Use figured dimensions only. Do not scale the drawings.

Client:

GFA Development -Ranch Unit

Project Title:

VILLAGE OF **HASTINGS**

Troy, MI

Sheet Title: 3D VIEWS -OPTION B

Project Number: 22312
Drawn By: JS
Checked By: AJM
Approved By: AJM
Date: 06-16-2023

Issued:

Owner's Review 06-16-23 Owner's Review 11-09-23 Site Plan Approval 04-29-24

Sheet Number:





5/13/2024 5:49:14 PM



FIRST FLOOR PLAN

Scale: 1/4" = 1'-0"



Moiseev/Gordon Associates, Inc. 4351 Delemere Court Royal Oak, MI 48073

248.549.4500 voice 248.549.7300 facs.

www.mga-architects.net

Copyright © 2024

© 2024
Moiseev/Gordon Associates, Inc.
Use of these drawings is limited
to the client for the subject project.
Common law copyright is reserved
by the Architect.

Use figured dimensions only. Do not scale the drawings.

Client:

GFA Development - 3 Car Ranch Unit

Project Title:

VILLAGE OF HASTINGS

Troy, MI

Sheet Title: FIRST FLOOR UNIT PLAN


Project Number: 22312
Drawn By: AJM, JS
Checked By: AJM
Approved By: AJM
Date:06-16-2023

Issued:


Owner's Review 06-16-23
Owner's Review 11-09-2023
Site Plan Approval 05-14-24


Sheet Number:


A100

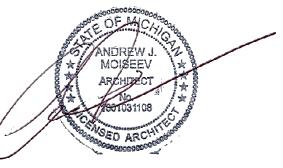

5/14/2024 8:59:30 AM

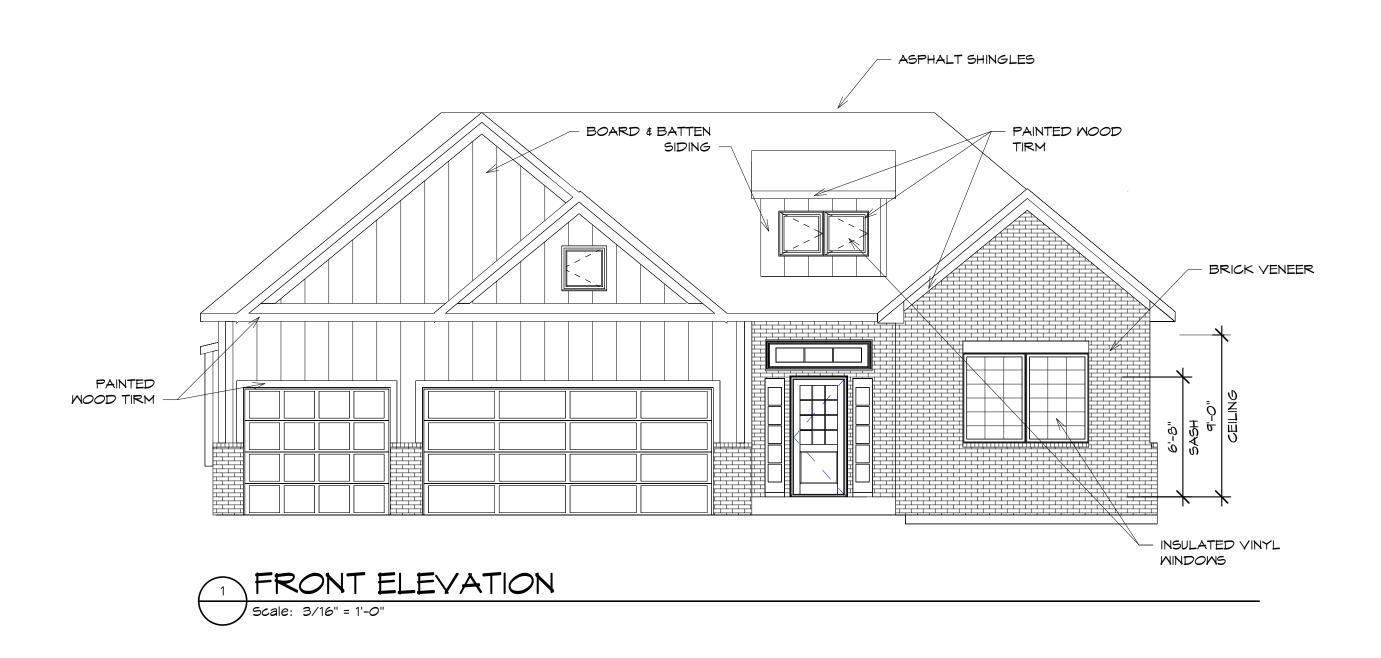

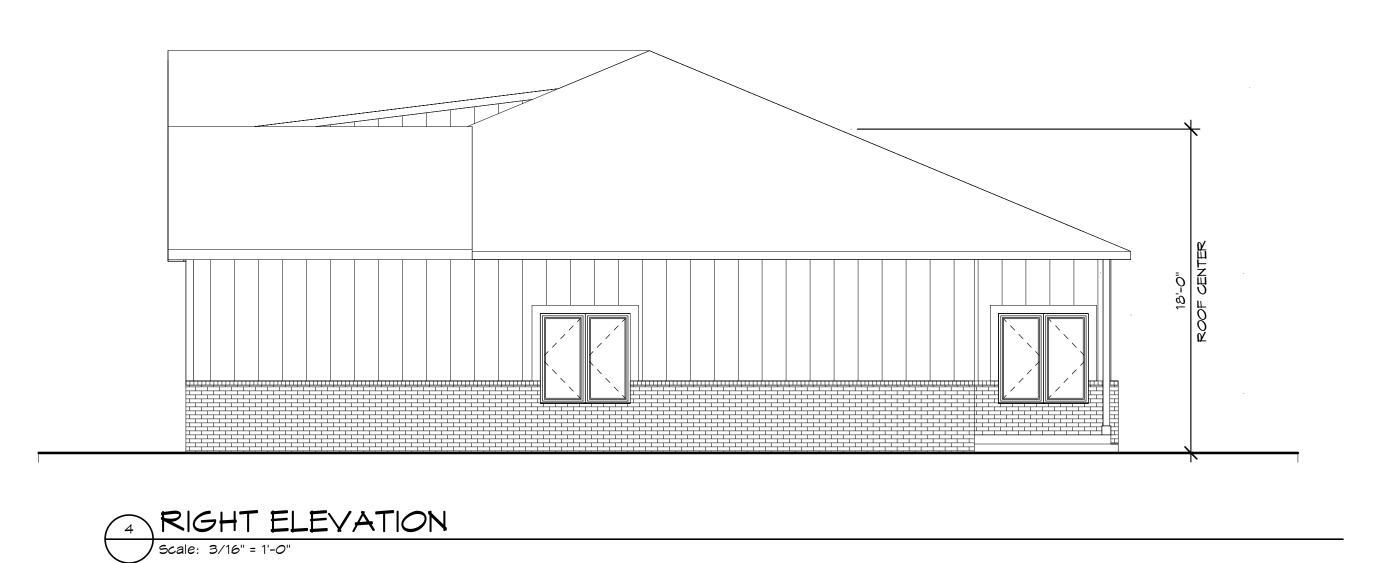

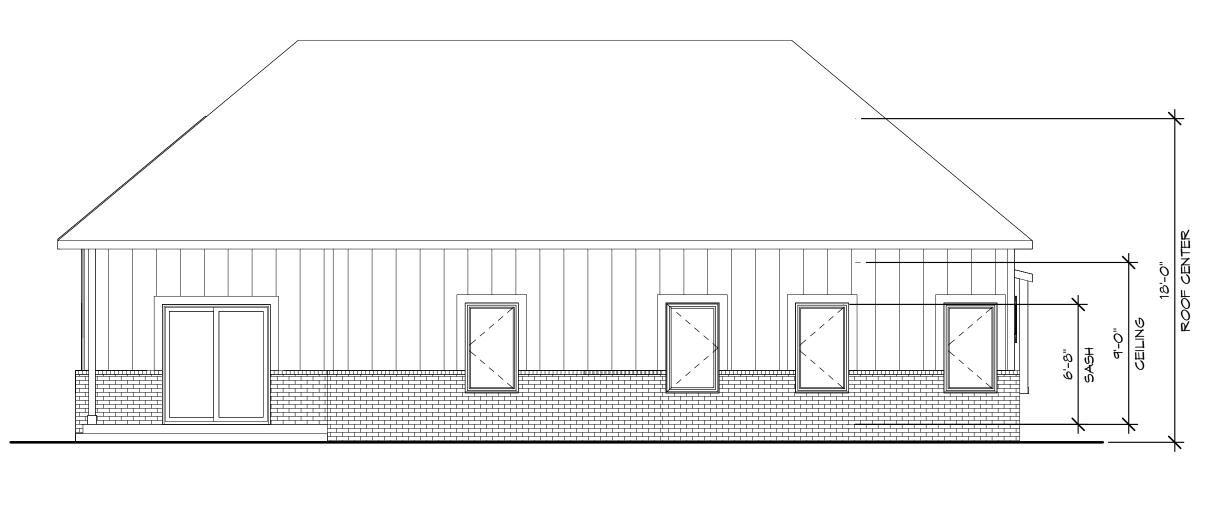



2 REAR ELEVATION

Scale: 3/16" = 1'-0"

Scale: 3/16" = 1'-0"



Moiseev/Gordon Associates, Inc. 4351 Delemere Court Royal Oak, MI 48073

248.549.4500 voice 248.549.7300 facs.

www.mga-architects.net

Copyright © 2024

Moiseev/Gordon Associates, Inc.
Use of these drawings is limited
to the client for the subject project.
Common law copyright is reserved
by the Architect.

Use figured dimensions only. Do not scale the drawings.

Client:

GFA Development - 3

Car Ranch Unit

Project Title:

VILLAGE OF **HASTINGS**

Troy, MI

Sheet Title: ELEVATIONS

Project Number: 22312
Drawn By: AJM, JS
Checked By: AJM
Approved By: AJM
Date:06-16-2023


08-04-16 06-16-23

11-09-2023

Issued: Review

Owner's Review Owner's Review Site Plan Approval 05-14-24



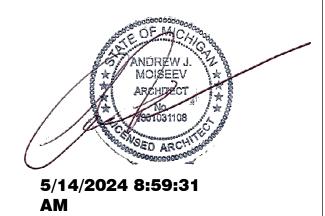









RANCH UNIT -3 CAR GARAGE



Moiseev/Gordon Associates, Inc. 4351 Delemere Court Royal Oak, MI 48073

248.549.4500 voice 248.549.7300 facs.

www.mga-architects.net

Copyright © 2024

Moiseev/Gordon Associates, Inc.
Use of these drawings is limited
to the client for the subject project.
Common law copyright is reserved
by the Architect.

Use figured dimensions only. Do not scale the drawings.

Client:

GFA
Development - 3
Car Ranch Unit

Project Title:

VILLAGE OF HASTINGS

Troy, MI

Sheet Title: 3D VIEWS

Project Number: 22312
Drawn By: J\$
Checked By: AJM
Approved By: AJM
Date:06-16-2023

Issued:

Owner's Review 06-16-23
Owner's Review 11-09-2023
Site Plan Approval 05-14-24


Sheet Number





5/14/2024 8:59:44



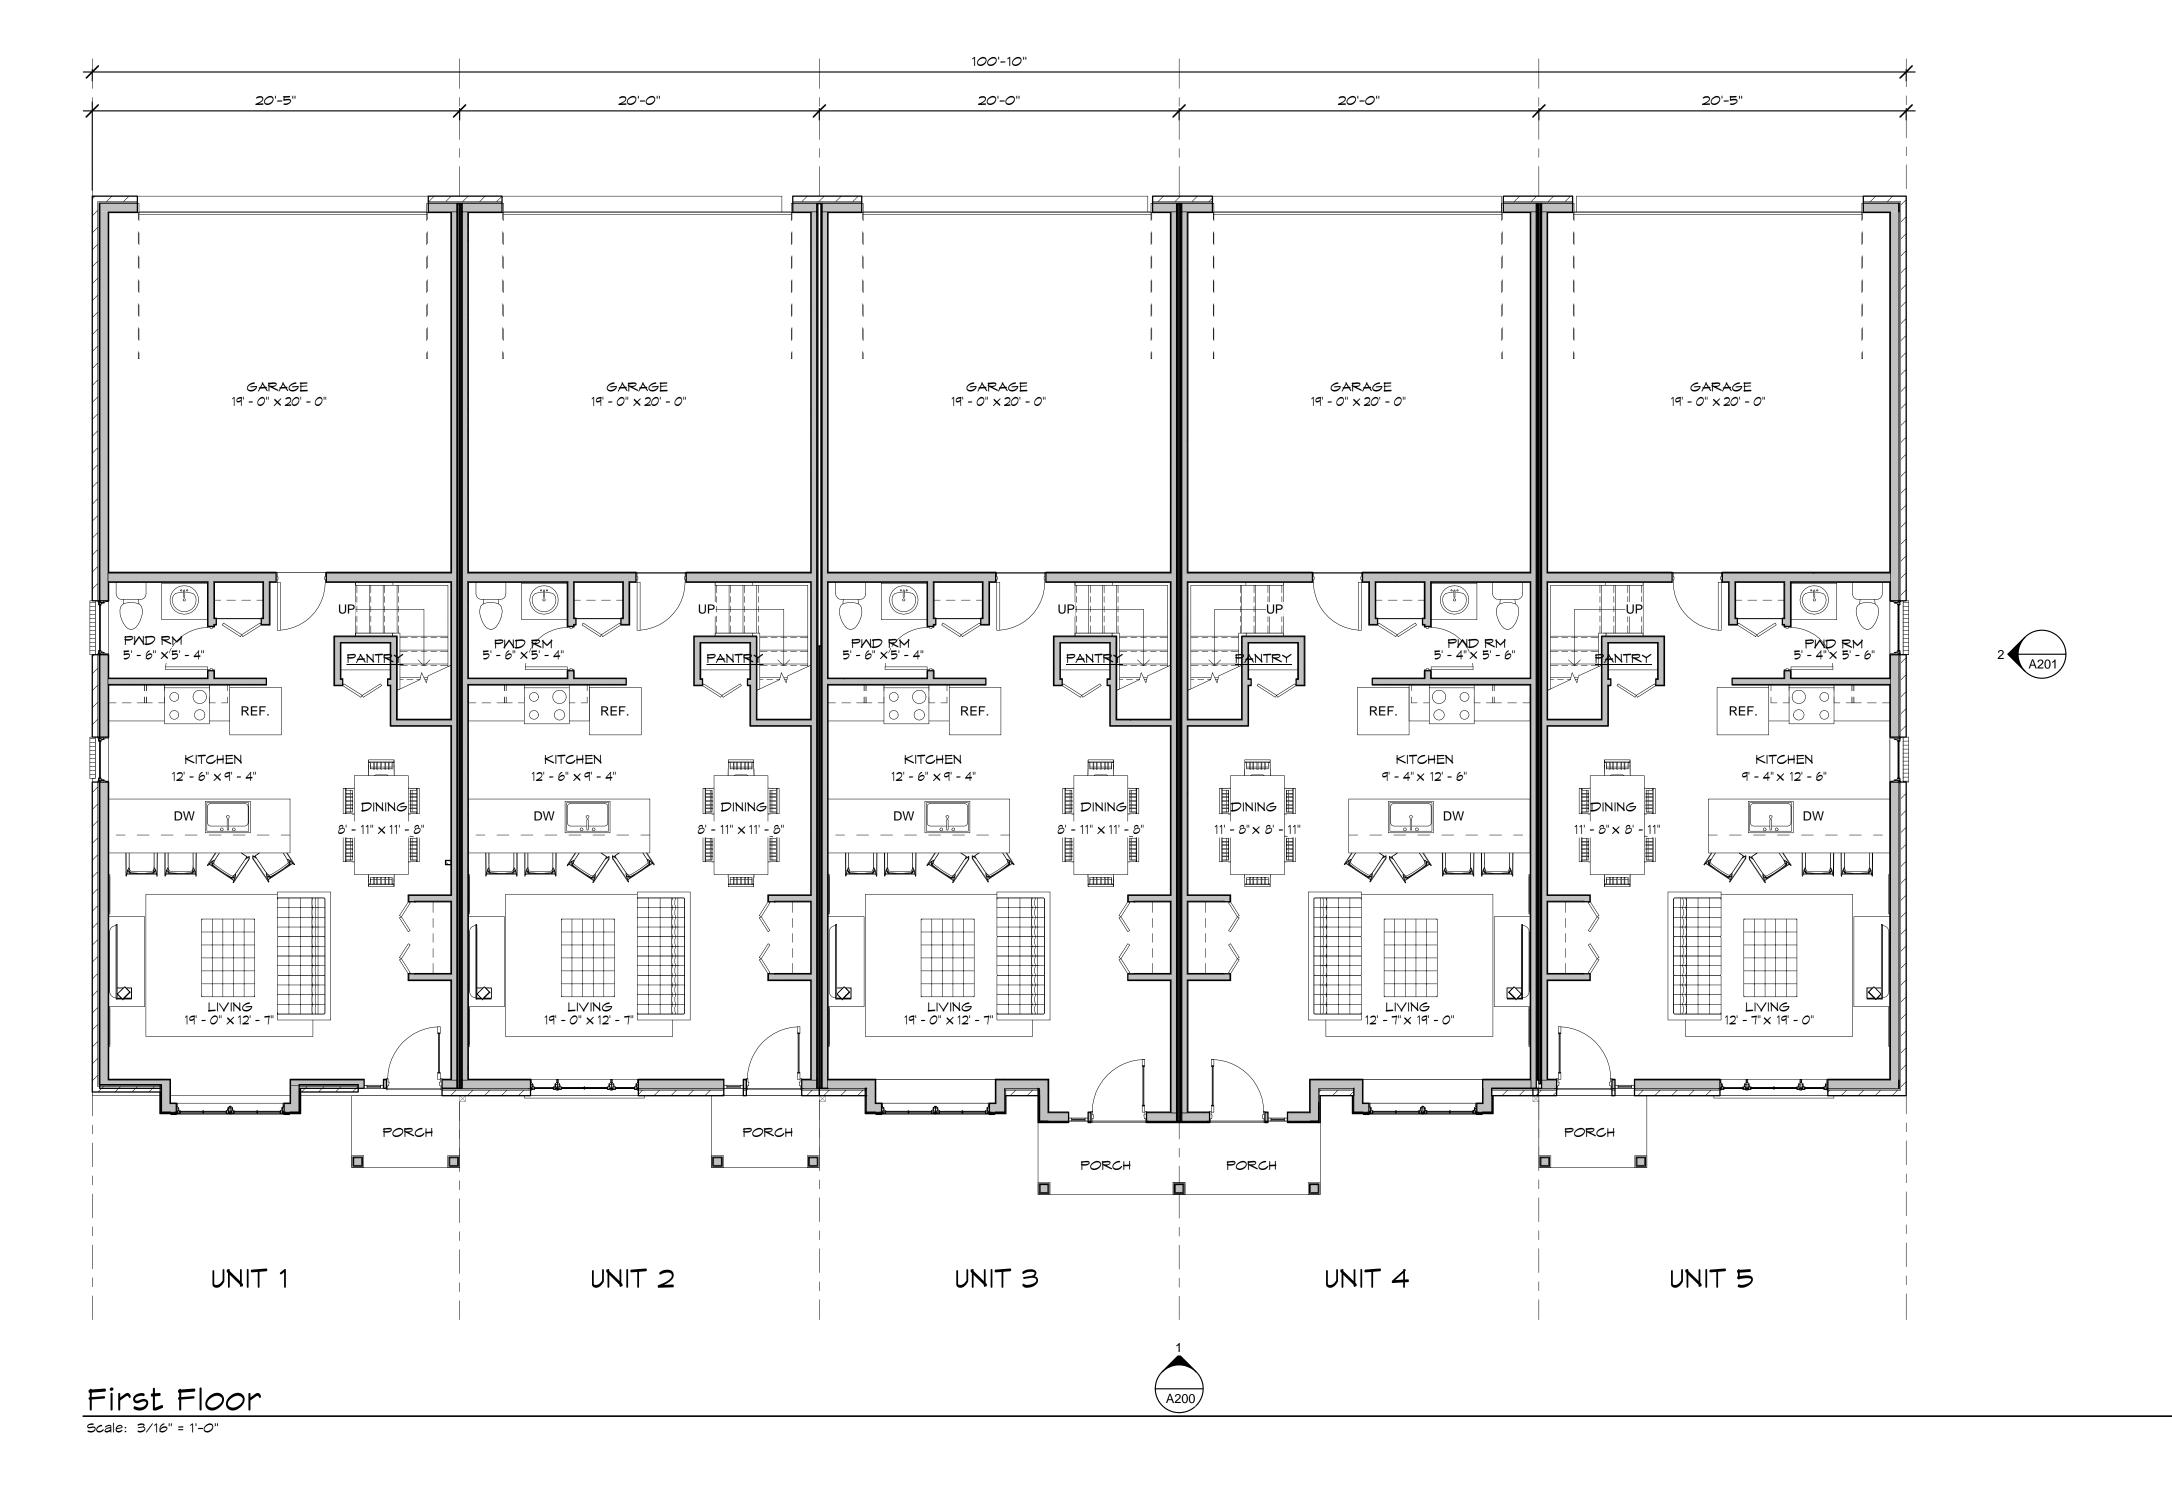

A201



Moiseev/Gordon Associates, Inc. 4351 Delemere Court Royal Oak, MI 48073

248.549.4500 voice 248.549.7300 facs.

www.mga-architects.net

Copyright © 2024

© 2024
Moiseev/Gordon Associates, Inc.
Use of these drawings is limited
to the client for the subject project.
Common law copyright is reserved
by the Architect.

Use figured dimensions only. Do not scale the drawings.

Client:

5 UNIT TOWNHOUSE

Project Title:

The Village of Hastings

Troy, MI

Sheet Title: FIRST FLOOR UNIT PLANS

Project Number: 22312
Drawn By: AJM, JS
Checked By: AJM
Approved By: AJM
Date: 11-03-23

Issued:


Owner's Review 06-29-23
Site Plan Approval 4-30-24

Sheet Number:

A101



4/29/2024 2:15:29 PM

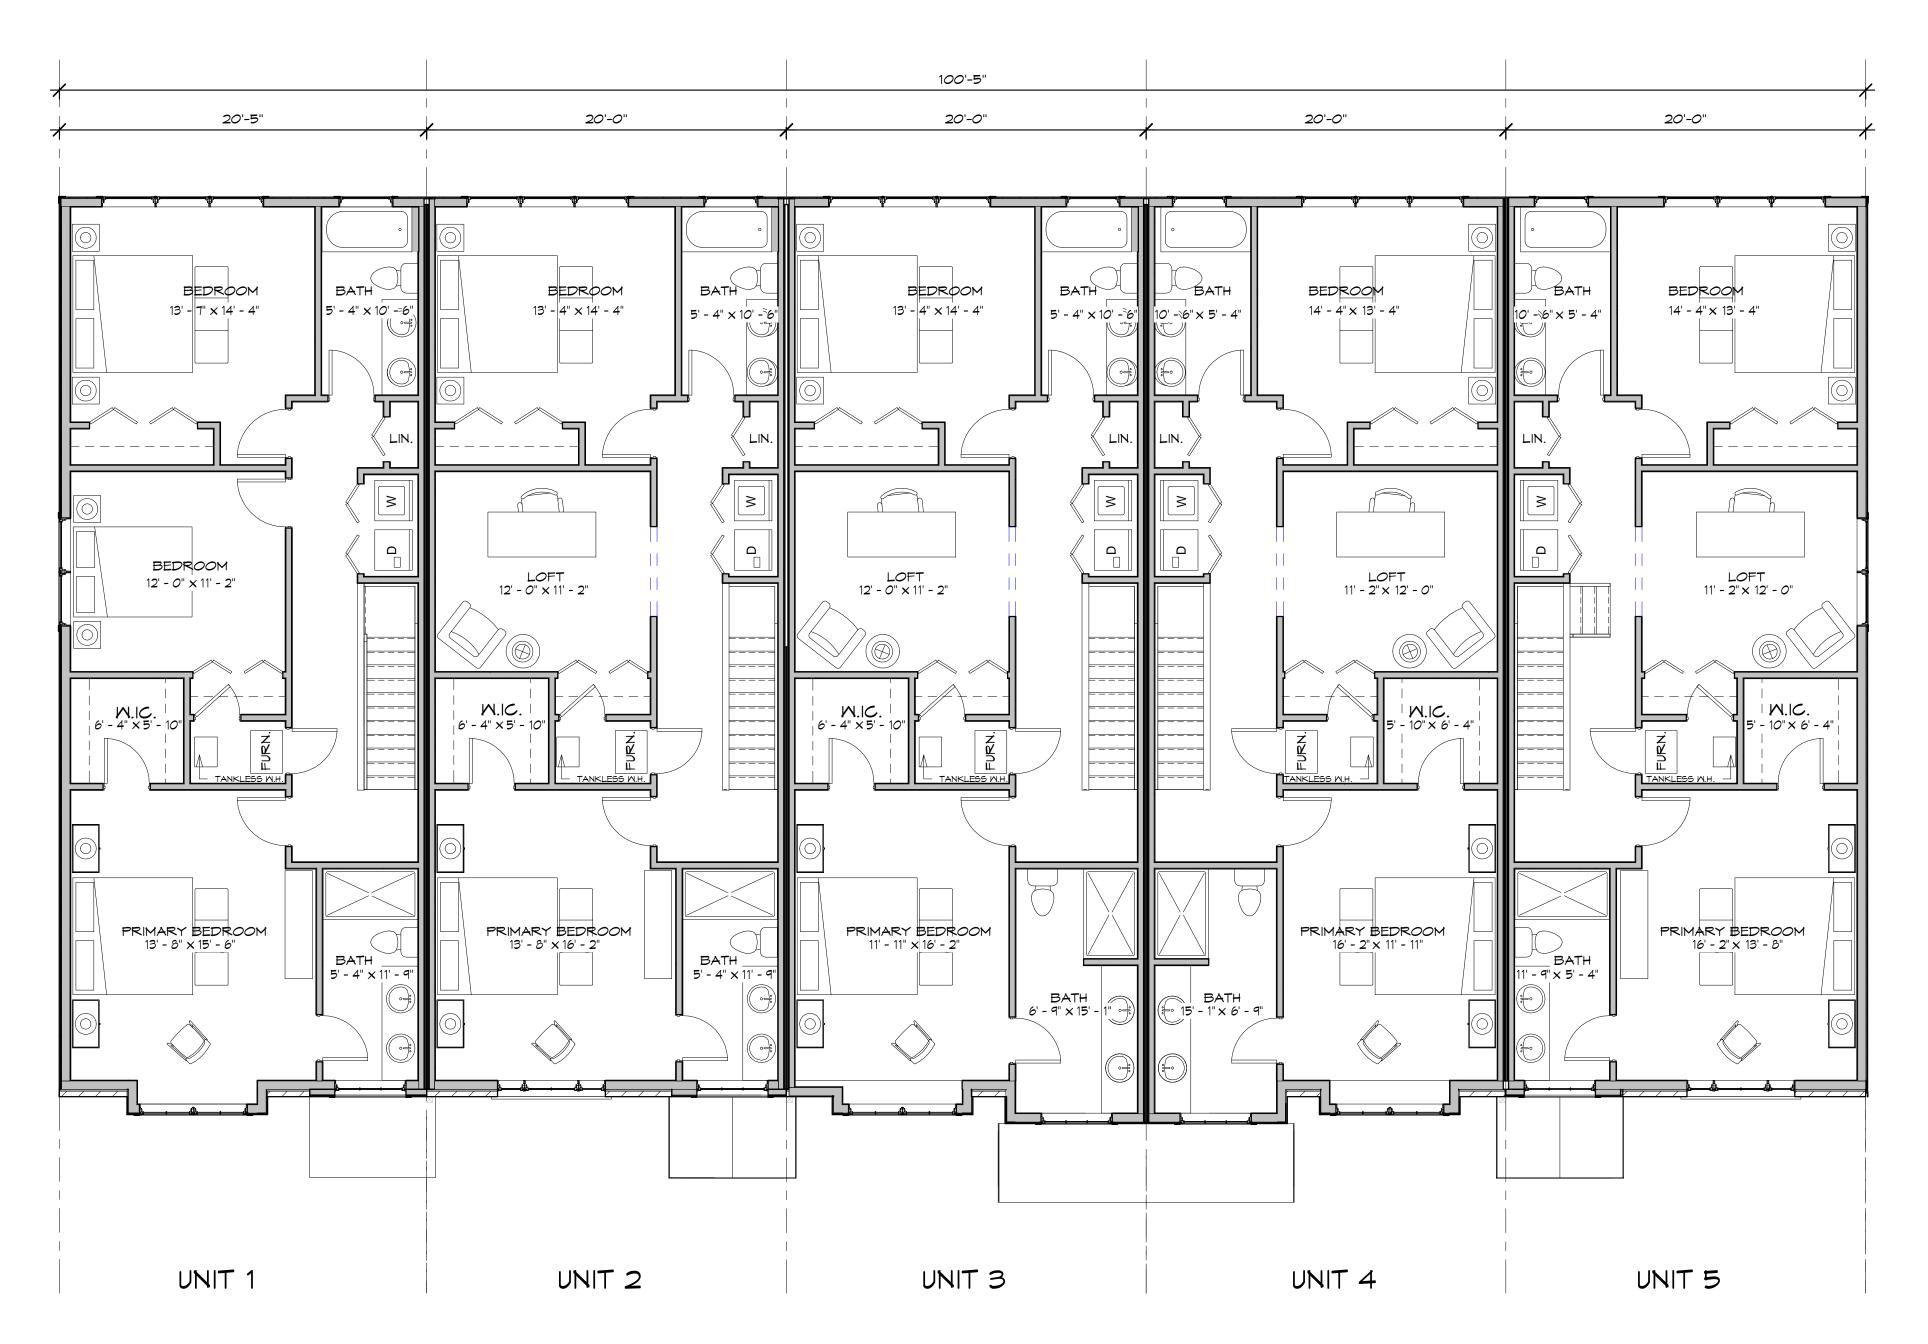

Second Floor

Scale: 3/16" = 1'-0"



Moiseev/Gordon Associates, Inc. 4351 Delemere Court Royal Oak, MI 48073

248.549.4500 voice 248.549.7300 facs.

www.mga-architects.net

Copyright © 2024

Moiseev/Gordon Associates, Inc.
Use of these drawings is limited
to the client for the subject project.
Common law copyright is reserved
by the Architect.

Use figured dimensions only. Do not scale the drawings.

Client:

5 UNIT TOWNHOUSE

Project Title: The Village of Hastings

Troy, MI

Sheet Title: STANDARD SECOND FLOOR UNIT PLANS

Project Number: 22312
Drawn By: AJM, JS
Checked By: AJM
Approved By: AJM
Date: 11-03-23

06-29-23

Issued:

Owner's Review Site Plan Approval 4-30-24

Sheet Number:






4/29/2024 2:15:32 PM





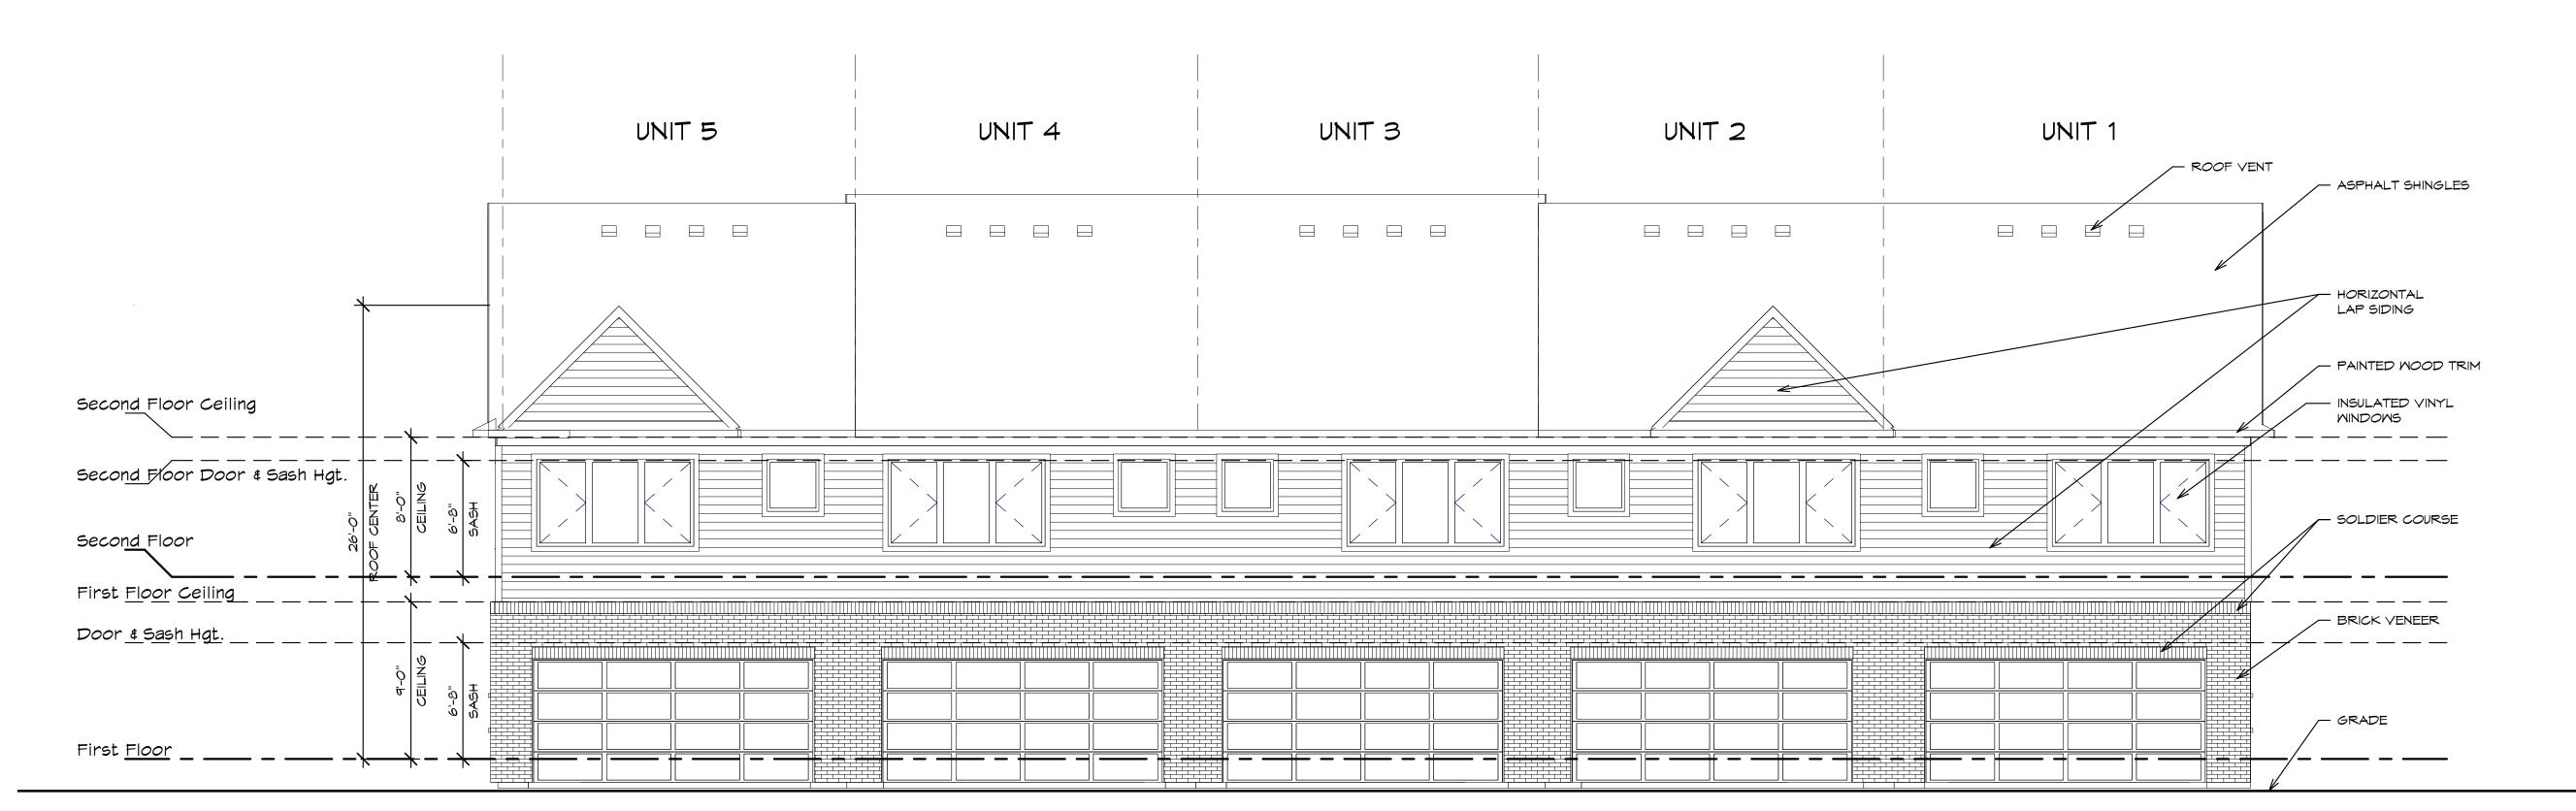

NORTH ELEVATION

A101 Scale: 3/16" = 1'-0"



Moiseev/Gordon Associates, Inc. 4351 Delemere Court Royal Oak, MI 48073

248.549.4500 voice 248.549.7300 facs.

www.mga-architects.net

Copyright © 2024

Moiseev/Gordon Associates, Inc.
Use of these drawings is limited
to the client for the subject project.
Common law copyright is reserved
by the Architect.

Use figured dimensions only. Do not scale the drawings.

Client:

5 UNIT TOWNHOUSE

Project Title:

The Village of Hastings

Troy, MI

Sheet Title: STANDARD NORTH & SOUTH ELEVATION

Project Number: 22312
Drawn By: AJM, JH
Checked By: AJM
Approved By: AJM
Date: 11-03-23

08-04-16


06-29-23


Issued: Review

Owner's Review Site Plan Approval 4-30-24


Sheet Number:



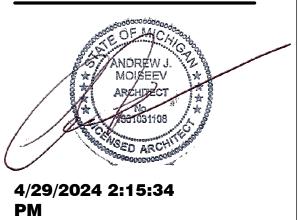

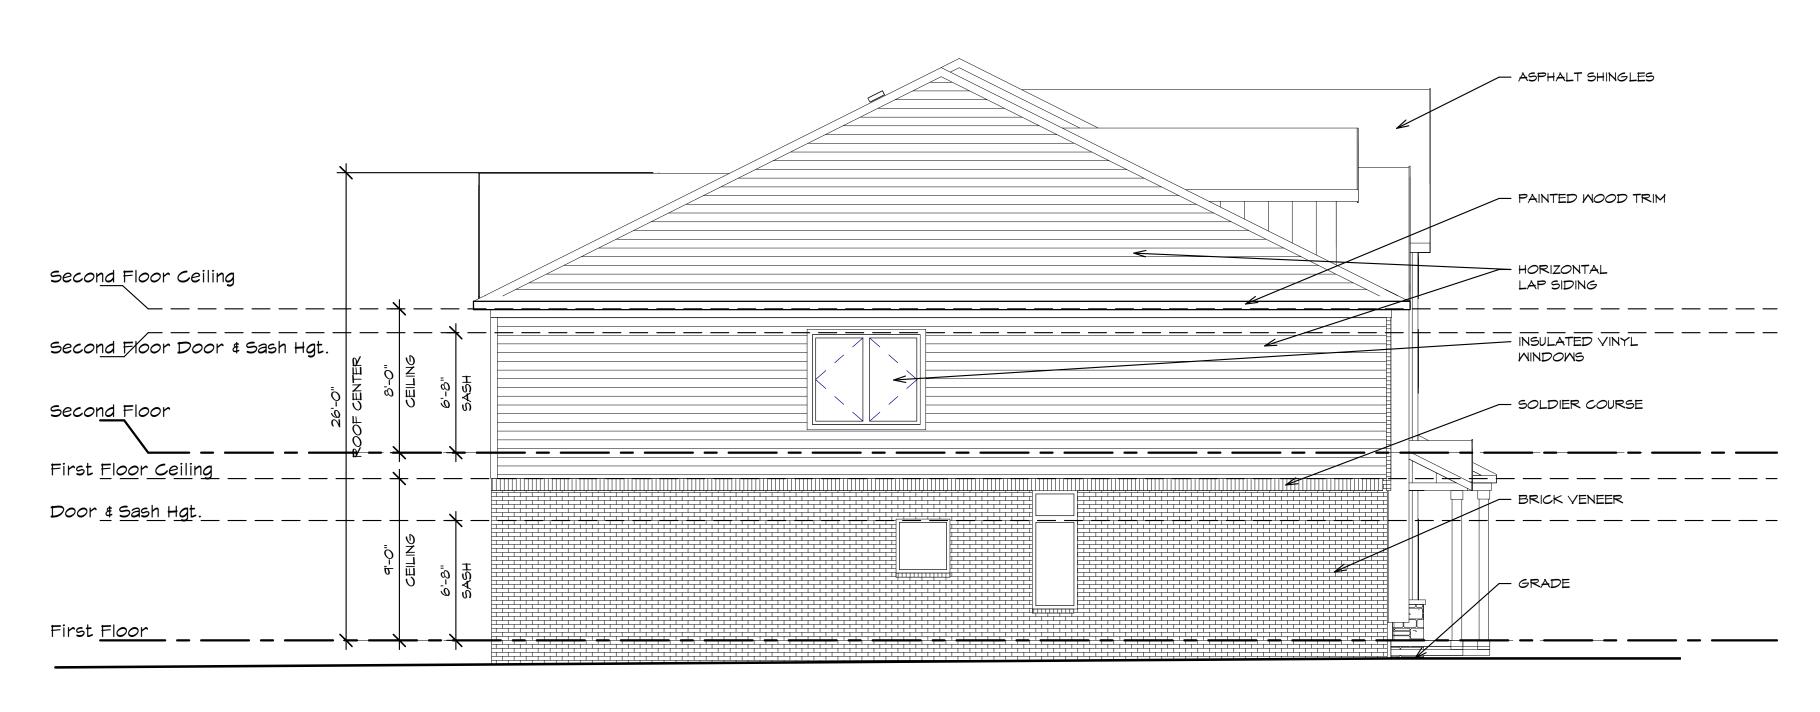

NEST ELEVATION
A101 Scale: 3/16" = 1'-0"

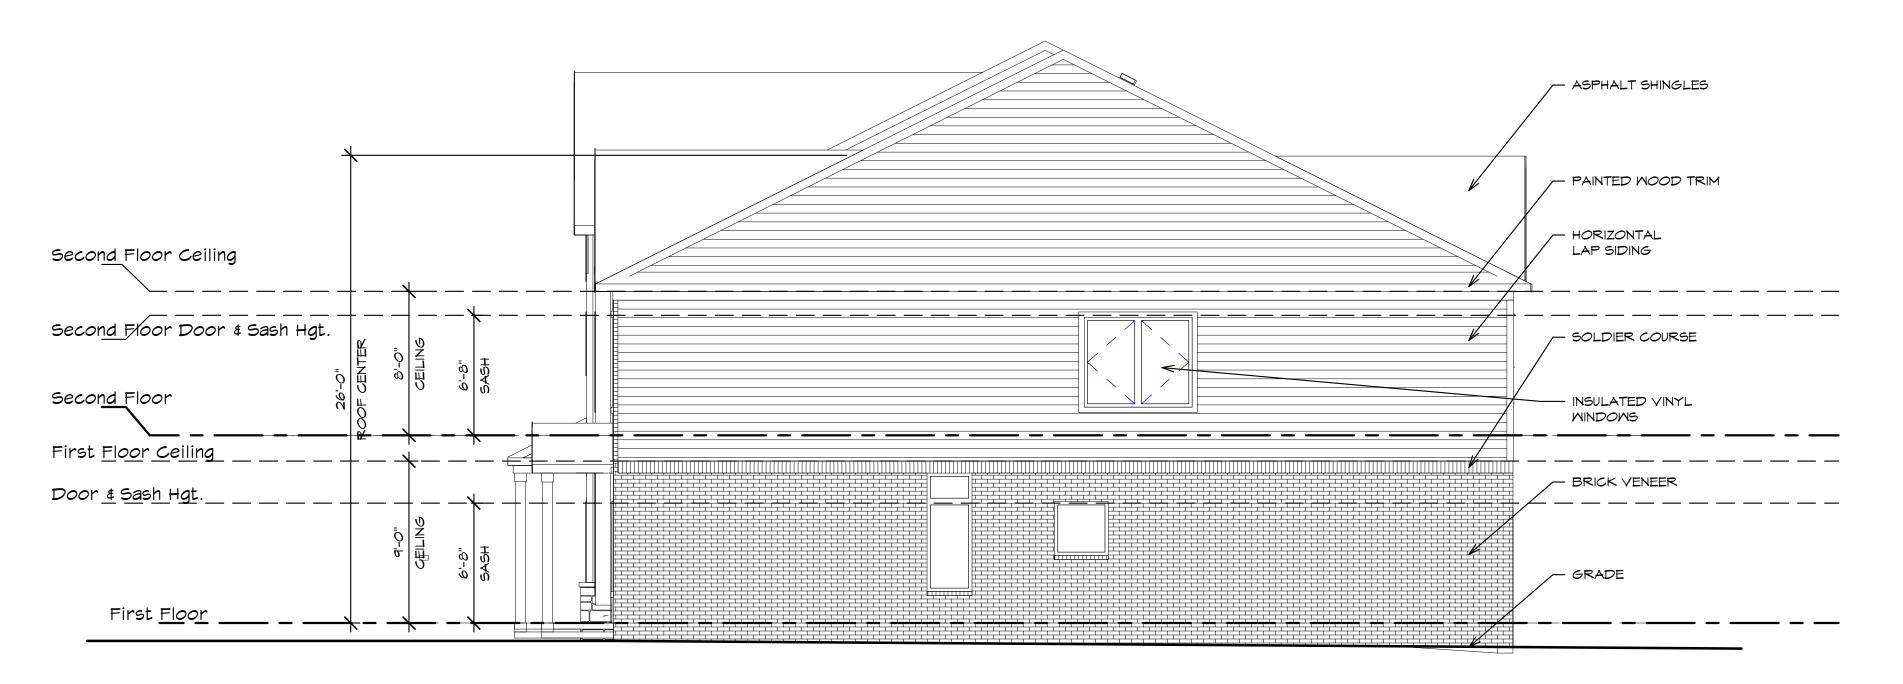

2 EAST ELEVATION
A101 Scale: 3/16" = 1'-0"



Moiseev/Gordon Associates, Inc. 4351 Delemere Court Royal Oak, MI 48073

248.549.4500 voice 248.549.7300 facs.

www.mga-architects.net

Copyright © 2024

Moiseev/Gordon Associates, Inc.
Use of these drawings is limited
to the client for the subject project.
Common law copyright is reserved
by the Architect.

Use figured dimensions only. Do not scale the drawings.

Client:

5 UNIT TOWNHOUSE

Project Title:
The Village of
Hastings

Troy, MI

Sheet Title: STANDARD EAST & MEST ELEVATION

Project Number: 22312
Drawn By: AJM,JS
Checked By: JS
Approved By: JS
Date: 11-03-23

06-29-23

Issued:

Owner's Review Site Plan Approval 4-30-24

Sheet Number:



4/29/2024 2:15:37 PM







Moiseev/Gordon Associates, Inc. 4351 Delemere Court Royal Oak, MI 48073

248.549.4500 voice 248.549.7300 facs.

www.mga-architects.net

Copyright © 2024

Moiseev/Gordon Associates, Inc.
Use of these drawings is limited
to the client for the subject project.
Common law copyright is reserved
by the Architect.

Use figured dimensions only. Do not scale the drawings.

Client:

5 UNIT TOWNHOUSE

Project Title:

The Village of Hastings

Troy, MI


Sheet Title: STANDARD AXONMETRIC VIEWS

Project Number: 22312
Drawn By: Author
Checked By: Checker
Approved By: Approver
Date: 11-03-23

Issued:Site Plan Approval 4-30-24

Sheet Number:



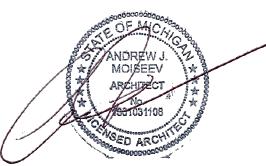

4/29/2024 2:15:41 PM



Architects/Designers

Moiseev/Gordon Associates, Inc. 4351 Delemere Court Royal Oak, MI 48073

248.549.4500 voice 248.549.7300 facs.

www.mga-architects.net

Copyright

Moiseev/Gordon Associates, Inc.
Use of these drawings is limited
to the client for the subject project.
Common law copyright is reserved
by the Architect.

Use figured dimensions only. Do not scale the drawings.

Client:

GFA Development -Ranch Duplex

Project Title:

VILLAGE OF HASTINGS

Troy, MI

Sheet Title:

FIRST FLOOR UNIT PLAN

Project Number: 22312
Drawn By: AJM, JS
Checked By: AJM
Approved By: AJM
Date: 06-16-2023

Issued: Owner's Review

Owner's Review 06-16-23
Owner's Review 11-09-2023


Sheet Number:


A100




FIRST FLOOR PLAN


Scale: 3/8" = 1'-0"

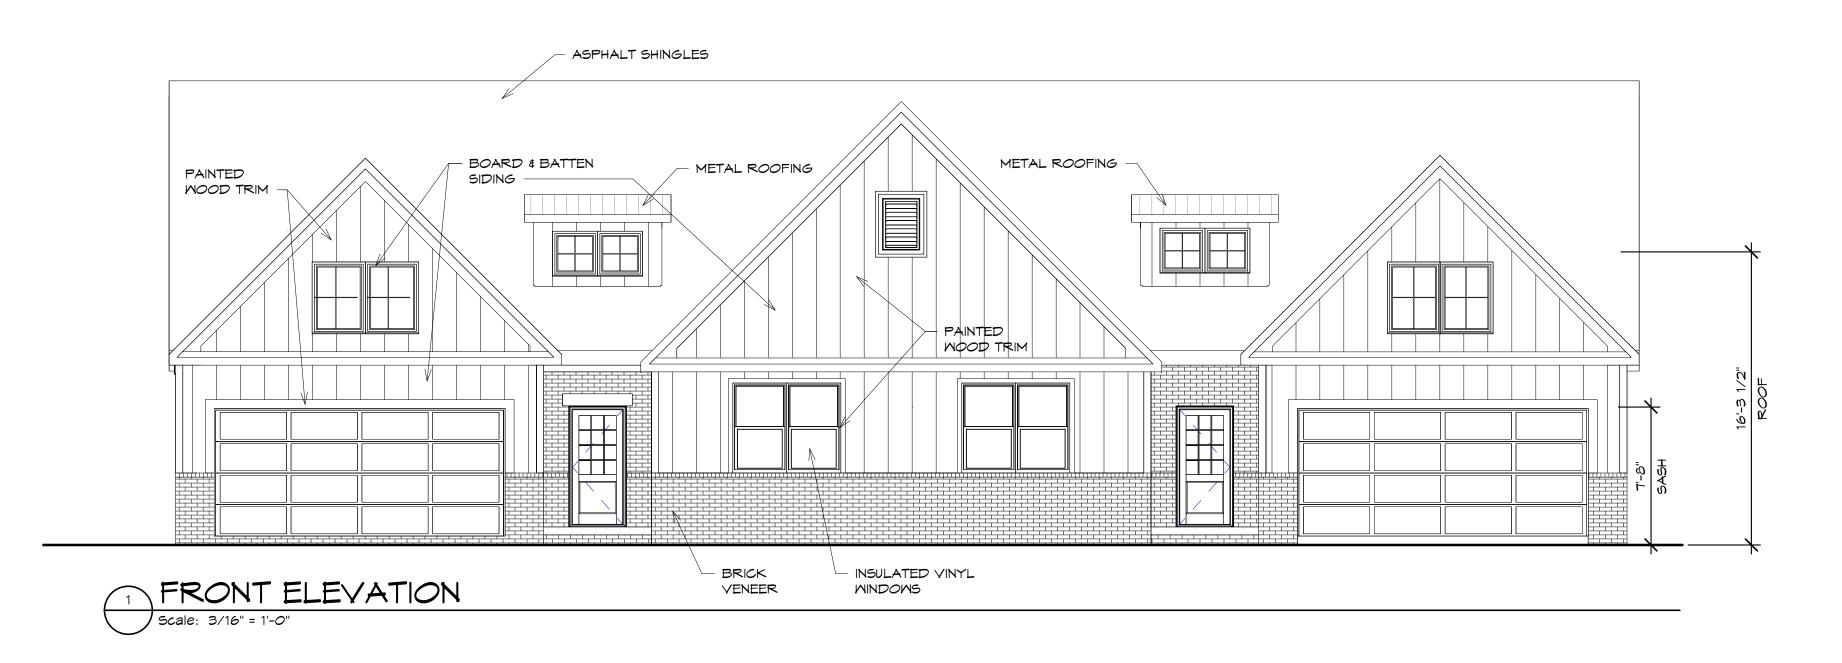

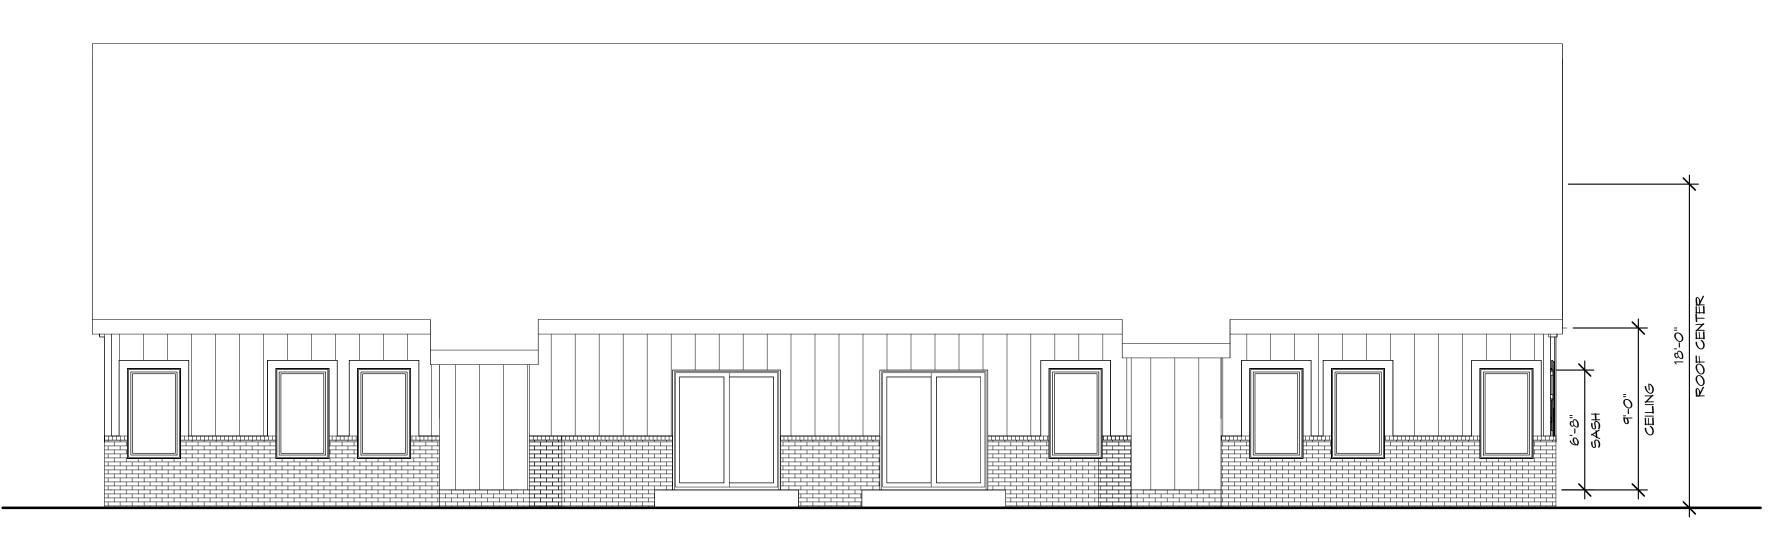



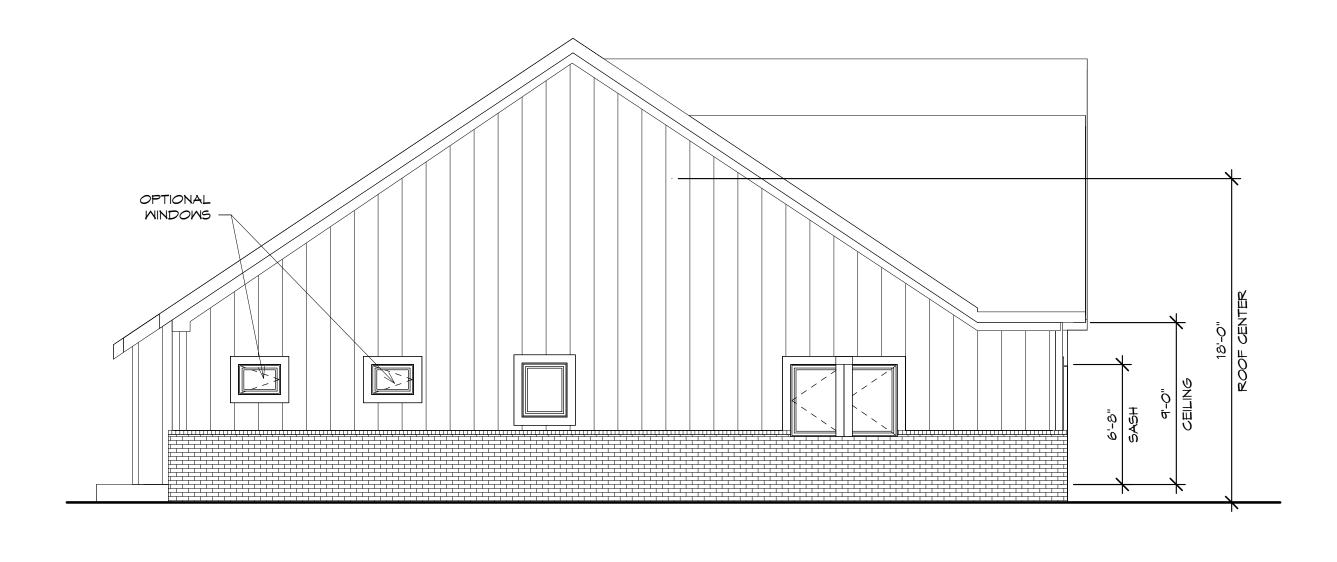

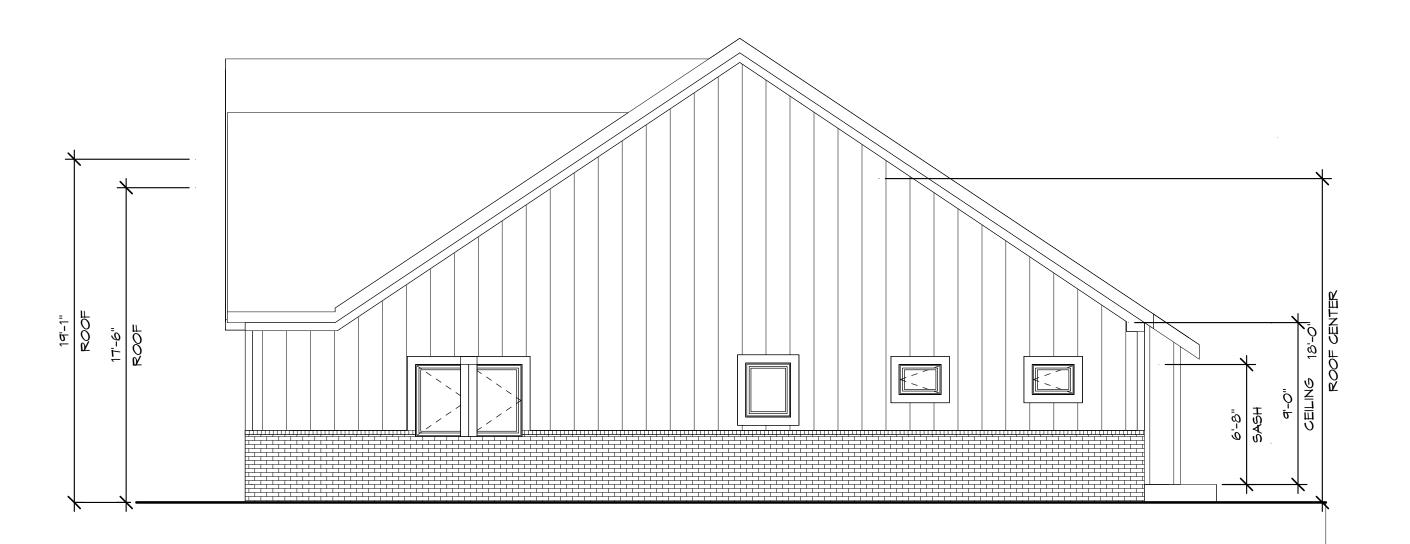







Moiseev/Gordon Associates, Inc. 4351 Delemere Court Royal Oak, MI 48073

248.549.4500 voice 248.549.7300 facs.

www.mga-architects.net

Copyright

Moiseev/Gordon Associates, Inc.
Use of these drawings is limited
to the client for the subject project.
Common law copyright is reserved
by the Architect.

Use figured dimensions only. Do not scale the drawings.

Client:

GFA Development -Ranch Duplex

Project Title:

VILLAGE OF HASTINGS

Troy, MI

Sheet Title: ELEVATIONS

Project Number: 22312
Drawn By: AJM, JS
Checked By: AJM
Approved By: AJM
Date: 06-16-2023

Issued:


Review Owner's Review Owner's Review SPA Approval

11-09-2023 04-29-2024

08-04-16 06-16-23

Sheet Number:



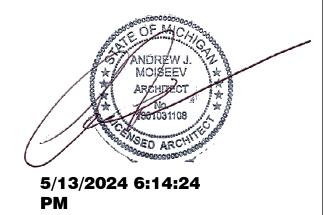







Moiseev/Gordon Associates, Inc. 4351 Delemere Court Royal Oak, MI 48073

248.549.4500 voice 248.549.7300 facs.

www.mga-architects.net

Copyright © 2024

© 2024
Moiseev/Gordon Associates, Inc.
Use of these drawings is limited
to the client for the subject project.
Common law copyright is reserved
by the Architect.

Use figured dimensions only. Do not scale the drawings.

Client:

GFA Development -Ranch Duplex

Project Title:

VILLAGE OF HASTINGS

Troy, MI

Sheet Title:
3D VIENS

Project Number: 22312
Drawn By: JS
Checked By: AJM
Approved By: AJM
Date: 06-16-2023

Issued: Owner's Review


 Owner's Review
 06-16-23

 Owner's Review
 11-09-2023


 SPA Approval
 04-29-2024

Sheet Number:



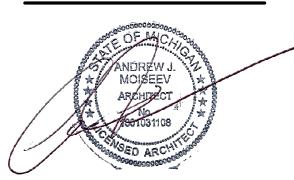

5/13/2024 6:14:34 PM

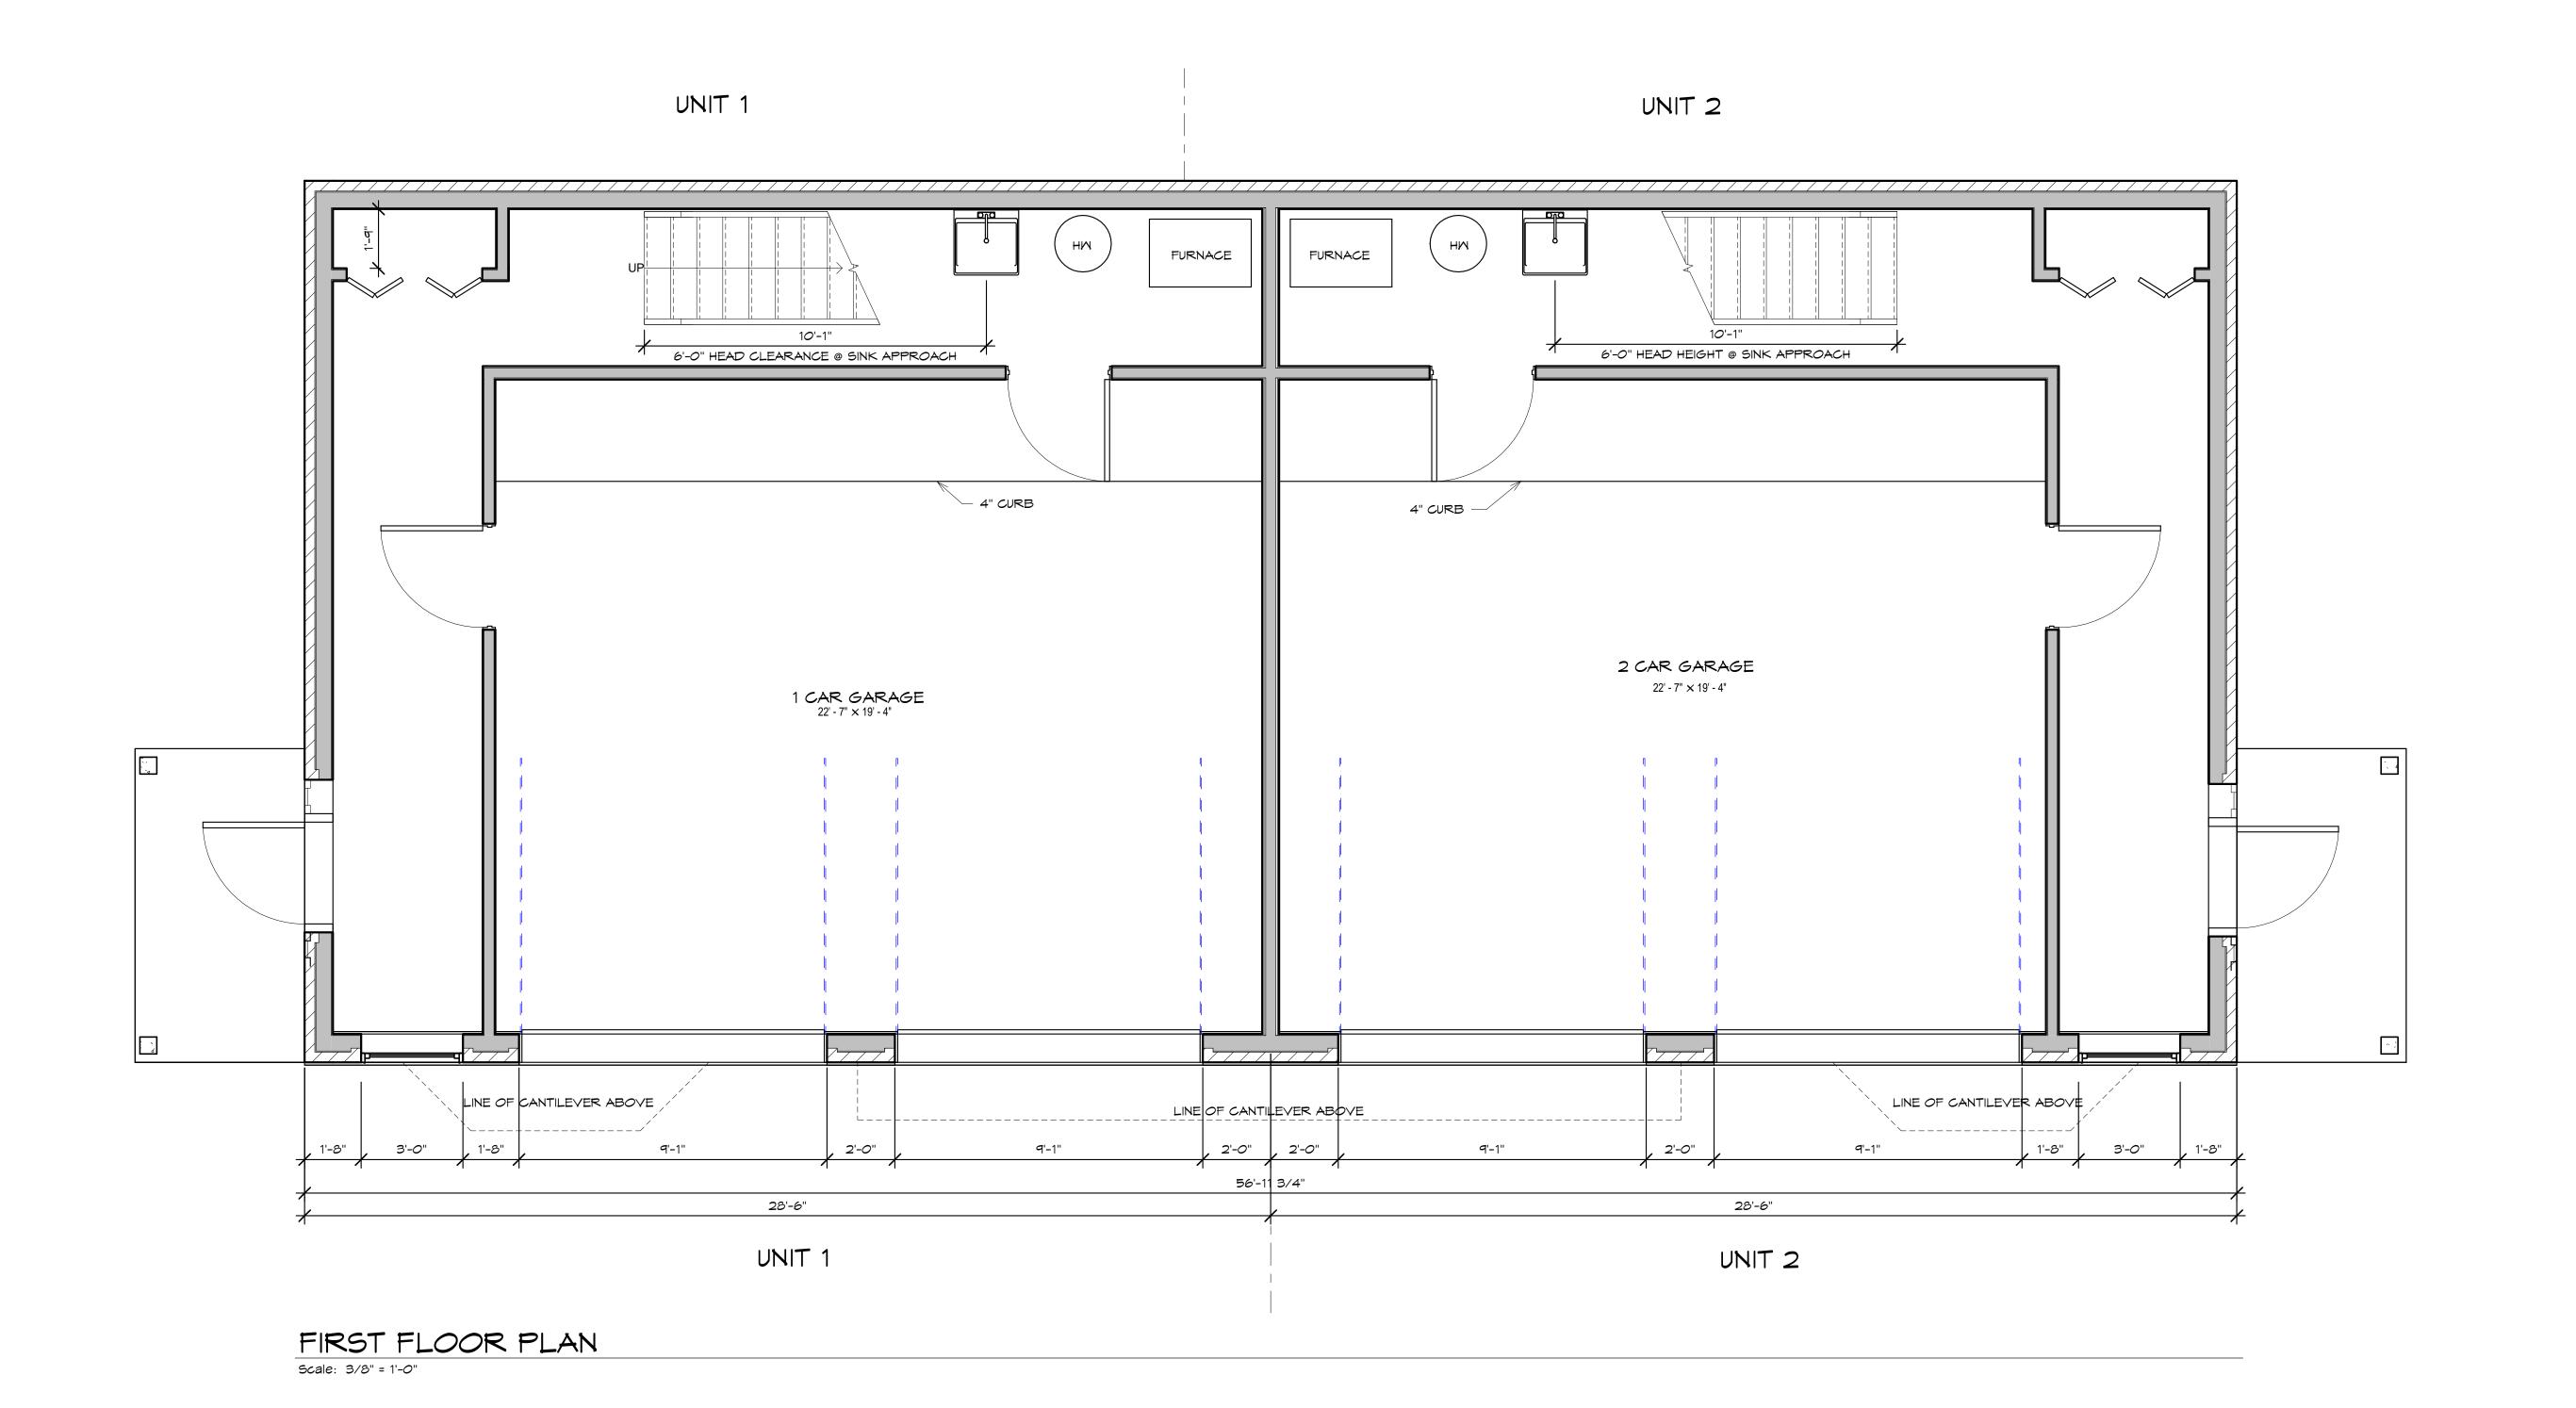

Architects/Designers

Moiseev/Gordon Associates, Inc. 4351 Delemere Court Royal Oak, MI 48073

248.549.4500 voice 248.549.7300 facs.

www.mga-architects.net

Copyright © 2024

© 2024
Moiseev/Gordon Associates, Inc.
Use of these drawings is limited
to the client for the subject project.
Common law copyright is reserved
by the Architect.

Use figured dimensions only. Do not scale the drawings.

Clie

TWO STORY DUPLEX

Project Title:

VILLAGE OF HASTINGS

Troy, MI

Sheet Title:
FIRST FLOOR

PLAN

Project Number: 22312
Drawn By: AJM, JS
Checked By: AJM
Approved By: AJM
Date: 06-16-2023

Issued: Owner's i


Owner's Review 06-16-23
Owner's Review 11-08-23
Site Plan Approval 4-26-2024

Sheet Number:





4/30/2024 4:41:07 PM

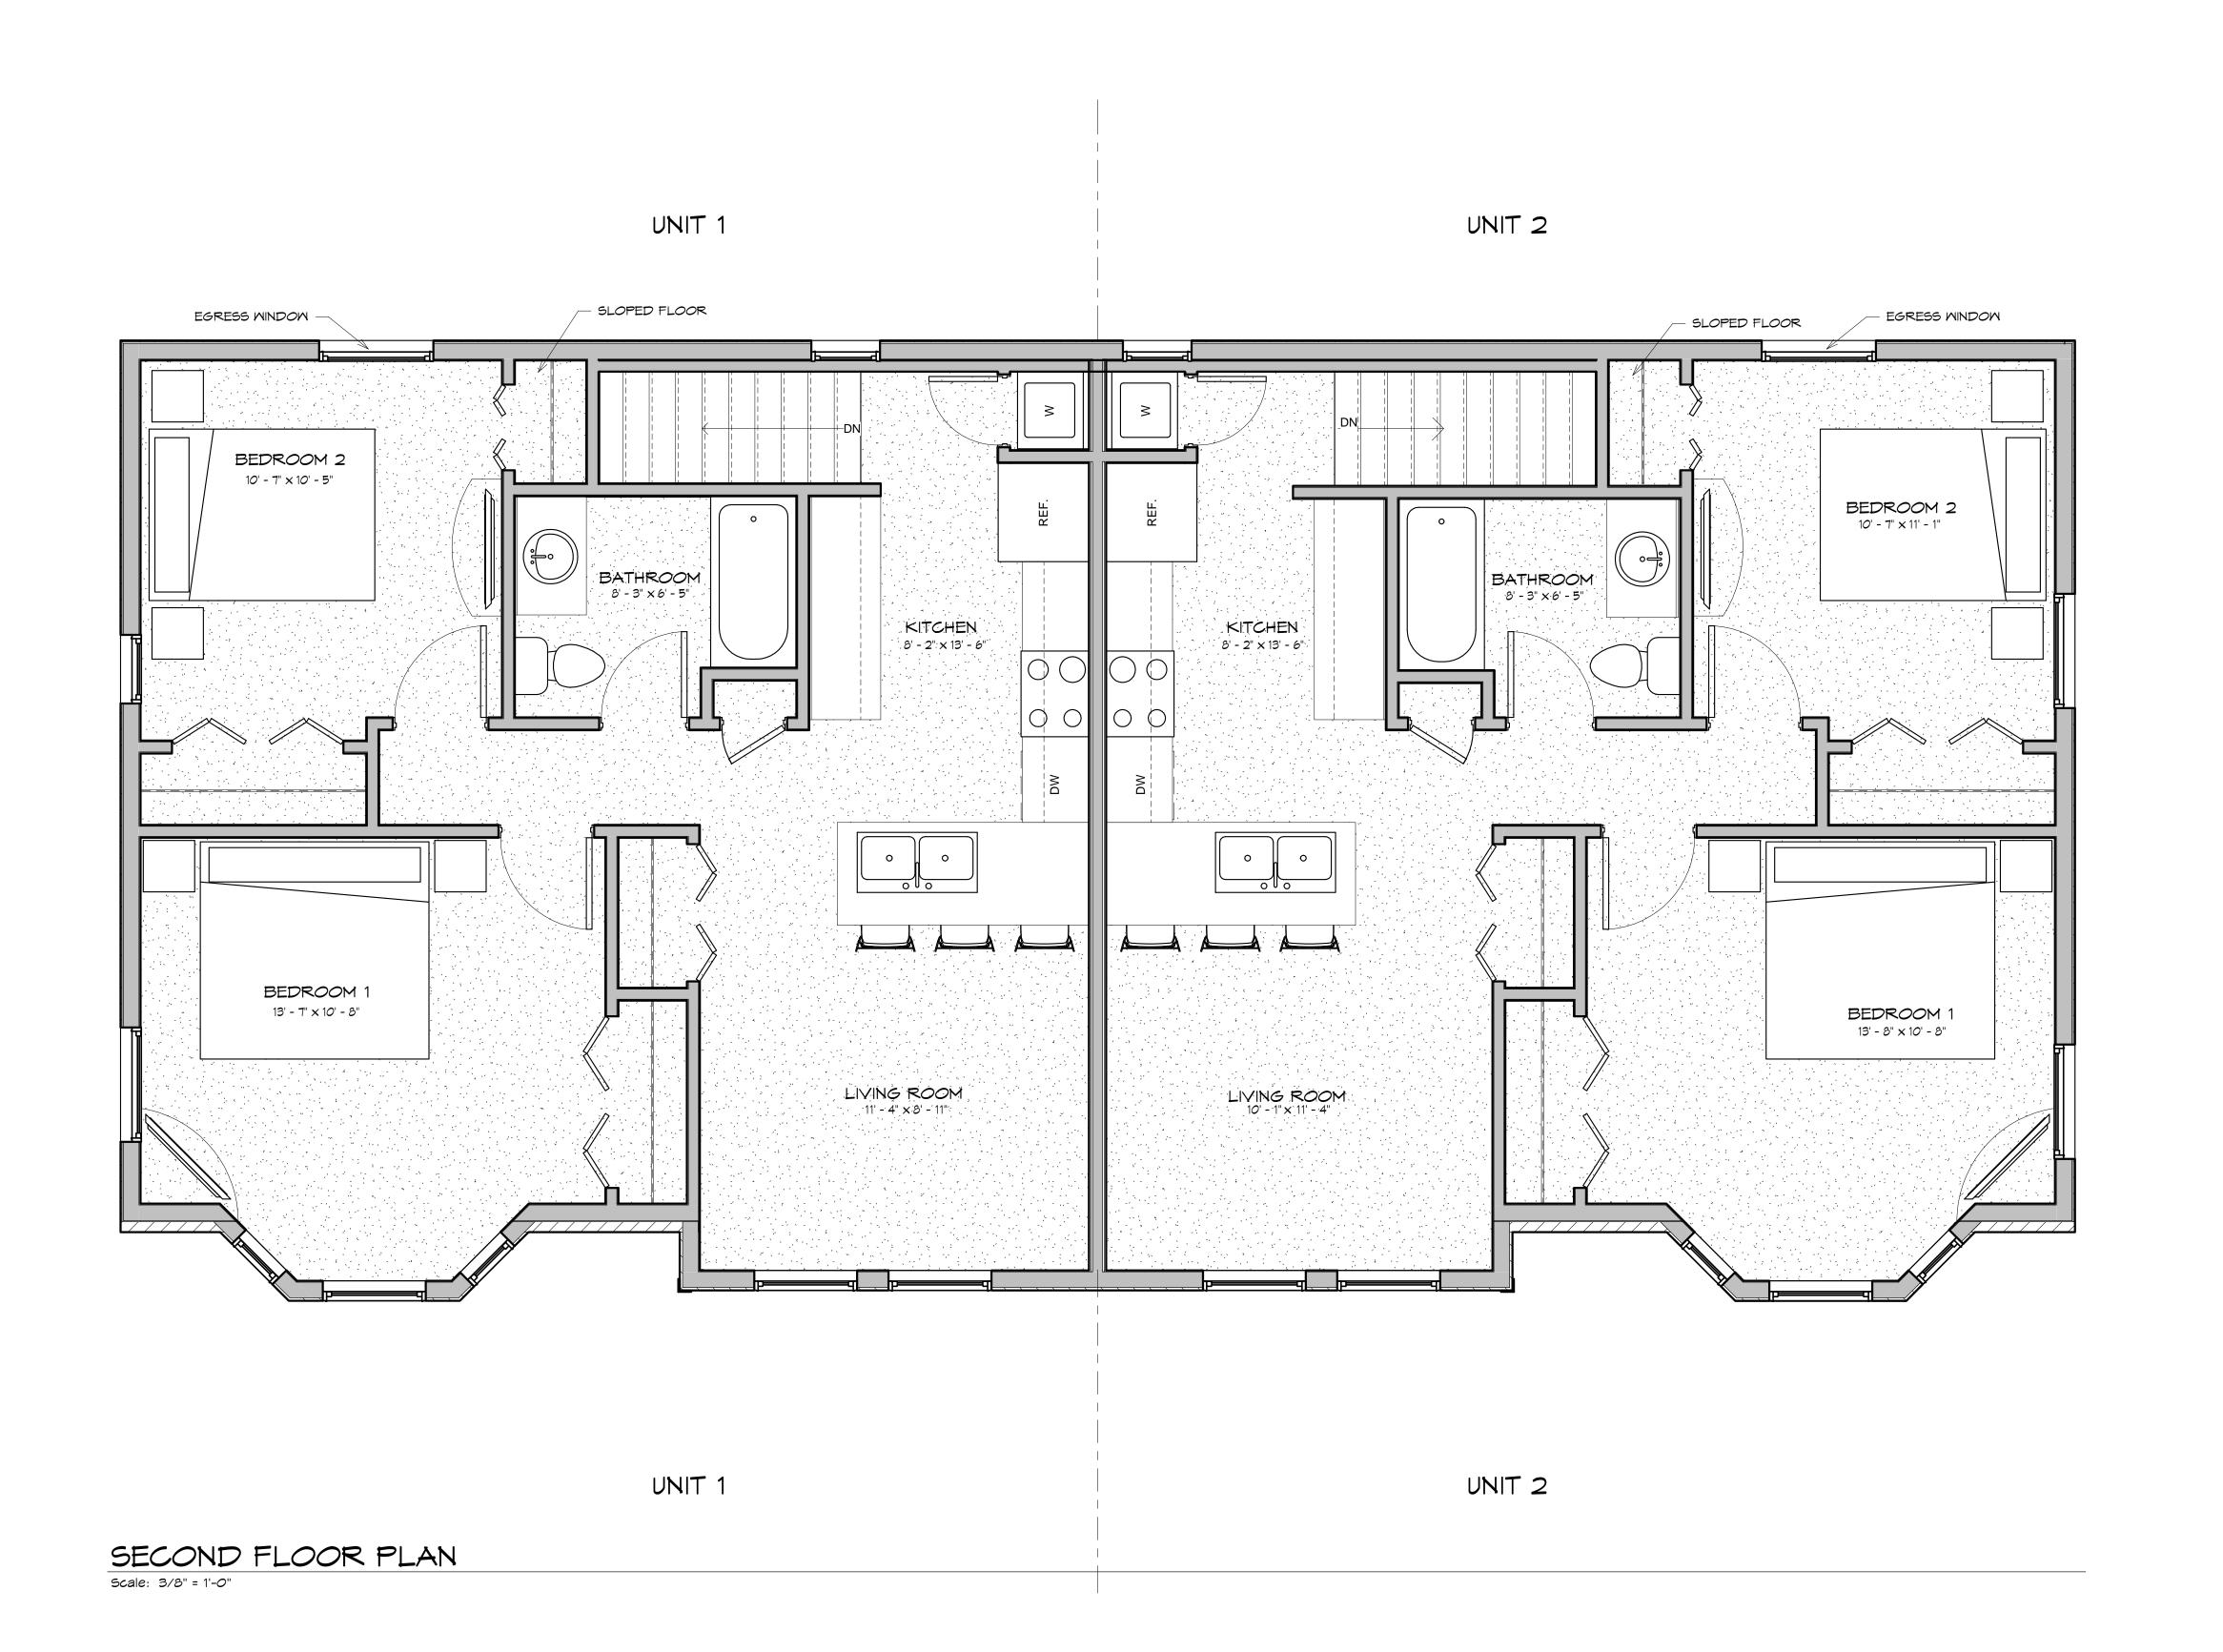



Moiseev/Gordon Associates, Inc. 4351 Delemere Court Royal Oak, MI 48073

248.549.4500 voice 248.549.7300 facs.

www.mga-architects.net

Copyright © 2024

Moiseev/Gordon Associates, Inc.
Use of these drawings is limited
to the client for the subject project.
Common law copyright is reserved
by the Architect.

Use figured dimensions only. Do not scale the drawings.

Client:

TWO STORY DUPLEX

Project Title:

VILLAGE OF HASTINGS

Troy, MI

Sheet Title:

SECOND FLOOR PLAN

Project Number: 22312
Drawn By: AJM, JS
Checked By: AJM
Approved By: AJM
Date:06-16-2023


06-16-23

11-08-23

Issued:

Owner's Review Owner's Review Site Plan Approval 4-26-2024


Sheet Number:

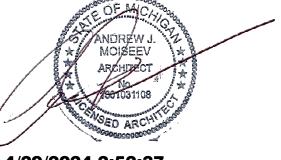

4/29/2024 2:52:37 PM





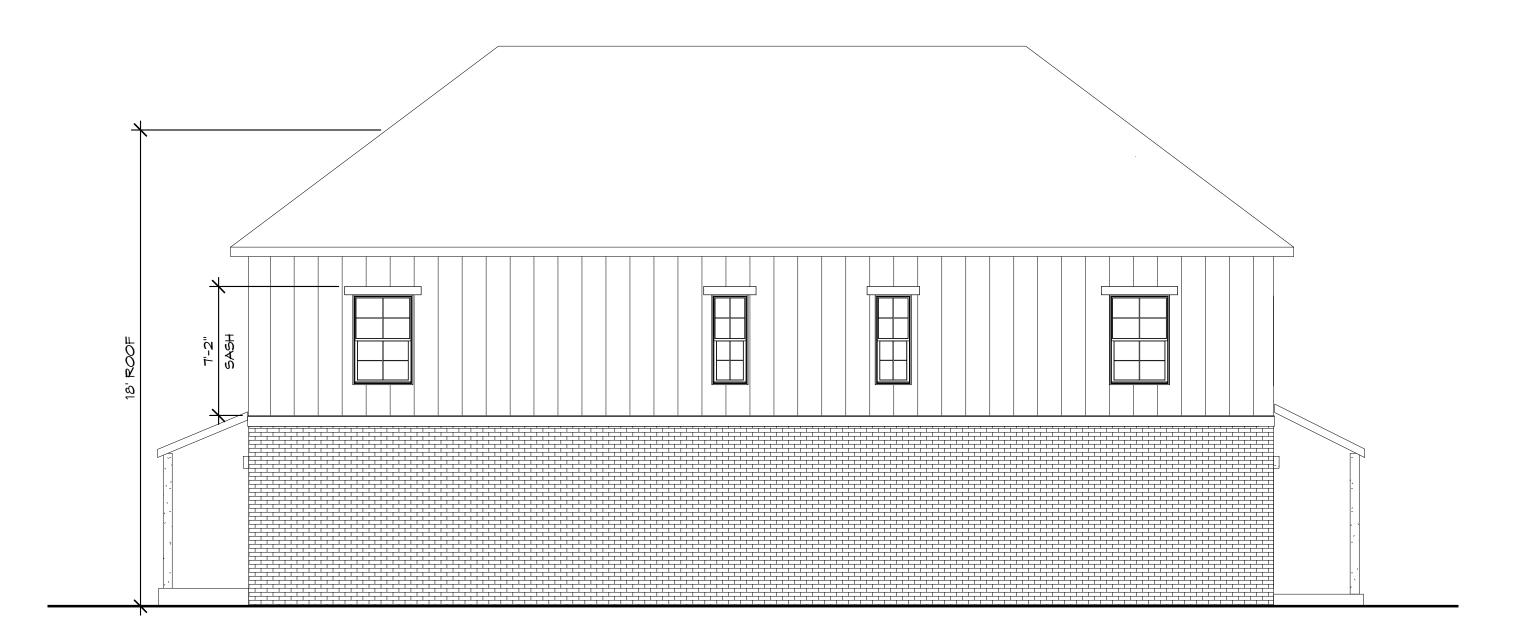

DUPLEX HEIGHTS

4 LEFT ELEVATION

Scale: 3/16" = 1'-0"

2 REAR ELEVATION

5cale: 3/16" = 1'-0"



Moiseev/Gordon Associates, Inc. 4351 Delemere Court Royal Oak, MI 48073

248.549.4500 voice 248.549.7300 facs.

www.mga-architects.net

Copyright

© 2024
Moiseev/Gordon Associates, Inc.
Use of these drawings is limited
to the client for the subject project.
Common law copyright is reserved
by the Architect.

Use figured dimensions only. Do not scale the drawings.

Client:

TWO STORY DUPLEX

Project Title:

VILLAGE OF HASTINGS

Troy, MI

Sheet Title: ELEVATIONS

Project Number: 22312
Drawn By: AJM, JS
Checked By: AJM
Approved By: AJM
Date:06-16-2023

Issued: Review

 Review
 08-04-16


 Owner's Review
 06-16-23

 Owner's Review
 11-08-23

 Site Plan Approval
 4-26-2024


Sheet Number




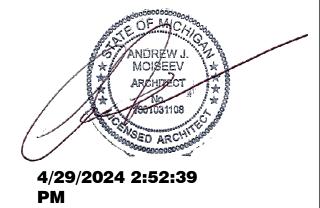





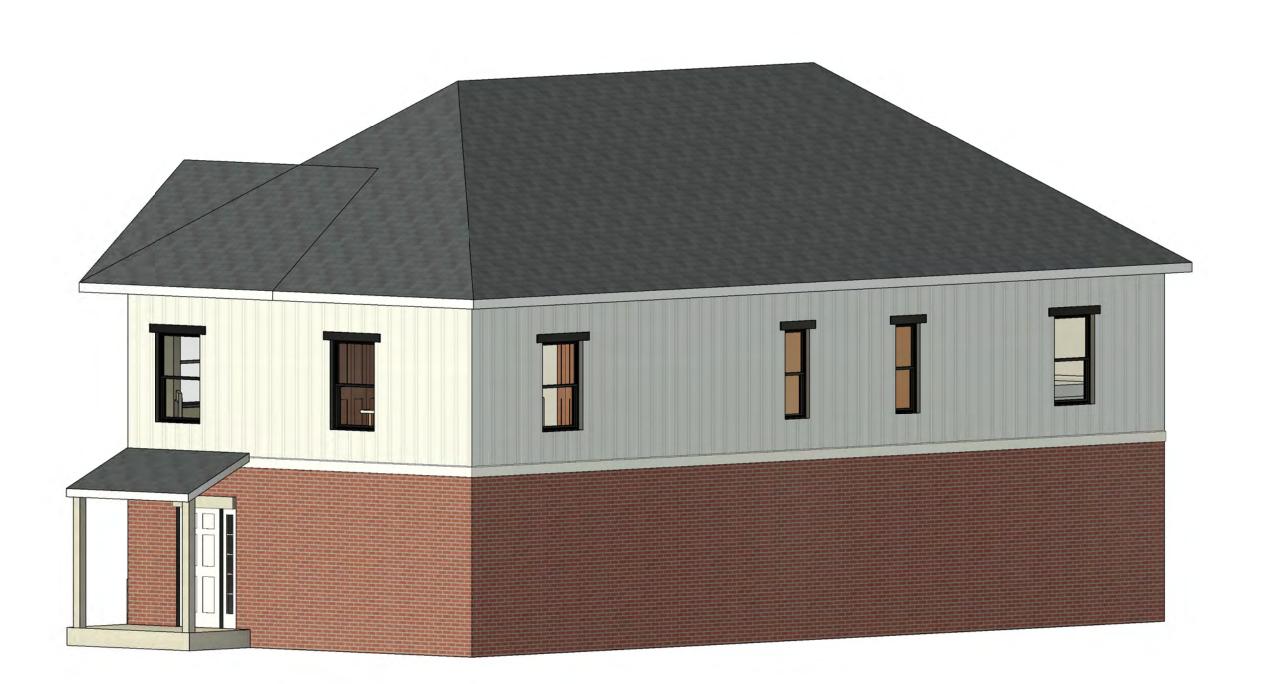

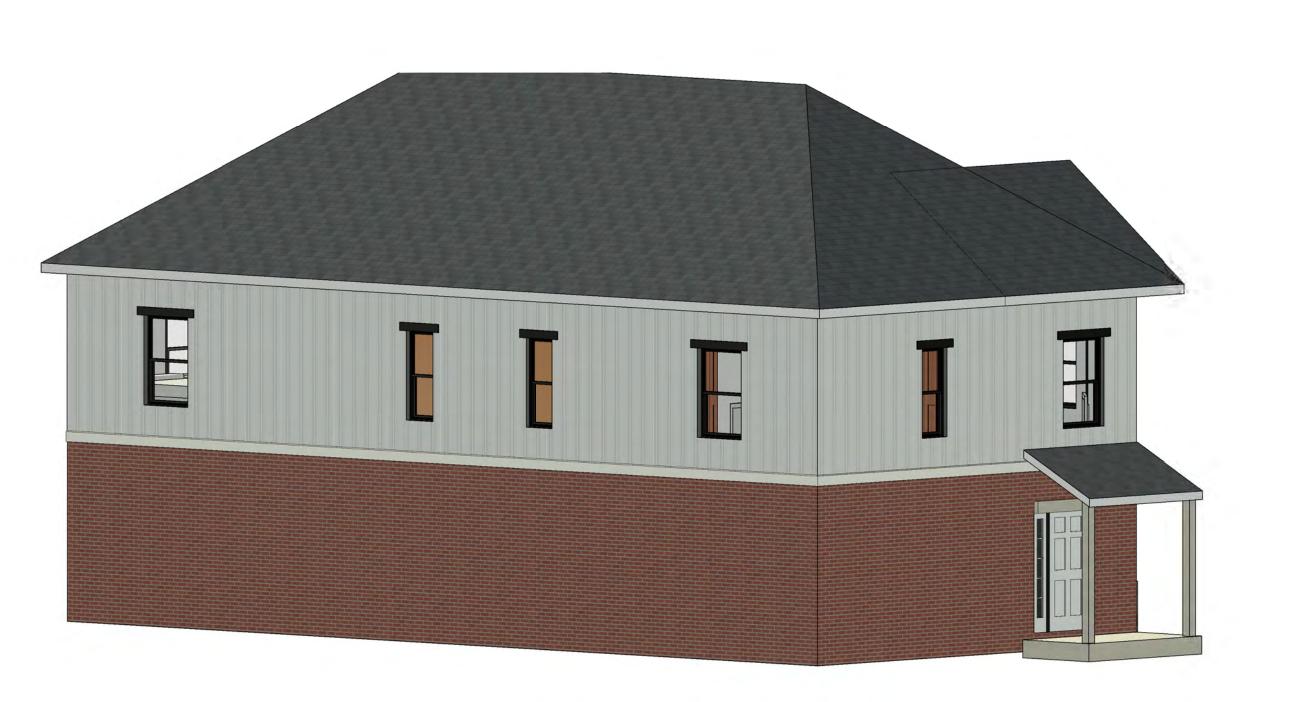



Moiseev/Gordon Associates, Inc. 4351 Delemere Court Royal Oak, MI 48073

248.549.4500 voice 248.549.7300 facs.

www.mga-architects.net

Copyright

Moiseev/Gordon Associates, Inc.
Use of these drawings is limited
to the client for the subject project.
Common law copyright is reserved
by the Architect.

Use figured dimensions only. Do not scale the drawings.

Client:

TWO STORY DUPLEX

Project Title:

VILLAGE OF HASTINGS

Troy, MI

Sheet Title: 3D VIENS

Project Number: 22312
Drawn By: JS
Checked By: AJM
Approved By: AJM
Date:06-16-2023

Issued:

Owner's Review 06-16-23
Owner's Review 11-08-23
Site Plan Approval 4-26-2024

Sheet Number:





4/29/2024 2:52:42 PM



Ranch Duplex Units Village of Hasting MGA Project Number 22312

May 14, 2024





3 - Car Ranch Unit Village of Hasting MGA Project Number 22312

May 14, 2024





5 Unit – Townhouse Village of Hasting MGA Project Number 22312

April 30, 2024





Ranch Duplex Units Village of Hasting MGA Project Number 22312

May 14, 2024





2 Story Duplex Unit Village of Hasting MGA Project Number 22312

April 29, 2024



From: Jen Gillie
To: Planning

Subject: Re: Stop Rezoning of Troy Corners Development

Date: Monday, April 22, 2024 7:21:26 PM

[You don't often get email from jenniferrobingillie@gmail.com. Learn why this is important at https://aka.ms/LearnAboutSenderIdentification]

CAUTION: This email did not originate from within the City of Troy. Do not click links or open attachments unless you recognize the sender and know the content is safe.

I am newer to the neighborhood and live at 212 Booth Rd. It took my family 5 years to find a house in this neighborhood. We choose this neighborhood because we love the big yards and not having neighbors so close. We moved from Royal Oak. We chose this neighborhood because of the community, we have over 10 families with kids around my son's age of 9, some younger. My son didn't learn to ride a bike until this past summer because the streets of Royal Oak, the houses were so congested you never knew if someone would be backing out of their driveway!

My biggest concern is the safety of my child and the children who ride their bikes and scooters in the street, if the builder ends up connecting our neighborhood to his multi family home plan this could increase the traffic on our streets by more than 68 cars based on his 34 unit development. 68 more cars driving our streets.

My next concern is our infrastructure, my yard is partially under water now, I feel this could cause more problems for our area adding that kind of density.

I understand that Troy Corners will at some point be developed. Let's keep the same look and feel of our community. Single family homes on 1/2 acres lots! We moved to this area for a reason!! Less congestion and more room for our family and our children to stay safe!

My other concern is possible redevelopment of our beautiful neighborhood. If Gary gets his way and connects our neighborhood through 400 Ottawa. Family's could start moving out and selling and then our beautiful ranches could all turn into multi family homes. Living in Royal Oak the last 18 years was a sad site to see all of the big foot homes moving in as they tore down the small ranches. When I first moved here I would stare out my back kitchen window and watch the sunrise! The most beautiful and relaxing view I had ever seen! And I have it here in Troy and didn't need to be on vacation to have such a beautiful view. Something I had not seen in years living in royal oak. All I could see were houses! Please let's keep our community in tact and keep the same feel that I am sure is the reason why we all live here. We do not want to live on top of each other and would like a safe place for our kids to grow up!

It would be a win for everyone if Gary would do single family homes, he would still make money as that's all he truly cares about! And it would keep the families of Troy Corners happy and this long drawn out fight would be over.

Sincerely, Jennifer Gillie

> On Dec 9, 2023, at 12:22 PM, Jen Gillie < jenniferrobingillie@gmail.com> wrote:

> I am a resident on Booth Rd, just north of the Troy corners site. I am not ok with this being zoned for PUD. This area needs to stay single family homes to maintained the integrity of our neighborhoods we love so much!

> We recently moved from the Royal Oak area for the quiet neighborhood with a small town feel. We do not approve or desire to have high rise buildings. This will add unnecessary congestion to our area and the need to do future upgrades of our roads that we do not need today!

> Keep our small town feel, please do not approve this to be rezoned!

> Jennifer Gillie

From: Shelley Stenger

To: Hirak Chanda; David Hamilton; Ellen C Hodorek; Mark A Gunn; Ethan Baker; Planning; Rebecca A. Chamberlain-

Creangă; Theresa Brooks

Subject: PUD and Troy Corners

Date: Monday, May 13, 2024 8:43:21 PM

Some people who received this message don't often get email from shellsellshomes1@gmail.com. <u>Learn why this</u> is important

CAUTION: This email did not originate from within the City of Troy. Do not click links or open attachments unless you recognize the sender and know the content is safe.

Dear Planning Commision and City Council members,

I am out of town so I wanted to send this to be included in the public remarks at the next meeting. I will keep this short and sweet.

My mom and I live on 437 E Hurst Drive near historic Troy Corners. My mom has lived here for 62 years after my dad built our house. We love our neighborhood but we do not like what has been happening in our area in the last handful of years.... beginning with the townhouses next to Peppy's Pizza.

I have attended the previous planning and council meetings and am afraid that we are not being heard. I believe there is some confusion about what the residents want and I want to be clear.

I know that there are other townhomes already approved on Square Lake Road by John's party store. But we are very **opposed to the PUD** that is proposed for the northeast corner of the intersection. We would much rather only have the townhouses on Square Lake Road ~ but with a larger setback than the buildings next to Peppy's. The PUD does not meet the requirements, plain and simple. Please hear our plea and do not approve the PUD.

We also agree with the majority of the neighbors regarding our Node, no high density, no three- story, etc. Please, please keep any more large developments off of our 2 lane road. Too much traffic already. And we need to keep property values up in Troy! We are not a low income neighborhood.

Thank you for all of your time and effort in this matter. We really do appreciate your hard work!

Shelley Stenger & Shirley Hardwick



Website: Shellsellshomes1.com

Ann Coleman 6091 Livernois Road Troy, MI 48098

City of Troy Planning Commission 500 W Big Beaver Road Troy, MI 48084

April 14, 2024

Dear Planning Commission,

I am writing to follow up on the topic of rezoning R1B to PUD that was discussed Tuesday April 9. 2024.

It was not my, nor do I believe anyone's intent, to create surprise among the commission. I and my neighbors have put many, many hours of learning, exploring, and thought into the proposal to rezone the R1B at Square Lake and Livernois roads to PUD.

An either-or choice was presented to the Telford HOA by the developer. The developer has not reached out to talk to me, or anyone on the west side of Livernois Road that I know of. In addition, I have repeatedly heard at commission meetings that the developer has the right to build the 14 units on Square Lake because of past decisions, he is within his rights, unless the PUD development can go in. So, I truly believe that we have an either-or choice. I respect the developer's rights.

In thinking about the loss of old/historic homes to build new single-family homes with adjacent unit development on Square Lake, vs keeping the homes and seeing unit development behind them, I would rather see the new homes in R1B. For 3 reasons:

- 1) The developer has not maintained the old/historic homes from the curb view. The landscape has overgrown, a chopped wood fence has fallen apart (although on Sunday the 14th I saw a man repairing it after years), and mold/mildew covers the siding. This tells me that he truly does not care about these homes as assets to the neighborhood. I do not trust his words that say he will repair them. I trust his previous actions. And there is no guarantee that a new owner would maintain them as historic. It would be a niche sale.
- 2) The intent of this area has not changed, and I agree with the intent of the master plan for this area. "The Master Plan recognizes that single-family residential neighborhoods are vital components of the City.... The R-1A through R-1E Districts are further intended to preserve and improve upon the quality of residential neighborhoods while permitting a limited number of other compatible uses which support residential neighborhoods."
- 3) If the precedent is set to increase density of housing this will lead to a ripple effect of widening the road and *I will lose my house because it sits close it*. It is obvious that the properties on the east side of Livernois, south of Square Lake are likely going to be re-developed, along with the area to the east that the developer says he owns. We have many more homes getting built. Any density greater than R1B is concerning.

I believe that community development, when there is conflict, ought to be worked out through discussion and compromise. I believe I am a stakeholder. If I am wrong about these things, I humbly ask for correction.

Thank you, as always, for your service.

Respectfully submitted,

Ann Coleman

Brent Savidant

From: Rosemarie Thommes <rthommes@aol.com>

Sent: Sunday, May 12, 2024 11:09 AM

To: Planning
Cc: Ethan Baker

Subject: Strong Opposition to Proposed PUD at Livernois Rd and Square Lake Rd

You don't often get email from rthommes@aol.com. Learn why this is important

CAUTION: This email did not originate from within the City of Troy. Do not click links or open attachments unless you recognize the sender and know the content is safe.

To: City of Troy Planning Commission

I am writing to reiterate my strong opposition to the proposed Planned Unit Development (PUD) near the Neighborhood Node at Livernois Rd and Square Lake Rd. This letter serves as a continuation of my previous communications on this matter.

My opposition is based on several key concerns:

- Traffic Congestion: Livernois Rd and Square Lake Rd are only two-lane roads, and I, along with many other residents, believe the traffic studies underestimate the significant impact this PUD will have. These roads cannot handle the additional traffic generated by a high-density development.
- Neighborhood Character: This proposal disrupts the established character of our neighborhood. The existing single-family homes, many over 100 years old, contribute significantly to the charm of the area. A PUD with multi-family units would be a stark contrast and not a welcome addition. It would disrupt the look and feel of the community, similar to the negative impact of the 3-story townhomes built on Livernois.
- Inaccurate Comparisons: The builder's argument referencing other approved PUDs is irrelevant. Those developments were situated on major roads with multiple lanes, unlike the narrow, local roads surrounding this proposed site.
- Unaffordable Housing: GFA's claim of providing affordable housing solutions is misleading. With starting prices of \$600,000 for homes and \$350,000 for townhomes, these units will be out of reach for most residents seeking affordability.

Alternative Solutions:

Instead of this ill-suited PUD, I urge the Commission to consider alternative locations for such developments:

- Vacant Office Buildings: There are numerous vacant office buildings in Troy that could be repurposed for multi-family housing.
- Demolished Hotel Site: The vacant site at Crooks Rd and I-75, where a hotel once stood, presents another perfect opportunity for a PUD with existing infrastructure already in place.
- Long Lake Rd and Crooks Rd PUD: The proposed PUD at this location seems like a much better fit and makes far more sense, with existing infrastructure capable of supporting additional traffic.

The entire community surrounding the proposed PUD at Livernois Rd and Square Lake Rd strongly opposes this development. We urge the Commission to maintain the current zoning and protect the character of our neighborhood.

Thank you for your time and consideration.

Sincerely, Rosemarie Thommes 335 Ottawa Drive

ITEM #6

DATE: May 22, 2024

TO: Planning Commission

FROM: R. Brent Savidant, Community Development Director

SUBJECT: PRELIMINARY SITE PLAN APPROVAL (JPLN2023-0031) -. Proposed Wattles

Square Apartments, South side of Wattles and east of John R (PIN 88-20-24-100-

039), Section 24, Zoned NN (Neighborhood Node "F") Zoning District.

The petitioner Atto Construction submitted the above referenced Preliminary Site Plan application for a 54-unit townhome development. The property is currently zoned NN (Neighborhood Node "F") Zoning District. Multi-family residential is permitted by right in this district, subject to height and setback limitations as well as transparency requirements. The Planning Commission is responsible for granting Preliminary Site Plan approval for this item.

The Planning Commission considered this item on April 23, 2024 and passed the following resolution:

Resolution # PC-2024-04-021

Moved by: Lambert Seconded by: Faison

RESOLVED, That Preliminary Site Plan Approval, pursuant to Article 8 of the Zoning Ordinance, as requested for the proposed Wattles Square Apartments, located on the South side of Wattles, East of John R, Section 24, Zoned NN (Neighborhood Node "F") Zoning District be postponed, for the following reasons:

- 1. To increase transparency on all sides of the units.
- 2. To address appropriate concerns on the first level balconies and lower level egress areas.
- 3. Add a bicycle rack.

Yes: All present (9)

MOTION CARRIED

The attached report prepared by Carlisle/Wortman Associates, Inc. (CWA), the City's Planning Consultant, summarizes the project. CWA prepared the report with input from various City departments including Planning, Engineering, Public Works and Fire. City Management supports the findings of fact contained in the report and the recommendations included therein.

Attachments:

- 1. Maps
- 2. Minutes from April 23, 2024 Planning Commission Regular meeting.
- 3. Report prepared by Carlisle/Wortman Associates, Inc.
- 4. Preliminary site plan

G:\SITE PLANS\SP_JPLN2023-0031_WATTLES SQUARE APARTMENTS\PC Memo 2024 05 28.docx

PROPOSED RESOLUTION


<u>PRELIMINARY SITE PLAN APPROVAL (JPLN2023-0031)</u> –. Proposed Wattles Square Apartments, South side of Wattles and east of John R (PIN 88-20-24-100-039), Section 24, Zoned NN (Neighborhood Node "F") Zoning District.

Resolution # PC-2024-05- Moved by: Seconded by:	
RESOLVED , That Preliminary Site Plan Approval, pursuant to Article 8 of Ordinance, as requested for the proposed Wattles Square Apartments, located side of Wattles, east of John R, Section 24, Zoned NN (Neighborhood Nod District, be granted, subject to applicant the following:	on the South
	_) or
(denied, for the following reasons:	_) or
(postponed, for the following reasons:	_)
Yes: No:	

MOTION CARRIED/FAILED



GIS Online

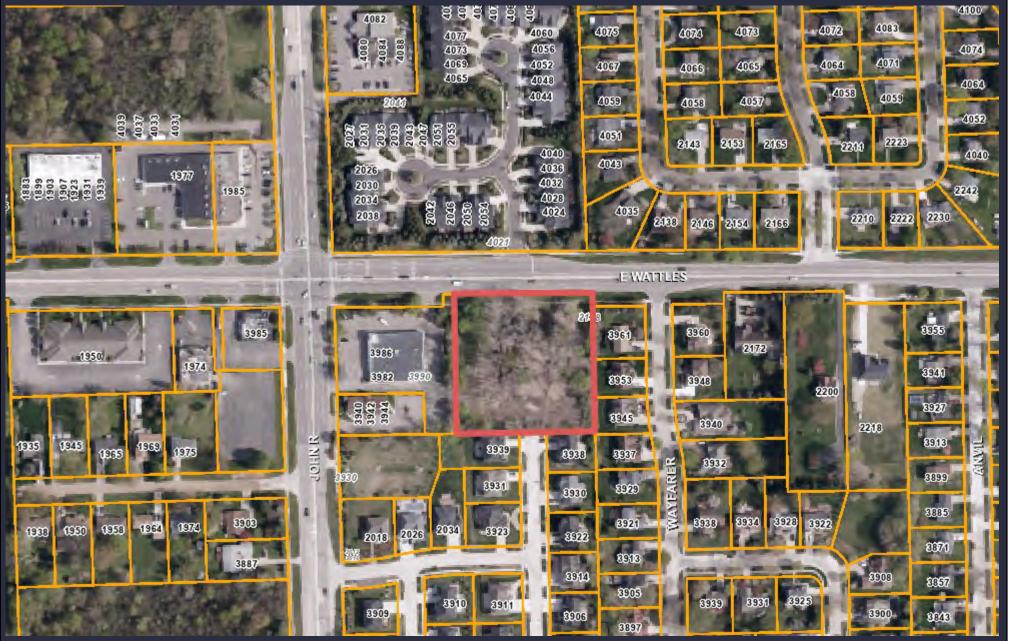

577 0 288 577Feet



Note: The information provided by this application has been compiled from recorded deeds, plats, tax maps, surveys, and other public records and data. It is not a legally recorded map survey. Users of this data are hereby notified that the source information represented should be consulted for verification.

TROY

GIS Online



577 0 288 577Feet



Note: The information provided by this application has been compiled from recorded deeds, plats, tax maps, surveys, and other public records and data. It is not a legally recorded map survey. Users of this data are hereby notified that the source information represented should be consulted for verification.

PRELIMINARY SITE PLAN

5. <u>PRELIMINARY SITE PLAN APPROVAL (JPLN2023-0031)</u> – Proposed Wattles Square Apartments, South side of Wattles and East of John R (PIN 88-20-24-100-039), Section 24, Zoned NN (Neighborhood Node "F") Zoning District

Mr. Savidant provided background information on the Preliminary Site Plan application for Wattles Square Apartments. He addressed the intent of the Neighborhood Node "F" zoning district, how the application relates to the Master Plan and specific site design and building design attributes. Mr. Savidant said the application proposes a first true 'garden style' building concept where a portion of the ground floor is below grade. He said there was extensive dialogue between the administration and the applicant on building height, what constitutes a story and the Zoning Ordinance definition of a basement.

Mr. Savidant asked to go on record with an apology to the Planning Commission and to the applicant for some errors in the Planning Consultant report dated April 12, 2024. He stated the application itself is more compliant than what the report narrates. Mr. Savidant noted the application meets all parking requirements with an exception of adding a bicycle rack. He reported the parking lot island trees and tree replacement are compliant. Mr. Savidant noted the one row of landscaping proposed on the north side of the site would have to be removed for future right of way purposes.

Mr. Savidant reported the application does not meet the transparency requirements on the Wattles frontage and east and south facades. He noted though transparency requirements relate more to commercial use than residential use. He said the applicant is seeking Planning Commission approval to incorporate transparency alternatives, and the Planning Commission has the authority to grant flexibility of the transparency requirements. Mr. Savidant also reported there are safety concerns with the head-clearance of the first floor balconies and the lower level units below grade.

Mr. Savidant asked the Planning Commission to consider in its deliberations the following:

- Does the Planning Commission support the proposed transparency alternatives?
- Does the proposed garden level apartment style meet the Neighborhood Node design requirements?
- Does the Planning Commission support the proposed floor plans (including the community building), elevations and balcony clearance?

In summary, Mr. Savidant asked any approval to be subject to the applicant providing the required bicycle rack and to confirm transparency requirements (30%) on the south and east sides of the buildings. He said the Planning Commission may approve the transparency alternatives for the north elevation.

Some of the comments during discussion among the administration related to:

- Transparency requirements on all facades.
- Design and transparency requirements of front elevation in relation to right of way.
- Horizontal mixed use complies with the Neighborhood Node zoning district.
- Neighborhood Node zoning requirements with future adoption of the Master Plan.
- Safety concerns of balcony head-clearance and lower level units below grade.
- Confirmation that a flat roof is proposed for both buildings.
- Compliance of landscape requirements on north side with removal of landscaping along right of way.

Chair Perakis called a recess at 7:30 p.m. to allow the Information Technology department to resolve audio issues. Chair Perakis called the meeting back in session at 7:40 p.m.

Richard Atto, property owner of subject site and Rite Aid property to the west, introduced family members in the audience and project team members business partner Brian Najor, Landscape Architect Stacee Hadeed and Project Engineer Greg Bono. Mr. Atto gave a brief history of his family background and real estate/development career. He identified several design aspects he feels would be desirous of a potential resident that are incorporated in the development.

Mr. Atto said his short-term goal is to obtain a tenant for the vacant Rite Aid store and a long-term goal would be to potentially expand the development given any future changes in the Neighborhood Node zoning district.

Ms. Hadeed distributed handouts to the Planning Commission and gave a brief history of her career path. She addressed in detail the proposed development as relates to living units, building height and stories, landscaping, parking, traffic circulation, three dimensional views from several directional perspectives, roof design, elevations, outdoor amenities, transparency calculations, site design attributes, building materials and color scheme.

There was discussion, some comments related to:

- Parking, as relates to Rite Aid existing spaces, designated spaces for residents, walking distance to residential units.
- Proposed garden style units as relates to creativity, urban look, massing, unique design, low profile.
- Examples of similar apartment styles in the City with below grade lower level units.
- Community center amenities, as relates to arrangement of work-out area and social gathering space.
- Options to mitigate safety concerns of below grade lower level units and head-clearance of balconies.
- Transparency requirements; measures applicant could apply to meet requirements, consideration of alternative options.

- Approval of application would be conditioned on applicant combining the parcels, as noted on the site plan.
- Nonconforming status of vacant Rite Aid building as relates to Neighborhood Node zoning district if demolished and/or renovated.

Mr. Hutson stated he does not support the application because of the proposed below grade lower level units and floor plans.

Chair Perakis opened the floor for public comment.

 Susan Kuhn, 2172 E Wattles; addressed existing swampy land near Wayfarer Street connection to new homes on John R, parking, management of apartment complex.

Chair Perakis closed the floor for public comment.

Discussion continued among Board members on options applicant could take to mitigate safety concerns of the balconies, to mitigate safety concerns and install egress windows on below grade lower level units, to reconfigure floor space in the community center and to meet transparency requirements.

Mr. Najor said finding a good tenant to lease the Rite Aid property is a step in the right direction. He addressed the subjectivity of transparency requirements for residential use compared to commercial use. Mr. Najor said they will work with the City to mitigate any concerns discussed this evening and meet all code requirements for the egress windows and balconies to assure compliance.

Resolution # PC-2024-04-021

Moved by: Lambert Seconded by: Faison

RESOLVED, That Preliminary Site Plan Approval, pursuant to Article 8 of the Zoning Ordinance, as requested for the proposed Wattles Square Apartments, located on the South side of Wattles, East of John R, Section 24, Zoned NN (Neighborhood Node "F") Zoning District be postponed, for the following reasons:

- 1. To increase transparency on all sides of the units.
- 2. To address appropriate concerns on the first level balconies and lower level egress areas.
- 3. Add a bicycle rack.

Yes: All present (9)

MOTION CARRIED

Mr. Savidant informed the applicant of the specific transparency requirements for each elevation.



117 NORTH FIRST STREET SUITE 70 ANN ARBOR, MI 48104 734.662.2200 734.662.1935 FAX

Date: November 1, 2023

Revised: February 7, 2024

April 12, 2024 May 14, 2024

Preliminary Site Plan For City of Troy, Michigan

Applicant: Atto Construction

Project Name: Wattles Square Apartment

Plan Date: DecembePLANNING COMMISSION

Location: REGULAR MEETING –FINAL APRIL

Zoning: 23, 2024r 5, 2023

Action Requested: South side of Wattles, east of John

PROJECT AND SITE DESCRIPTION

An application has been submitted for alphanses to be fit with the family stacked flat project along the south side of Wattles, east of John R. The site is approximately 2 acres 3.47 acres in area and is currently vacant but encumbered with tree cover. The site is directly east of an existing RiteAid and abuts residential uses on its north, east, and south sides.

The applicant proposes a total of 54 units, divided into two (2) buildings. The first building is directly adjacent to Wattles and the second building is set behind the first. The buildings are stacked flats totaling three (3) stories, but we note that the applicant has lowered the grade of the site so the first story is below grade. The level below grade (noted as "garden level") and the level above (noted as "first floor") are one unit. The third level (noted as "second floor") is a separate unit.

The proposed development is heavily intertwined with the RiteAid site to the east. The applicant is utilizing a portion of the existing RiteAid site for sidewalks, open space, seven (7) parking spaces, and a shared dumpster/recycling enclosure. Furthermore, the applicant proposes to convert a 500 sq/ft section of the existing RiteAid building into a community building for tenants. The existing RiteAid site is owned by the same owner and they will combine the lots to make them one zoning lot.

The site is zoned NN, Neighborhood Node. The proposed multiple family residential use is permitted in the NN, Neighborhood Node, Site Type B.

Location of subject site:

South side of Wattles, east of John R.



Location and Aerial Image of Subject Site

Size of subject site:

The property is approximately 3.47 acres in area.

Proposed use of subject site:

The proposed use is for 54 apartment units.

Current use of subject site:

The property is currently vacant.

Current Zoning:

The property is currently zoned NN, Neighborhood Node, Site Type B.

Surrounding Property Details:

Direction	Zoning	Use
North	NN, Neighborhood Node	Attached Residential
South	R1-C, One Family Residential District	Single Family Residential
East	R1-C, One Family Residential District	Single Family Residential
West	NN, Neighborhood Node	RiteAid

PREVIOUS PLANNING COMMISSION REVIEWS

The Concept Plan was first reviewed by the Planning Commission on April 23, 2024. Discussion primarily focused on:

- Safety issues posed by the balcony arrangement (garden level 'balcony' seen as open hole in the ground; first floor balcony seen as head clearance hazard)
- Structural and dimensional details of the egress windows
- Non-compliance with minimum transparency requirements

CHANGES SINCE PLANNING COMMISSION REVIEW

At the April 23, 2024 Planning Commission meeting, Commissioners voiced concerns with the arrangement of the garden level and first floor balconies. The garden level 'balcony' was seen as a hole with no barrier protection, making it a hazard to children and wildlife specifically. The first floor balcony was seen as a head clearance hazard for both adults and children, as the bottom of the balcony was proposed only 3'10" above grade.

The applicant utilized feedback from the Planning Commission to revise the layout of the balconies. While the original site plans featured a 'floating' first floor balcony, the revised site plans show support beams between the first floor and garden level balconies. The support beams are not necessary from a structural standpoint, but they mitigate concerns of children (and possibly adults) running into corners of the balcony.

Similarly, revised site plans feature a guard rail around the garden level 'balcony,' minimizing its appearance as a hole in the ground. Colored renderings show planter boxes hanging on the guard rail. See below for a comparison of the original balcony design versus the revised balcony design.

Original Balcony Design



Revised Balcony Design, Dated May 7, 2024.



MASTER PLAN

The site is Master Planned for Neighborhood Node. The intended purpose of the neighborhood nodes are to:

- Work together with Social Neighborhoods to create a more livable community.
- Mixed use.
- Provide neighborhood gathering places.
- Accommodate the daily needs of residents.

In addition, neighborhood nodes include specific site design and building design attributes:

SITE DESIGN ATTRIBUTES

- Buildings should be separated from the right-of-way line by a landscaped greenbelt, one lane of off-street parking or a pedestrian walk, or a combination of these.
- Primary parking areas will be located within rear or interior side yards.
- Off-street parking should be screened from the public right-of-way by a knee wall or low decorative fence with a hedge of plantings.
- Walks will connect adjacent developments and the public sidewalks.
- Well-defined crosswalks with timed signalization will permit safe crossings.
- Flexible use of space allowing modest outdoor gathering spaces, such as plazas, will be encouraged.

BUILDING DESIGN ATTRIBUTES

- Buildings should be between two and three stories, although one—story structures accommodating gas stations or other special situations may be permitted.
- One-story buildings should have a minimum exterior height of sixteen feet.
- A ground level story should have a minimum height of twelve feet from finished floor to finished ceiling.
- Facades facing major thoroughfares will be treated as fronts and should have a minimum of half transparent glass and special architectural design treatments.
- Fenestration (the arrangement of windows and doors) should be highlighted through the use of awnings, overhangs or trim detailing.
- Lighting will be carefully managed so as not to encroach on adjacent residential areas.

NATURAL RESOURCES

Topography: The site is relatively flat with minor elevation changes.

Wetlands/Floodplain: The site is not encumbered with wetlands or located in a floodplain.

Woodlands: A tree survey has been provided to inventory the natural features that

exist onsite. The survey identified a total of approximately 78 trees on

site. Most of the trees are invasive species such as cottonwood and box elder. Full replacement and preservation details are shown in the table below:

Replacement Details			
Protected Tree	Inches Removed	Replacement Required	
Landmark	85 inches	85 inches	
Woodland	137 inches	69 inches	
Preservation/Mitigation	Inches Preserved	Credit	
Landmark	0 inches	0 inches	
Woodland	0 inches	0 inches	
Total	154 inches required for replacement.		

Items to be Addressed: None.

SITE ARRANGEMENT

The applicant proposes a total of 54 units, divided into two (2) buildings. One building is directly adjacent to Wattles and the second building is set behind the first. The buildings are stacked flats totaling three (3) stories, but we note that the applicant has lowered the grade of the site so the first floor is below grade. The below grade (noted as "garden level") and the level above (noted as "first floor") are one unit. The "second floor" is a separate unit.

Parking is located in three (3) main areas: along the east side of the site, in the center of the site between the two (2) apartment buildings, and behind the second apartment building (south end of site). The applicant proposes one (1) access point off Wattles and one (1) shared access with the RiteAid property.

The plans propose for the development to share certain site features with the RiteAid site directly to the west. The applicant proposes to utilize a portion of the RiteAid site for sidewalks, open space, seven (7) parking spaces, and a dumpster enclosure. The proposed use of the RiteAid site will remove approximately 20 spaces from the RiteAid site. The applicant's parking calculations for RiteAid have been provided and are detailed in the "Parking" section.

Additional supplemental information has been provided regarding the connection between the proposed development and the RiteAid site. The applicant states that a portion of the RiteAid site is being used so that some site features can be shared, helping to make the development more efficient and sustainable, such as using the driveway from John R and the shared dumpster/recycling enclosure. The existing RiteAid site is owned by the same owner and they will combine the lots to make them one zoning lot.

The applicant proposes to convert a 500 sq/ft section of the existing RiteAid building into a community building for tenants. This separate 500 sq/ft area is located in the southwest corner


of the RiteAid building and is currently vacant. Floor plans provided by the applicant indicate that the community building includes one (1) large, open-concept room and one (1) restroom. The large community room includes: a living room area with a 60-inch flat screen and sitting furniture; a dining area with a table, six (6) chairs, and counter space with a sink and 24-inch mini-fridge; and a workout area with four (4) pieces of equipment and two (2) ADA compliant drinking fountains.

Additionally, colored renderings provided by the applicant show the inclusion of a small patio near the community room entrance. Renderings indicate enough patio space for two (2) small tables, one (1) box plant, and a small group of people. A transformer with a 64-inch screening wall is also shown on the patio.



Community Building/Room as Presented in Colored Renderings

Community Building/Room Location in Context of Surrounding Area

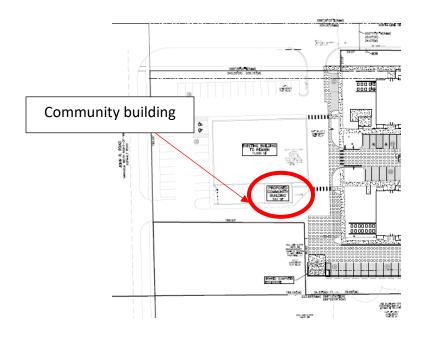

Items to be Addressed: None.

AREA, WIDTH, HEIGHT, SETBACKS


	Required/Allowed	Provided	Compliance
Front (north)	10 feet	10 feet	Complies
Rear (south)	30 feet	72 feet	Complies
Side (west/RiteAid)	0 feet	89 feet	Complies
Side (east)	20 feet	90 feet	Complies
Setbacks Adjacent to Residential (east, south)	Where a property is abutting a one-family or one-family attached district, all setbacks abutting said district shall be equal to the height of the building.	90 feet (east) 72 feet (south)	Complies
Maximum Height	2.5 stories/30 feet	30 feet	Complies
Maximum Lot Area Covered by Buildings (combined lots)	30%	21,280 SF/85,737= 25%	Complies

Garden Style Apartment Design:

The applicant proposes a garden style apartment where a portion of the "ground" floor is below grade. This is being done to essentially provide a three-story building and comply with the 2.5 story/30-foot height requirement. The applicant states that the ground floor does not constitute a story and is considered a basement per ordinance definitions. The Zoning Ordinance defines a "Basement" as follows:

• "That portion of a building which is partly or wholly below grade but is so located that the vertical distance from the average grade to the floor is greater than the vertical distance from the average grade to the ceiling. A basement shall not be counted as a story."

The applicant states that the ground floor is 4'-8" underground and 3-10" is above grade, thus they conclude that more than " fifty (50) percent by cubic content, is below the height level of the adjoining ground", and thus does not constitute a story. See the cross section below.

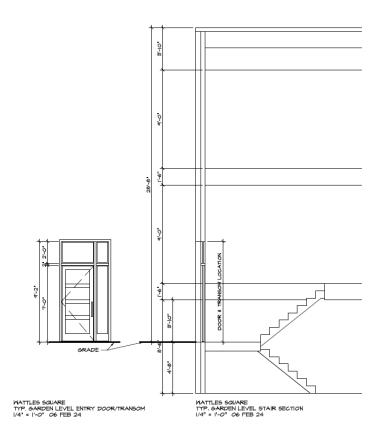

Despite its compliance with building height requirements, the garden style apartment still raised concerns from a design perspective.

Items to be Addressed:-Planning Commission evaluation of revised balcony design.

SITE ACCESS AND CIRCULATION

Vehicular Access:

There are two (2) proposed points of access off Wattles, one (1) of which is a shared access with RiteAid. We note an existing access point to RiteAid off John R, which will also be usable by tenants. Circulation and access have been reviewed by the Engineering and Fire Department and no issues were noted. A traffic review was not required as part of the Engineering review.

Pedestrian Circulation:

There is a continuous sidewalk around both apartment buildings, across the driveway, and then connecting to the existing sidewalk on Wattles. One (1) crosswalk is shown leading towards the proposed Community Building and one (1) crosswalk is shown leading towards RiteAid. Required signage has been added.

Items to be Addressed: None.

PARKING

Section 13.06.G of the Zoning Ordinance requires:

	Required	Provided	Complies
Multiple-Family Residential			
1 space per each efficiency dwelling unit 2 spaces per each dwelling unit	54 units*2= 108	108	Complies
Barrier Free	5	5	Complies
Bicycle	2	Bike Rack	Complies
Retail			
1 space per 250 SF of gross floor area	11,585 SF/250= 46	46	Complies
Barrier Free	2	2	Complies

Parking calculations confirm that on-site parking will remain sufficient for both the subject site and the RiteAid site.

Items to be Addressed: None.

LANDSCAPING

Landscaping is regulated by Section 13.02:

	Required	Provided	Complies
Site landscaping: A minimum of twenty percent (20%) of the site area shall be comprised of landscape material. Up to twenty-five percent (25%) of the required landscape area may be brick, stone, pavers, or other public plaza elements, but shall not include any parking area or required sidewalks.	20%	35%	Complies
Screening between uses: Table 13.02A and 13.02B set forth screening requirements relating to	East: 303 feet = 31 trees	East: 31	Complies
adjacent land uses. Applicant selected one (1) large evergreen tree per ten (10) lineal feet.	South: 380 feet = 38 trees	South: 38	·
Parking Lot Trees: 1 per 8 spaces	114 spaces = 14 trees	15 trees	Complies
Mitigation: Replace 50% of Woodland DBH Replace 100% of Landmark DBH	154 inches of DBH	156 inches	Complies

Trash Enclosure:

The applicant intends to remove the existing RiteAid dumpster/enclosure and utilize a shared use dumpster/recycling enclosure between the two (2) sites. The proposed shared dumpster is located at the southwest corner of the site near the RiteAid property. The enclosure is a 6-foot masonry block wall matching the finish of the buildings.

Equipment:

Mechanical equipment is proposed at the northwest corner of the property. The applicant has provided details for a 3-foot-tall brick screening wall.

Items to be Addressed: Provide required interior parking lot landscaping.

LIGHTING

The applicant is proposing to light the site with 10 pole lights and 28 lighted bollards. The fixtures and photometrics meet ordinance requirements. The pole lights will measure 15 feet in height.

Items to be Addressed: None.

FLOOR PLANS AND ELEVATIONS

Floorplans:

34 out of 54 proposed units are two (2) level units. In these 34 units, the "garden level" begins four (4) feet 8 inches below grade and contains a bedroom, bathroom, walk-in closet, and storage/utility room. Upstairs, the "first floor" contains a foyer area, living room, kitchen, bathroom, and second bedroom.

20 out of 54 proposed units are one (1) level units on the "second floor" of each building (above the garden level and first floor). These 20 units include a foyer area, two (2) bedrooms, living room, kitchen, two (2) bathrooms, walk-in closet, and laundry room.

All units are accessed by stairs and no elevators are included in the buildings. With that said, the units are not ADA accessible by default. However, the applicant has noted that certain units can become ADA accessible with the inclusion of stair lifts.

Elevations:

The apartment buildings feature a flat-roof design with an overall height of 30 feet.

Egress Windows:

As requested by the Planning Commission at the April 23, 2024 meeting, the applicant has provided details on the structure and dimensions of the egress windows. Egress window details are available in the Planning Commission meeting packet.

Balcony Clearance:

See "Area, Width, Height, Setbacks" section for discussion on balcony clearance.

Building Materials:

Proposed building materials include brick veneer (colors medium and light gray), concrete block (light cream), metal siding (charcoal and light walnut), stone veneer (light gray), and canvas awning (marine blue).

Transparency:

Transparency calculations are fully compliant for each apartment building. First floor transparency facing Wattles shall be 50% and all first floor facades facing a parking area shall be 30% transparent.

Items to be Addressed: None.

SITE PLAN REVIEW STANDARDS

Section 8.06 outlines Site Plan Review Design Standards.

- 1. Development shall ensure compatibility to existing commercial districts and provide a transition between land uses.
 - a. Building design shall enhance the character of the surrounding area in relation to building and parking placement, landscape and streetscape features, and architectural design.
 - b. Street fronts shall provide a variety of architectural expression that is appropriate in its context and prevents monotony.
 - c. Building design shall achieve a compatible transition between areas with different height, massing, scale, and architectural style.
- 2. Development shall incorporate the recognized best architectural building design practices.
 - a. Foster a lasting impact on the community through the provision of high quality design, construction, and detailing.
 - b. Provide high quality, durable materials, such as but not limited to stone, brick, glass, and metal. E.I.F.S. or material equivalent shall only be used as an accent material.
 - c. Develop buildings with creativity that includes balanced compositions and forms.
 - d. Design roofs that are appropriate to the architectural style of the building and create an appropriate visual exterior mass of the building given the context of the site.
 - e. For commercial buildings, incorporate clearly defined, highly visible customer entrances using features such as canopies, porticos, arcades, arches, wing walls, ground plane elements, and/or landscape planters.
 - f. Include community amenities that add value to the development such as patio/ seating areas, water features, art work or sculpture, clock towers, pedestrian plazas with park benches or other features located in areas accessible to the public.
- 3. Enhance the character, environment and safety for pedestrians and motorists.
 - a. Provide elements that define the street and the pedestrian realm.
 - b. Create a connection between the public right of way and ground floor activities.
 - c. Create a safe environment by employing design features to reduce vehicular and pedestrian conflict, while not sacrificing design excellence.
 - d. Enhance the pedestrian realm by framing the sidewalk area with trees, awnings, and other features.
 - e. Improve safety for pedestrians through site design measures.

SUMMARY

As part of the deliberation, the Planning Commission should discuss the following topics:

- 1. Compliance with Site Plan Review standards set forth in Section 8.06
- 2. Evaluation of revised balcony design.

3. How well the proposed project meets the overall site and building design standards of the Neighborhood Nodes.

Sincerely,


CARLISLE/WORTMAN ASSOC., INC. Benjamin R. Carlisle, AICP, LEED AP

President


CARLISLE/WORTMAN ASSOC., INC.

Shana Kot

Community Planner

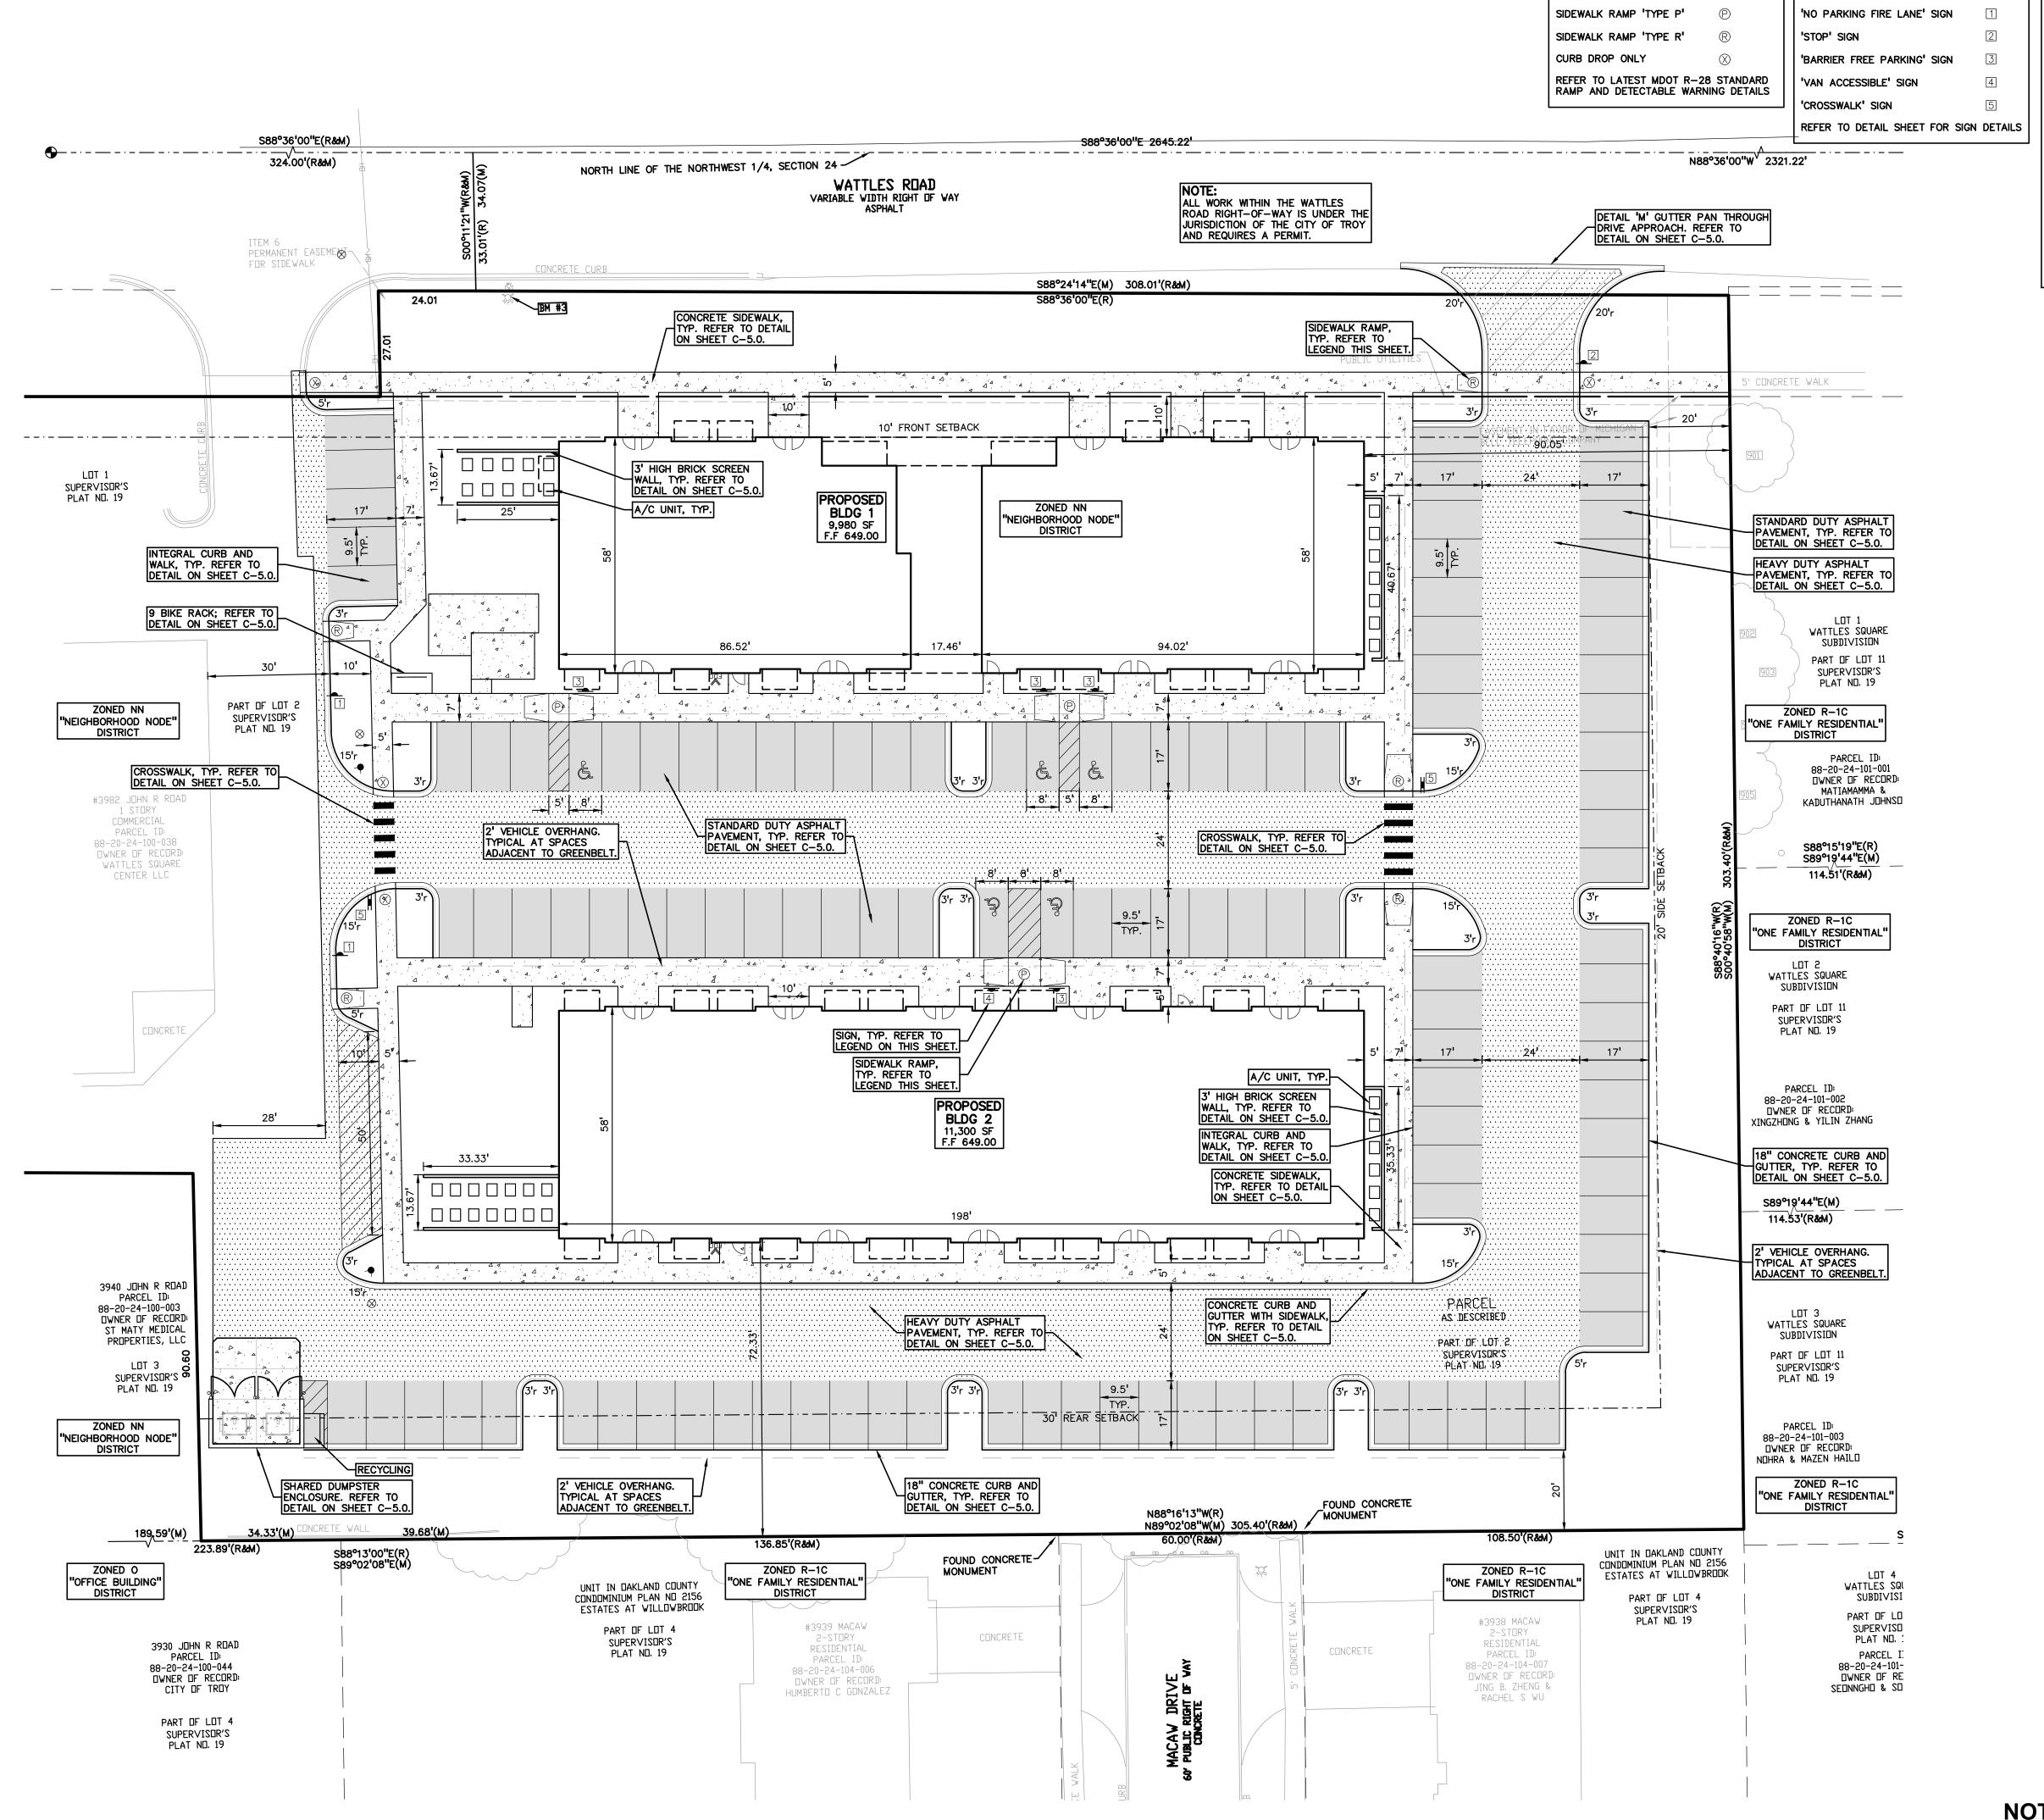

CONCRETE PAVEMENT ASPHALT PAVEMENT t: 844.813.2949

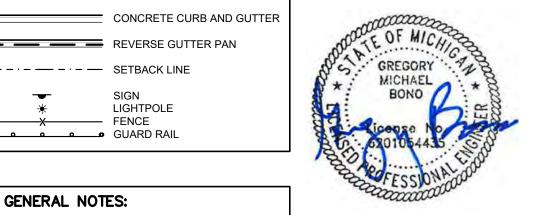

www.peagroup.com

GENERAL NOTES:

LEGEND:

STD HEAVY DEEP DUTY DUTY STRENGTH

at at at METLAND

— - · - — - · - — SETBACK LINE

—————— FENCE

GUARD RAIL

REVERSE GUTTER PAN

SIDEWALK RAMP LEGEND:

SIGN LEGEND:

THESE NOTES APPLY TO ALL CONSTRUCTION ACTIVITIES ON THIS PROJECT.

ALL DIMENSIONS SHOWN ARE TO BACK OF CURB, FACE OF SIDEWALK, OUTSIDE FACE OF BUILDING, PROPERTY LINE, CENTER OF MANHOLE/CATCH BASIN OR CENTERLINE OF PIPE UNLESS OTHERWISE NOTED.


LIGHTPOLE

GRAVEL

2. 'NO PARKING-FIRE LANE' SIGNS SHALL BE POSTED ALONG ALL FIRE LANES AT 100 FOOT INTERVALS OR AS DIRECTED BY THE FIRE OFFICIAL. . REFER TO NOTES & DETAILS SHEET FOR

ON-SITE SIDEWALK RAMP DETAILS


ON-SITE PAVING DETAILS. . REFER TO NOTES & DETAILS SHEET FOR

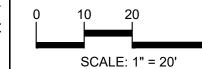



CAUTION!!

THE LOCATIONS AND ELEVATIONS OF EXISTING UNDERGROUND UTILITIES AS SHOWN ON THIS DRAWING ARE ONLY APPROXIMATE. NO GUARANTEE IS EITHER EXPRESSED OR IMPLIED AS TO THE COMPLETENESS OR ACCURACY THEREOF THE CONTRACTOR SHALL BE EXCLUSIVELY RESPONSIBLE FOR DETERMINING THE EXACT UTILITY LOCATIONS AND ELEVATIONS PRIOR TO THE START OF CONSTRUCTION. LOCATION MAP

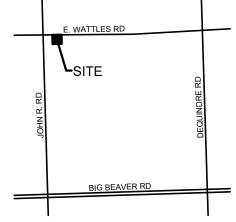

CLIENT

CONSTRUCTION, INC. 2150 FRANKLIN ROAD BLOOMFIELD HILLS, MI 48302


PROJECT TITLE

WATTLES SQUARE APARTMENTS E. WATTLES RD. & JOHN R. RD. TROY, MI 48083

REVISIONS	
CITY COMMENTS	11/15/2
SITE PLAN APPROVAL	12/5/2
CITY COMMENTS	3/6/2
ORIGINAL ISSUE DATE:	
ONIGINAL IGOUL DATE.	

DRAWING TITLE **PRELIMINARY SITE PLAN**


PEA JOB NO.	22-1309
P.M.	GME
DN.	KRD
DES.	KRD
DRAWING NUMBER:	

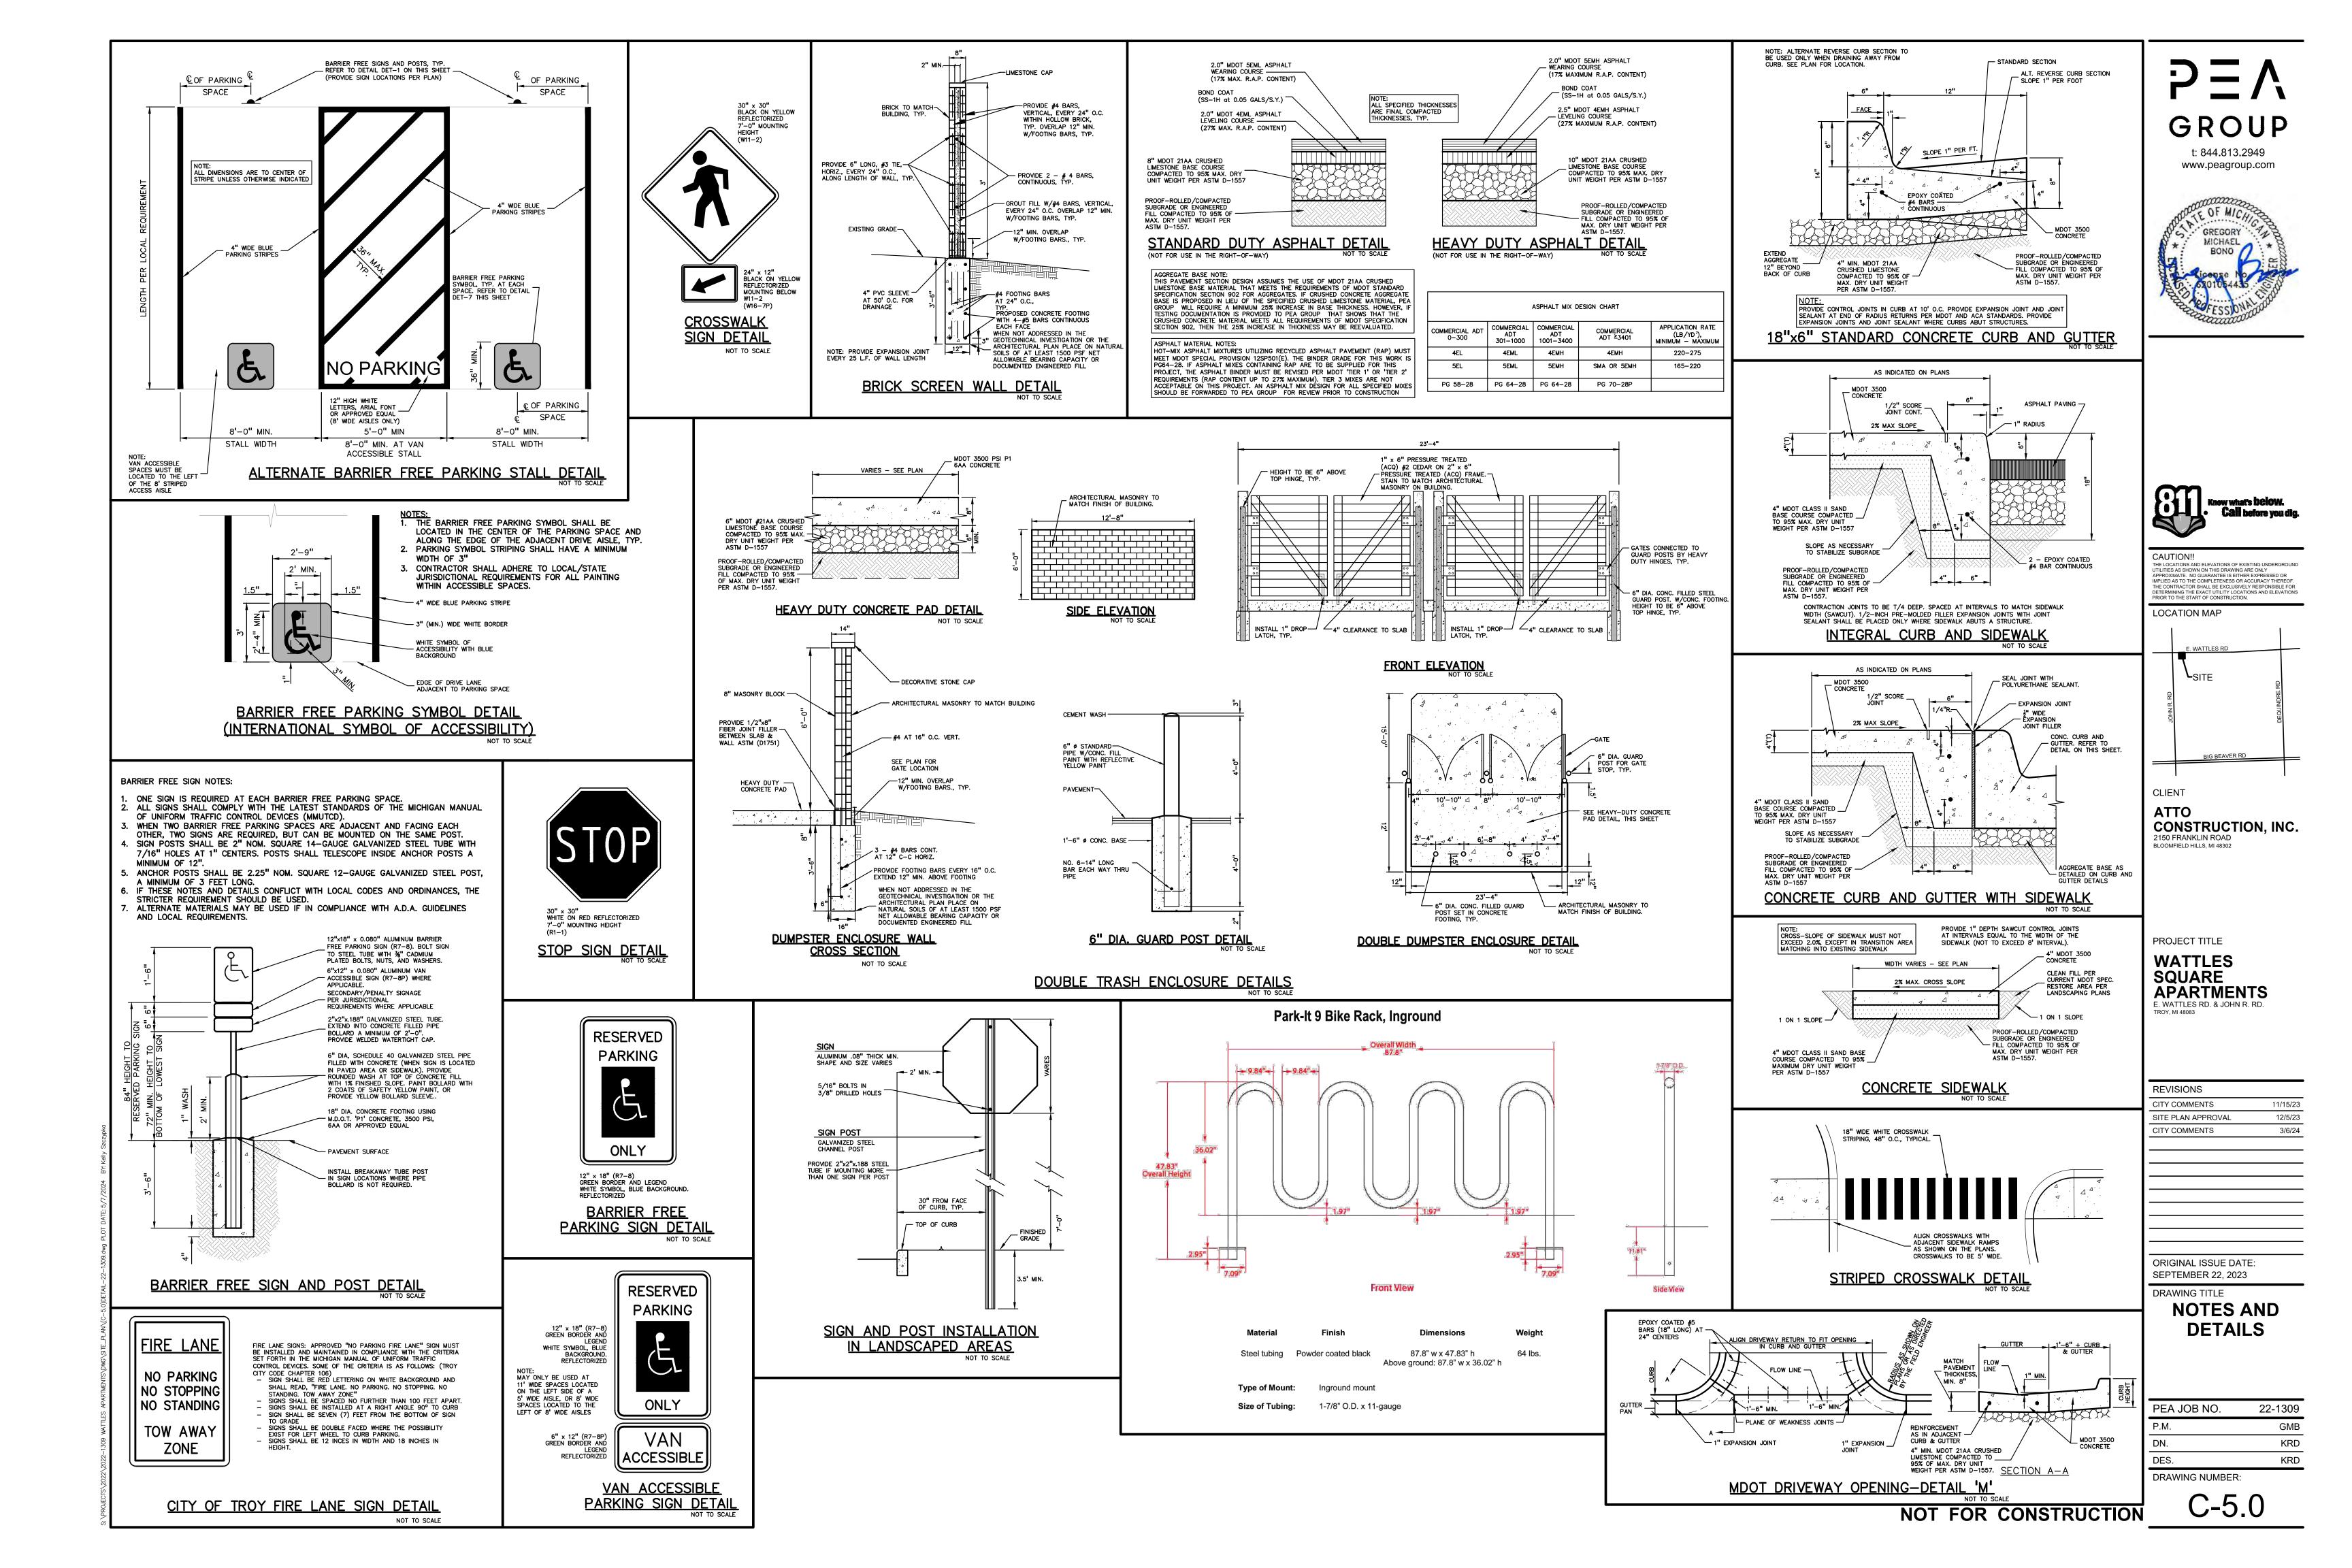


WATTLES SQUARE APARTMENTS - TRANSPARENCY REQUIREMENTS


4-30-2024



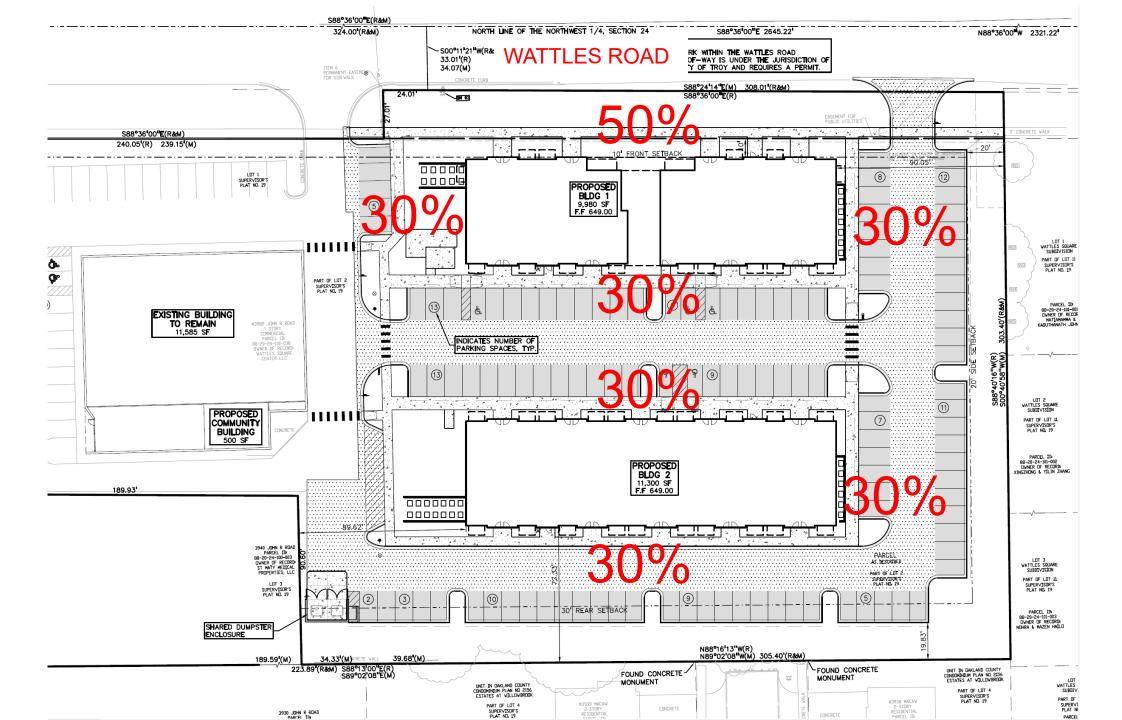

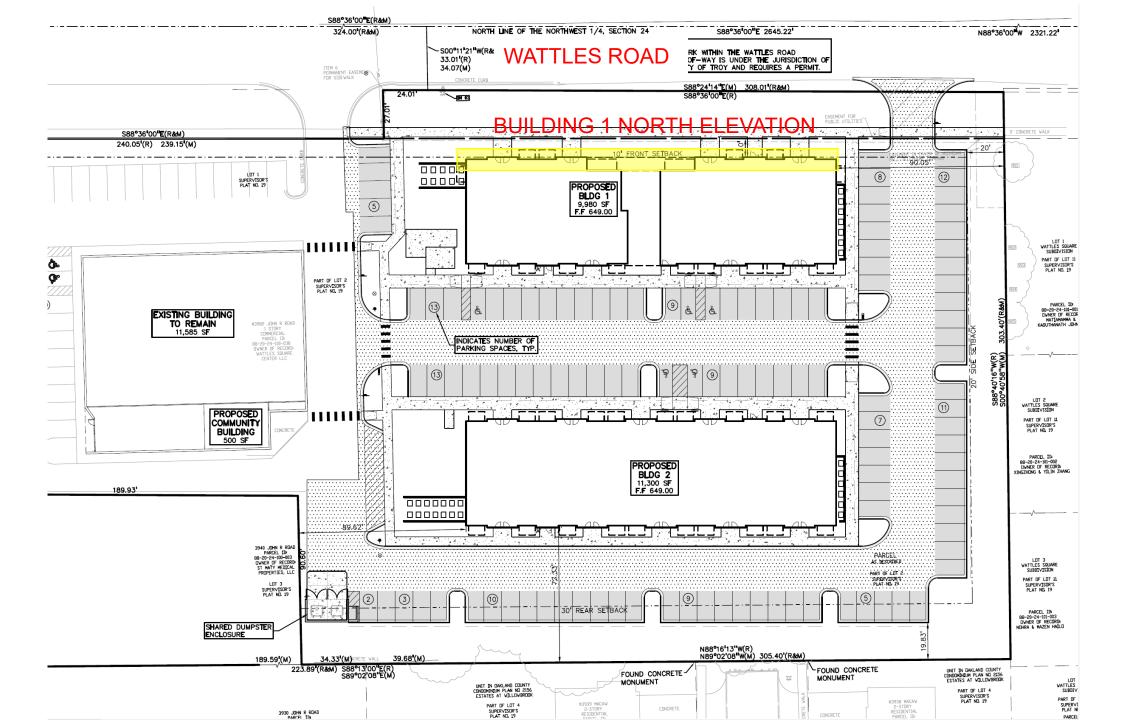

50% TRANSPARENCY REQUIRED AT WATTLES FACADE

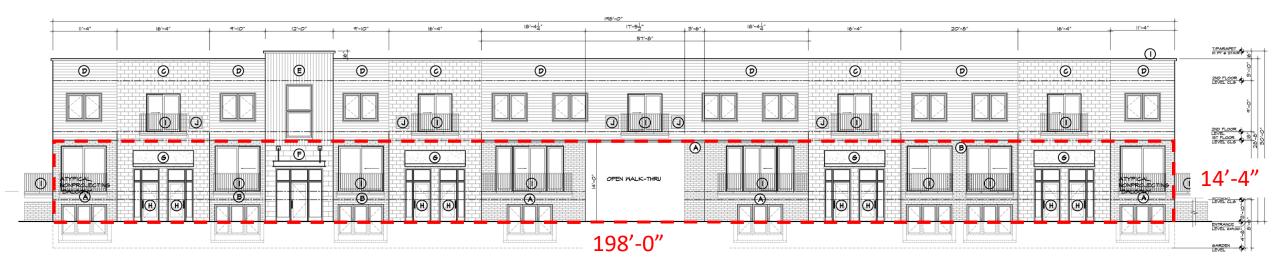

 $198 \times 14.3 = 2831 \text{ SF of facade}$

BUILDING 1- NORTH ELEVATION


 $198' \times 14.3' = 2831 \text{ SF of façade}$

2831 SF / 2 = 1415 SF

50% transparency = 1415 SF

50% TRANSPARENCY REQUIRED AT WATTLES FACADE

50% transparency = 1415 SF

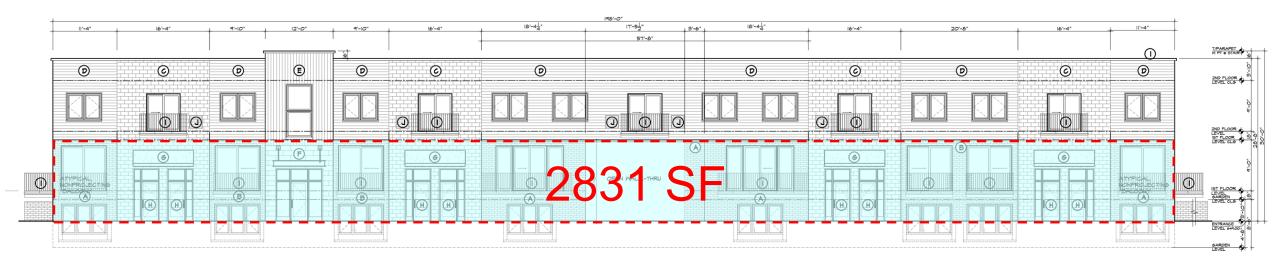

50% TRANSPARENCY REQUIRED AT WATTLES FACADE





384 + 192 + 348 + 87 + 160 + 248 = 1419 SF



3.5 SF X 6 - 346 SF 87 SF 80 SF x 2 = 160 SF 248 SF 1419 SF

BUILDING 1– NORTH ELEVATION

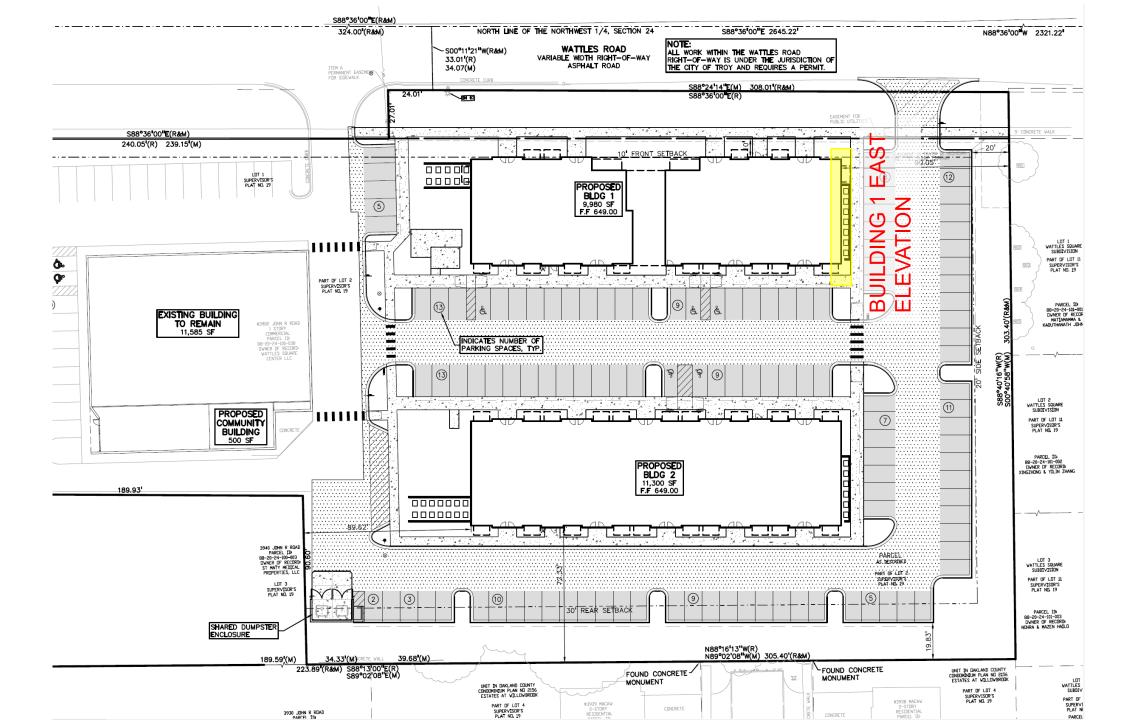

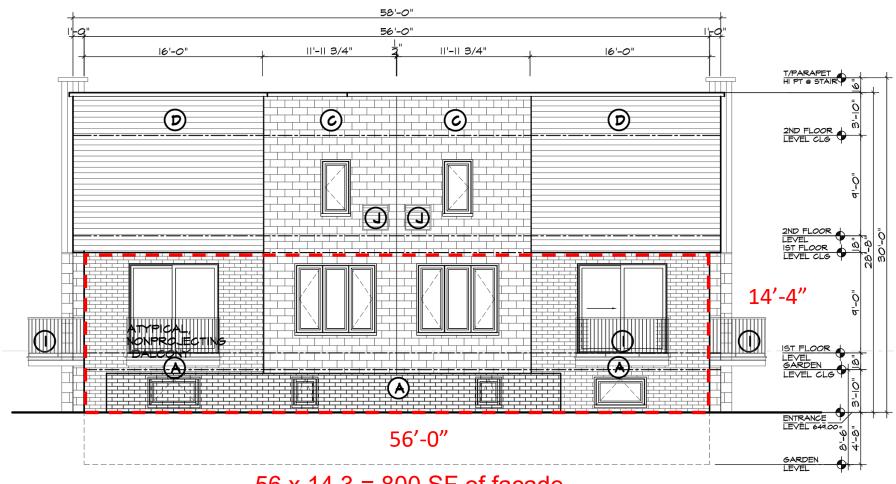


 $56 \times 14.3 = 800 \text{ SF of facade}$

 $56' \times 14.3' = 800 SF of façade$


800 SF x . 3 = 240 SF

30% transparency = 240 SF

30% transparency = 240 SF

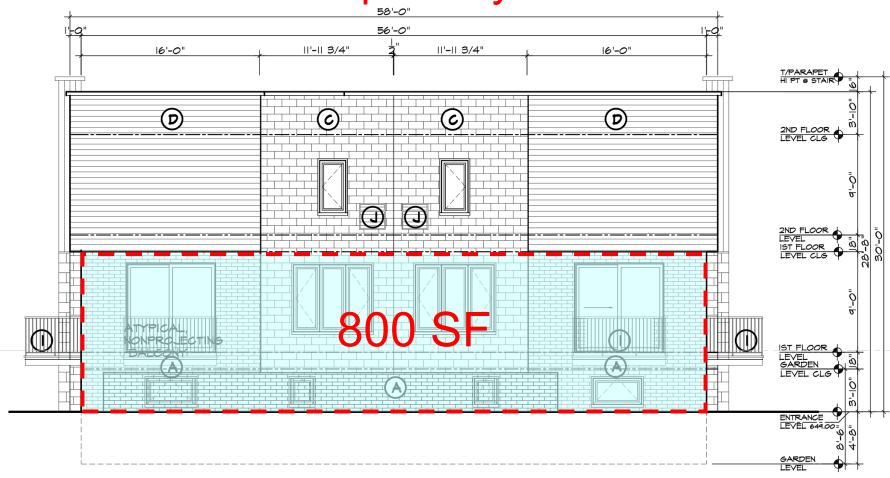





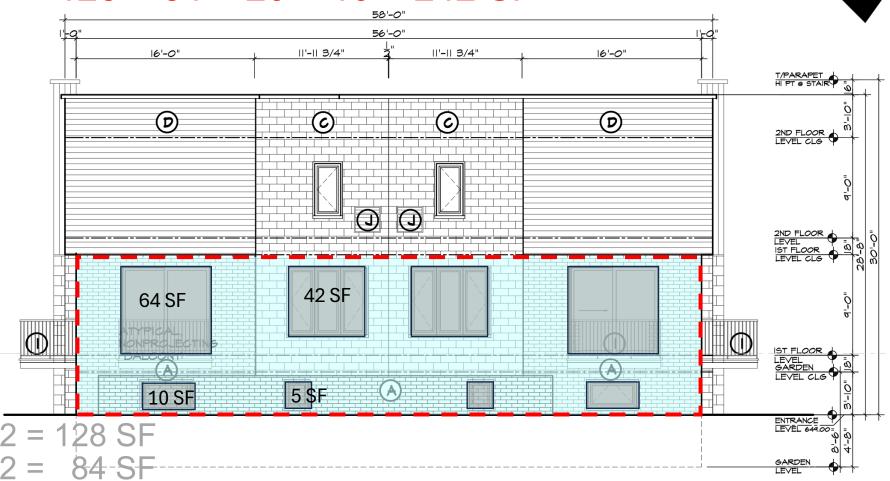

64 SF x 2 = 128 SF 42 SF x 2 = 84-SF----10 SF x 2 = 20 SF 5 SF x 2 = 10 SF242 SF

BUILDING 1- EAST ELEVATION

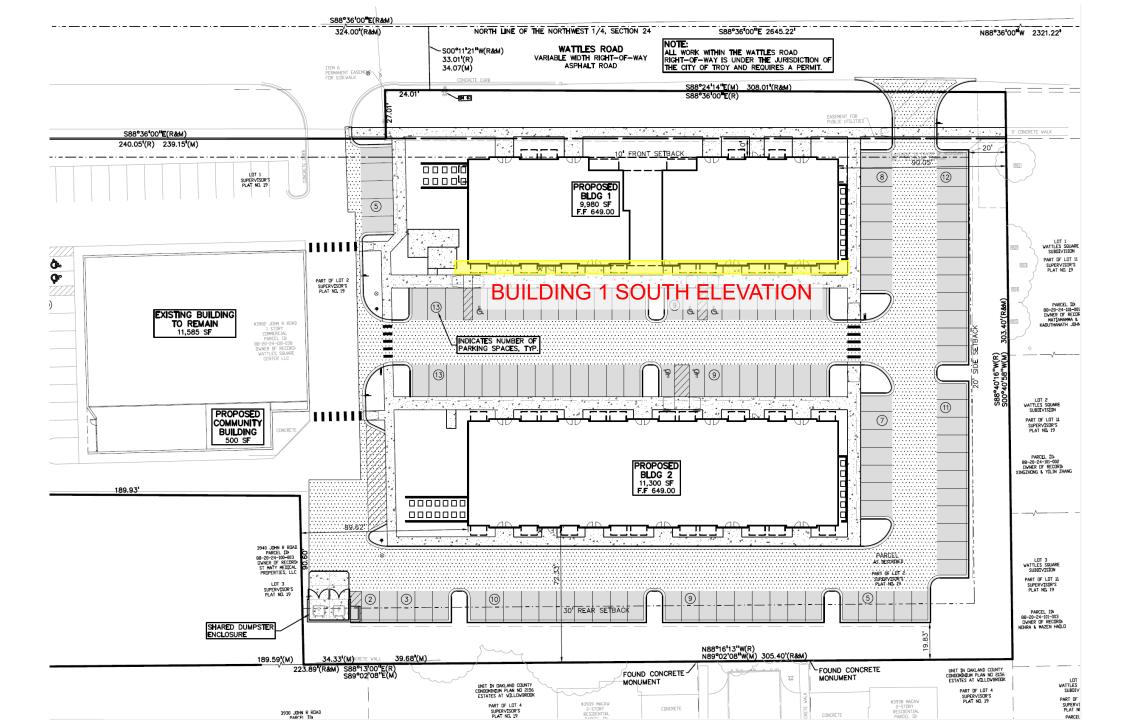

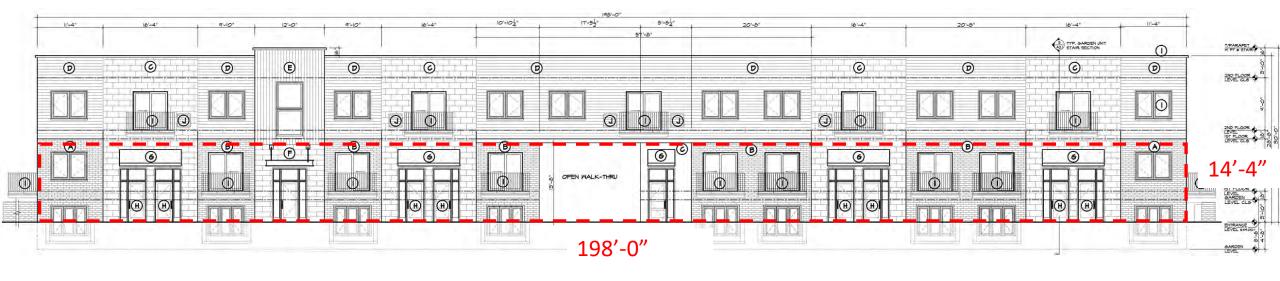

 $198 \times 14.3 = 2831 \text{ SF of facade}$


BUILDING 1- SOUTH ELEVATION

 $198' \times 14.3' = 2831 \text{ SF of façade}$

2831 SF x .3 = 849 SF

30% transparency = 849 SF



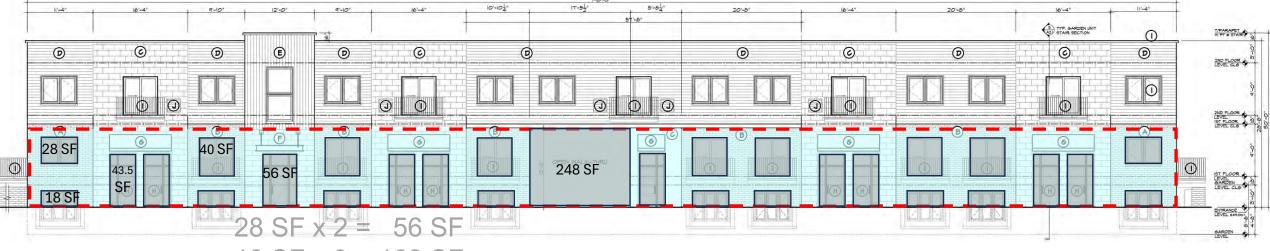


$$18 \text{ SF x } 9 = 162 \text{ SF}$$


$$43.5 \, \text{SF} \, \text{x} \, 9 = 391 \, \text{SF}$$

$$40 \text{ SF } \times 7 = 280 \text{ SF}$$

1193 SF

BUILDING 1— SOUTH ELEVATION

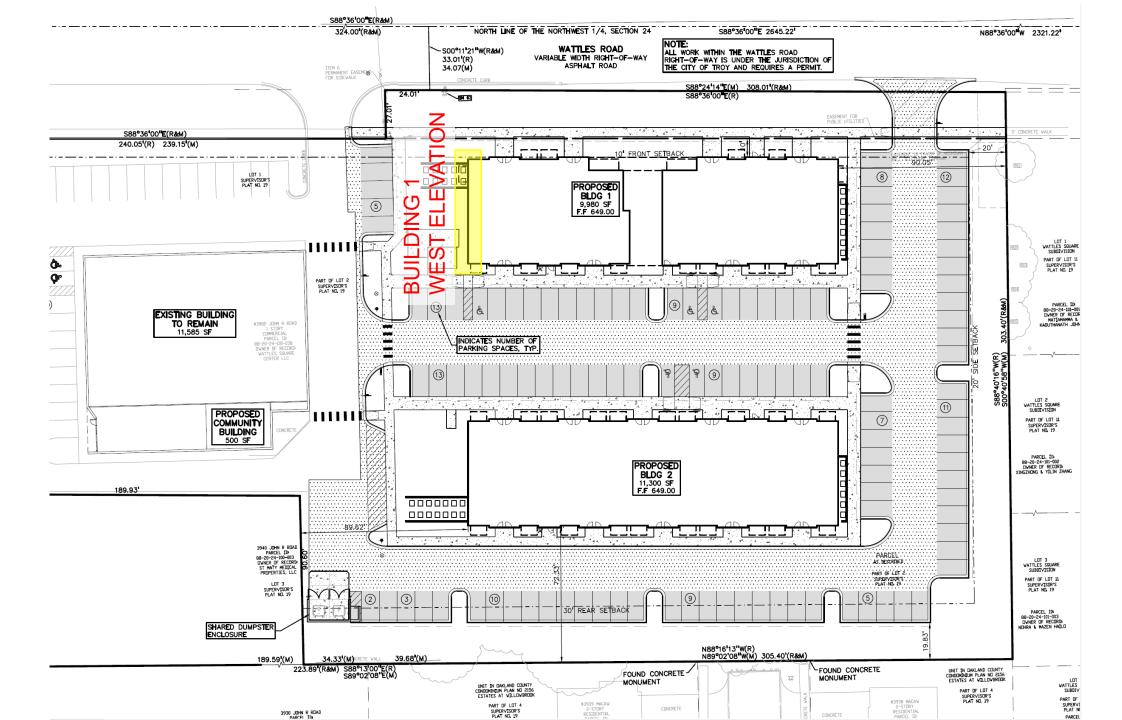

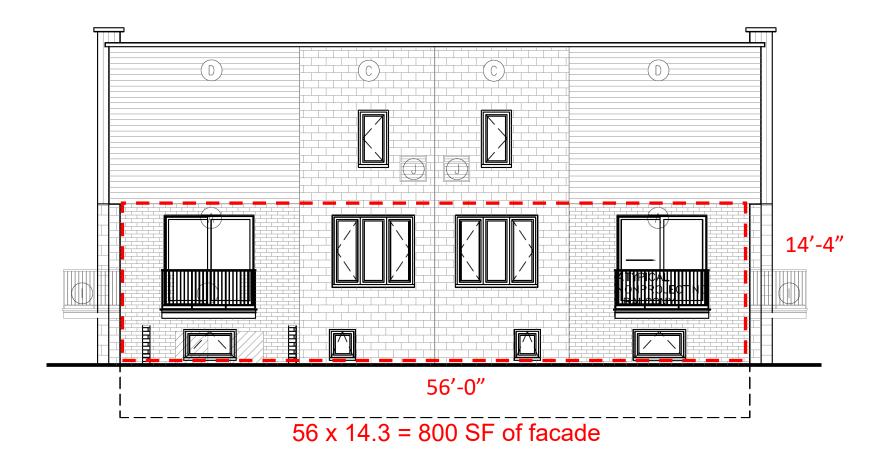

BUILDING 1- WEST ELEVATION


 $56' \times 14.3' = 800 SF of façade$

800 SF x . 3 = 240 SF


30% transparency = 240 SF

30% transparency = 240 SF



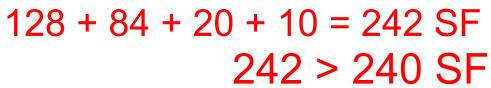




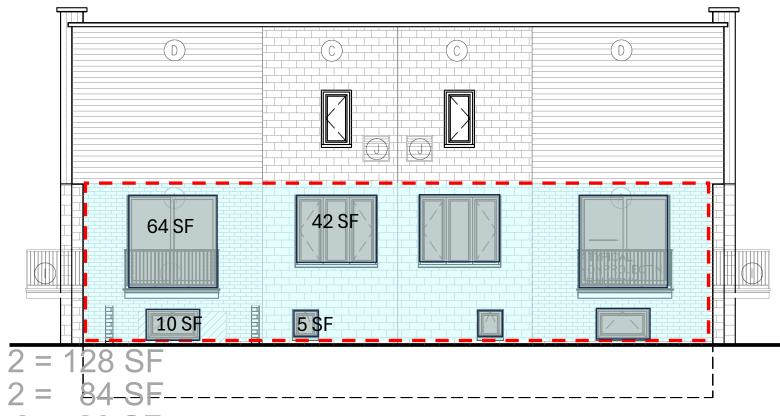

$$42 \, \text{SF} \, \text{x} \, 2 = 84 \, \text{SF}$$

$$10 \text{ SF x 2} = 20 \text{ SF}$$

$$5 \text{ SF x 2} = 10 \text{ SF}$$

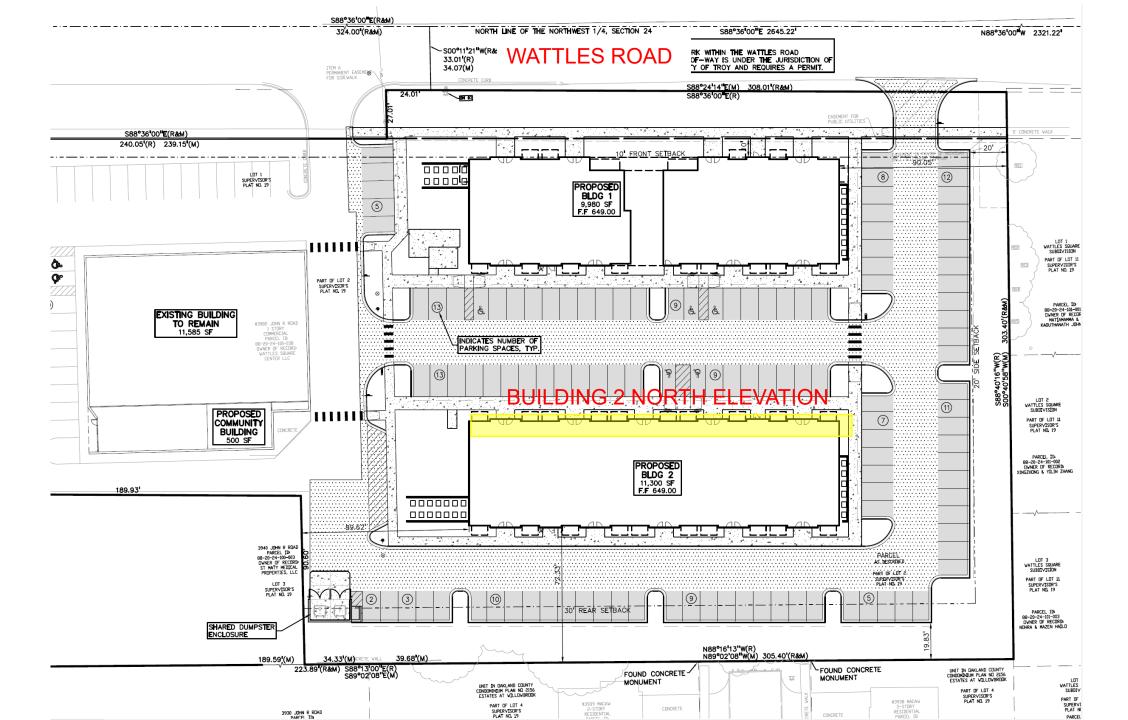



BUILDING 2- NORTH ELEVATION

 $198 \times 14.3 = 2831 \text{ SF of facade}$

 $198' \times 14.3' = 2831 \text{ SF of façade}$

2831 SF x .3 = 849 SF


30% transparency = 849 SF





1071 SF

BUILDING 2- NORTH ELEVATION

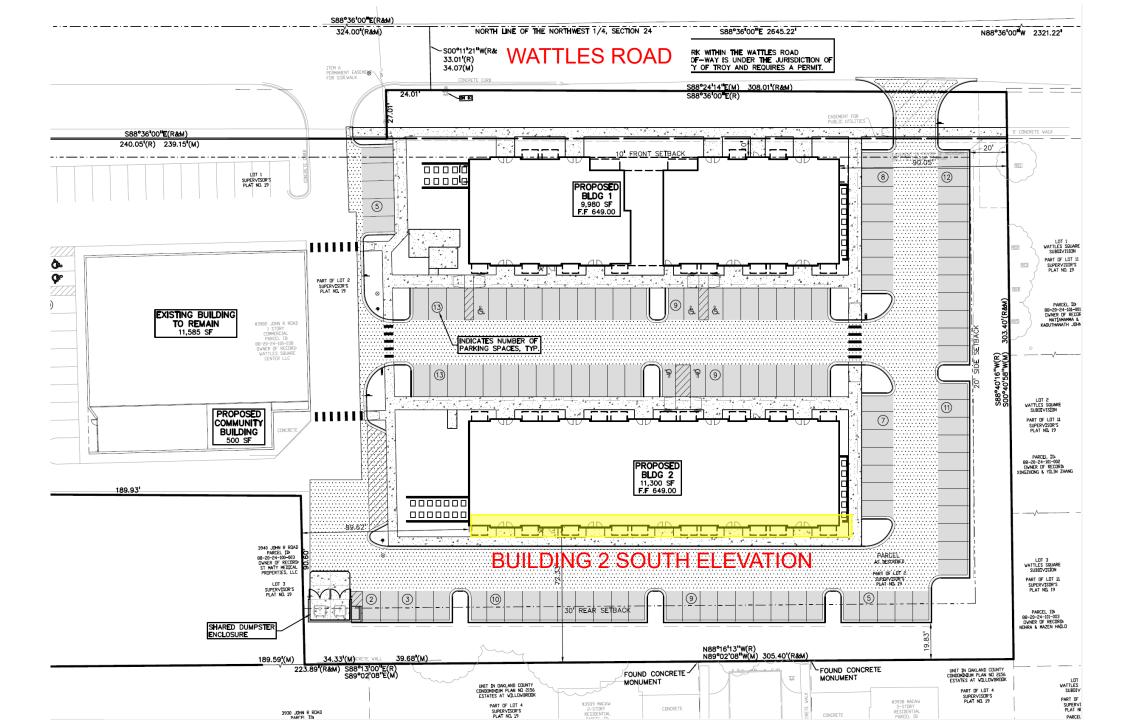



BUILDING 2- SOUTH ELEVATION

 $198 \times 14.3 = 2831 \text{ SF of facade}$

 $198' \times 14.3' = 2831 \text{ SF of façade}$


2831 SF x .3 = 849 SF


30% transparency = 849 SF





BUILDING 2- SOUTH ELEVATION

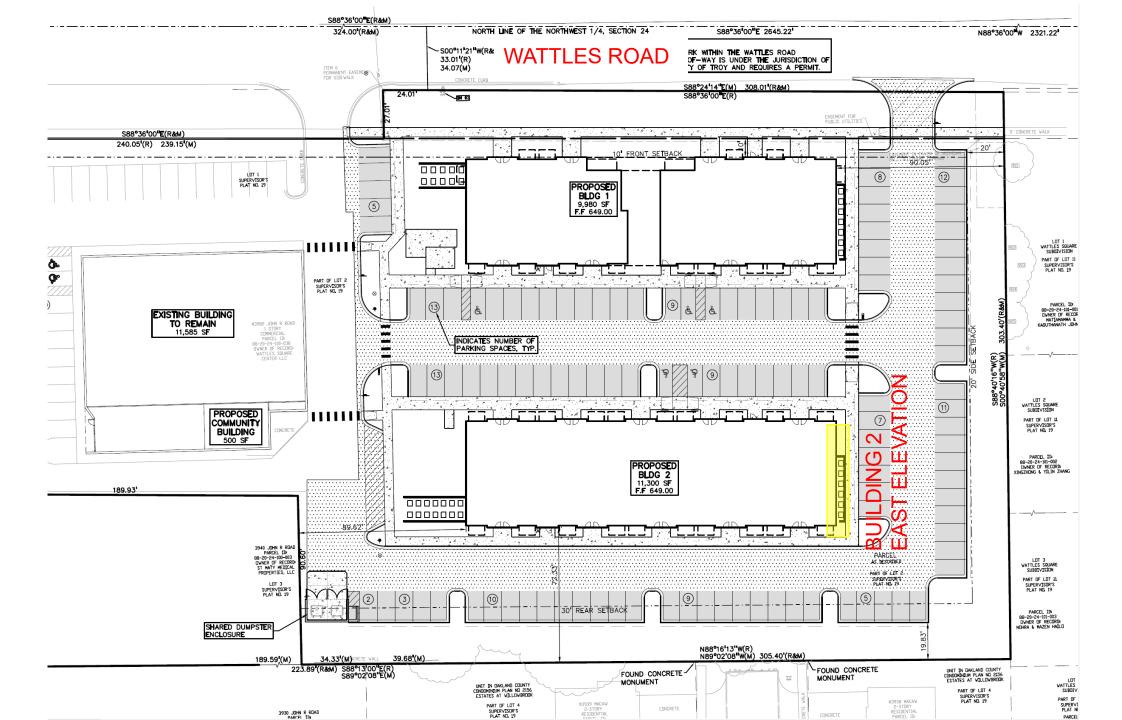

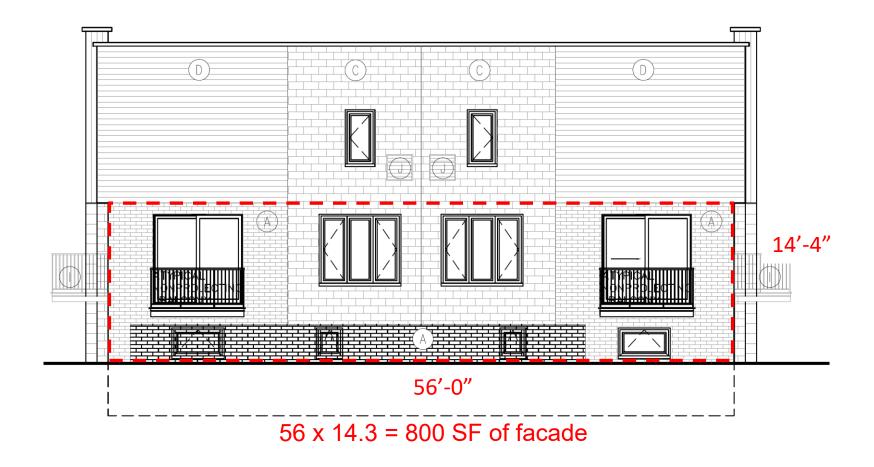

BUILDING 2- EAST ELEVATION

 $56' \times 14.3' = 800 SF of façade$

800 SF x . 3 = 240 SF


30% transparency = 240 SF

30% transparency = 240 SF




128 + 84 + 20 + 10 = 242 SF



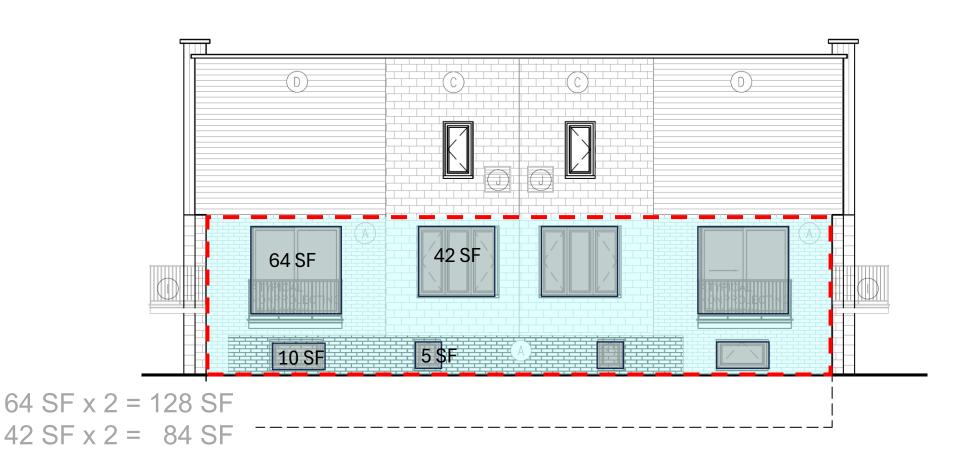


10 SF x 2 = 20 SF 5 SF x 2 = 10 SF 242 SF

BUILDING 2- EAST ELEVATION

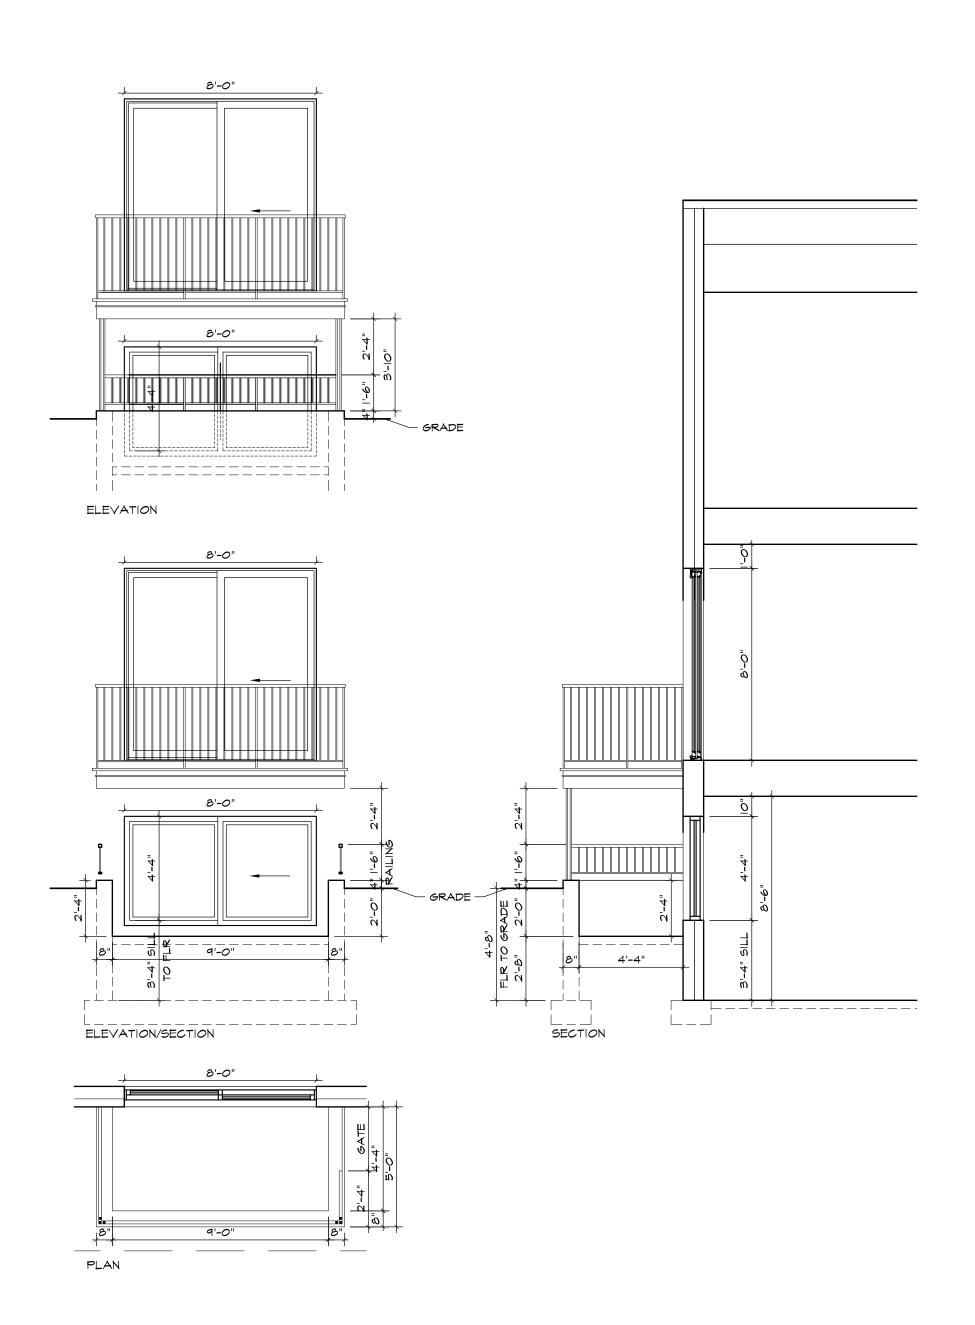

MATTLES SQUARE GARDEN LEVEL WINDOW WELL NORTH ELEVATION BLDG. I ONLY SECTION/PLAN/ELEVATIONS 1/4" = 1'-0" O7 MAY 24

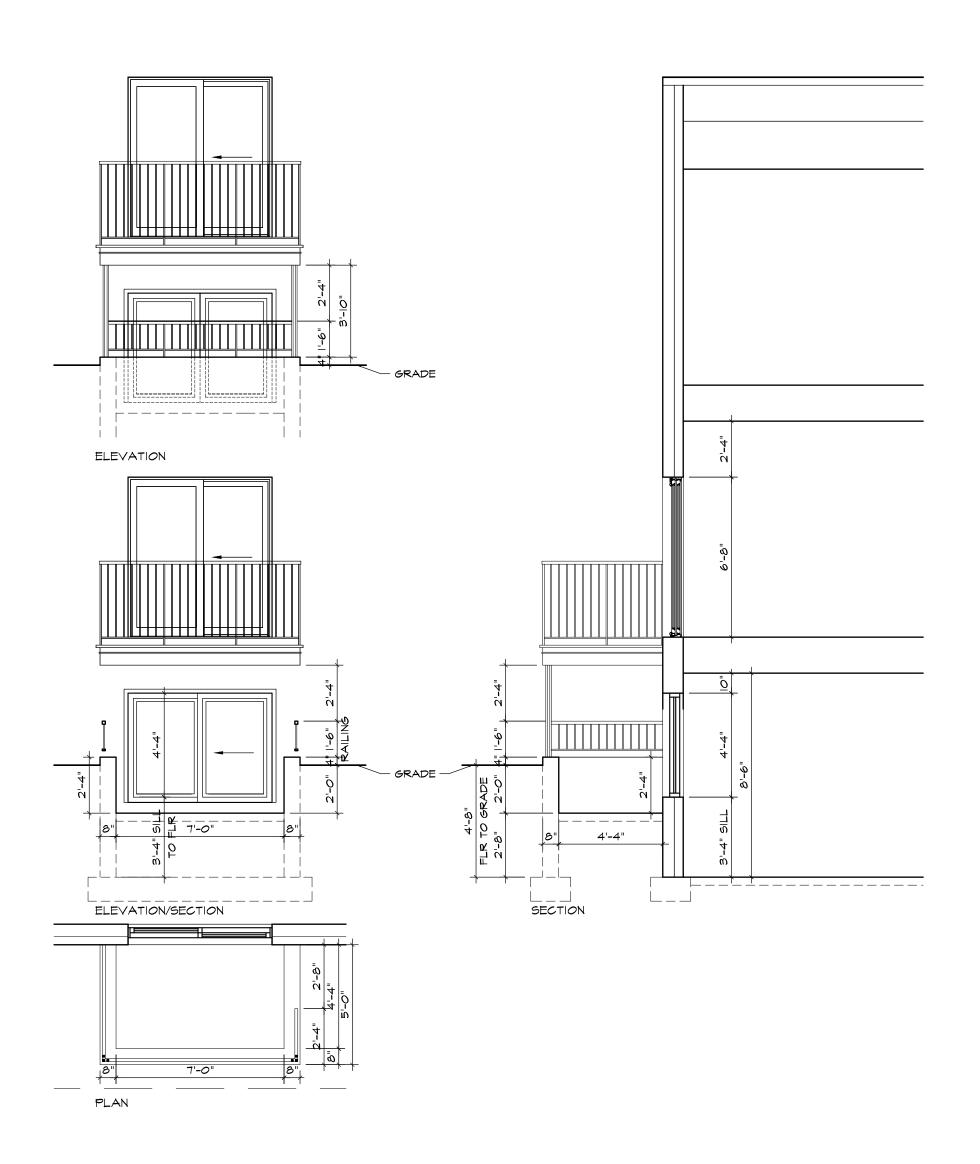

WATTLES SQUARE GARDEN LEVEL WINDOW WELL

TYP. ALL ELEVATIONS EXCEPT BLDG. I NORTH ELEVATION

SECTION/PLAN/ELEVATIONS

I/4" = I'-0" O7 MAY 24



Wattles Square Apartments - 3D view at balcony

archile + design

ITEM #7

DATE: May 22, 2024

TO: Planning Commission

FROM: R. Brent Savidant, Community Development Director

SUBJECT: PUBLIC HEARING – SPECIAL USE APPROVAL AND PRELIMINARY SITE PLAN

<u>REVIEW (SU JPLN2024-0006)</u> – Proposed Jax Kar Wash, South side of Long Lake, East of Livernois (102 East Long Lake Road), Section 15, Currently Zoned

NN (Neighborhood Node "M") Zoning District.

The petitioner BMW Kar Wash, LLC submitted the above referenced Special Use Approval and Preliminary Site Plan Approval application for a proposed Jax Kar Wash. Vehicle washes are permitted in the NN district, subject to special use approval.

The attached report prepared by Carlisle/Wortman Associates, Inc. (CWA), the City's Planning Consultant, summarizes the application. CWA prepared the report with input from various City departments including Planning, Engineering, Public Works and Fire. City Management supports the findings of fact contained in the report and recommends approval of the project, as noted.

Attachments:

- 1. Maps
- 2. Report prepared by Carlisle/Wortman Associates, Inc.
- 3. Special Use/Preliminary Site Plan application
- 4. Car Wash Community Noise Impact Study, prepared by K&S Engineers, LLC

G:\SPECIAL USE\SU_JPLN2024-0006_JAX KAR WASH\PC Memo 05 28 2024.docx

PROPOSED RESOLUTION

<u>PUBLIC HEARING – SPECIAL USE APPROVAL AND PRELIMINARY SITE PLAN REVIEW (SU JPLN2024-0006)</u> – Proposed Jax Kar Wash, South side of Long Lake, East of Livernois (102 East Long Lake Road), Section 15, Currently Zoned NN (Neighborhood Node "M") Zoning District.

Resolution # PC-2024-05-

Moved by: Seconded by:

RESOLVED, That Special Use Approval and Preliminary Site Plan Approval for the proposed Jax Kar Wash, South side of Long Lake, East of Livernois (102 East Long Lake), Section 15, Currently Zoned NN (Neighborhood Node "M") District, be (granted, subject to the following conditions):

) or
(denied, for the following reasons:) or
(postponed, for the following reasons:)
Yes: No: Absent:	

MOTION CARRIED / FAILED

TROY

GIS Online



288 0 144 288 Feet



Note: The information provided by this application has been compiled from recorded deeds, plats, tax maps, surveys, and other public records and data. It is not a legally recorded map survey. Users of this data are hereby notified that the source information represented should be consulted for verification.

TROY

GIS Online



288 0 144 288 Feet



Note: The information provided by this application has been compiled from recorded deeds, plats, tax maps, surveys, and other public records and data. It is not a legally recorded map survey. Users of this data are hereby notified that the source information represented should be consulted for verification.



117 NORTH FIRST STREET SUITE 70 ANN ARBOR, MI 48104 734.662.2200 734.662.1935 FAX

Date:

April 10, 2024

May 21, 2024

For City of Troy, Michigan

Applicant: BMW Kar Wash LLC

Project Name: Jax Troy

Location: 103 E Long Lake Road

Plan Date: March 8, 2024

Zoning: NN, Neighborhood Nodes ("M")

Action Requested: Preliminary Site Plan and Special Use Approval

SITE DESCRIPTION

An application has been submitted to construct a Jax Car Wash at 103 E Long Lake Road. This is the site of the former Kim's Restaurant, which closed in 2019 and has since remained vacant. The applicant intends to remove the existing building and reconfigure the site to accommodate a car wash facility. The site plans include a new 5,434 square foot building, nineteen (19) outdoor vacuum stations, and two (2) stacking lanes, with fourteen (14) stacking spaces.

The site is zoned NN-Neighborhood Nodes, Site Type A, in which auto/transportation uses require Special Use Approval.

Site Location:



Proposed Use of Subject Parcel:

One-story 5,434 square foot automatic car wash.

Current Zoning:

The property is currently zoned NN, Neighborhood Nodes (M) Form Based District, Site Type A.

Surrounding Property Details:

Direction	Zoning	Use
North	NN, Neighborhood Nodes (M)	Kroger/Multi-Tenant Building
South	R1-B, Single Family Residential	Single-Family Residential
East	NN, Neighborhood Nodes (M)	Childtime Learning Center
West	NN, Neighborhood Nodes (M)	Community Choice Credit Union

NATURAL FEATURES

Topography/Wetlands/Drain: The subject site is not located in a floodplain and contains no wetlands. Most of the site has already been graded for previous development.

Woodlands: A tree inventory has been provided by the applicant. No existing trees at this site are considered Landmark or Woodland trees. There are seven (7) existing trees on site, all of which are invasive species including American Elm, Box Elder, and Black Locust. The applicant proposes to remove five (5) and save two (2) trees. As invasive species, replacement of the five (5) trees is not required. One (1) Box Elder in fair condition and one (1) American Elm in good condition are being saved.

Replacement Details				
Protected Tree	Inches Removed	Replacement Required		
Landmark	0 inches	0 inches		
Woodland	0 inches	0 inches		
Preservation/Mitigation	Inches Preserved	Credit		
Landmark	0 inches	0 inches		
Woodland	0 inches	0 inches		
Total 0 inches required for replacement.				

Items to be Addressed: None.

MASTER PLAN

While still zoned Neighborhood Node (NN), in the adopted version of the Master Plan, the future land use for this site was removed from Neighborhood Nodes. The recommendation is to rezone this intersection for general commercial uses.

AREA, WIDTH, HEIGHT, SETBACKS

The proposed building is being reviewed under Building Form A.

	Required	Provided	Compliance
Front (North)	10-foot build-to-line	10 feet	Complies
Side (East)	N/A, building may be placed up to property line	33.71 feet	Complies
Side (West)	N/A, building may be placed up to property line	82.62 feet	Complies
Rear (South)	30-foot minimum setback	151.75 feet	Complies
Building Height (Neighborhood Nodes)	Any building, or portion of a building, on a parcel abutting a one-family residentially zoned parcel shall not exceed 2.5 stories/30 feet in height	1 story, 25.58 feet	Complies
Open Space	30%	42%	Complies

Items to be Addressed: None.

PARKING

	Required	Provided	Compliance
Vehicle Wash:			
2 spaces, plus 12 stacking spaces per bay	(2 spaces + 12 stacking spaces)	26 stacking spaces	
, ,	= 14 spaces	+	
1 space per employee on	+	6 standard spaces	
largest typical shift	(1 space * 3 employees)	+	See Below
	= 3 spaces	T	
		19 vacuum spaces	
	= 17 spaces total		
		= 51 spaces total	
Loading	1 space	1 space	Complies
Barrier Free	1 space	1 space	Complies

Jax Troy May 21, 2024

Including parking for vacuum spaces, the applicant has proposed 200% more parking than is required. Excessive parking increases heat island effect and contributes to high rates of stormwater runoff. For these reasons, the City requires applicants to receive approval when exceeding parking requirements by over 20%. We requested an explanation and documented evidence as to why additional stacking spaces and the total number of vacuum stations are needed.

When asked about the number of vacuum stations the applicants response:

Based upon Jax Kar Wash years of experience operating multiple car wash locations in the Detroit Area, they feel that the number of vacuum spaces provided is appropriate for the effective operation of this car wash. The projected volume for this site is how they determine the number of vacuum and stacking spaces. They are also based upon the demographics in the area.

Items to be Addressed: Planning Commission to discuss the number of vacuum spaces.

TRAFFIC and CIRCULATION

Vehicular Traffic:

The site has one (1) point of access via Long Lake. The access point allows for two-way traffic via a 25-foot wide aisle. Upon entry, there are two (2) areas on site in which patrons will occupy: the car wash lane and/or the vacuum station area.

The car wash stacking lane begins at the south end of the site with traffic heading east via two (2) 11-foot wide lanes, each with their own kiosk at the end. Once patrons visit the kiosk, these (2) stacking lanes merge into one (1) 13-foot wide stacking lane and traffic heads north towards the entrance of the building. Patrons then move westbound through the automatic car wash and turn right (north) to exit the site. For patrons who choose to exit the stacking lane prior to receiving a car wash, a 13-foot wide exit route is provided, allowing drivers to then move westbound through the vacuum area and leave the site.

Automatic vacuum stations are located in a parking lot behind the building, in the center of the site. The parking lot includes a 24-foot wide aisle which allows for two-way traffic; however, there is no exit to the east. Drivers must turn around within the lot and exit the area from the access point to the west.

Pedestrian Access:

The applicant is increasing the sidewalk along Long Lake to 8-feet in width, and tying the new sidewalk to the building.

Traffic and circulation has been reviewed by the City's Engineering and Fire Departments. Those comments have been addressed by the applicant.

Items to be Addressed: None

LANDSCAPING

A landscaping plan has been provided on Sheet L-1.0. The following table discusses the development's compliance with the landscape requirements set forth in Section 13.02.

	Required	Provided	Compliance
Long Lake Road: One (1) deciduous tree for every thirty (30) lineal feet, or fraction thereof, of frontage abutting a public road right-of-way.	250 LF/30= 8 trees	9 trees	Complies
Site Landscaping: A minimum of 20% of the site area shall be comprised of landscape material.	20%	43.18%	Complies
Screening Between Uses: South/Residential: One (1) large evergreen tree per ten (10) lineal feet and/or wall OR One (1) narrow evergreen tree per five (5) lineal feet and/or wall West/Retail: One (1) narrow evergreen tree per three (3) lineal feet and/or wall	South: 205 LF/10= 20.5 trees West: 149 LF/3 = 53 trees	South: 25 large evergreen trees and existing concrete wall West: One (1) narrow evergreen tree per three (3) lineal feet and/or wall	South: Complies West: Complies
Parking Lot Trees: 1 per 8 spaces	25 parking lot spaces/8= 3 parking lot trees	5 trees	Complies

Mechanical Equipment:

The plans indicate that an electric transformer shall be placed upon a concrete pad with no screening and screened with landscaping.

Jax Troy May 21, 2024

Trash Enclosure:

The trash enclosure will be screened with a 6-foot tall masonry block wall. The wall shall match the architecture of the building.

Stormwater Management:

No information has been provided regarding water reclamation and recycling. Similarly, the applicant has not addressed the potential runoff of pollutants or freezing concerns.

The applicant has noted:

The project does not propose the installation of a water reclamation/recycling system. The storm water for the development will be collected, treated, and managed on-site with the proposed underground storm water management system.

We encourage water reclamation and recycling system. Applicant should describe why a water reclamation and recycling system is not used.

Items to be Addressed: Describe why a water reclamation and recycling system is not used.

PHOTOMETRICS

The applicant proposes six (6) freestanding pole lights and fourteen (14) wall mounted lights. Proposed fixture designs and lighting levels are compliant with zoning regulations. Each pole light shall measure 20 feet in height and each wall mounted light shall measure 10 feet in height.

Items to be Addressed: None.

FLOOR PLAN AND ELEVATIONS

Floor Plans:

The building on site is roughly 132-feet wide and 46-feet deep. The front portion of the building (north side) is roughly 26-feet deep and contains the wash tunnel where patrons will receive their car wash. The rear portion of the building is roughly 20-feet deep and includes an equipment area, break room, cleaning room, manager's office, and two (2) individual restrooms.

The equipment area and vacuum room are accessible via the wash tunnel and/or an entry on the west side of the building. The area with the break room, cleaning room, office, and restrooms is accessible via the wash tunnel and/or rear entry on the south side of the building. There is no direct connection between the equipment area/vacuum room and these other rooms.

South of the building are nineteen (19) outdoor vacuum stations arranged in two (2) rows.

Elevations:

Overall building height is 25 feet 7 inches. The applicant has provided 50% transparency for the front façade and over 30% for each façade facing a side yard or parking area.

Several materials are proposed for all four (4) building façades. Exterior walls are largely comprised of full dimensional veneer and horizontal lap siding. Other materials include brick veneer, recessed brick soldier course, fascia trim, and asphalt shingles. Tinted windows and doorways with clear windows are proposed along each façade with metal coping and metal frames. Exterior building colors are dark blue, yellow, white, and light brown as shown below.



Colored Renderings Received May, 22, 2024.

Items to be Addressed: None.

CARWASH USE

We have noted a significant increase in the number of carwash applications in the Troy and the region. Recently, the City approved a carwash at Oakland Mall, considered a Jax Carwash on Big Beaver, and have an application for a carwash at Long Lake and Dequindre.

The proliferation in carwashes is due to private equity funding and shift to monthly subscription based model:

https://www.bloomberg.com/news/features/2024-02-21/car-washes-are-taking-over-the-us-here-s-why?embedded-checkout=true

While reusing dilapidated and vacant sites, carwashes are also land consumptive, generate few jobs, and can lead to increased traffic congestion and environmental concerns. Of particular concern is that carwash buildings require heavy ongoing investments, resource dependent, and are singular use and cannot be repurposed, such as a retail store, office, or hotel.

In response the applicant has noted:

Jax Kar Wash has an extensive history of owning and operating successful car washes in the Detroit Area for over 70 years. They do extensive research to determine the potential locations for new facilities.

There are no car washes on Long Lake Road. The population in this area is very dense. 6,300 within 1 mile and 74,457 within 3 miles. Traffic counts (VPD) are also extremely strong at 39,262 VPD on East Long Lake and 27,986 VPD on Livernois Road. It also fills a geographical need for Jax. 75% of Jax customers use multiple Jax locations. This location on East Long Lake falls in the middle of our existing Troy location (3.7 miles to the south) and our Rochester location (3.4 miles to the north).

If this site should "fail", it would likely be rebranded for use as a car wash by another operator. If the car wash operation in this location is not viable for another operator, it would be likely completely redeveloped for another commercial use.

Items to be Addressed: Planning Commission to consider the use.

SPECIAL USE APPROVAL STANDARDS

Table 5.06.C-1 illustrates that auto/transportation uses are considered a special use for Neighborhood Nodes Site Type NN:A.

For any special use, according to Section 9.02.D, the Planning Commission shall "...review the request, supplementary materials either in support or opposition thereto, as well as the Planning

Department's report, at a Public Hearing established for that purpose, and shall either grant or deny the request, table action on the request, or grant the request subject to specific conditions." Section 9.03 states that before approving any requests for Special Use Approval, the Planning Commission shall consider:

- 1. Compatibility with Adjacent Uses.
- 2. Compatibility with the Master Plan.
- 3. Traffic Impact.
- 4. Impact on Public Services.
- 5. Compliance with Zoning Ordinance Standards.
- 6. Impact on the Overall Environment. The proposed Special Use shall no
- 7. Special Use Approval Specific Requirements.

Items that the Planning Commission should consider when reviewing the application:

- General context of the property
- Intended automotive use of the property
- The use and number of carwashes in the city and general area
- Traffic and circulation
- Impacts (noise, light, odor, etc) upon adjacent properties

SITE PLAN REVIEW STANDARDS

<u>Section 8.06 outlines Site Plan Review Design Standards.</u>

- 1. Development shall ensure compatibility with existing commercial districts and provide a transition between land uses.
 - a. Building design shall enhance the character of the surrounding area in relation to building and parking placement, landscape and streetscape features, and architectural design.
 - b. Street fronts shall provide a variety of architectural expression that is appropriate in its context and prevents monotony.
 - c. Building design shall achieve a compatible transition between areas with different height, massing, scale, and architectural style.
- 2. Development shall incorporate the recognized best architectural building design practices.
 - a. Foster a lasting impact on the community through the provision of high quality design, construction, and detailing.
 - b. Provide high quality, durable materials, such as but not limited to stone, brick, glass, and metal. E.I.F.S. or material equivalent shall only be used as an accent material.
 - c. Develop buildings with creativity that includes balanced compositions and forms.
 - d. Design roofs that are appropriate to the architectural style of the building and create an appropriate visual exterior mass of the building given the context of the site.

- e. For commercial buildings, incorporate clearly defined, highly visible customer entrances using features such as canopies, porticos, arcades, arches, wing walls, ground plane elements, and/or landscape planters.
- f. Include community amenities that add value to the development such as patio/ seating areas, water features, art work or sculpture, clock towers, pedestrian plazas with park benches or other features located in areas accessible to the public.
- 3. Enhance the character, environment and safety for pedestrians and motorists.
 - a. Provide elements that define the street and the pedestrian realm.
 - b. Create a connection between the public right of way and ground floor activities.
 - c. Create a safe environment by employing design features to reduce vehicular and pedestrian conflict, while not sacrificing design excellence.
 - d. Enhance the pedestrian realm by framing the sidewalk area with trees, awnings, and other features.
 - e. Improve safety for pedestrians through site design measures.

SUMMARY

The Planning Commission is asked to consider the proposed use, consumer demand, hold a public hearing, consider testimony, and deliberate the following:

- 1. Compliance with Special Use Standards
- 2. Compliance with Site Plan Review Standards
- 3. Why is a water reclamation and recycling system not used?

Sincerely,

CARLISLE/WORTMAN ASSOC., INC. Benjamin R. Carlisle, AICP, LEED AP

President

CARLISLE/WORTMAN ASSOC., INC.

Shana Kot

Community Planner

PEA GROUP

1849 Pond Run Auburn Hills, MI 48326

844.813.2949 peagroup.com

April 29, 2024

Project No.: 23-1373

Mr. R. Brent Savident, Community Development Director City of Troy Planning Department 755 West Big Beaver Troy, Michigan 48083

RE: Jax Kar Wash (102 East Long Lake Road)

Dear Mr. Savidant:

Our office is in receipt of the various review letters prepared by the various City Department and the City's Planning and Traffic consultants regarding the subject parcel. Based upon the review comments in the various review letters received, please note following response regarding the comments:

OHM (4-24-2024)

It appears that this building is not set back from Big Beaver appropriately. Verify that the master plan ROW is 150' and adjust the location of the building.

The plans have been revised to reflect the additional right-of-way.

The site driveway needs to be 30-feet wide at the road right-of-way line. It can then taper to the 25' width noted on the plans.

The plans have been revised to provide for the requested 30' wide drive width.

The sidewalk within the site does not connect to each other and appears randomly placed. Organize a smoother pedestrian route throughout the site, including a connection to the path along Big Beaver Rd.

Based upon the revised site plan layout the sidewalks have been revised to provide better routing.

How are the stacking lanes delineated? Will there be striping, curbs? Label accordingly.

The staking lanes will be delineated with pavement striping.

Provide DO NOT ENTER and WRONG WAY signs for the parking / vacuum area so customers don't try to enter the queue for the car wash.

The requested signs have been added to the revised plans.

The path along Big Beaver must cross this site's driveway at right angles, not angled as shown. Adjust the angled sidewalk segment on the northeast corner of the driveway approach.

Based upon the revised site plan layout the sidewalks have been revised to provide better routing.

The sidewalk along the west side of the site aligns with vehicles exiting the car wash. This needs to be changed. It might be better to run sidewalk along the west side of the site driveway and cross where the 7-foot site sidewalk starts.

Due to the proposed use, we do not feel that a walkway connection to Long Lake Road is necessary. This section of the internal sidewalk is provided for two specific purposes; (1) to allow access from the building to the trash dumpster; (2) to allow access to the loading/unloading area. If the City and its consultant determine that this section of sidewalk is necessary, we will open to installing it. Please be advised this will eliminate a section of the landscaping requested by the Planning Consultant in their review letter.

The sidewalk ramp should not be placed in the middle of the sidewalk. It should instead be adjacent to the hatched our parking space.

The sidewalk ramp has been revised.

CWA (04-10-2024):

Provide explanation and documented evidence to justify additional stacking spaces and the number of vacuum stations.

Based upon Jax Kar Wash years of experience operating multiple car wash locations in the Detroit Area, they feel that the number of vacuum spaces provided is appropriate for the effective operation of this car wash. The projected volume for this site is how they determine the number of vacuum and stacking spaces. They are also based upon the demographics in the area. See below for the demographics noted in the respond to the customer demand.

Address circulation issues identified in report.

Based upon the revised site plan layout the sidewalks have been revised to provide better routing.

Address traffic and circulation identified by OHM, and the Engineering and Fire Department.

The traffic and circulation issues have been addressed with the plan revisions.

Provide landscape screening on the west lot line.

Landscape screening had been added along the west property line. Please be advised that the Traffic Consultant has requested that "the sidewalk along the west side of the site aligns with vehicles exiting the car wash. This needs to be changed. It might be better to run sidewalk along the west side of the site driveway and cross where the 7-foot site sidewalk starts". If this section of sidewalk is installed it will eliminate a section of the landscaping requested.

_

Provide parking lot landscaping in compliance with Section 13.02(C).

The required parking lot landscaping requirement has been addressed with the revised plans.

Provide mechanical equipment screening.

The ground mounted equipment screening has been provided.

Describe systems in place for water reclamation and recycling, mitigation of runoff, and freezing concerns.

The project does not propose the installation of a water reclamation/recycling system. The storm water for the development will be collected, treated, and managed on-site with the proposed underground storm water management system.

Provide fully transparent windows.

Fully transparent windows have been provided.

Provide evidence of consumer demand for this site and how the building could be repurposed if the use were to fail.

Jax Kar Wash has an extensive history of owning and operating successful car washes in the Detroit Area for over 70 years. They do extensive research to determine the potential locations for new facilities.

There are no car washes on Long Lake Road. The population in this area is very dense. 6,300 within 1 mile and 74,457 within 3 miles. Traffic counts (VPD) are also extremely strong at 39,262 VPD on East Long Lake and 27,986 VPD on Livernois Road. It also fills a geographical need for Jax. 75% of Jax customers use multiple Jax locations. This location on East Long Lake falls in the middle of our existing Troy location (3.7 miles to the south) and our Rochester location (3.4 miles to the north).

If this site should "fail", it would likely be rebranded for use as a car wash by another operator. If the car wash operation in this location is not viable for another operator, it would be likely completely redeveloped for another commercial use.

Engineering Department by Antonio Cicchetti

What is the proposed pathway of refuse collection trucks? It appears they may need to turn around inside the parking lot which will be difficult with parked vehicles in the way.

Based upon our turning analysis, the trash truck can make the necessary movement without impacting the parked cars in the vacuum spaces.

The relocated hydrant is too close to the proposed building. Needs to be minimum 25' away from all sides.

Noted.

Provide a demolition plan showing the limits of all the removals, including the existing 24" storm sewer.

A demolition plan will be provided during the engineering review.

_

Show the existing 12' wide storm sewer easement across this property and into the property to the east. A portion of this easement will need to be vacated and replaced with a new easement based on the route of the proposed storm sewer.

The easement has been provided.

No permanent structures are allowed along the path of the existing and new storm sewer easement.

Noted.

The existing sanitary lead for the old building should be used if it is in good condition. It will need to be located during demolition, cleaned, and televised.

Noted.

The internal sidewalk along the exit of the car wash appears to serve no purpose. Remove or provide explanation.

This section of the internal sidewalk is provided for two specific purposes; (1) to allow access from the building to the trash dumpster; (2) to allow access to the loading/unloading area.

The proposed sidewalk & approach improvements at the site entrance are unacceptable. The proposed sidewalk does not align with the existing sidewalk to the west. Also, the proposed ramps are directing pedestrians right into vehicles exiting the car wash. Also, the radius crosses the property line extended. The whole layout needs to be re-designed.

The plans have been revised to improve the issues noted above.

A 30' wide approach is required for commercial developments.

The plans have been revised to provide for the requested 30' wide drive width.

Storm Detention calculations will be required during final site plan review.

Noted.

RCOC Permit required for work in Long Lake Road ROW.

Noted.

Traffic Engineer by Scott Finlay

The master plan right of way at this location on Long Lake is 150 feet. 75 feet on each side, the proposed site needs to be built to the master plan right of way, not the existing 60 feet.

The plans have been revised to reflect the additional right-of-way.

The sidewalk needs to cross driveways perpendicular and cannot cross into the exit for cars leaving the car wash.

_

Based upon the revised site plan layout the sidewalks have been revised to provide better routing.

Parking stalls can be 17 feet as opposed to 20 feet as shown on the plans.

The Jax Kar Wash Standard parking stall depths are 20'. This is done for the purpose of allow for sufficient space for the vacuuming of cars.

All sidewalk along Long Lake will need to be removed and replaced.

The plans have been revised to reflect this request.

Provide acceleration taper.

The plans have been revised to reflect this request.

Water & Sewer by Water & Sewer

If hydrant is relocated requires new hydrant with two four inch nozzles.

Noted.

If you should have any questions, please feel free to contact this office.

Sincerely,

PEA Group

James P. Butler, PE


Principal/Project Executive

PRELIMINARY SITE PLANS

JAX TROY

103 EAST LONG LAKE ROAD CITY OF TROY, OAKLAND COUNTY, MICHIGAN



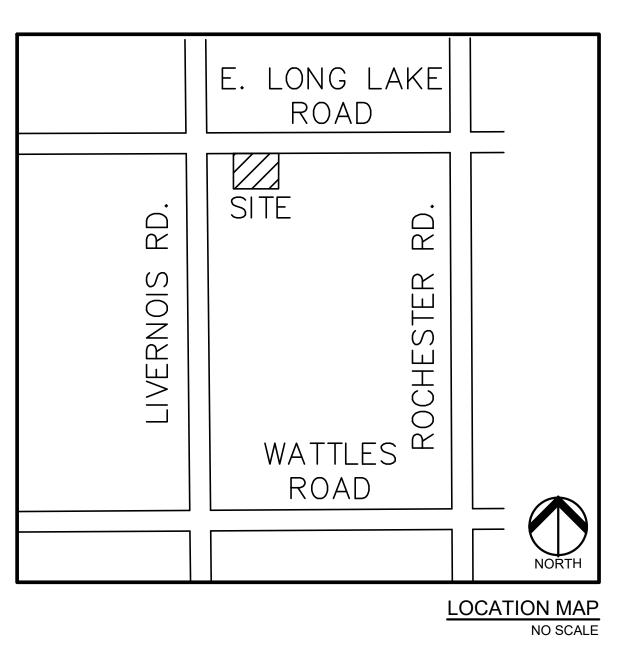

	INDEX OF DRAWINGS
NUMBER	TITLE
	COVER SHEET
C-1.0	TOPOGRAPHIC SURVEY
C-3.0	PRELIMINARY SITE PLAN
C-4.0	PRELIMINARY GRADING PLAN
C-6.0	PRELIMINARY UTILITY PLAN
C-9.0	NOTES AND DETAILS
L-1.0	LANDSCAPE PLAN
L-1.1	LANDSCAPE DETAILS
	ARCHITECTURAL PLANS
PE-4A	BUILDING ELEVATIONS
PE-4B	PAY STATION/VACCUM ELEVATIONS
PFP-4	PRELIMINARY OVERALL FLOOR PLAN
PH-1	PHOTOMETRIC PLAN

DESIGN TEAM

APPLICANT

BMW KAR WASH, LLC 26777 CENTRAL PARK, S-180 SOUTHFIELD, MI 48034 CONTACT: TODD GESUND PHONE: 7248-514-5565 EMAIL: TODD@JAXKARWASH.NET

ARCHITECT

DATE SUBMITTED DATE APPROVED PERMIT / APPROVAL

F.A. STUDIO 26261 EVERGREEN ROAD SOUTHFIELD, MI CONTACT: DAVID BRINKMEIER PHONE: 248.619.2354 EMAIL: DBRINKMEIER@FA.STUDIO CIVIL ENGINEER

PEA GROUP 1849 POND RUN AUBURN HILLS, MI 48326 CONTACT: JAMES P. BUTLER, PE PHONE: 844.813.2949 EMAIL: JBUTLER@PEAGROUP.COM

LANDSCAPE ARCHITECT

PEA GROUP 7927 NEMCO WAY, STE. 115 BRIGHTON, MI 48116 CONTACT: JANET EVANS, PLA PHONE: 844.813.2949 EMAIL: JEVANS@PEAGROUP.COM

GROUP

REVISIONS		
DATE		
3/8/2024		
4/26/2024		

LEGEND

-OH-ELEC-V-O-C **ELEC., PHONE OR CABLE TV O.H. LINE, POLE & GUY WIRE**

IRON FOUND BRASS PLUG SET X IRON SET MONUMENT FOUND MAIL FOUND MONUMENT SET Ø NAIL & CAP SET

-UG-CATV-TV UNDERGROUND CABLE TV, CATV PEDESTAL

GAS MAIN, VALVE & GAS LINE MARKER

SANITARY SEWER, CLEANOUT & MANHOLE — – — STORM SEWER, CLEANOUT & MANHOLE

-W-UG-PHONE-T TELEPHONE U.G. CABLE, PEDESTAL & MANHOLE

R RECORDED M MEASURED C CALCULATED

REFERENCE DRAWINGS: CITY OF TROY, GIS MAP, DATED 7/15/2019 DTE, FACILITY MAP, DATED 7/24/2019

CONSUMERS ENERGY MAP, DATED 1/31/2024

TREE LIST TAG CODE DBH COMMON NAME LATIN NAME COND COMMENTS Fair 163 BX Good Acer negundo 164 BL 7 Robinia pseudoacacia Fair Black Locust Acer negundo Fair Dead Black Locust Robinia pseudoacacia Box elder Fair Acer negundo Good American Elm Ulmus americana

THERE WAS NO EVIDENCE OF POTENTIAL WETLANDS OBSERVED ON THE SUBJECT PROPERTY AT THE TIME THE SURVEY WAS CONDUCTED. THE SURVEYOR HAS NOT BEEN PROVIDED ANY DOCUMENTATION OF ANY WETLANDS BEING LOCATED ON THE SUBJECT PROPERTY.

FLOODPLAIN:
BY GRAPHIC PLOTTING, THE SUBJECT PARCEL IS IN "AREAS DETERMINED TO BE OUTSIDE OF THE 0.2% ANNUAL CHANCE FLOODPLAIN." (ZONE X) PER FEMA FLOOD INSURANCE RATE MAP PANEL NUMBER 26125C0534F, EFFECTIVE DATE FEBRUARY 29, 2006

BENCHMARKS (GPS DERIVED - NAVD88)

> SET PUNCH MARK ON HYDRANT ARROW 40.7' NORTH OF NORTHEAST CORNER OF KIMS RESTURANT SOUTH SIDE OF EAST LONG LAKE ROAD

BM #301
SET PUNCH MARK ON HYDRANT ARROW 155.1' NORTH OF NORTHEAST CORNER OF KIMS RESTURANT IN MEDIAN OF EAST LONG LAKE ROAD

CORNER OF KIMS RESTURANT IN MEDIAN OF EAST LONG LAKE ROAD ELEV. — 708.27

BM #302

SET PUNCH MARK ON NORTH BOLT OF TOP FLANGE OF HYDRANT 56.8' NORTH OF NORTHWEST CORNER OF CHILDTIME LEARNING CENTERS SOUTH SIDE OF EAST LONG LAKE ROAD ELEV. — 705.55

GROUP t: 844.813.2949 www.peagroup.com

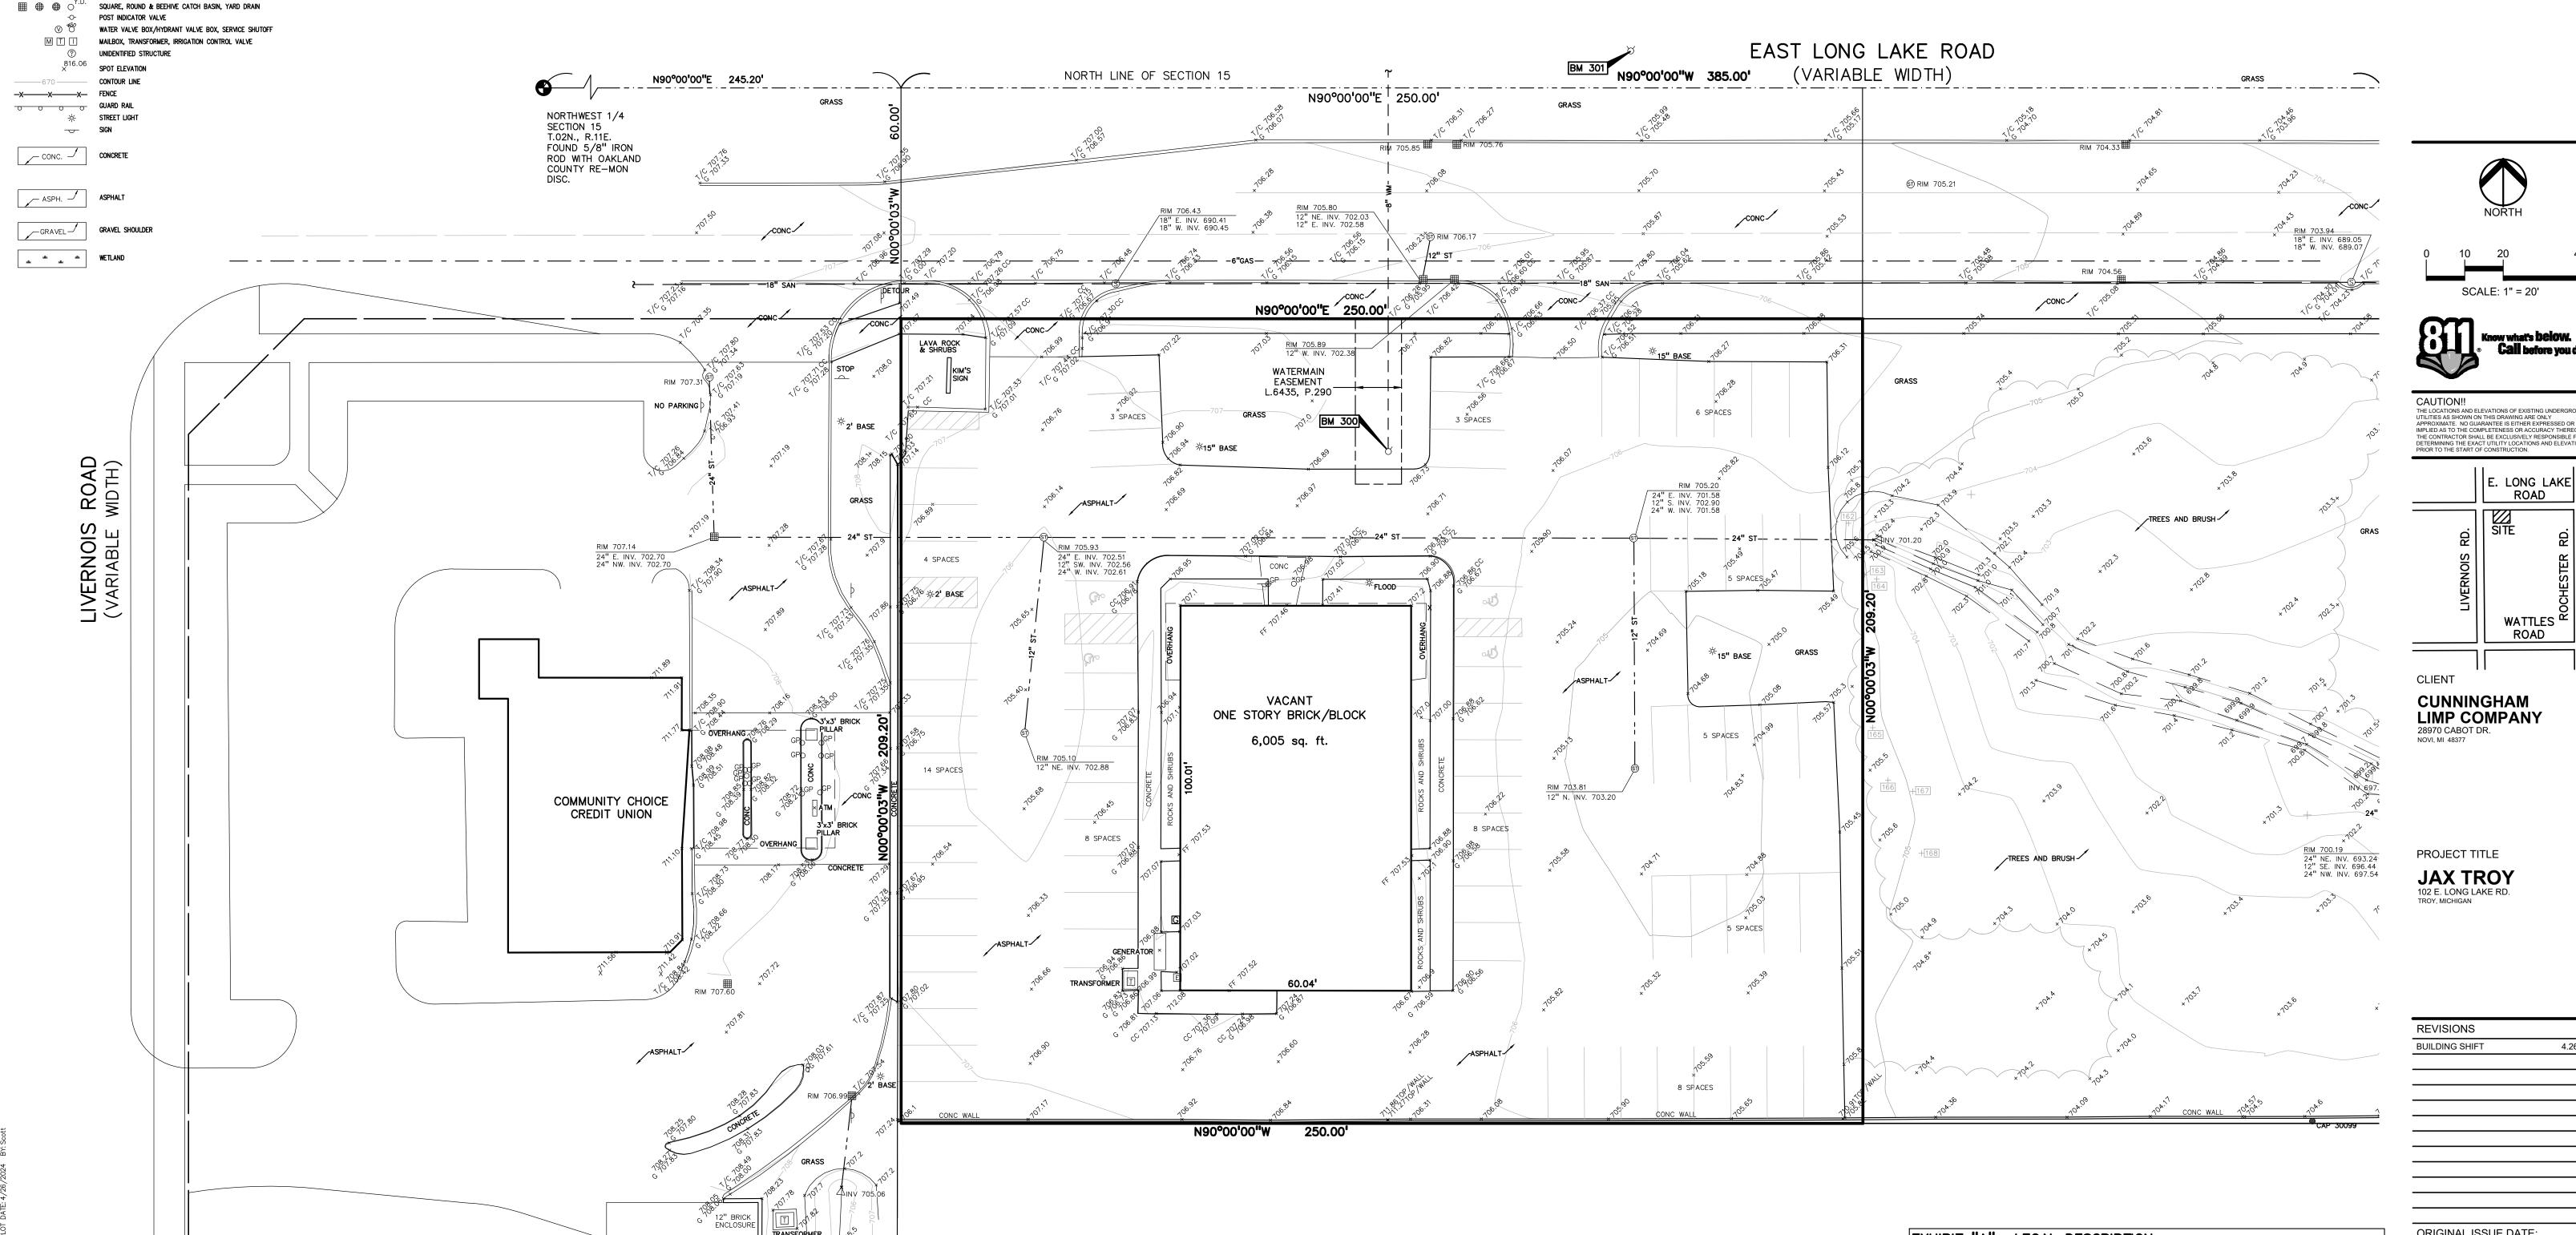


EXHIBIT "A"- LEGAL DESCRIPTION

Issuing Agent: ATA National Title Group, LLC Issuing Office File Number: 63—24901750—SCM Commitment Date: January 19, 2024

The Land is described as follows: Situated in the City of Troy, County of Oakland, State of Michigan

<u>Fee Parcel</u>


The East 250.00 feet of the West 495.20 feet of the North 269.20 feet of the Northwest 1/4 of the Northwest 1/4 of Section 15, Town 2 North, Range 11 East, City of Troy, Oakland County, Michigan, EXCEPT the North 60.00 feet used for road purposes.

Easement Parcel

Together with the rights and easements as created, limited and defined in Cross Access—Joint Drive Easement recorded in Liber 37677, Page 639, Oakland County Records.




THE LOCATIONS AND ELEVATIONS OF EXISTING UNDERGROUUTILITIES AS SHOWN ON THIS DRAWING ARE ONLY UTILITIES AS SHOWN ON THIS DRAWING ARE ONLY APPROXIMATE. NO QUARANTEE IS EITHER EXPRESSED OR IMPLIED AS TO THE COMPLETENESS OR ACCURACY THEREOF. THE CONTRACTOR SHALL BE EXCLUSIVELY RESPONSIBLE FOR DETERMINING THE EXACT UTILITY LOCATIONS AND ELEVATIONS PRIOR TO THE START OF CONSTRUCTION.

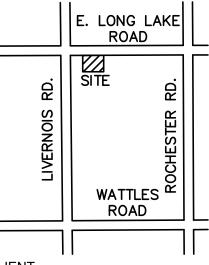

ORIGINAL ISSUE DATE: MARCH 8, 2024


DRAWING TITLE **TOPOGRAPHIC** SURVEY

PEA JOB NO. 2023-1373 JPB SWS SWS DRAWING NUMBER:

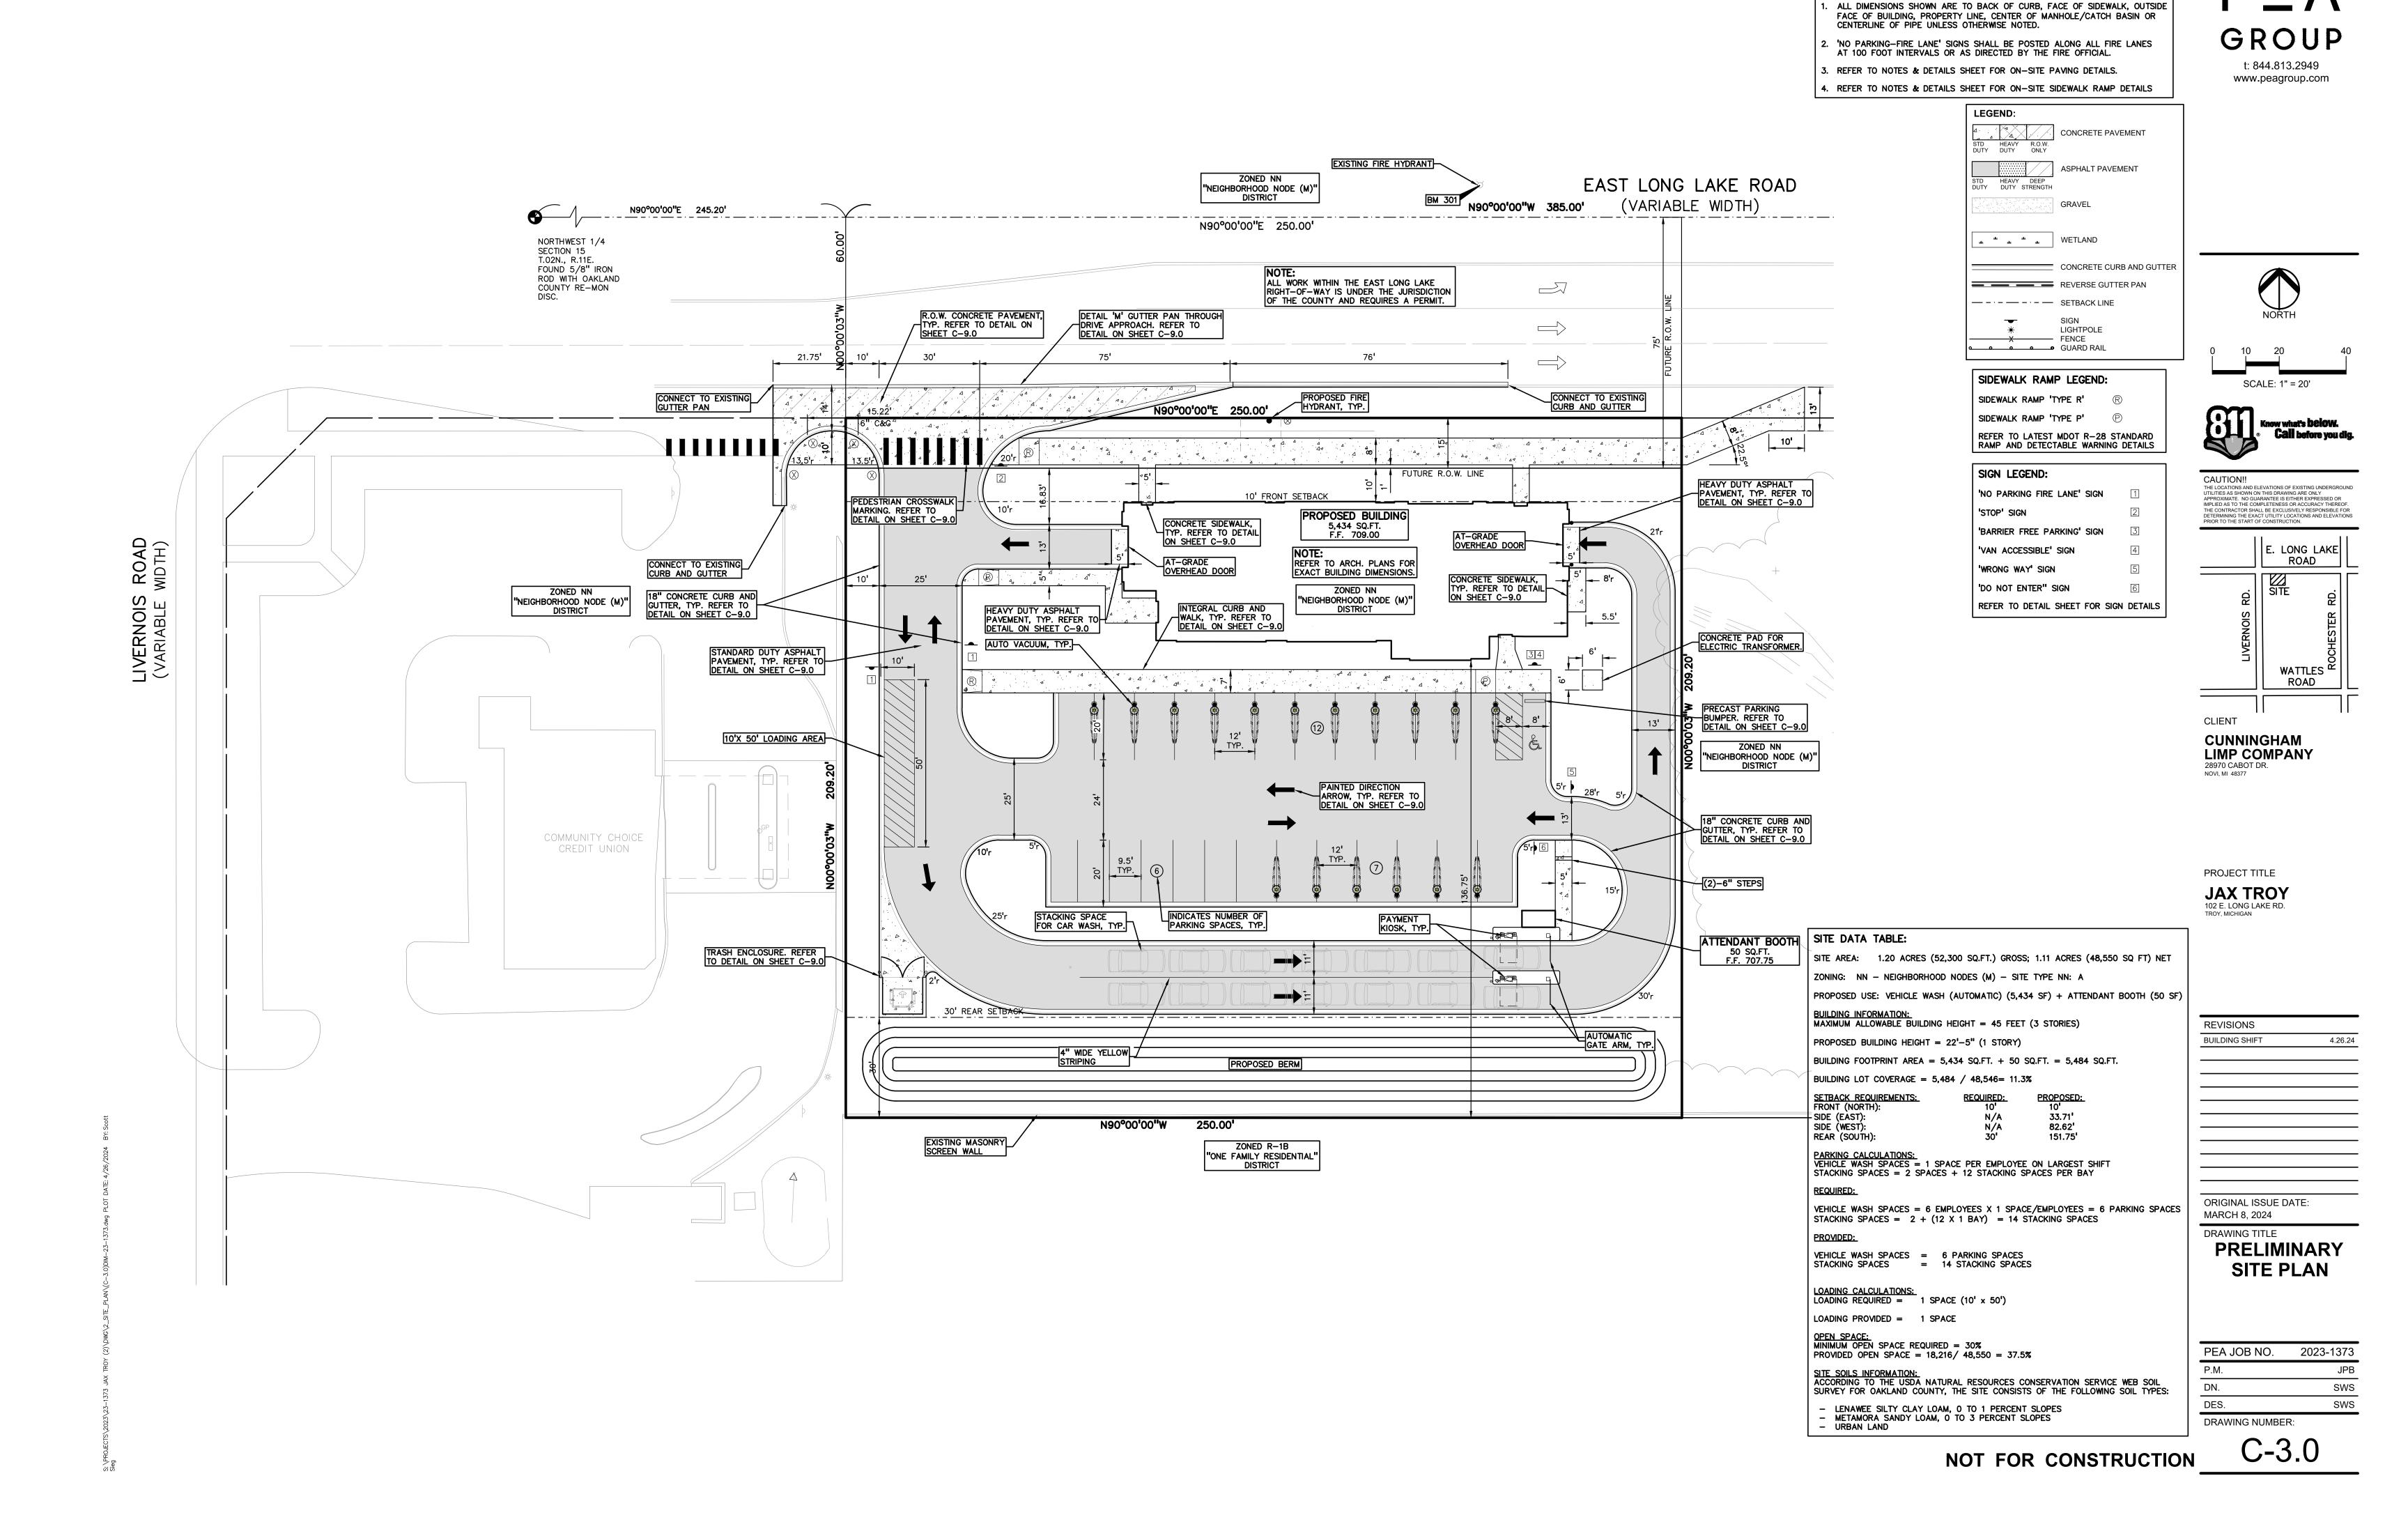


GENERAL NOTES:


THESE NOTES APPLY TO ALL CONSTRUCTION ACTIVITIES ON THIS PROJECT.

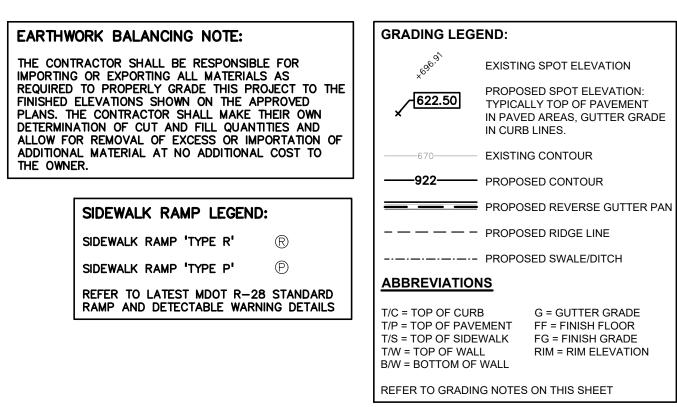



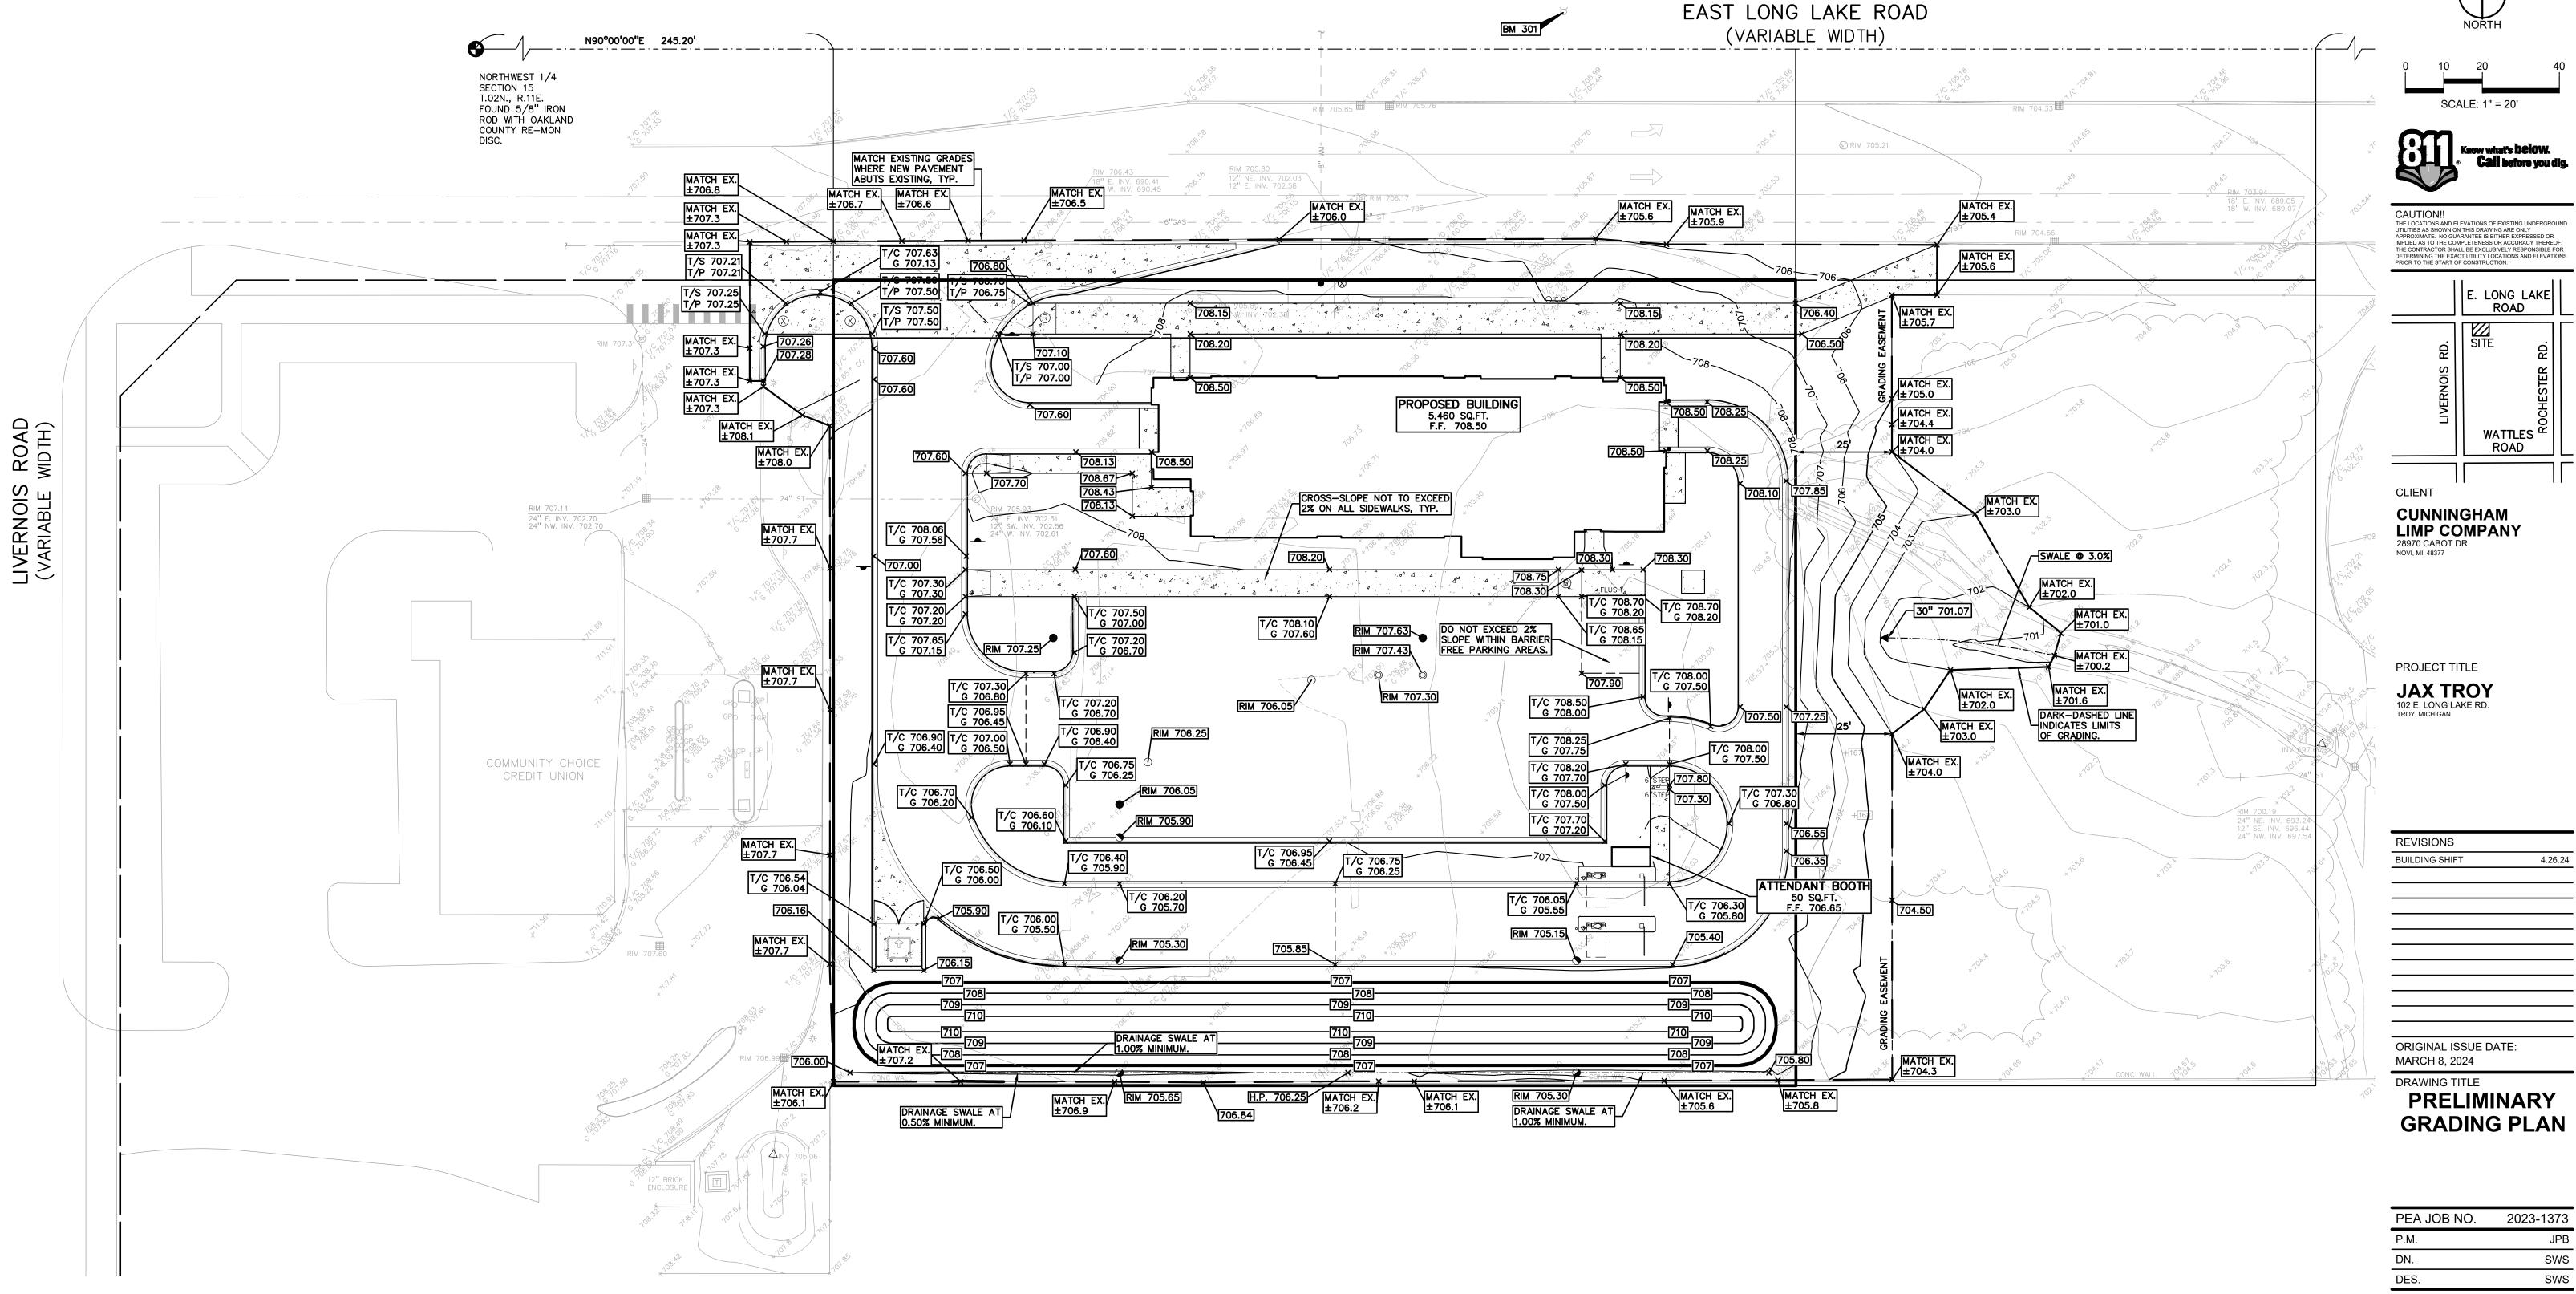

DRAWING NUMBER:

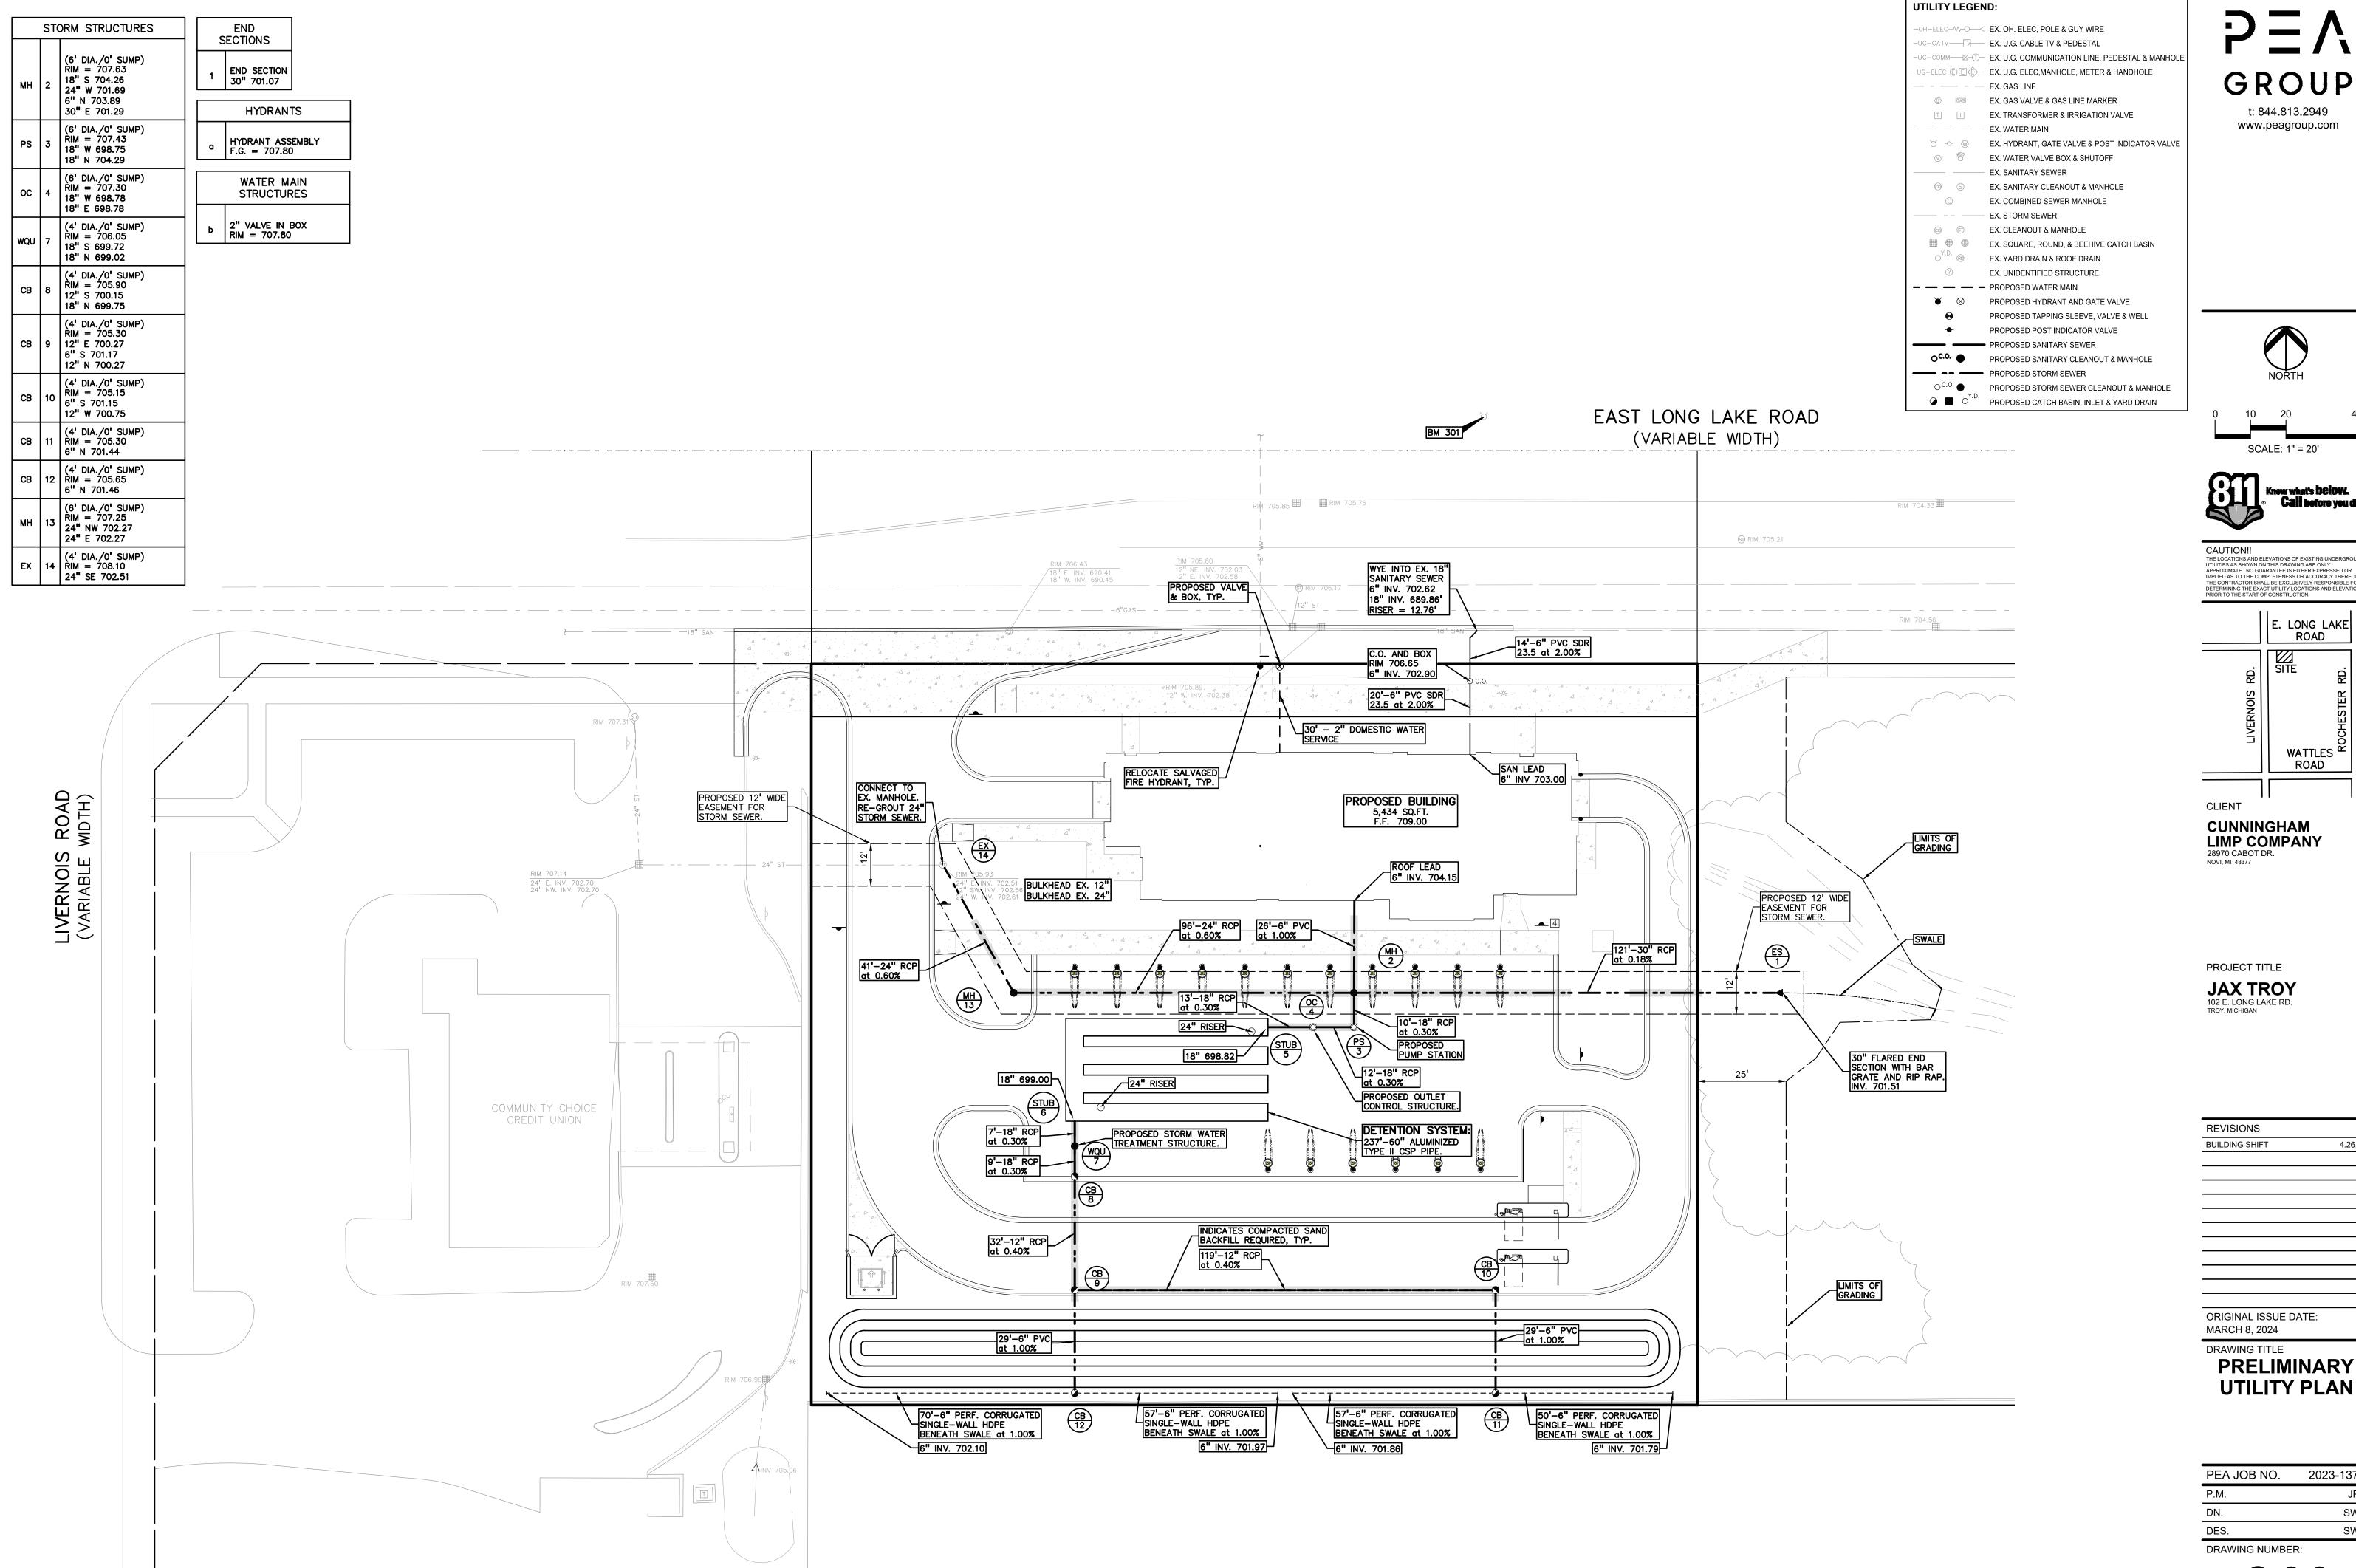









THE LOCATIONS AND ELEVATIONS OF EXISTING UNDERGROUND UTILITIES AS SHOWN ON THIS DRAWING ARE ONLY UTILITIES AS SHOWN ON THIS DRAWING ARE ONLY APPROXIMATE. NO GUARANTEE IS EITHER EXPRESSED OR IMPLIED AS TO THE COMPLETENESS OR ACCURACY THEREOF. THE CONTRACTOR SHALL BE EXCLUSIVELY RESPONSIBLE FOR DETERMINING THE EXACT UTILITY LOCATIONS AND ELEVATIONS PRIOR TO THE START OF CONSTRUCTION.

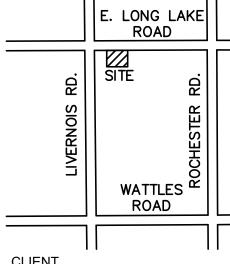

ORIGINAL ISSUE DATE:

PRELIMINARY UTILITY PLAN

2023-1373 JPB SWS SWS

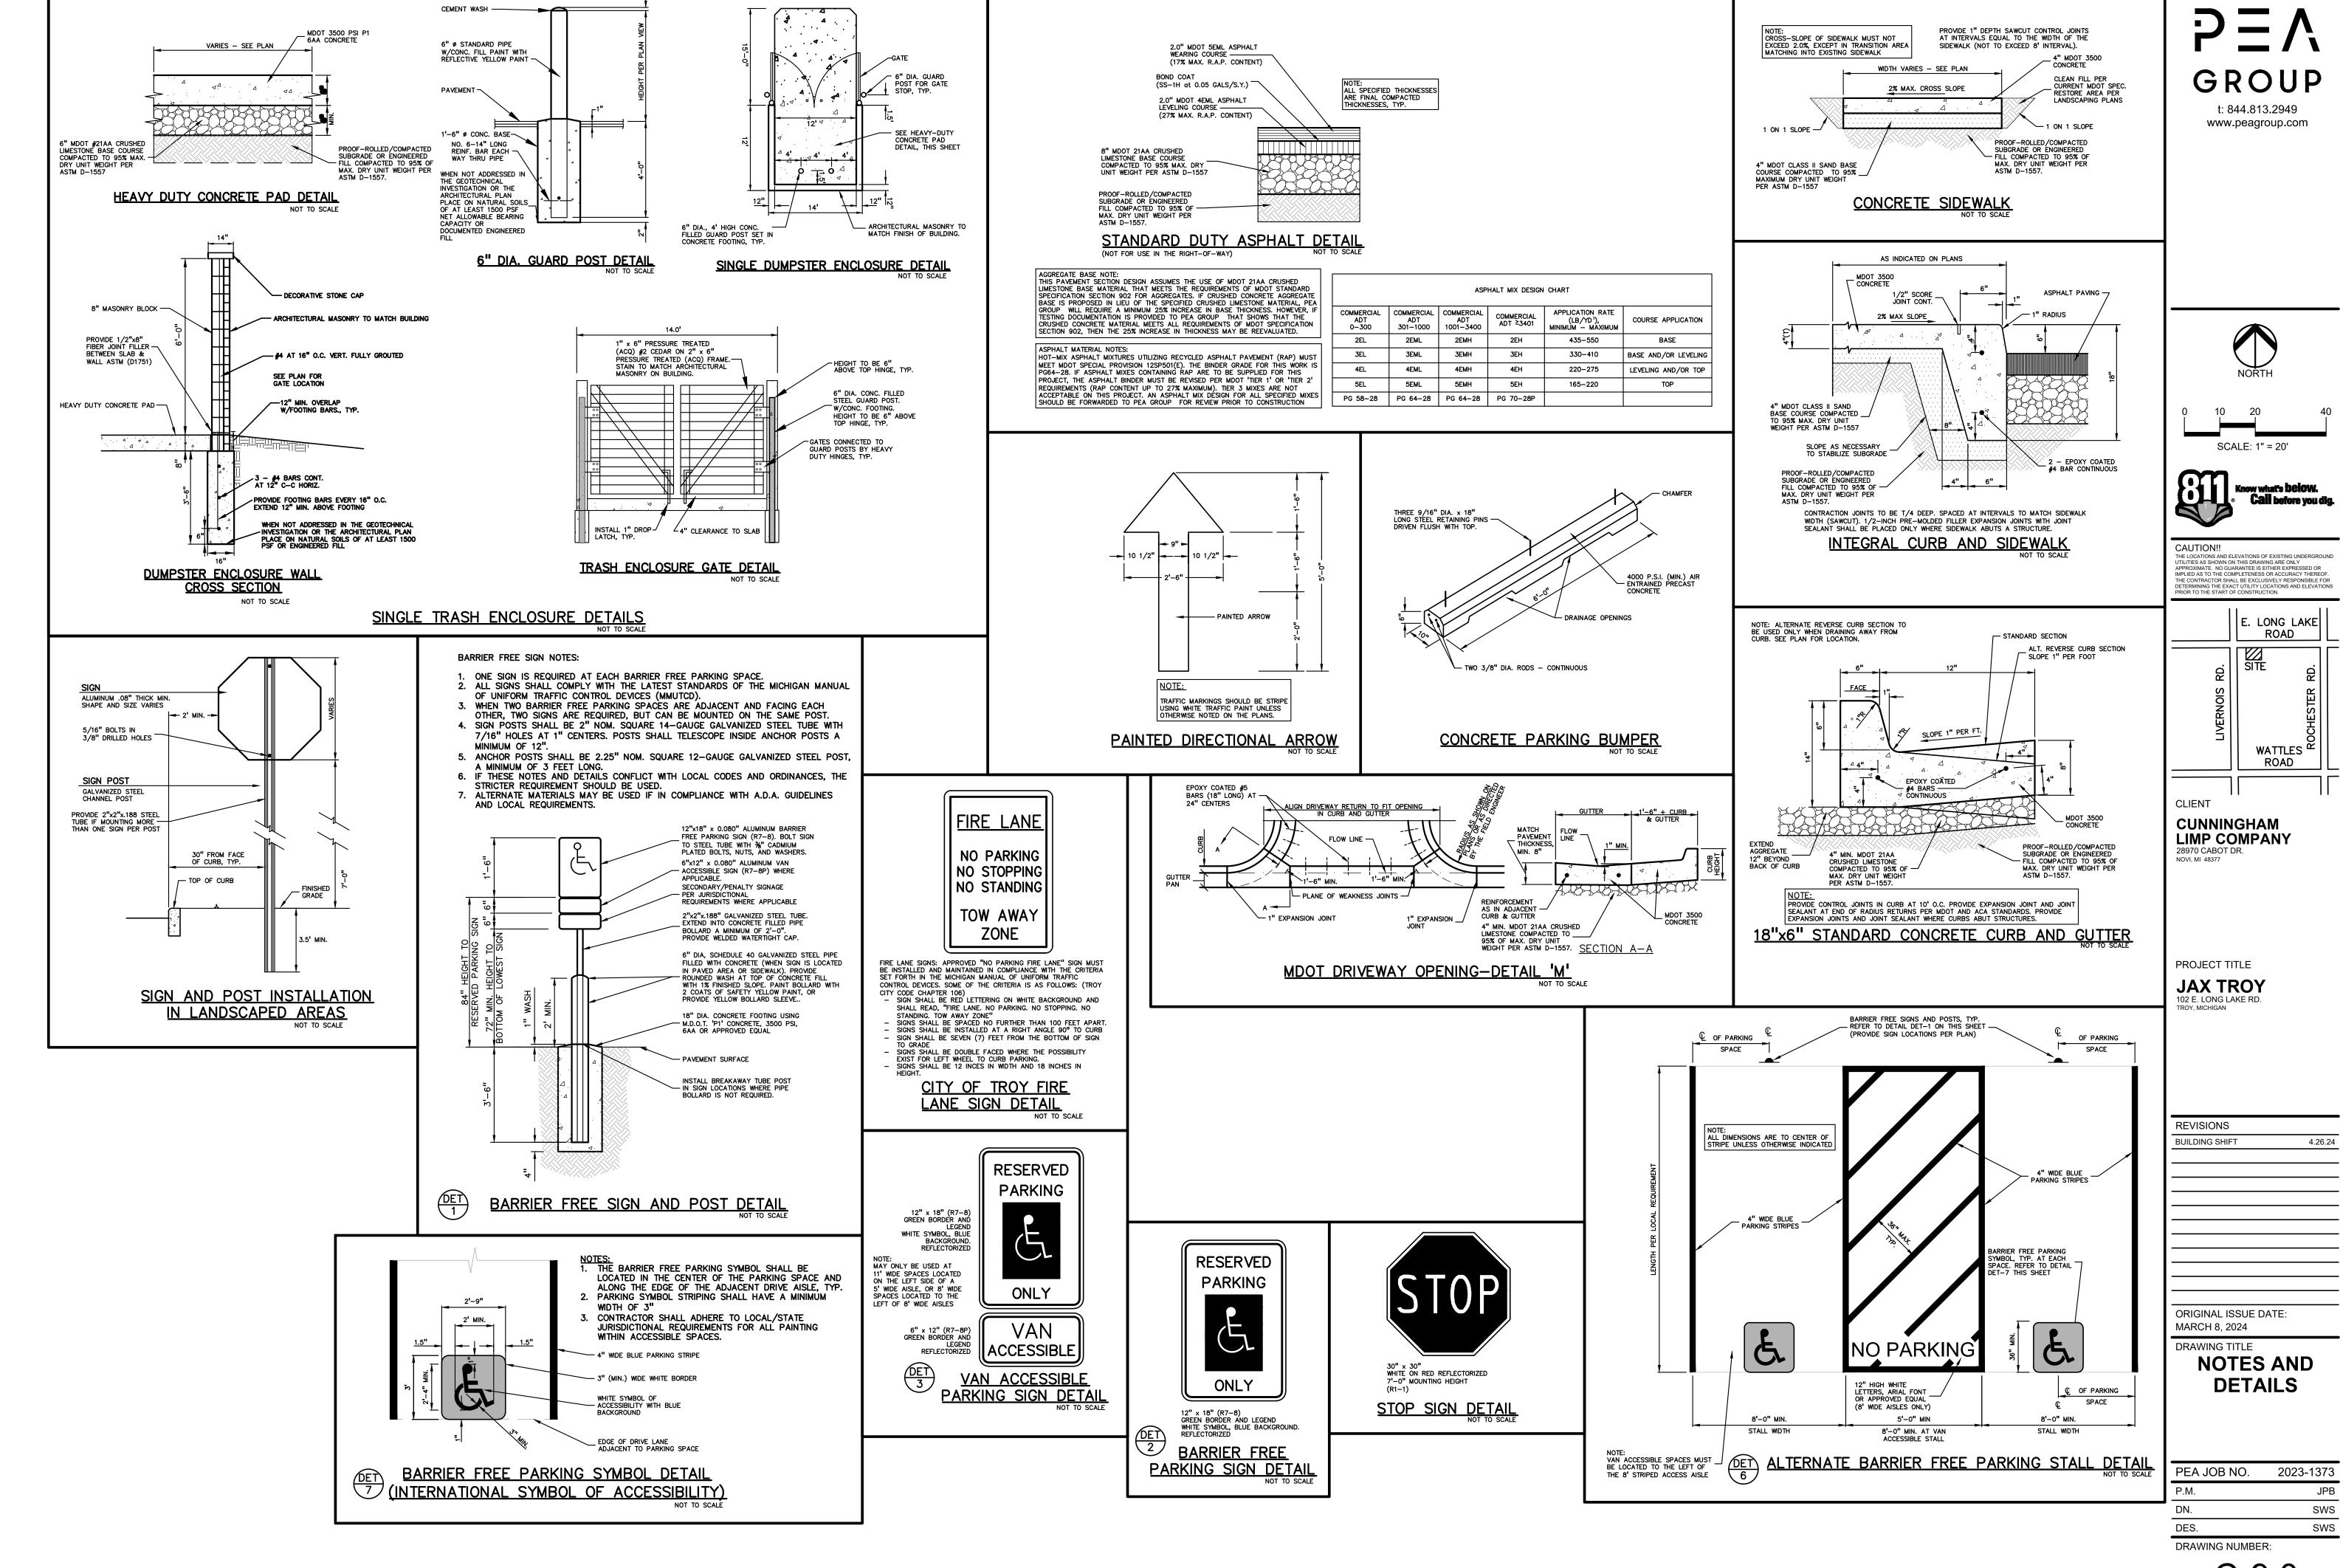

NOT FOR CONSTRUCTION


C-9.0


PLAN	NT SCH	EDULE			
CODE	<u>QTY</u>	BOTANICAL / COMMON NAME	SIZE	CONTAINER	SPACING
DECID	UOUS TI	REES			
ASB2.5	3	ACER SACCHARUM 'BARRETT COLE' / APOLLO® SUGAR MAPLE	2.5" CAL.	B&B	PER PLAN
GBF2.5	6	GINKGO BILOBA 'FASTIGIATA' / FASTIGIATE MAIDENHAIR TREE	2.5" CAL.	B&B	PER PLAN
QA2.5	1	QUERCUS ALBA / WHITE OAK	2.5" CAL.	B&B	PER PLAN
QP2.5	4	QUERCUS ROBUR X BICOLOR 'LONG' / REGAL PRINCE® OAK	2.5" CAL.	B&B	PER PLAN
	14	SUBTOTAL:			
FVFR(GREEN T	REES			
AC8	5	ABIES CONCOLOR / WHITE FIR	8` HT.	B&B	PER PLAN
PG8	4	PICEA GLAUCA / WHITE SPRUCE	8` HT.	B&B	PER PLAN
PS8	5	PINUS STROBUS / EASTERN WHITE PINE	8` HT.	B&B	PER PLAN
TG8	6	THUJA STANDISHII X PLICATA 'GREEN GIANT' / GREEN GIANT ARBORVITAE	8` HT.	B&B	PER PLAN
TSC8	5	TSUGA CANADENSIS / EASTERN HEMLOCK	8` HT.	B&B	PER PLAN
	25	SUBTOTAL:			
SHRU	RS				
TH36	<u>50</u>	TAXUS X MEDIA 'HICKSII' / HICKS ANGI O-JAPANESE YEW	3` HT.	CONT.	30" O.C.
TOS6	53	THUJA OCCIDENTALIS 'SMARAGD' / EMERALD GREEN ARBORVITAE	6` HT.	B&B	36"O.C.
. 500	70	SUBTOTAL:			00 0.0.

PIN 1/2IN

							SAVE (S) /
TAG	CODE	DBH	LATIN NAME	COMMON NAME	COND	NOTES	REMOVE (X)
162	E	6	Ulmus americana	American Elm	Fair	x1	Х
163	₽X	8	Acer negundo	Box elder	Good	× 4	X
164	₽L	7	Robinia pseudoacacia	Black Locust	Fair		X
165	₽X	8	Acer negundo	Box elder	Fair		X
166	₽L	7	Robinia pseudoacacia	Black Locust			X
167	вх	6	Acer negundo	Box elder	Fair		S
168	E	8	Ulmus americana	American Elm	Good		S

	TREE REPLACEMENT	
)	NON-EXEMPT TREES REMOVED	0
	EXEMPT TREES REMOVED:	5
	REPLACEMENT REQUIRED:	0

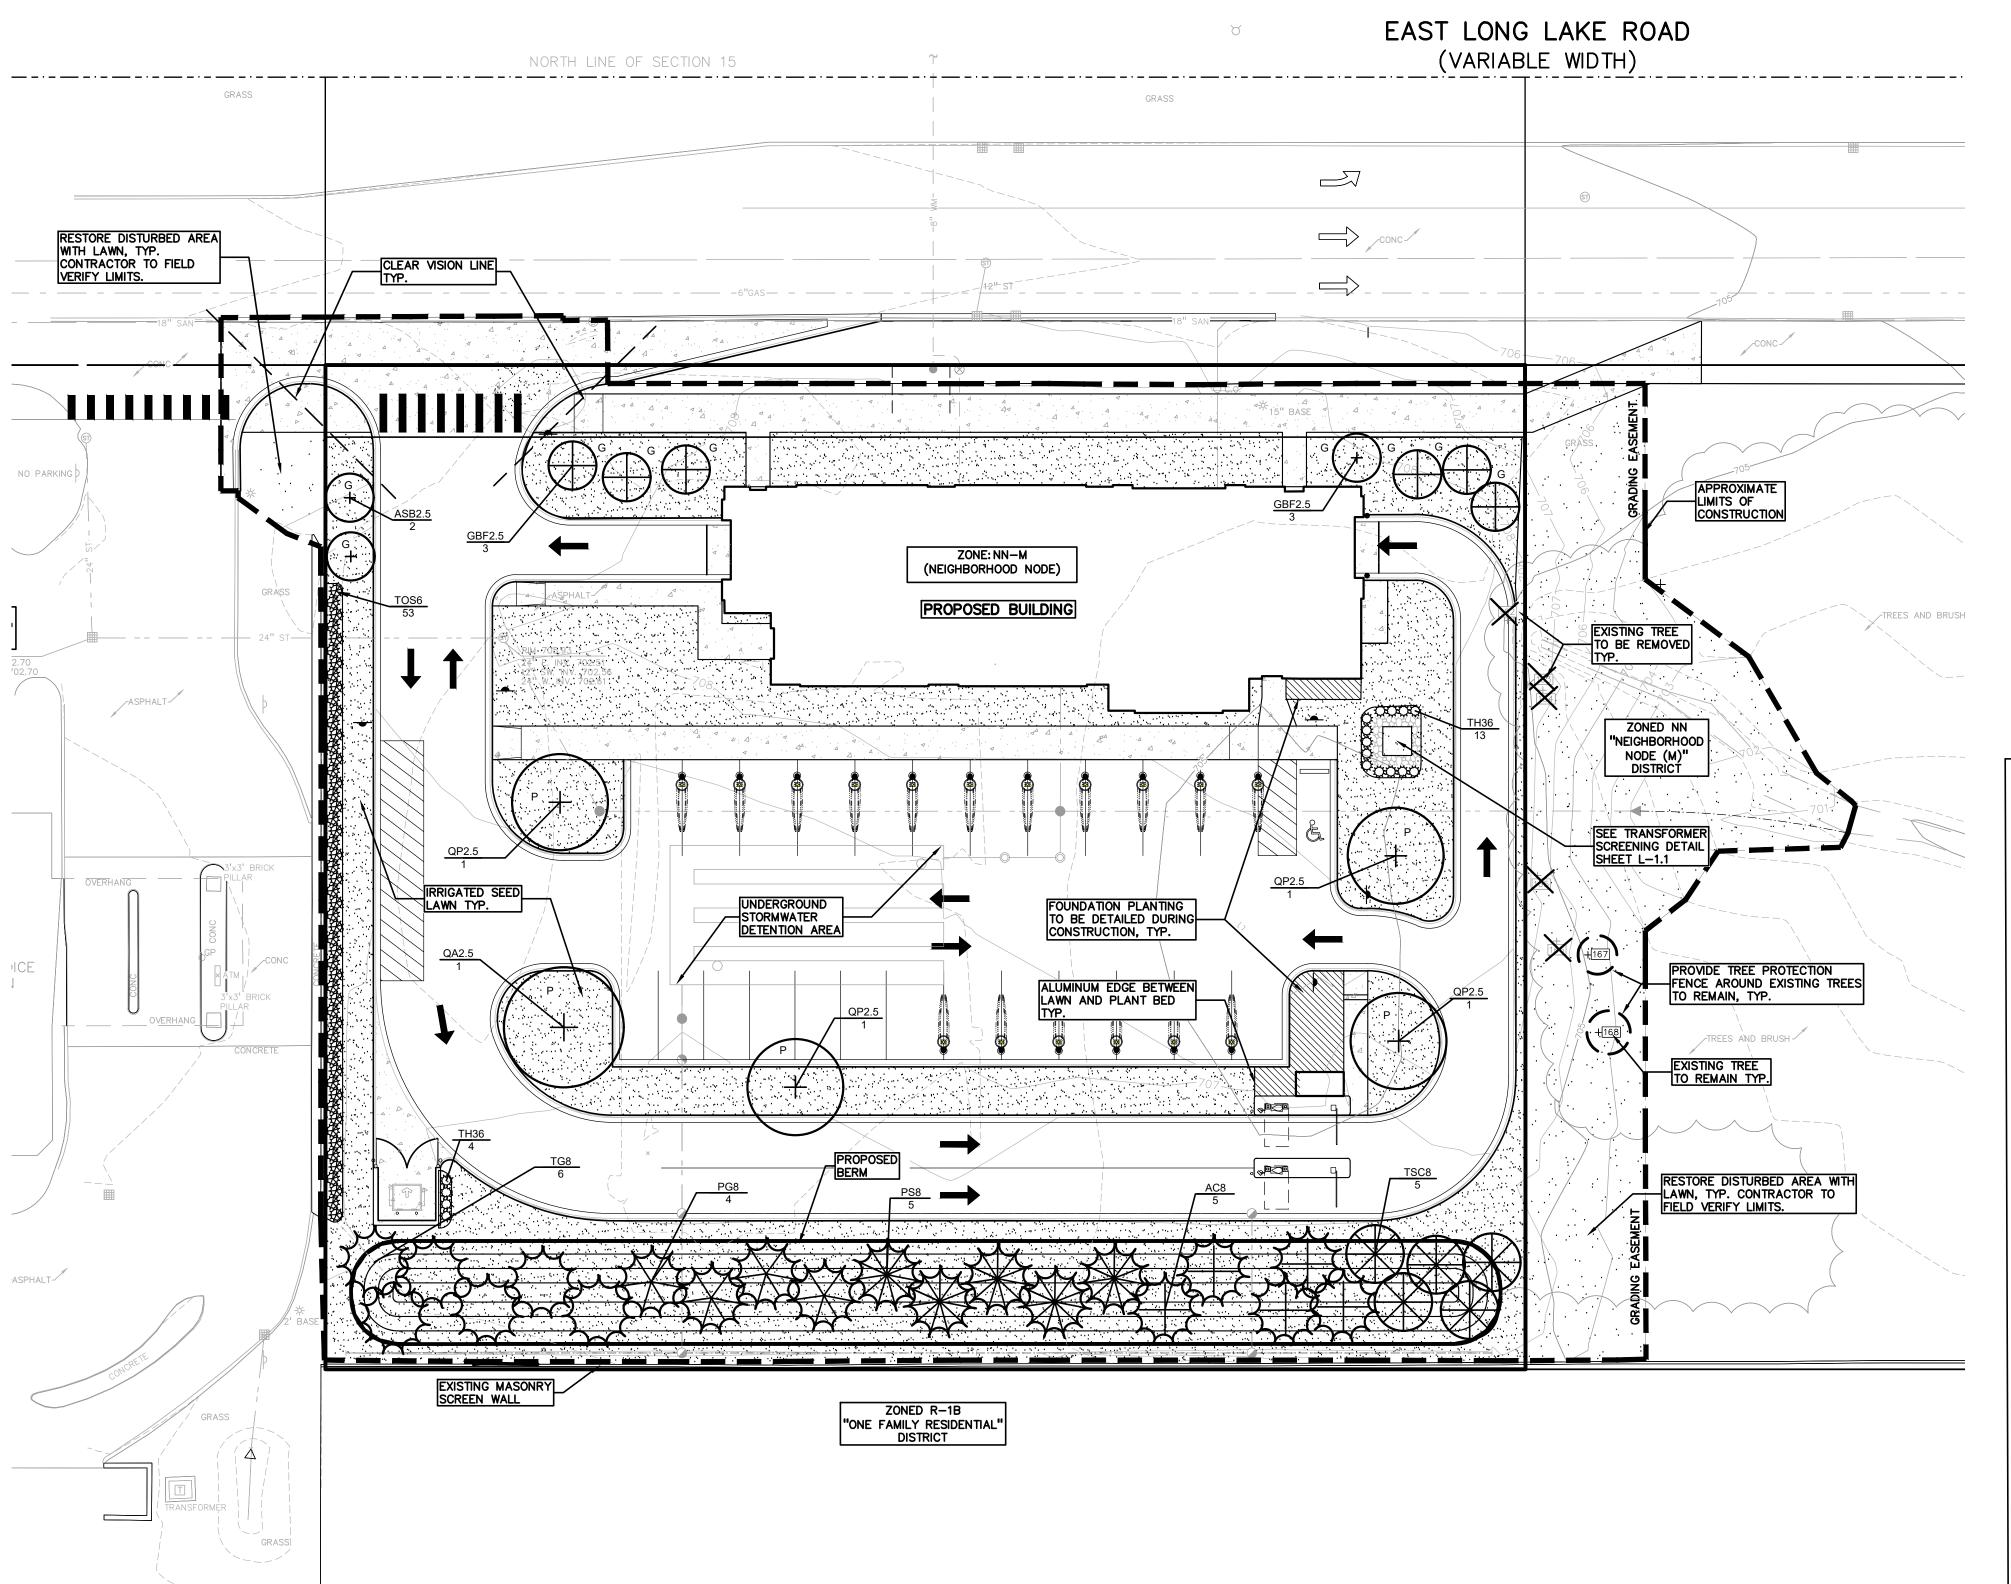

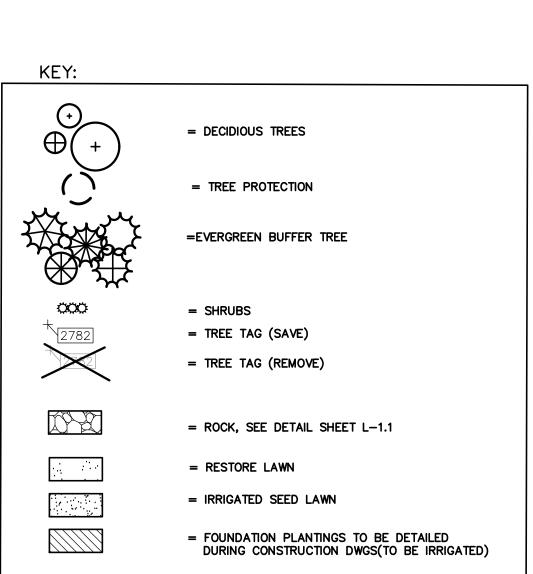

SEE SHEET L-1.1 FOR LANDSCAPE DETAILS

ZONING: NN - NEIGHBORHOOD NODES (M) - SITE TYPE NN: A

LANDSCAPE CALCULATIONS:

 $\frac{\mathsf{PARKING}\ \mathsf{LOT}\ \mathsf{LANDSCAPING}}{\mathsf{LOT}\ \mathsf{LANDSCAPING}} = \mathsf{P}$

PROVIDED: 5 PROPOSED DEC. TREE

PROVIDED: 9 PROPOSED DEC. TREES

SCREENING BETWEEN LAND USES

REQUIRED: 1 NARROW EVG PER 3 LF

PROVIDED: 53 NARROW EVG

MATERIALS AND DUMPSTER.

WEST BOUNDARY: 149 LF / 3 = 53 NARROW EVG

PROVIDED: PROPOSED UPRIGHT EVG SHRUBS

250 LF / 30 = 9 TREES

PER CITY OF TROY ZONING ORDINANCE;

25 PARKING SPACES / 5 TREE

GREENBELT ON E. LONG LAKE RD = G
REQUIRED: 1 DEC TREE / 30 LF OF STREET FRONTAGE

GENERAL SITE LANDSCAPE
REQUIRED: 20% OF SITE AREA SHALL BE LANDSCAPE MATERIAL;

PARKING LOT TREEGREENBELT TREE

REQUIRED: 1 TREE / 6 PARKING SPACES AND 200 SF MINIMUM PARKING ISLANDS

1.20 ACRES (52,300 SQ.FT.) * 20% = 10,460 SQ FT

REQUIRED: 1 LARGE EVG PER 10 LF/1 NARROW EVG PER 5 LF OR WALL WHEN

CONTIGUOUS WITH RESIDENTIAL/OFFICE LAND USES. 205 / 10 = 25 TREES

EQUIPMENT SCREENING
REQUIRED: AT GRADE EQUIPMENT SHALL BE SCREENED BY EVG LANDSCAPE

PROVIDED AT SOUTH BOUNDARY: 25 LARGE EVG. AND CONCRETE WALL

PROVIDED: 22,585 SQ FT OF SOFT-SCAPE/52,300 = 43.18 % LAWN & PLANT BEDS

0 10 20

SCALE: 1" = 20'

SCALE: 1" = 20'

Know what's below.
Call before you die

GROUP

t: 844.813.2949 www.peagroup.com

CAUTION!!

THE LOCATIONS AND ELEVATIONS OF EXISTING UNDERGROUND UTILITIES AS SHOWN ON THIS DRAWING ARE ONLY APPROXIMATE. NO GUARANTEE IS EITHER EXPRESSED OR IMPLIED AS TO THE COMPLETENESS OR ACCURACY THEREOF. THE CONTRACTOR SHALL BE EXCLUSIVELY RESPONSIBLE FOR DETERMINING THE EXACT UTILITY LOCATIONS AND ELEVATIONS PRIOR TO THE START OF CONSTRUCTION.

LIVERNOIS RD.

ROAD

WATTLES

ROAD

WATTLES

ROAD

ROAD

WATTLES

ROAD

CLIENT

CUNNINGHAM
LIMP COMPANY
28970 CABOT DR.
NOVI, MI 48377

GENERAL PLANTING NOTES:

TRUNKS WILL NOT BE ACCEPTED.

- 1. LANDSCAPE CONTRACTOR SHALL VISIT SITE, INSPECT EXISTING SITE CONDITIONS AND REVIEW PROPOSED PLANTING AND RELATED WORK. IN CASE OF DISCREPANCY BETWEEN PLAN AND PLANT LIST, PLAN SHALL GOVERN QUANTITIES. CONTACT LANDSCAPE ARCHITECT WITH ANY CONCERNS.
- 2. CONTRACTOR SHALL VERIFY LOCATIONS OF ALL ON SITE UTILITIES PRIOR TO BEGINNING CONSTRUCTION ON HIS/HER PHASE OF WORK. ELECTRIC, GAS, TELEPHONE, CABLE TELEVISION MAY BE LOCATED BY CALLING MISS DIG 1-800-482-7171. ANY DAMAGE OR INTERRUPTION OF SERVICES SHALL BE THE RESPONSIBILITY OF CONTRACTOR. CONTRACTOR SHALL COORDINATE ALL RELATED ACTIVITIES WITH OTHER TRADES ON THE JOB AND SHALL REPORT ANY UNACCEPTABLE JOB CONDITIONS TO OWNER'S REPRESENTATIVE PRIOR TO COMMENCING.
- 3. ALL PLANT MATERIAL TO BE PREMIUM GRADE NURSERY STOCK AND SHALL SATISFY AMERICAN ASSOCIATION OF NURSERYMEN STANDARD FOR NURSERY STOCK. ALL LANDSCAPE MATERIAL SHALL BE NORTHERN GROWN, NO. 1. GRADE.
- 4. CONTRACTOR IS RESPONSIBLE FOR VERIFYING ALL QUANTITIES SHOWN ON LANDSCAPE PLAN PRIOR TO PRICING THE WORK.
- 5. THE OWNER'S REPRESENTATIVE RESERVES THE RIGHT TO REJECT ANY PLANT MATERIAL NOT MEETING
- SPECIFICATIONS.

 6. ALL SINGLE STEM SHADE TREES TO HAVE STRAIGHT TRUNKS AND SYMMETRICAL CROWNS.
- 7. ALL SINGLE TRUNK SHADE TREES TO HAVE A CENTRAL LEADER; TREES WITH FORKED OR IRREGULAR
- 8. ALL MULTI STEM TREES SHALL BE HEAVILY BRANCHED AND HAVE SYMMETRICAL CROWNS. ONE SIDED TREES OR THOSE WITH THIN OR OPEN CROWNS SHALL NOT BE ACCEPTED.
- 9. ALL EVERGREEN TREES SHALL BE HEAVILY BRANCHED AND FULL TO THE GROUND, SYMMETRICAL IN SHAPE AND NOT SHEARED FOR THE LAST FIVE GROWING SEASONS.
- 10. ALL TREES TO HAVE CLAY OR CLAY LOAM BALLS, TREES WITH SAND BALLS WILL BE REJECTED.
- 11. NO MACHINERY IS TO BE USED WITHIN THE DRIP LINE OF EXISTING TREES; HAND GRADE ALL LAWN AREAS WITHIN THE DRIP LINE OF EXISTING TREES.
- 12. ALL TREE LOCATIONS SHALL BE STAKED BY LANDSCAPE CONTRACTOR AND ARE SUBJECT TO THE APPROVAL OF THE LANDSCAPE ARCHITECT PRIOR TO INSTALLATION OF THE PLANT MATERIAL.
- 13. IT IS MANDATORY THAT POSITIVE DRAINAGE IS PROVIDED AWAY FROM ALL BUILDINGS.
- 14. ALL PLANTING BEDS SHALL RECEIVE 3" SHREDDED HARDWOOD BARK MULCH WITH PRE EMERGENT, SEE SPECIFICATIONS. SHREDDED PALETTE AND DYED MULCH WILL NOT BE ACCEPTED.
- 15. ALL LANDSCAPED AREAS SHALL RECEIVE 3" COMPACTED TOPSOIL.

LANDSCAPE ARCHITECT IF DRAWINGS CONFLICT WITH BUILDING OVERHANGS.

- 16. SEE SPECIFICATIONS FOR ADDITIONAL COMMENTS, REQUIREMENTS, PLANTING PROCEDURES AND WARRANTY STANDARDS.
- 17. FOR NON-LAWN SEED MIX AREAS, AS NOTED ON PLAN, BRUSH MOW ONCE SEASONALLY FOR
- INVASIVE SPECIES CONTROL.

 18. CONTRACTOR SHALL NOT INSTALL PLANTS UNDER BUILDING OVERHANG AND SHALL NOTIFY
- 19. TREES SHALL NOT CONFLICT/ BLOCK PROPOSED REGULATORY/ DIRECTION SIGNAGE, MONUMENT SIGNS, ADDRESS OR LIGHT POLES. SHIFT TREES AS NECESSARY TYP.
- 20. ALL LANDSCAPE AREAS WILL BE IRRIGATED OR HAVE A READILY AVAILABLE AND ACCEPTABLE WATER SUPPLY.

PROJECT TITLE

JAX TROY

102 E. LONG LAKE RD.

TROY, MICHIGAN

REVISIONS

BUILDING SHIFT

		·

ORIGINAL ISSUE DATE: MARCH 8, 2024 DRAWING TITLE

PRELIMINARY
LANDSCAPE
PLAN

PEA JOB NO.	2023-1373
P.M.	JPB
DN.	CAL
DES.	JLE
DRAWING NUMBER	:

ACCESS DOORS NOT BLOCKED BY PLANTINGS, - SHIFT PLANTS AS NECESSARY TO MAINTAIN CLEARANCE (TYP.) 2-3" DIAMETER RIVER - ROCK AT 5" DEPTH OVER WEED FABRIC TRANSFORMER (TYP.) SEE PLAN FOR EXACT ← PLANTING LAYOUT, TYPE AND QUANTITY

TRANSFORMER SCREENING DETAIL-FOR ACCESS REF. ONLY SCALE: 1'' = 3'-0''

PLANT SO THAT TOP OF ROOT BALL IS

POORLY DRAINED SOILS

(DO NOT USE WIRE & HOSE)

BACKFILLING

-FINISH GRADE

TAMPED SOIL

CONTINUOUS RIM

FIRMLY INTO SUBGRADE PRIOR TO

SHREDDED HARDWOOD BARK MULCH TO

PLACE MULCH IN CONTACT WITH TREE

TRUNK. FORM SAUCER WITH 4" HIGH

CONDITIONS & TREE REQUIREMENTS

BARE SOIL AROUND TREE TRUNK. DO NOT

SPECIFIED PLANTING MIX, WATER & TAMP TO

- REMOVE AIR POCKETS, AMEND SOIL PER SITE

EXPOSE ROOT FLARE OF TREE. CONTRACTOR

MAY HAVE TO REMOVE EXCESS SOIL FROM

- TOP OF ROOTBALL. REMOVE ALL BURLAP

FROM TOP 3 OF ROOTBALL. DISCARD ALL

PLACE ROOTBALL ON UNEXCAVATED OR

NON-BIODEGRADABLE MATERIAL OFF SITE

DRIPLINE. 3" DEEP AND LEAVE 3" CIRCLE OF

FLUSH TO GRADE OR 1-2" HIGHER IF IN

STAKE JUST BELOW BRANCHES WITH 2"-3"

WIDE NYLON OR PLASTIC STRAPS. CONNECT FROM TREE TO STAKE AND ALLOW FOR FLEXIBILITY. REMOVE AFTER (1) ONE YEAR.

THREE 2"X2" HARDWOOD STAKES OR STEEL T-POSTS DRIVEN A MIN. OF 18" DEEP

TREE PROTECTION DETAIL

SCALE: 1'' = 3'-0''

TREE PROTECTION WILL BE ERECTED PRIOR TO START OF CONSTRUCTION ACTIVITIES AND SHALL REMAIN IN PLACE UNTIL CONSTRUCTION IS COMPLETE NO PERSON MAY CONDUCT ANY ACTIVITY WITHIN THE DRIP LINE OF ANY TREE DESIGNATED TO REMAIN; INCLUDING, BUT NOT LIMITED TO PLACING SOLVENTS, BUILDING MATERIAL, CONSTRUCTION EQUIPMENT OR

SOIL DEPOSITS WITHIN DRIP LINES GRADE CHANGES MAY NOT OCCUR WITHIN THE DRIP

LINE OF PROTECTED TREES DURING CONSTRUCTION, NO PERSON SHALL ATTACH

ANY DEVICE OR WIRE TO ANY REMAINING TREE

ALL UTILITY SERVICE REQUESTS MUST INCLUDE NOTIFICATION TO THE INSTALLER THAT PROTECTED TREES MUST BE AVOIDED. ALL TRENCHING SHALL OCCUR OUTSIDE OF THE PROTECTIVE FENCING

TREES LOCATED ON ADJACENT PROPERTY THAT MAY BE AFFECTED BY CONSTRUCTION ACTIVITIES MUST BE

TREES TO BE PRESERVED SHALL BE IDENTIFIED WITH FLAGGING PRIOR TO THE TREE CLEARING OPERATIONS

PROVIDE FENCE AROUND CRITICAL ROOT ZONE OF

PLANT SO THAT TOP OF ROOT BALL IS FLUSH TO GRADE OR 1-2" HIGHER IF

FENCE SHALL BE PLACED IN A CIRCLE WITH A MINIMUM RADIUS OF 1' PER 1" DIAMETER OF THE TREE MEASURED AT 4.5' ABOVE GROUND

> 4'HIGH PROTECTIVE FENCING WITH STEEL POSTS - 10' O.C. - EXISTING SOIL

> > CAUTION!! THE LOCATIONS!
> >
> > THE LOCATIONS AND ELEVATIONS OF EXISTING UNDERGROUND UTILITIES AS SHOWN ON THIS DRAWING ARE ONLY APPROXIMATE. NO GUARANTEE IS EITHER EXPRESSED OR IMPLIED AS TO THE COMPLETENESS OR ACCURACY THEREOF. THE CONTRACTOR SHALL BE EXCLUSIVELY RESPONSIBLE FOR DETERMINING THE EXACT UTILITY LOCATIONS AND ELEVATIONS PRIOR TO THE START OF CONSTRUCTION.

GROUP

t: 844.813.2949

www.peagroup.com

E. LONG LAKE ROAD ROAD

CLIENT

CUNNINGHAM LIMP COMPANY 28970 CABOT DR. NOVI, MI 48377

PROJECT TITLE

JAX TROY 102 E. LONG LAKE RD. TROY, MICHIGAN

REVISIONS

BUILDING SHIFT

ORIGINAL ISSUE DATE:

MARCH 8, 2024

DRAWING TITLE

4.26.24

IN POORLY DRAINED SOILS DO NOT COVER TOP OF ROOTBALL WITH SOIL FORM SAUCER WITH 4" HIGH CONTINUOUS RIM SHREDDED HARDWOOD BARK MULCH 3" DEEP AND LEAVE 3" CIRCLE OF BARE SOIL AROUND TRUNK. DO NOT PLACE MULCH IN CONTACT WITH TRUNK — FINISH GRADE SPECIFIED PLANTING MIX. WATER AND TAMP TO REMOVE AIR POCKETS REMOVE ALL BURLAP FROM TOP 1 OF ROOTBALL. DISCARD ALL NON-BIODEGRADABLE MATERIAL OFF SITE VARIES ON CONTAINER OR BALL SIZE PLACE ROOTBALL ON UNEXCAVATED OR

SHRUB PLANTING DETAIL SCALE: 1'' = 2'-0''

120° STAKING/GUYING LOCATION

SCALE: 1'' = 3'-0''

PLANT SO THAT TOP OF ROOT BALL IS FLUSH TO GRADE OR 1-2" HIGHER IF IN POORLY DRAINED SOILS SECURE TREE WRAP WITH BIODEGRADABLE

MATERIAL AT TOP & BOTTOM, REMOVE AFTER FIRST WINTER DO NOT PRUNE TERMINAL LEADER PRUNE ONLY DEAD, BROKEN BRANCHES AS

DIRECTED BY LANDSCAPE ARCHITECT STAKE JUST BELOW BRANCHES WITH 2"-3" WIDE NYLON OR PLASTIC STRAPS. CONNECT - FROM TREE TO STAKE AND ALLOW FOR FLEXIBILITY. REMOVE AFTER (1) ONE YEAR. (DO NOT USE WIRE & HOSE)

(3) THREE 2"X2" HARDWOOD STAKES DRIVEN A MIN. OF 18" DEEP FIRMLY INTO SUBGRADE PRIOR TO BACKFILLING

SHREDDED HARDWOOD BARK MULCH TO DRIPLINE. 3" DEEP AND LEAVE 3" CIRCLE OF BARE SOIL AROUND TREE TRUNK. DO NOT PLACE MULCH IN CONTACT WITH TREE

TRUNK. FORM SAUCER WITH 4" HIGH CONTINUOUS RIM SPECIFIED PLANTING MIX, WATER & TAMP TO - REMOVE AIR POCKETS, AMEND SOIL PER SITE CONDITIONS & TREE REQUIREMENTS

-FINISH GRADE EXPOSE ROOT FLARE OF TREE. CONTRACTOR MAY HAVE TO REMOVE EXCESS SOIL FROM - TOP OF ROOTBALL. REMOVE ALL BURLAP FROM TOP 3 OF ROOTBALL. DISCARD ALL

NON-BIODEGRADABLE MATERIAL OFF SITE _ PLACE ROOTBALL ON UNEXCAVATED OR TAMPED SOIL **DECIDUOUS TREE PLANTING DETAIL**

PEA JOB NO. 2023-1373 P.M. JPB DN. CAL DES. JLE

LANDSCAPE

DETAILS

NOT FOR CONSTRUCTION

PERMALOC ALUMINUM EDGING OR APPROVED EQUAL WITH BLACK FINISH -BED MEDIA - COMPACTED SUBGRADE

> SPECIFICATIONS FOR LANDSCAPE BED EDGING: LANDSCAPE BED EDGING SHALL BE ALUMINUM AS MANUFACTURED BY PERMALOC 1.800.356.9660

> EDGING SHALL BE $\frac{3}{16}$ " THICK X 4" DEPTH WHEN ADJ. TO MULCH AND THICK X 5 1" DEPTH WHEN ADJ. TO ROCK, FINISH: BLACK

8' OR 16' SECTIONS SHALL BE USED WITH ONE STAKE PER 38" OF

DURAFLEX MEETING AAMA 2603 STAKE SHALL SECURELY ENGAGE EDGING AND SHALL BE ENTIRELY BELOW TOP SURFACE OF EDGING

EDGING SHALL HAVE A MINIMUM OF 2" OF INTERLOCKING OVERLAP BETWEEN SECTIONS INSTALL AS PER MANUFACTURER'S SPECIFICATIONS WITH TOP OF

EDGING $\frac{1}{4}$ " ABOVE COMPACTED FINISH GRADE. FINISH GRADE TO BE COMPACTED ON BOTH SIDES OF EDGING TO MAINTAIN STABILITY

ALUMINUM EDGE DETAIL

SCALE: 1/2'' = 1'-0''


DRAWING NUMBER:




 $\overset{\mathbb{Z}}{\mathsf{A}}$

4-24-24

PROJECT NUMBER: 24021

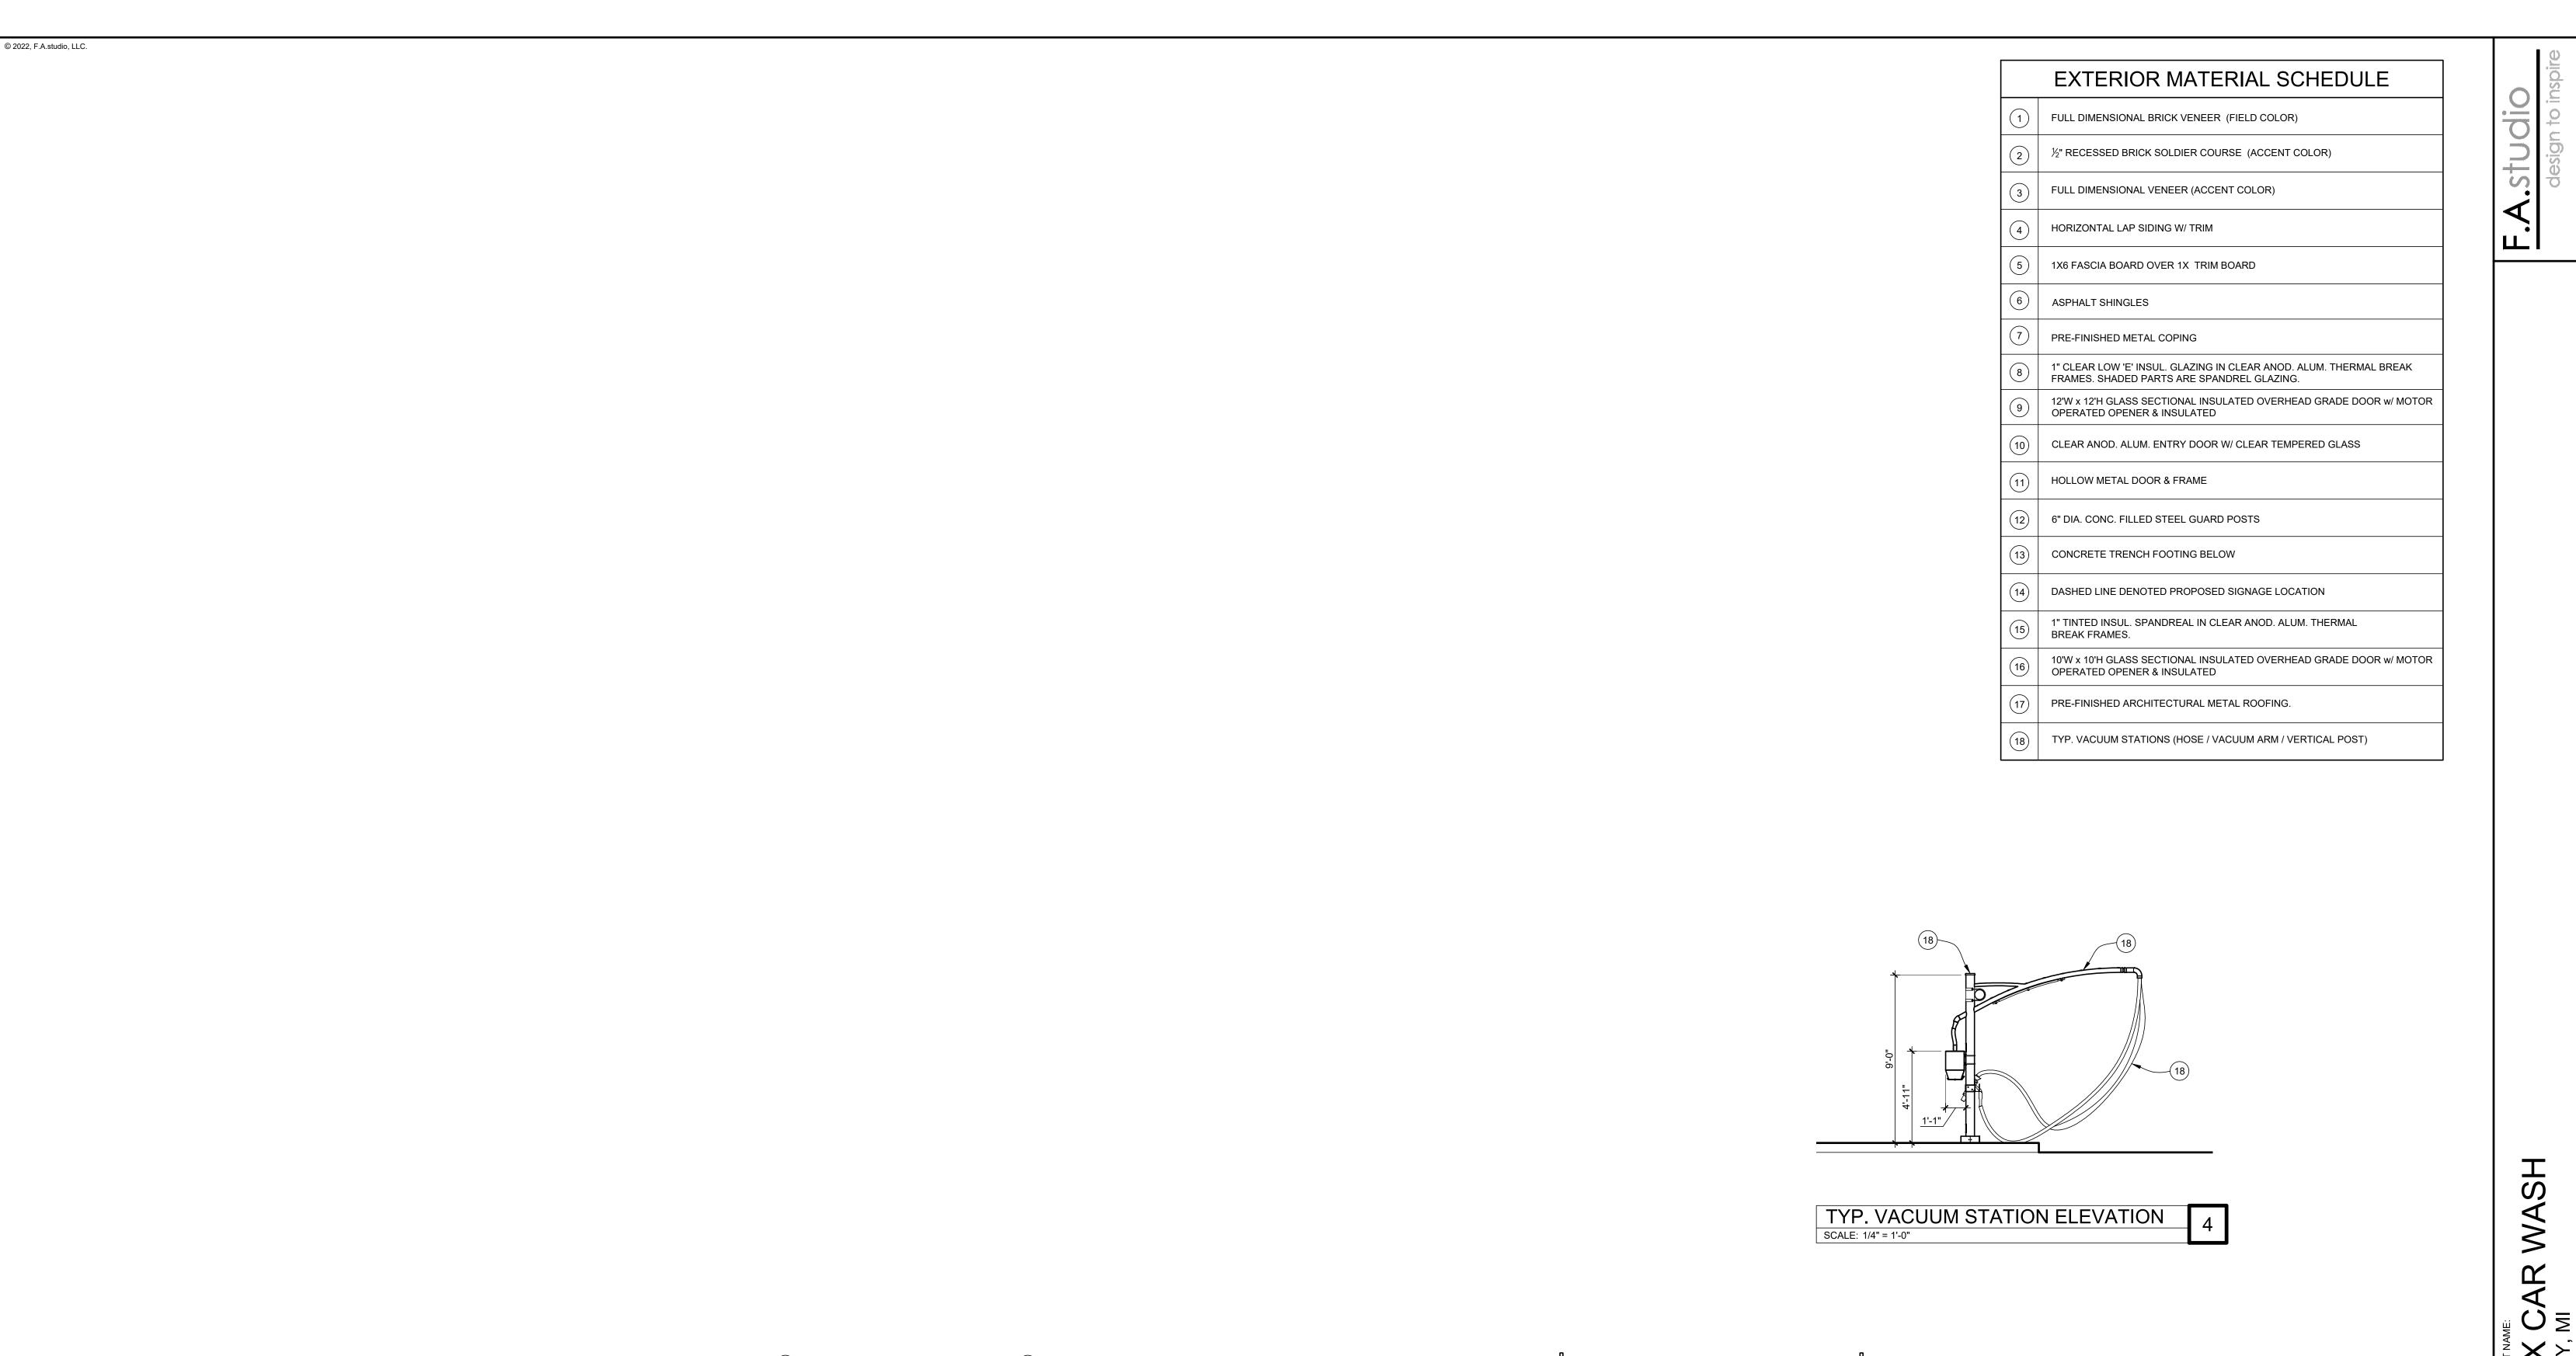

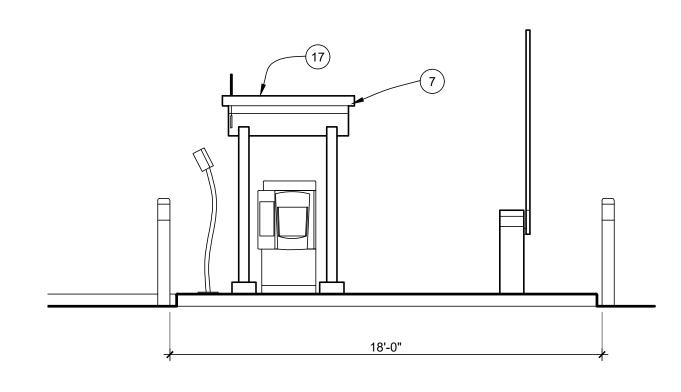

NORTH ELEVATION

SCALE: 1/4" = 1'-0"

3


4'-0"

WEST ELEVATION

SCALE: 1/4" = 1'-0"

SOUTH ELEVATION

SCALE: 1/4" = 1'-0"

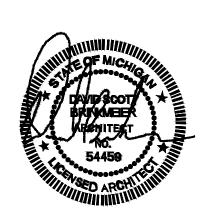

CAR WASH

PROJECT NUMBER: 24021 SHEET NUMBER: PE-4B

CODE COMPLIANCE

APPLICABLE CODE REQUIREMENTS:

- THIS BUILDING HAS BEEN DESIGNED IN ACCORDANCE WITH THE FOLLOWING:
- 2015 MICHIGAN BUILDING CODE (MBC)
- 2018 MICHIGAN PLUMBING CODE (MPC) - 2015 MICHIGAN MECHANICAL CODE (MMC)
- 2017 NATIONAL ELECTRIC CODE WITH PART 8 AMENDMENTS (NEC) - PART 10 MICHIGAN UNIFORM ENERGY CODE PART 10A RULES (ANSI /ASRAE 90.1-CODE 2015)
- MICHIGAN BARRIER FREE DESIGN LAW (PA 1 OF 1966 AS AMENDED),
- INCORPORATING THE 2012 MICHIGAN BUILDING CODE WITH ICC/ANSI A-117.1, 2009 - NFPA 13-2013 FIRE SPRINKLER SYSTEM
- NFPA 72-2013 FIRE ALARM SYSTEM

OCCUPANCY CLASSIFICATION:

- USE GROUP 'B' (BUSINESS) CAR WASH MBC 304.1
- USE GROUP 'S-1' (STORAGE). NON SEPARATED MIXED USES -MOST RESTRICTIVE 'S-1' USE SHALL BE APPLIED TO ENTIRE BUILDING (MBC 508.3.1)

CONSTRUCTION CLASSIFICATION:

- TYPE VB (MBC 602.5)

FIRE SUPPRESSION REQUIREMENTS:

- BUILDING IS NOT PROTECTED BY A FIRE SUPPRESSION AUTOMATIC FIRE SPRINKLER SYSTEM (MBC 903.2).
- PROPOSED BUILDING DOES NOT HAVE ANY HIGH PILE STORAGE - PROPOSED BUILDING DOES NOT HAVE ANY REQUIREMENTS FOR STANDPIPES - PROPOSED BUILDING WILL NOT HAVE A GENERATOR

PRELIMINARY OVERALL FLOOR PLAN

SCALE: 1/8" = 1'-0"

BUILDING AREA:

- TOTAL BUILDING AREA= 5,609 S.F. (GROSS)

ALLOWABLE AREA:

- TYPE V B, MBC 506.2 - PROPOSED BUILDING IS 5609 S.F. ≤ 9,000 S.F. - ACCEPTABLE
- ALLOWABLE BUILDING HEIGHT: - PER 'B', TYPE V B: 40 FEET, 3 STORIES (MBC TABLE 504.3, 504.4) - PROPOSED BUILDING 21'-10", ONE-STORY - ACCEPTABLE

BUILDING OCCUPANCY:

- PER MBC TABLE 1004.1.2
- TOTAL BUILDING AREA:5,602 S.F. MINUS 498 S.F. PERIMETER WALL THICKNESS = 5,104 S.F.
- 'B' USE BUSINESS 929 S.F. / 100 S.F. PER OCC. = 9 OCCUPANTS 4,175 S.F. / 300 S.F. PER OCC. = 14 OCCUPANTS STORAGE/ MECH. SPACE TOTAL BUILDING OCCUPANTS = 23 OCCUPANTS

MINIMUM NUMBER OF EXITS:

- MBC TABLE 1006.3.1

23 OCCUPANTS = 2 EXITS REQUIRED | 5 EXITS PROVIDED

EXIT WIDTH REQUIREMENTS:

- DOORS (MBC 1005.3.2)

23 OCCUPANTS X 0.2" PER OCCUPANT = 5.0" TOTAL DOOR WIDTH REQUIRED AT 33" CLEAR WIDTH PROVIDED PER 36" DOOR, A MINIMUM OF 2 EXIT DOORS ARE REQUIRED 5 EXIT DOORS ARE PROVIDED

EXIT DISTANCE LIMITATIONS:

- 200' MAX ALLOWED (MBC TABLE 1017.2) - ALL OCCUPANTS ARE WITHIN 200 FEET OF AN EXIT


- REQUIRED EXIT DOOR SEPARATION IS GREATER THAN $rac{1}{3}$ OF THE LENGTH OF MAXIMUM OVERALL DIAGONAL DIMENSION OF THE AREAS SERVED (MBC 1007.1.1 EXCEPTION 2)

FIRE RESISTANCE RATINGS OF BUILDING ELEMENTS:

- TYPE 'II B' CONSTRUCTION

STRUCTURAL FRAME 0 HR. (MBC TABLE 601) 0 HR. (MBC TABLE 601) BEARING WALLS - EXTERIOR BEARING WALLS - INTERIOR 0 HR. (MBC TABLE 601) NON-BEARING WALLS - EXTERIOR 0 HR. (MBC TABLE 601) NON-BEARING WALLS - INTERIOR 0 HR. (MBC TABLE 601) FLOOR CONSTRUCTION 0 HR. (MBC TABLE 601) ROOF CONSTRUCTION 0 HR. (MBC TABLE 601) SHAFTS STAIR WELL N/A FIRE WALL N/A


4 132'-8" MANAGERS OFFICE 8'-6" X 13-0" 23'-4" 123'-0"

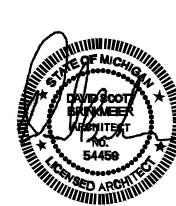



 $\overset{\mathbb{Z}}{\mathsf{AR}}$

PROJECT NUMBER: 24021 SHEET NUMBER: PFP-4

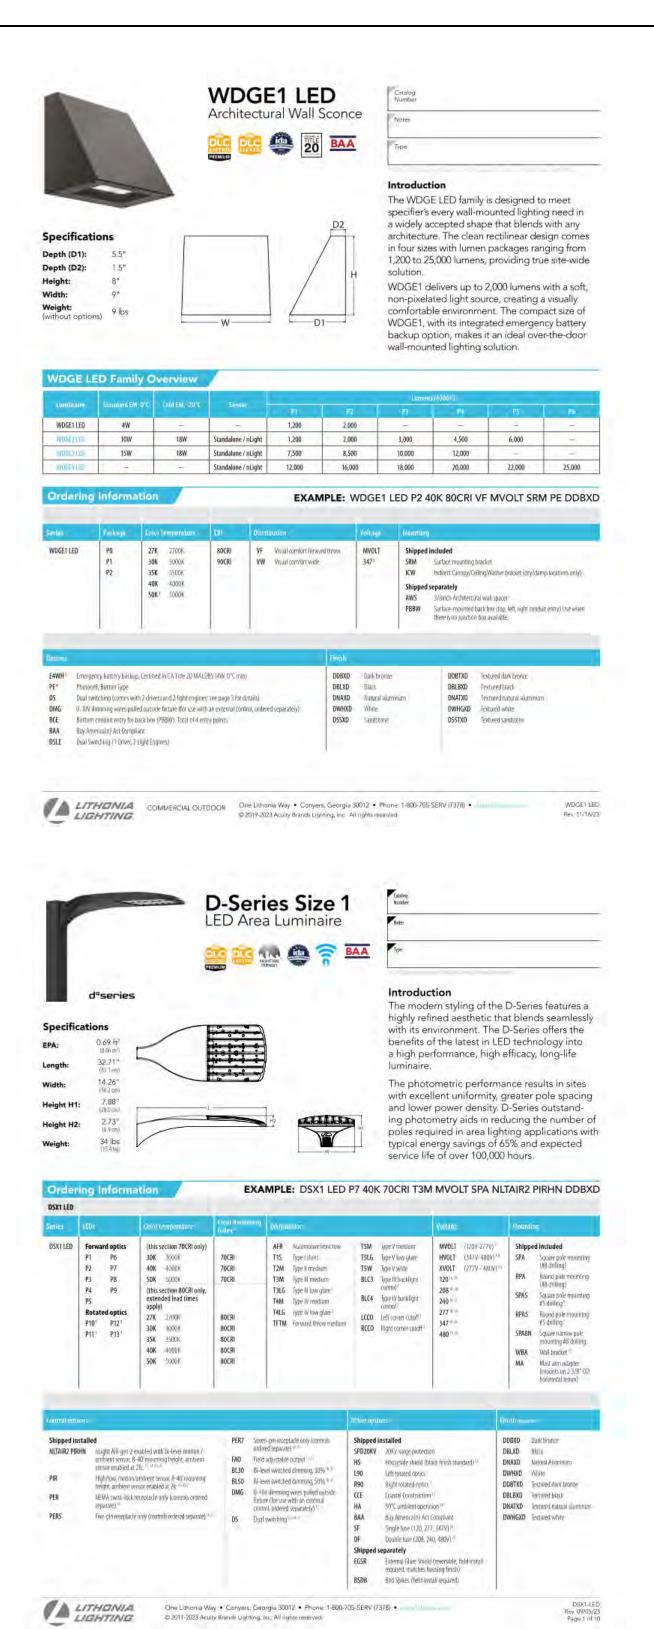

General Note

- 1. SEE SCHEDULE FOR LUMINAIRE MOUNTING HEIGHT.
- 2. SEE LUMINAIRE SCHEDULE FOR LIGHT LOSS FACTOR.
- 3. CALCULATIONS ARE SHOWN IN FOOTCANDLES AT: GRADE

THE ENGINEER AND/OR ARCHITECT MUST DETERMINE APPLICABILITY OF THE LAYOUT TO EXISTING / FUTURE FIELD CONDITIONS. THIS LIGHTING LAYOUT REPRESENTS ILLUMINATION LEVELS CALCULATED FROM LABORATORY DATA TAKEN UNDER CONTROLLED CONDITIONS IN ACCORDANCE WITH ILLUMINATING ENGINEERING SOCIETY APPROVED METHODS. ACTUAL PERFORMANCE OF ANY MANUFACTURER'S LUMINAIRE MAY VARY DUE TO VARIATION IN ELECTRICAL VOLTAGE, TOLERANCE IN LAMPS, AND OTHER VARIABLE FIELD CONDITIONS. MOUNTING HEIGHTS INDICATED ARE FROM GRADE AND/OR FLOOR UP.

THESE LIGHTING CALCULATIONS ARE NOT A SUBSTITUTE FOR INDEPENDENT ENGINEERING ANALYSIS OF LIGHTING SYSTEM SUITABILITY AND SAFETY. THE ENGINEER AND/OR ARCHITECT IS RESPONSIBLE TO REVIEW FOR MICHIGAN ENERGY CODE AND LIGHTING QUALITY COMPLIANCE.

UNLESS EXEMPT, PROJECT MUST COMPLY WITH LIGHTING CONTROLS REQUIRMENTS DEFINED IN ASHRAE 90.1 2013. FOR SPECIFIC INFORMATION CONTACT GBA CONTROLS GROUP AT ASG@GASSERBUSH.COM OR 734-266-6705

Alternates Note

THE USE OF FIXTURE ALTERNATES MUST BE RESUBMITTED TO THE CITY FOR APPROVAL

Drawing Note


THIS DRAWING WAS GENERATED FROM AN ELECTRONIC IMAGE FOR ESTIMATION PURPOSE ONLY. LAYOUT TO BE VERIFIED IN FIELD BY OTHERS.

Ordering Note

FOR INQUIRIES CONTACT GASSER BUSH AT QUOTES@GASSERBUSH.COM OR 734-266-

6705. **Mounting Height Note**

MOUNTING HEIGHT IS MEASURED FROM GRADE TO FACE OF FIXTURE. POLE HEIGHT SHOULD BE CALCULATED AS THE MOUNTING HEIGHT LESS BASE HEIGHT.

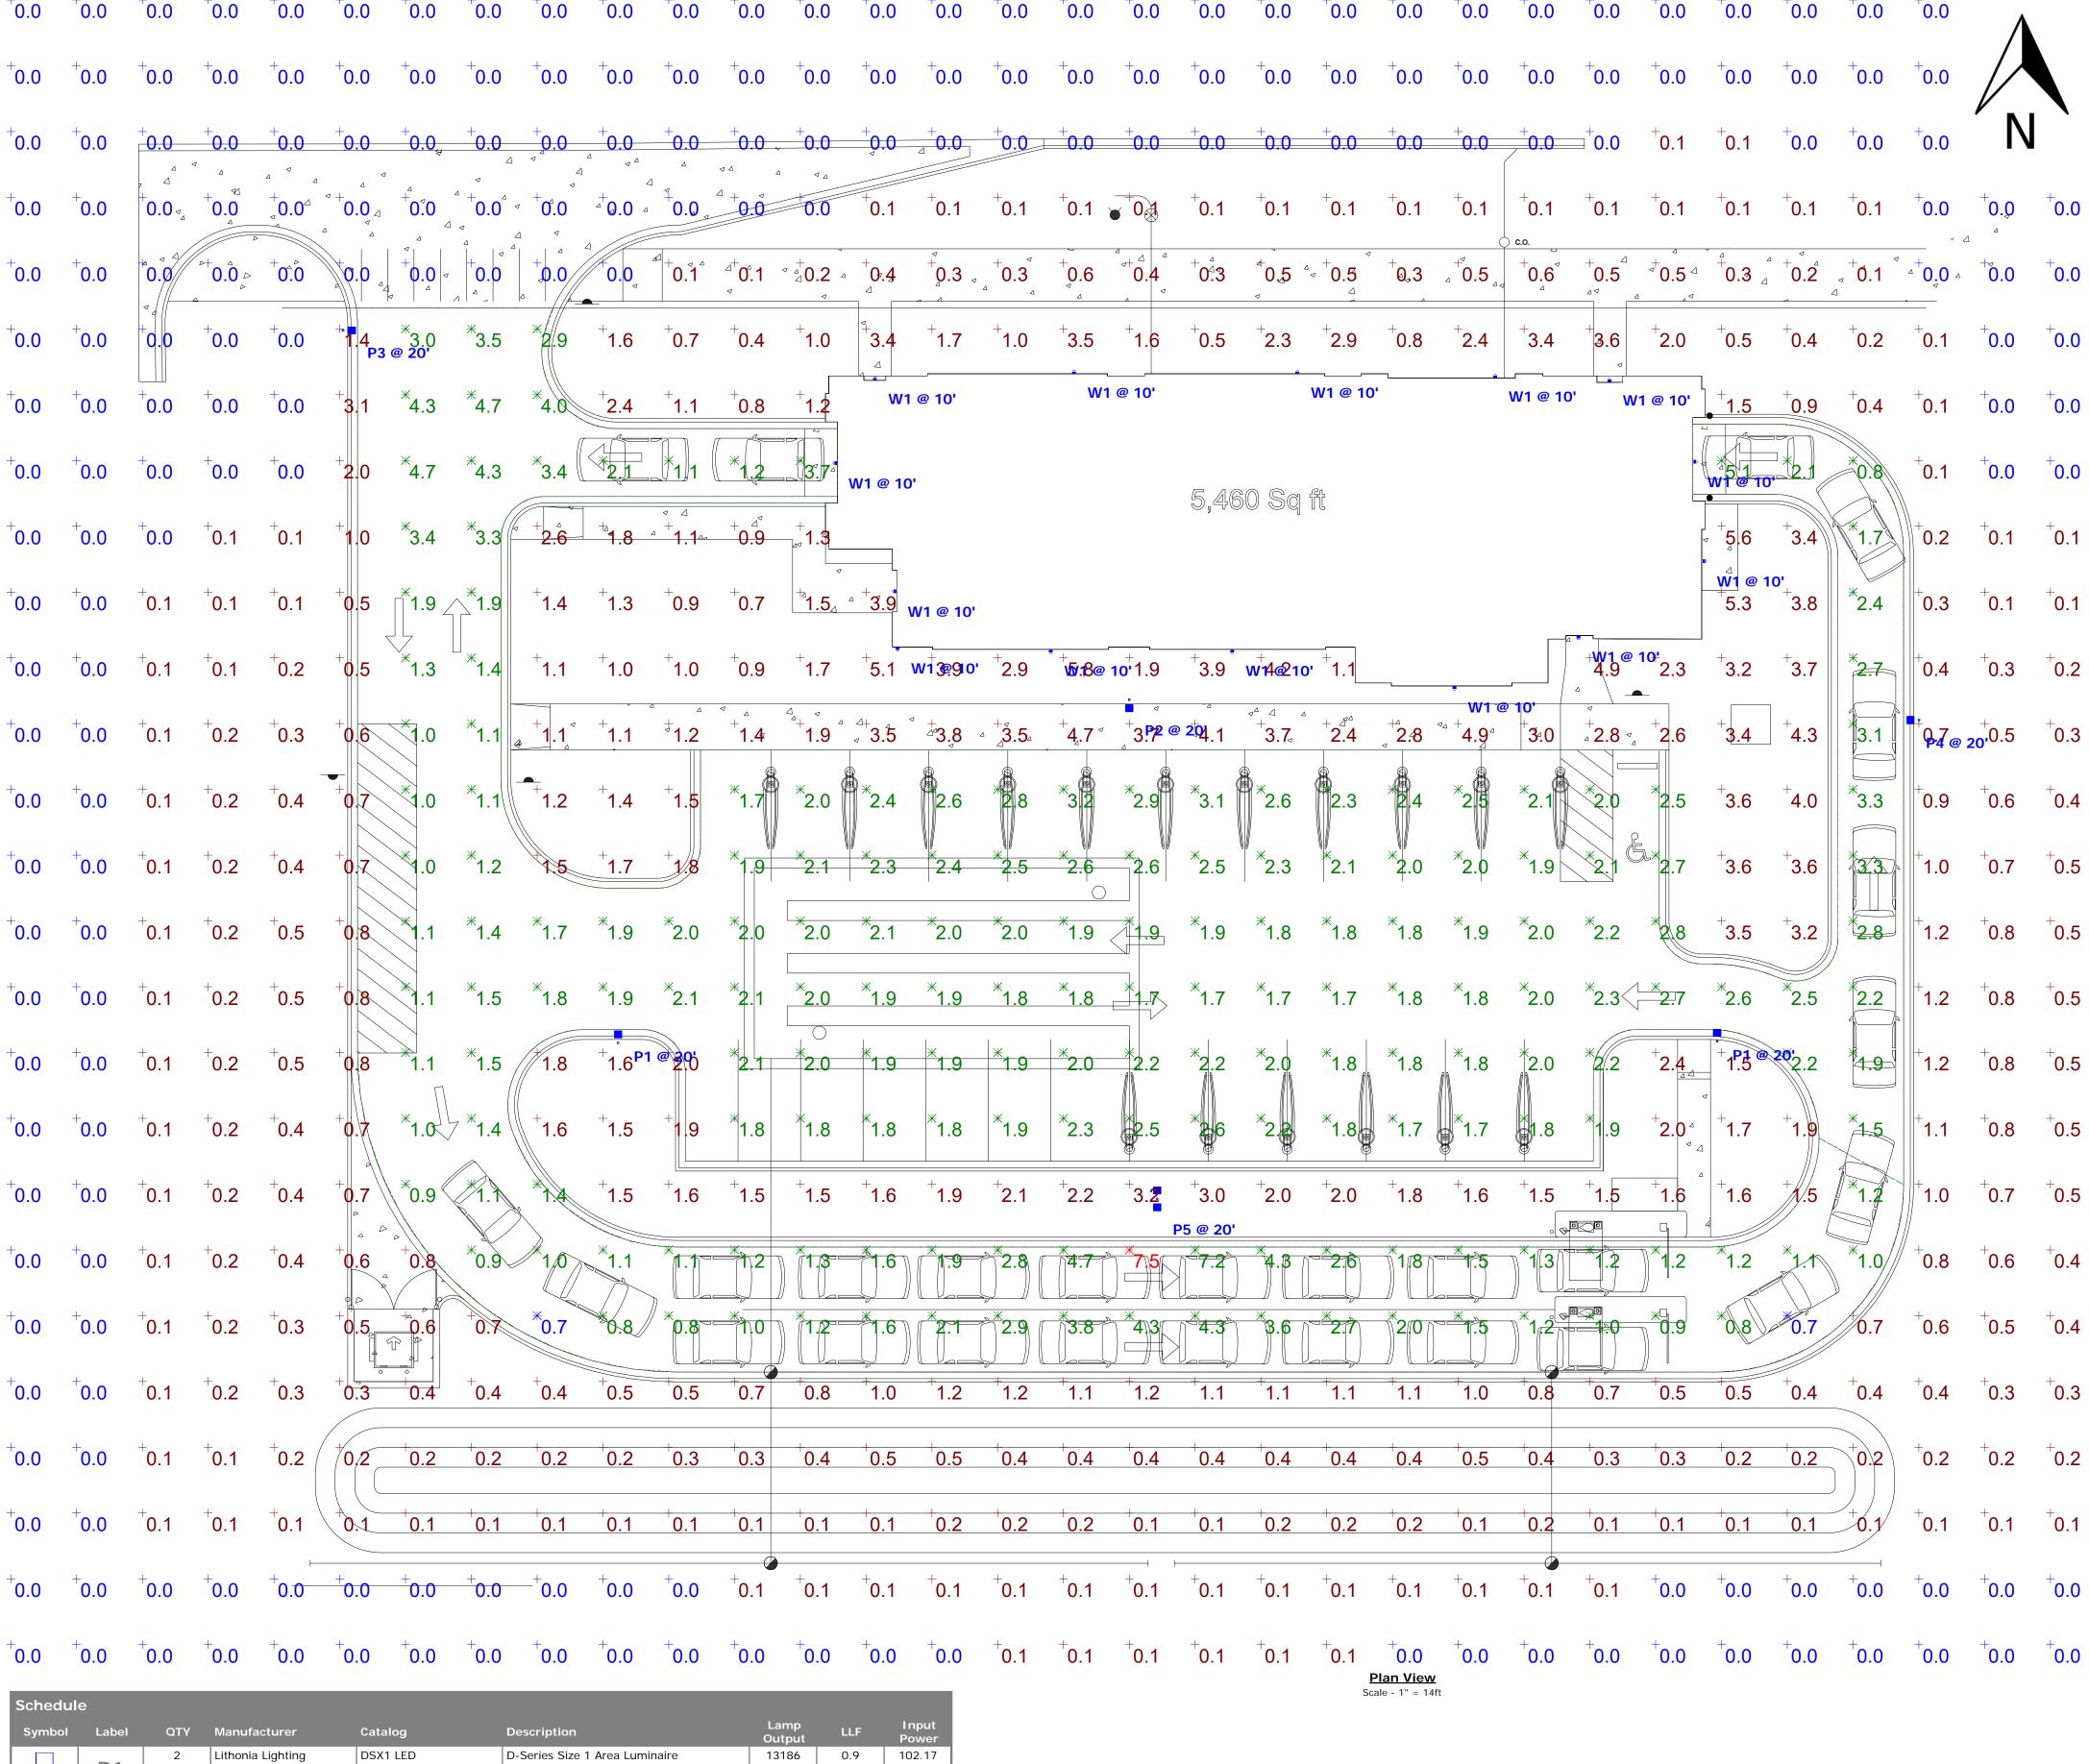

Symbol	Label	QTY	Manufacturer	Catalog	Description	Lamp	LLF	Input
Symbol	Labei	QIY			Description	Output		Power
	P1	2	Lithonia Lighting	DSX1 LED	D-Series Size 1 Area Luminaire	13186	0.9	102.17
	P2	1	Lithonia Lighting	DSX1 LED	D-Series Size 1 Area Luminaire	12483	0.9	102.17
	Р3	1	Lithonia Lighting	DSX1 LED	D-Series Size 1 Area Luminaire	9268	0.9	102.17
	P4	1	Lithonia Lighting	DSX1 LED	D-Series Size 1 Area Luminaire	9186	0.9	102.17
	P5	1	Lithonia Lighting	[]	[]	[]	0.9	135.58
			Lithonia Lighting	DSX1 LED	D-Series Size 1 Area Luminaire	8855	0.9	67.79
			Lithonia Lighting	DSX1 LED	D-Series Size 1 Area Luminaire	9559	0.9	67.79
	W1	14	Lithonia Lighting	WDGE1 LED	WDGE1 LED	1227	0.9	10.0002

Statistics						
Description	Symbol	Avg	Max	Min	Max/Min	Avg/Min
arking & Drive Lanes	Ж	2.1 fc	7.5 fc	0.7 fc	10.7:1	3.0:1
Overall/Grade	+	1.0 fc	7.5 fc	0.0 fc	N/A	N/A

Designer Date 04/25/2024 Scale Not to Scale Drawing No. #24-26955 V2

XTERIOR GASSER I WWW.G

View 1 5-9-24



Proposed Exterior Renderings for:





























K&S Engineers, LLC

Consultants in Acoustics, Noise and Vibration

2024-004 April 18, 2024

Mr. Todd Gesund Vice-President Jax Kar Wash 26777 Central Park Blvd., Suite 180 Southfield, MI 48076

Subject: Car Wash Community Noise Impact Study

re: Jax Kar Wash - Troy, MI

Dear Mr. Gesund:

At your request and authorization, K & S Engineers, LLC (K&SE) has conducted an investigation to provide a community noise impact study for the proposed car wash. This investigation projects the expected sounds from the proposed car wash to the nearby residential properties and compares the results to ambient sound level measurements and the City of Troy noise ordinance. This evaluation compares the noise from various sources including car wash and vacuum station related sound sources.

Proposed Site

The location of the proposed Jax Kar Wash is to the south of E Long Lake Road, 300-feet east of Livernois Road. Properties to the south of the proposed car wash are zoned residential. Exhibit 1 provides an aerial view of the proposed car wash site.

Sound level predictions were based on the location of property lines, and measured sound levels of car wash equipment. The following document was utilized for the predictions:

PEA Group plan, Jax Kar Wash – Troy, MI dated 2/5/2024.

City of Troy Noise Code

The City of Troy provides objective noise limits in their Zoning Ordinance Section 12.06 *Environmental Performance Standards*, subsection *H*. The ordinance excerpt reads:

H. Noise. The emission of measurable noises from the premises shall not exceed sixty-five (65) decibels as measured at the boundary property line, except that where normal street traffic noises exceed sixty-five (65) decibels during such periods, the measurable noise emanating from premises may equal, but not exceed such traffic noises. Within the IB district, sound levels not exceeding seventy (70) decibels may be permitted.

Mr. Todd Gesund Jax Kar Wash

These limits apply at the residential properties to the south.

Understanding Sound and How it is Measured

To aid in the understanding of the results of this investigation, we have provided some discussion on the basics of sound and sound measurements. Sound is a rapid fluctuation of air pressure that occurs in a range that is detectable by human hearing. Sound pressure can be measured in units of Pascals (Pa), though would range from 2x10-5 to over 10 million! To compress this tremendous scale to manageable numbers, as well to create a scale that reflects human perception of sound, the decibel sound scale was developed. The decibel sound scale is a unit of measure based on a logarithmic equation with specific reference to the human threshold of hearing. Because of the logarithmic nature, sound levels in decibels do not add, or subtract by simple arithmetic. Similarly, human response to sound is logarithmic rather than linear in nature.

The decibel sound scale generally ranges from 0 dB to 180 dB, where 0 dB is the threshold where we begin to hear and 180 dB is an approximate maximum audible level, though pain associated with hearing starts at 120-140 dB. Relative to human perception of sound, a 3-dB increase (or decrease) in level is the threshold at which people begin to notice a change. A change less than a 3 dB is generally undetectable to the normal populace. Additionally, a 3-dB increase is an actual doubling of sound energy, though it takes a 10 dB increase for humans to perceive a doubling of loudness. For reference, a quiet library typically has an ambient sound level of 20-30 dB. Normal speech at a 3-foot distance is approximately 60 to 65 dB. **Appendix A** provides a chart of sound levels for some typical sound sources encountered in daily living.

Measured Ambient Sound Levels

To determine the current ambient sound levels experienced at residential properties adjacent to the proposed Jax Kar Wash, we conducted sound level measurements near the residential property line, at the south end of the proposed site. The measurements were conducted at a location 210-feet south of E Long Lake Road, and 470-feet east of Livernois Road. **EXHIBIT 2** provides an aerial image of the measurement location relative to proposed Jax Kar Wash site and residential properties to the south.

Measurements were conducted for a continuous 24-hour period using a calibrated real-time environmental noise analyzer, with a precision microphone and a preamplifier assembly. Calibration was performed prior to and after the measurements using a Britel and Kjer type 4231 Acoustic Calibrator.

The results of our measurements are provided as a sound level versus time plot provided in **EXHIBIT 3**. The results of these measurements show that average sound levels near the residential properties were 57 dB(A) during daytime hours when the car wash is expected to operate. These sound level values are lower than the ordinance limit of 65 dB(A).

Additionally, we conducted sound level measurements at a representative Jax Kar Wash at 26550 Greenfield Road, Oak Park, MI. Measurements were conducted to quantify the sound produced by the various sound sources of the proposed Jax Kar Wash. These sources include: the entrance and

exit of the car wash building during washing and drying activities, vacuum equipment, compressed air nozzles, and vehicles moving on site.

Advanced Computer Modeling Noise Prediction

Sound is a physical phenomenon that can be readily projected and predicted with reasonable accuracy. To help evaluate the sounds created by the proposed Jax Kar Wash and determine what noise impact may occur at the adjacent residential boundaries, we developed an advanced three-dimensional, outdoor acoustical model. This model allows accurate projection and prediction of sound levels created by the operation of known building mechanical systems, vehicle movements, and delivery operations. The computer program we use for this modeling relies on international standards (such as ISO 9613) to properly calculate and predict sound levels. The computer program relies on user inputs of terrain, structures, foliage, obstacles, sound reflective and absorptive surfaces, receiver positions, as well as the type of sound source, including point sources (small individual devices, such as small fans), line sources (numerous sources in a line, such as road traffic), and area sources (sources with large surface areas, such as transformers). By using this predictive tool, we have constructed virtual acoustic model of the proposed car wash and have developed sound level projections and predictions for its operation.

Predictions of the Proposed Jax Kar Wash

The proposed car wash will have various sources of sound from the equipment on site and patron activities. Jax Kar Wash sources include:

- Wash operation sound generated from wash equipment and dryers, emitting from the entrance and exit.
- A centralized vacuum system with the vacuum motor located within the building, and vacuum lines running underground from the building to the vacuum stations.
- Compressed air nozzles at the vacuum stations, with compressed air lines running underground, supplied from a central compressor within the building.
- Vehicles moving on site at slow speeds, typically less than 10 MPH.

The results of our model predictions are presented in **EXHIBIT 4**. The results provide the expected sound levels from the operations of the Jax Kar Wash along the residential property lines. The results show that the car wash sound levels are expected to be below the ordinance noise limits. Additionally, the predicted sound levels are expected to be similar to the daytime ambient sound levels along the residential property lines, in most locations. That is to say, sound levels are expected to be within 3 dB of the average ambient levels (see *Understanding Sound and How it is Measured*, above).

Based on our measurements and evaluation of the Jax Kar Wash operations, we expected the proposed car wash to comply with the local ordinance noise limits at all residential properties.

Mr. Gesund, we hope the information from our investigation is informative and helpful. Should you need additional information regarding this work or additional assistance, don't hesitate to contact us.

Sincerely,

K & S ENGINEERS, LLC

Darren Brown, P.E. INCE Board Certified Principal Consultant

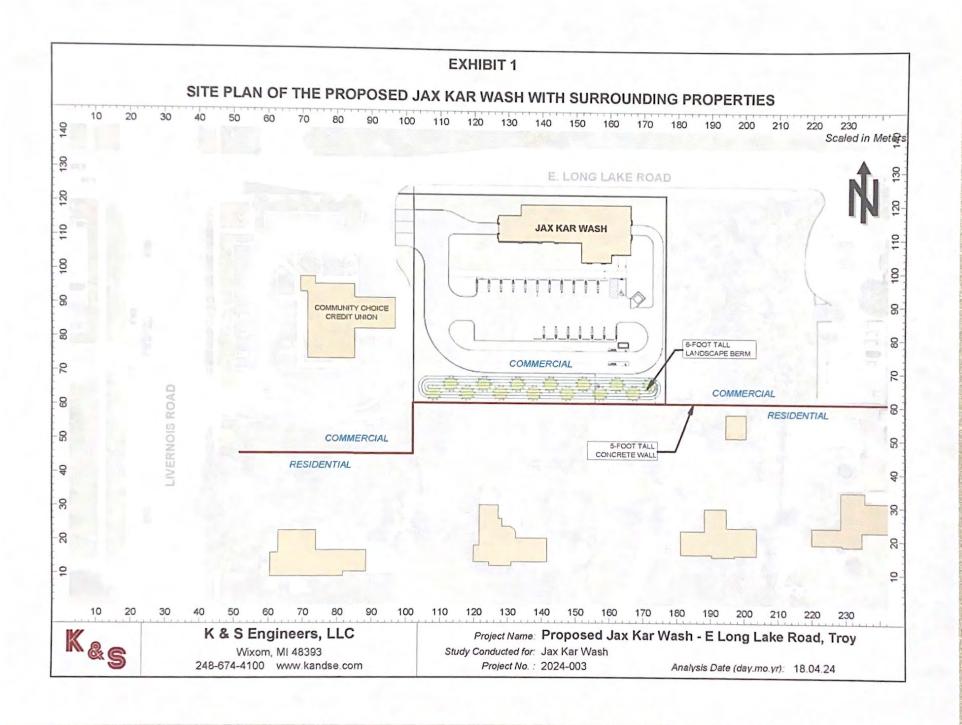


EXHIBIT 2


AERIAL IMAGE OF THE PROPOSED JAX KAR WASH SITE DETAILING THE LOCATION OF AMBIENT 24-HOUR SOUND LEVEL MEASUREMENTS




EXHIBIT 3

Ambient Sound Levels at the Proposed Jax Kar Wash Site

Measured at a Position 210-ft South of E. Long Lake Rd., and 470-ft East of Livernois Rd.

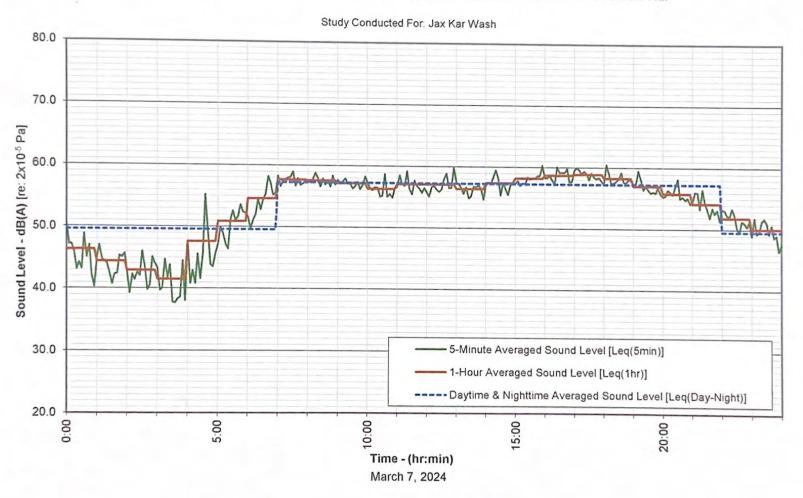

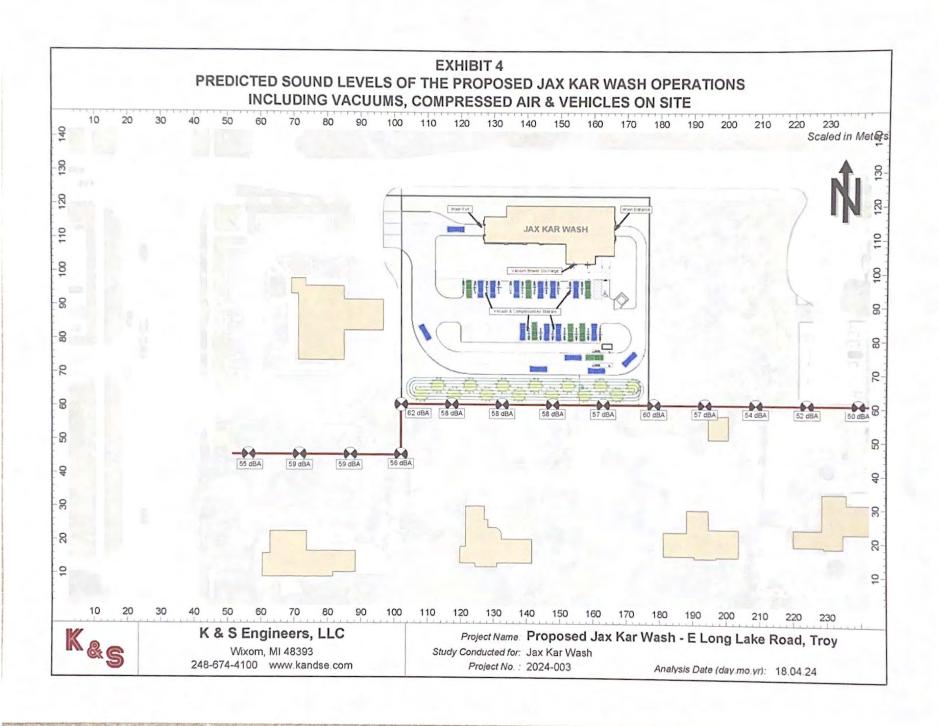

K & S Engineers, LLC

Consultants in Acoustics & Noise Control 248-674-4100 - www.kandse.com

APPENDIX A

Sound Level of Typical Sources					
Sound Level dB(A)	Subjective Impression	Outdoor	Indoor		
180		Rocket Launch, Artillery Fire			
160	Extremely Loud	Rifle Shot at Shooters Ear			
130	Pain	Fire Cracker at 30 Feet			
120	Uncomfortable	Jet Plane Taking Off at 200 Feet			
110		Jet Flyover at 1000 Feet	Rock Concert, Dance Club		
100	Very Loud	Motorcycle pass-by at 25 Feet			
90		Lawn Mower at 5 Feet	Food Blender at 3ft.		
80	Moderately Loud	Diesel Truck Pass-by (50mph) at 50 Feet	Vacuum Cleaner at 4ft.		
70		Car pass-by (50mph) at 50 Feet			
60		Residential Air Cond. Condenser at 15 Feet	Normal Conversation at 5ft.		
50	Quiet	Large transformer at 100 Feet			
40		Bird Calls at 100 Feet	Open office with low activity		
30	Very Quiet		Soft Whisper at 5ft.		
20		Tree Leaves Rustling In Wind	Quiet Bedroom		
10	Just Audible		Normal Breathing		
0	Hearing Threshold				

It should be noted that sound level is a function of sound power and distance from the source. The examples given are approximate and show the general range where they are normally heard.