

PLANNING COMMISSION MEETING AGENDA REGULAR MEETING

Marianna Perakis, Chair, Lakshmi Malalahalli, Vice Chair Toby Buechner, Carlton Faison, Tyler Fox, Michael W. Hutson, Tom Krent, Dave Lambert and John J. Tagle

July 23, 2024 7:00 P.M. Council Chambers

- 1. ROLL CALL
- 2. APPROVAL OF AGENDA
- 3. APPROVAL OF MINUTES July 9, 2024
- 4. PUBLIC COMMENT For Items Not on the Agenda

SPECIAL USE REQUEST

5. <u>SPECIAL USE AND PRELIMINARY SITE PLAN REVIEW (SU JPLN2024-003)</u> - Proposed Starbucks with drive through, North side of Big Beaver, West of John R (1735 E. Big Beaver), Section 23, Currently Zoned CB (Community Business) Zoning District

PRELIMINARY SITE PLAN APPROVAL

- 6. <u>PRELIMINARY SITE PLAN APPROVAL (JPLN2023-0028)</u> Proposed John R Commons Townhome Development, West side of John R, North of Big Beaver (PIN 88-20-23-476-017), Section 23, Zoned MF (Multi-Family Residential) Zoning District
- 7. PRELIMINARY SITE PLAN APPROVAL (JPLN2023-0031) —. Proposed Wattles Square Apartments, South side of Wattles and east of John R (PIN 88-20-24-100-039), Section 24, Zoned NN (Neighborhood Node "F") Zoning District

OTHER ITEMS

- 8. <u>PUBLIC COMMENT</u> For Items on the Agenda
- 9. PLANNING COMMISSION COMMENT
- 10. ADJOURN

NOTICE:People with disabilities needing accommodations for effective participation in this meeting should contact the City Clerk by e-mail at clerk@troymi.gov or by calling (248) 524-3317 at least two working days in advance of the meeting. An attempt will be made to make reasonable accommodations

Chair Perakis called the Regular meeting of the Troy City Planning Commission to order at 7:00 p.m. on July 9, 2024, in the Council Chamber of the Troy City Hall. Chair Perakis and Vice Chair Malalahalli presented opening remarks relative to the role of the Planning Commission and procedure of tonight's meeting.

1. ROLL CALL

Present:

Toby Buechner
Carlton M. Faison
Tyler Fox
Michael W. Hutson
Tom Krent
David Lambert
Lakshmi Malalahalli

Marianna Perakis

Absent:

John J. Tagle

Also Present:

Ben Carlisle, Carlisle Wortman & Associates R. Brent Savidant, Community Development Director Julie Quinlan Dufrane, Assistant City Attorney Kathy L. Czarnecki, Recording Secretary

2. APPROVAL OF AGENDA

Resolution # PC-2024-07-039

Moved by: Faison Support by: Fox

RESOLVED, To approve the agenda as prepared.

Yes: All present (8)

Absent: Tagle

MOTION CARRIED

3. APPROVAL OF MINUTES – June 25, 2024

Resolution # PC-2024-07-040

Moved by: Malalahalli Support by: Lambert

RESOLVED, To approve the minutes of June 25, 2024 Regular meeting as submitted.

Yes: Buechner, Faison, Hutson, Krent, Lambert, Malalahalli, Perakis

Abstain: Fox Absent: Tagle

MOTION CARRIED

4. <u>PUBLIC COMMENT</u> – For Items Not on the Agenda

There was no one present who wished to speak.

STREET VACATION REQUEST

5. <u>PUBLIC HEARING - STREET VACATION REQUEST (SV JPLN2024-0002)</u> – Request to vacate a portion of a right of way, approximately 30-feet wide by 263.2-feet long, West of Rochester, between Lovell and Hannah, Abutting 801 Hannah (PIN 88-20-03-276-001), Platted as part of Clark Estates Subdivision, in Section 3

Mr. Savidant presented a brief slide presentation on what is a Street Vacation application and its approval process.

Mr. Savidant gave a brief background of the vacation request for consideration this evening. He referenced thirteen reasons listed by the applicant to vacate the street. Mr. Savidant stated public comment received shared concern the applicant might split the property to build a home. Mr. Savidant said the Engineering Department and Department of Public Works do not support the request. He said the departmental review comments state City utilities should remain in the rights of way whenever possible and that there appears to be no apparent benefit to the City.

Present were attorney Darius Dynkowski of Butzel Long law firm and applicant Olimpiu (Ollie) Apahidean.

Mr. Apahidean said his extensive research of public records on street and alley vacation requests previously considered by the Planning Commission and the City Council indicate the majority of the requests were granted and very few were denied. He detailed the unique situation of the non-conforming lot which is the only non-conforming lot in the subdivision. Mr. Apahidean said a variance from the Zoning Board of Appeals would be required to obtain a building permit for any future improvements to the property.

Mr. Apahidean said he wants to restore the City right of way back to an easement as the property was originally platted. Mr. Apahidean said he does not intend to split the parcel to build another home or to build an addition to the existing home. He said the property would remain unobstructed, there would be access for emergency service vehicles, pedestrians and school children could continue to traverse the property and wildlife would not be inhibited.

Some comments during discussion related to the following:

- Uniqueness of property as situated in subdivision.
- Driveway of existing home situated in the right of way; potential liability concerns.
- Intent of property owner if street vacation is granted.
- Disclosure of encumbrances of property at time of purchase in January 2024.
- Existing City watermain in right of way.
- Public trail system; no current plan for a trail connection to this corridor.
- The City's best interest is that property remains a right of way.

PUBLIC HEARING OPENED

- Sheila Gull, 6579 Norton; addressed concern property will be split to build a home, change in neighborhood character, home is a rental property.
- John Terenzi, 841 Hannah; addressed concern property will be split to build a home, change integrity of subdivision, loss of pedestrian/recreational access.
- Alyson Sloan, 821 Hannah; addressed concern property will be split to build a home, either by applicant or future property owner.
- Stephen Douglas Wright, 726 E. Lovell; said his parents (owners of 726 E. Lovell) have not had time to consider how application might affect their property.
- Derek Queen, 783 Hannah; addressed loss of pedestrian/recreational access if privately owned.
- Donna Parlo, 783 Hannah; addressed school district boundaries.

PUBLIC HEARING CLOSED

Discussion continued:

- Clarification on property purchase/ownership.
- City notification of the Public Hearing.

Mr. Apahidean addressed what he perceived as speculative and inappropriate public comments as relates to property ownership and his intent to bring the property into conformance.

Resolution # PC-2024-07-041

Moved by: Krent Seconded by: Buechner

RESOLVED, That the Planning Commission hereby recommends to the City Council that the Street Vacation request, to vacate an unconstructed portion of right of way, approximately 30-feet wide by 263.2-feet long, abutting 801 Hannah, Platted as an Easement as part of Clark Estates Subdivision, in Section 3, be **denied**, for the reason that the City Water and Sewer Department says if possible not to change a right of way into an easement where there are utilities involved, and for specific reasons as follows:

- 1. Vacating the right of way offers no benefit to the City.
- 2. Utilities within rights of way are preferred over easements.
- 3. Right of way was acquired specifically for construction of a watermain.
- 4. Utilities should remain within rights of way when possible.
- 5. It is in the City's best interest to retain intact the right of way between Lovell and Quill Creek.

Discussion on the motion on the floor.

Mr. Lambert said he supports the resolution based on the City staff comments and objection to the request. He noted this is the first street vacation request to which the City staff objected since he has served on the Planning Commission.

Mr. Hutson said he supports the resolution because the applicant's statement that he would never interfere with anyone walking, entering or using the land is not legally enforceable.

Vote on the motion on the floor.

Yes: Buechner, Faison, Hutson, Krent, Lambert, Malalahalli, Perakis

No: Fox Absent: Tagle

MOTION CARRIED

PRELIMINARY SITE PLAN APPROVAL

 PRELIMINARY SITE PLAN APPROVAL (JPLN2023-0020) – Proposed The Rookery of Troy Mixed Use Development, West of Dequindre, South of Long Lake (Parcels 88-20-13-228-003 and 88-20-13-228-015), Section 13, Currently Zoned NN (Neighborhood Node "J") District

Mr. Carlisle reviewed the Preliminary Site Plan application for The Rookery of Troy mixed use development. He addressed individually the general retail and residential components of the development as relates to the number of units, building materials, access and circulation, parking, height of residential homes, five-foot sidewalk along entire complex, buffer to residential, landscaping, location of retail dumpster, lighting and EVA (Emergency Vehicle Access) on site.

Mr. Carlisle noted a parcel shown on the site plan is not part of the application under consideration this evening. The parcel is for a commercial building of which the Planning Commission would consider the application at a future date.

In summary, Mr. Carlisle asked the Planning Commission to consider if the Site Plan Review Design Standards have been met and to discuss with the applicant:

- Site elements that might encourage outdoor recreation.
- Length of driveways.
- Relocation of retail dumpster.

- Reduce light pole heights and move light pole from the southern property line.
- Remove retail EIFS building material; consider alternative building material.
- Provide additional landscaping internally and along property line.

Mr. Carlisle recommended any approval of the application to be subject to providing building height calculations for the residential homes and to provide the wall details to buffer residential.

Present were Project Architect Mark Abanatha, Project Engineer John Thompson of PEA Group and the applicant Joseph Maniaci.

There was discussion on:

- Adding patios to residential units; patio layout.
- Future commercial on site; applicant in negotiations with bank.
- Transition to existing single family; buffer, wall details.
- Outdoor recreational amenities as relates to scale of development.
- Side entry garages.
- Driveway lengths; consideration to expand.
- Location of retail trash receptacle.
- Photometric plan; mitigation of light pollution, applicant agrees to reduce pole heights and move pole on the southern property line.
- Applicant amenable to provide additional landscaping.
- Architectural residential and commercial design features; EIFS building material.
- Connectivity with adjacent residential homes; general comment from HOA to provide EVA.
- Placement of pedestrian crosswalks.

Moved by: Malalahalli Support by: Buechner

RESOLVED, That Preliminary Site Plan Approval, pursuant to Article 8 and Article 5 of the Zoning Ordinance, as requested for the proposed The Rookery of Troy Mixed Use Development, comprised of 23 residential units and approximately 7,000 square feet of retail, West of Dequindre and South of Long Lake (Parcels 88-20-13-228-003 and 88-20-13-228-015), Section 13, approximately 5.94 acres in size, Currently Zoned NN (Neighborhood Node "J") District, be postponed, for the following conditions and reasons:

- 1. Provide building height calculations on property elevations.
- 2. Provide wall details on the southern end of the property.
- 3. Landscaping details.
- 4. Recreational space usage with additional amenities to be provided for residents.
- 5. Crosswalk markings to be considered and revised if possible.
- 6. Amended photometric plan.
- 7. EIFS building material, to consider any other better building quality material.
- 8. Rendering with patio layout design.

Yes: All present (8) Absent: Tagle

MOTION CARRIED

OTHER ITEMS

7. <u>PUBLIC COMMENT</u> – For Items on the Agenda

There was no one present who wished to speak.

8. PLANNING COMMISSION COMMENT

There were general Planning Commission comments relating to connectivity between developments.

9. ADJOURN

The Regular meeting of the Planning Commission adjourned at 9:48 p.m.

Respectfully submitted,
Marianna J. Perakis, Chair
Kathy L. Czarnecki, Recording Secretary

https://d.docs.live.net/2f7ed4fe5f664ea8/Documents/Kathy/COT Planning Commission Minutes/2024/2024 07 09 Draft.docx

5. SPECIAL USE AND PRELIMINARY SITE PLAN REVIEW (SU JPLN2024-003) - Proposed Starbucks with drive through, North side of Big Beaver, West of John R (1735 E. Big Beaver), Section 23, Currently Zoned CB (Community Business) Zoning District

DATE: July 12, 2024

TO: Planning Commission

FROM: R. Brent Savidant, Community Development Director

SUBJECT: SPECIAL USE AND PRELIMINARY SITE PLAN REVIEW (SU JPLN2024-003) -

Proposed Starbucks with drive through, North side of Big Beaver, West of John R (1735 E. Big Beaver), Section 23, Currently Zoned CB (Community Business)

Zoning District

The petitioner Jim Butler of PEA Group submitted the above referenced Special Use Approval and Preliminary Site Plan Approval application for a Starbucks restaurant with drive through within an existing retail building. Restaurant drive throughs are permitted in the CB district, subject to special use approval.

The Planning Commission considered this item on May 14, 2024 and postponed the item for the following reasons:

Applicant to provide:

- a photometric plan
- larger context circulation plan
- dumpster plans
- pedestrian safety improvements
- tree ordinance compliance plan

A Circulation Plan for the property north of this proposed site was discussed at the June 25, 2024 Planning Commission Regular meeting.

The attached report prepared by Carlisle/Wortman Associates, Inc. (CWA), the City's Planning Consultant, summarizes the project. CWA prepared the report with input from various City departments including Planning, Engineering, Public Works and Fire. City Management supports the findings of fact contained in the report and the recommendations included therein.

Attachments:

- 1. Maps
- 2. Minutes from May 14, 2024 Planning Commission Regular meeting.
- 3. Minutes from the June 25, 2024 Planning Commission Regular meeting.
- 4. Report prepared by Carlisle/Wortman Associates, Inc.

PROPOSED RESOLUTION


<u>SPECIAL USE AND PRELIMINARY SITE PLAN REVIEW (SU JPLN2024-003)</u> - Proposed Starbucks with drive through, North side of Big Beaver, West of John R (1735 E. Big Beaver), Section 23, Currently Zoned CB (Community Business) Zoning District

beaver), Section 25, Santently Zoned SB (Sommanity	Business) Zoning Bistriot
Resolution # PC-2024-07-	
Moved by: Seconded by:	
RESOLVED , That Special Use Approval and Prel proposed Starbucks with drive through, North side of Big Beaver), Section 23, Currently Zoned CB (Commsubject to the following conditions):	Big Beaver, West of John R (1735 E.
) or
(denied, for the following reasons:) or
(postponed, for the following reasons:)
Yes:	
No: Absent:	
ANSCIII.	

MOTION CARRIED / FAILED

TROY


GIS Online

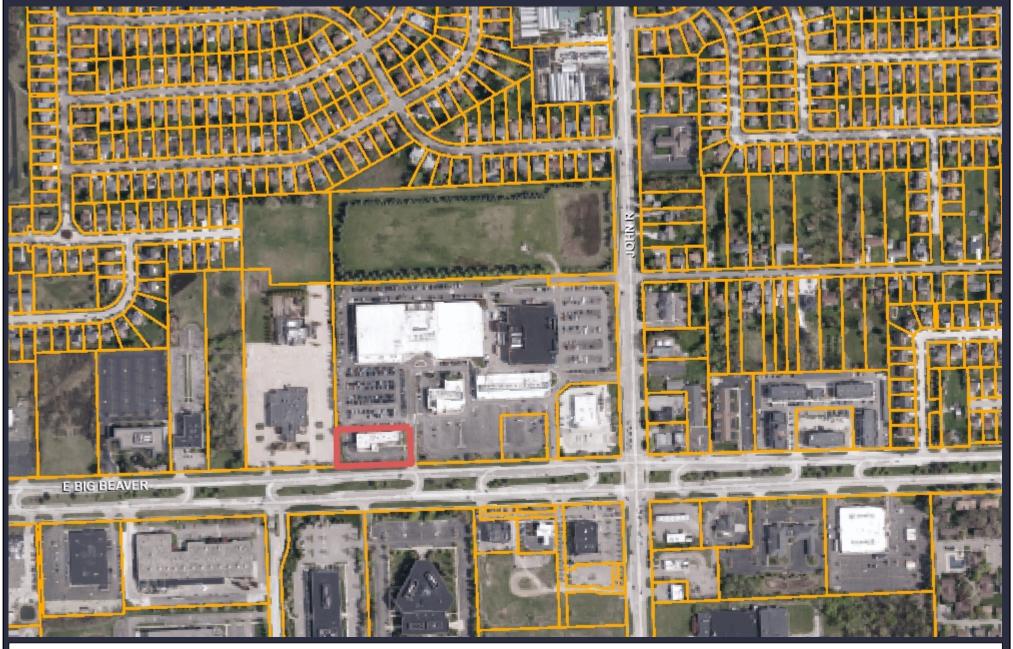

Note: The information provided by this application has been compiled from recorded deeds, plats, tax maps, surveys, and other public records and data. It is not a legally recorded map survey. Users of this data are hereby notified that the source information represented should be consulted for verification.

1,153

GIS Online

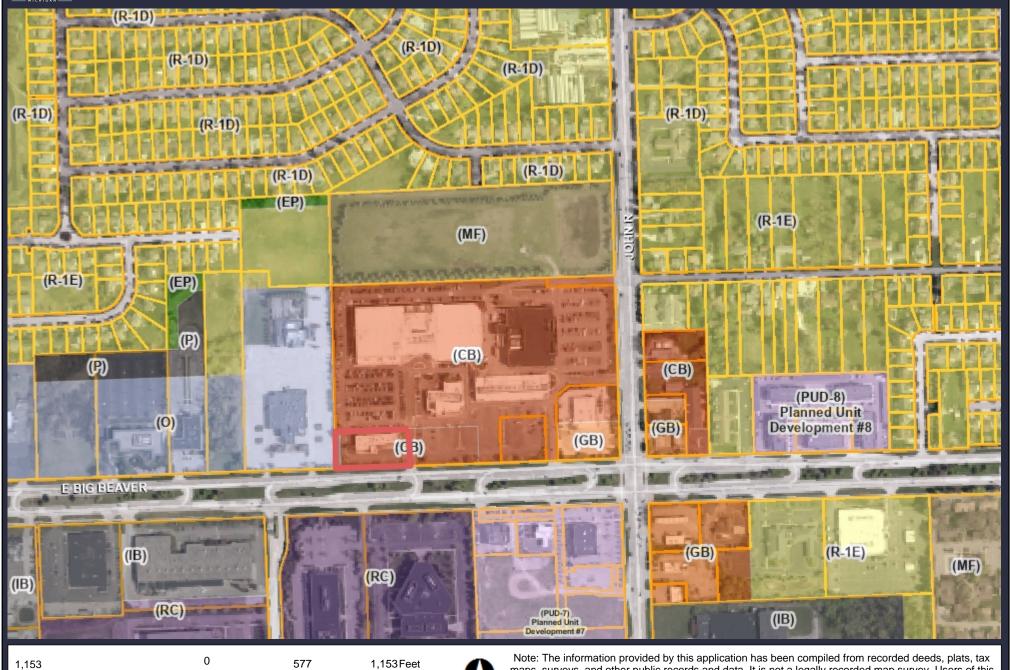



Note: The information provided by this application has been compiled from recorded deeds, plats, tax maps, surveys, and other public records and data. It is not a legally recorded map survey. Users of this data are hereby notified that the source information represented should be consulted for verification.

Chair Perakis called the Regular meeting of the Troy City Planning Commission to order at 7:02pm on May 14, 2024, in the Council Chamber of the Troy City Hall. Chair Perakis presented opening remarks relative to the role of the Planning Commission and procedure of tonight's meeting.

1. ROLL CALL

Present:

Toby Buechner
Carlton M. Faison
Tyler Fox
Michael W. Hutson
Tom Krent
David Lambert
Marianna Perakis

Absent:

Lakshmi Malalahalli

Also Present:

John J. Tagle

R. Brent Savidant, Community Development Director Ben Carlisle, Carlisle Wortman Associates Allan Motzny, Assistant City Attorney Jackie Ferencz, Planning Department staff

2. APPROVAL OF AGENDA

Resolution # PC-2024-05-22

Moved by: Fox Support by: Tagle

RESOLVED, To approve agenda as prepared.

Yes: All present (8)
Absent: Lakshmi Malalahalli

MOTION CARRIED

3. APPROVAL OF MINUTES – April 23, 2024

Resolution # PC-2024-05-23

Moved by: Lambert Support by: Buechner

RESOLVED, To approve the minutes of April 23, 2024 Regular meeting as submitted.

Yes: All present (8)
Absent: Lakshmi Malalahalli

MOTION CARRIED

PUBLIC HEARING – SPECIAL USE AND PRELIMINARY SITE PLAN REVIEW (SU JPLN2021-024) - Proposed Starbucks with drive through, North side of Big Beaver, West of John R (1735 E. Big Beaver), Section 23, Currently Zoned CB (Community Business) Zoning District.

Mr. Carlisle presented proposed Starbuck with drive through project.

There was discussion by Board members related to:

- Crosswalks
- Tree placement
- Speed tables
- Traffic Circulation

Applicants Jim Butler, PEA Group; Dennis Bostick, Troy Sports Center LLC; Brian Neeper, Brian Neeper Architecture presented their application.

Chair Perakis opened public comment

Chair Perakis closed public comment

Planning Commission Discussion

Resolution # PC-2024-05-25

Moved by: Fox

Seconded by: Buechner

RESOLVED, That Special Use Approval and Preliminary Site Plan Approval for the proposed Starbucks with drive through, North side of Big Beaver, West of John R (1735 E. Big Beaver), Section 23, Currently Zoned CB (Community Business) District, be **postponed** for the following reasons:

Applicant to provide:

- a photometric plan
- larger context circulation plan
- dumpster plans
- pedestrian safety improvements
- tree ordinance compliance plan

Yes: All (8)

Absent: Lakshmi Malalahalli

MOTION CARRIED

The Regular meeting of the Planning Commission adjourned at 9:22 p.m.

Respectfully submitted,

Marianna J. Perakis, Chair

Jackie Ferencz, Planning Department Staff

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Chair Perakis called the Regular meeting of the Troy City Planning Commission to order at 7:00 p.m. on June 25, 2024, in the Council Chamber of the Troy City Hall. Chair Perakis and Vice Chair Malalahalli presented opening remarks relative to the role of the Planning Commission and procedure of tonight's meeting.

1. ROLL CALL

Present:

Toby Buechner
Carlton M. Faison
Michael W. Hutson
Tom Krent
David Lambert
Lakshmi Malalahalli
Marianna Perakis
John J. Tagle

Absent:

Tyler Fox

Also Present:

Ben Carlisle, Carlisle Wortman & Associates R. Brent Savidant, Community Development Director Salim Huerta Jr., Commercial Project Collaborator Julie Quinlan Dufrane, Assistant City Attorney Kathy L. Czarnecki, Recording Secretary

2. APPROVAL OF AGENDA

Resolution # PC-2024-06-036

Moved by: Faison Support by: Buechner

RESOLVED, To approve the agenda as prepared.

Yes: All present (8)

Absent: Fox

MOTION CARRIED

3. APPROVAL OF MINUTES – June 11, 2024

Resolution # PC-2024-06-037

Moved by: Buechner Support by: Lambert

RESOLVED, To approve the minutes of June 11, 2024 Regular meeting as submitted.

Discussion on the motion on the floor.

Mr. Lambert said he is pleased that a cricket field, a much-desired recreational amenity for the City and its nearby communities, is moving forward.

Vote on the motion on the floor.

Yes: All present (8)

Absent: Fox

MOTION CARRIED

6. <u>CIRCULATION PLAN DISCUSSION</u> – Proposed John R Commons Townhome Development (JPLN2023-0028) and Starbucks with Drive-through (JPLN2021-024), West of John R, North of Big Beaver, Section 23

Mr. Savidant briefly introduced the proposed townhome development and Starbucks application that the Planning Commission considered at their May 14, 2024 meeting. He stated the circulation plan is for discussion only and the Planning Commission would take no action this evening.

Present were James Butler of PEA Group and City Traffic Consultant Stephen Dearing of OHM Advisors.

Mr. Butler reviewed the reconfiguration of the traffic circulation plan to maneuver traffic to the southwest corner where the Starbucks drive-through is proposed.

Mr. Dearing said the circulation plan is a significant improvement, one that makes the best of an existing circulation configuration that has evolved over time. He recommended approval of the proposed circulation plan.

There was discussion on:

- Bumped out island; extend one parking space.
- Closing off nearest, southern-most drive aisle (north/south) to drive-through.
- Location of trash dumpster.
- Overall landscaping, center aisles, parking lot trees.
- Provide pedestrian pathway on west side.
- Construction/traffic pattern challenges with existing power line.
- Turning curve at beginning of Starbucks drive-through.
- Overall circulation to accommodate existing retail and ice arena.
- Resurfacing existing parking lot to the north.
- Signage to direct traffic to Starbucks drive-through and Big Beaver exit.

Discussion points for consideration by applicant.

- Push "bumped out island" further (one parking space).
- Signage to direct traffic to drive-through and Big Beaver exit.
- Delineation (via landscaping) of Starbucks from ice arena/retail area.
- Provide striped pedestrian crossing within drive-through aisle.
- Consideration of closing off nearest, southern-most drive aisle (north/south) to drivethrough.
- Consideration to eliminate three-way traffic pattern(s) for public safety.
- Provide pedestrian pathway on west side.

Chair Perakis cited Zoning Ordinance Article 14.01, C.4 and C.5, Non-Conforming Lots, Uses and Structures.

OTHER ITEMS

7. <u>PUBLIC COMMENT</u> – For Items on the Agenda

There was no one present who wished to speak.

8. PLANNING COMMISSION COMMENT

There were general Planning Commission comments.

9. ADJOURN

The Regular meeting of the Planning Commission adjourned at 8:34 p.m.

Respectfully submitted,
Marianna J. Perakis, Chair
Kathy L. Czarnecki, Recording Secretary

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117 NORTH FIRST STREET SUITE 70 ANN ARBOR, MI 48104 734.662.2200 734.662.1935 FAX

To: Troy Planning Commission

From: Ben Carlisle, AICP

Date: July 16, 2024

RE: NW Corner of Big Beaver and John R. (Starbucks)

At the May 14, 2024 meeting, the Planning Commission reviewed a proposed Starbucks and a new multiple family development (John R. Commons). Both developments are under the same ownership and located at the NW corner of Big Beaver and John R.

At the May 14, 2024 meeting, Starbucks was continued for the following reasons:

1. Troy Sports Center Circulation Improvements

At the June 25th Planning Commission meeting, the applicant presented a revised circulation improvement plan for the Troy Sports Center parking lot. These improvements include:

- Added a cut-through through the west side of the main drive-aisle of the Troy Sports Center parking lot;
- Added a curb bump-out to direct traffic to the new cut-through; and
- Reconfigured access to the Starbucks drive-through.

A detailed review of the site circulation plan was provided by OHM. There was consensus at the June 25th meeting, that this improves overall onsite circulation.

- Dumpster location. The Planning Commission expressed concerns regarding the proposed dumpster location due to visibility and loss of parking. The applicant has rotated the dumpster 90-degrees to the west, so it is better screened and the opening does not face the drive-aisle and parking lot.
- 3. Landscaping. The applicant has added the required parking lot trees. We note that due to limited site area and the existing pavement, the applicant has added these trees to the perimeter of the site.

NW Corner of Big Beaver and John R. (Starbucks) July 16, 2024

- 4. Photometrics. The applicant will provide a photometric plan at the meeting. If the application is unable, the Planning Commission can make this a condition of approval.
- 5. Pedestrian Improvements. Based on direction from the Planning Commission, the applicant has extended crosswalks to provide better site circulation.

I look forward to meeting with you all at your July 23, 2024 meeting.

Sincerely,

CARLISLE/WORTMAN ASSOC., INC. Benjamin R. Carlisle, AICP, LEED AP

President

CARLISLE/WORTMAN ASSOC., INC.

Shana Kot

Community Planner

CITY OF TROY SPECIAL USE REQUEST APPLICATION

CITY OF TROY PLANNING DEPARTMENT 500 W. BIG BEAVER TROY, MICHIGAN 48084

PHONE: 248-524-3364 FAX: 248-524-3382

E-MAIL: planning@troymi.gov



SPECIAL USE APPROVAL FEE \$1,800.00

\$1,500.00

REGULAR MEETINGS OF THE CITY PLANNING COMMISSION ARE HELD ON THE SECOND AND FOURTH TUESDAYS OF EACH MONTH AT 7:00 P.M. AT CITY HALL.

APPLICATIONS FOR SPECIAL USE APPROVALS REQUIRING THE SUBMITTAL OF A SITE PLAN SHALL CONFORM TO THE REQUIREMENTS OF THE TROY ZONING ORDINANCE.

A PLANNING COMMISSION PUBLIC HEARING SHALL BE SCHEDULED FOLLOWING A DETERMINATION BY THE PLANNING DEPARTMENT THAT THE SPECIAL USE REQUEST APPLICATION IS COMPLETE AND MEETS THE REQUIREMENTS OF THE TROY ZONING ORDINANCE.

TR	OY ZONING ORDINANCE.	
1.	NAME OF THE PROPOSED DEVELOPMENT:Starbuc	eks
	ADDRESS OF THE SUBJECT PROPERTY: 1735 East	
3.	ZONING CLASSIFICATION OF SUBJECT PROPERTY: CI	В
4.	TAX IDENTIFICATION NUMBER(S) OF SUBJECT PROPER	RTY:20-23-476-011
5.	DESCRIPTION OF PROPOSED USE: New Tenant I	nsert with Drive Thru
6.	SECTION OF THE ZONING ORDINANCE UNDER WHICH	SPECIAL USE APPROVAL IS SOUGHT: 4.21B
7.	APPLICANT:	PROPERTY OWNER:
	NAME James P. Butler, PE	NAME Dennis Bostick
	COMPANY PEA Group	COMPANY Troy Sports Center, LLC
	ADDRESS 1849 Pond Run	ADDRESS 803 West Big Beaver, S-100
	CITY Auburn Hills STATE MI ZIP 48326	CITY Troy STATE MI ZIP 48084
	TELEPHONE <u>248-689-9090 x 1133</u>	TELEPHONE 248-506-1287
	E-MAIL jbutler@peagroup.com	E-MAIL dennisbostick@att.net
8.	THE APPLICANT BEARS THE FOLLOWING RELATIONSH	IP TO THE OWNER OF THE SUBJECT PROPERTY:
9.	SIGNATURE OF APPLICANT	DATE 2/27/24
10.	SIGNATURE OF PROPERTY OWNER Dunis Bostick	DATEDATE

BY THIS SIGNATURE, THE PROPERTY OWNER AUTHORIZES THE PLACEMENT OF A SIGN ON THE PROPERTY TO INFORM THE PUBLIC OF THE REQUEST FOR SPECIAL USE APPROVAL.

STARBUCKS

1735 EAST BIG BEAVER ROAD





PERMIT / APPROVAL SUMMARY DATE SUBMITTED DATE APPROVED PERMIT / APPROVAL



INDEX OF DRAWINGS NUMBER TITLE **COVER SHEET** TOPOGRAPHIC SURVEY PRELIMINARY SITE PLAN CIRCULATION PLAN PRELIMINARY GRADING PLAN NOTES AND DETAILS NOTES AND DETAILS PRELIMINARY LANDSCAPE PLAN LANDSCAPE DETAILS **ARCHITECTURAL** PROPOSED FIRST FLOOR PLAN PROPOSED ELEVATIONS RENDERED ELEVATIONS PHOTOMETRIC PLAN

DESIGN TEAM


OWNER/APPLICANT/DEVELOPER CIVIL ENGINEER

TROY SPORT CENTER, LLC 803 W BIG BEAVER ROAD, SUITE 100 TROY, MICHIGAN 48084 CONTACT: DENNIS BOSTICK PHONE: 248.506.1287 EMAIL: DENNISBOSTICK@ATT.NET

PEA GROUP 1849 POND RUN AUBURN HILLS, MI 48326 CONTACT: JAMES P. BUTLER, PE PHONE: 844.813.2949 EMAIL: JBUTLER@PEAGROUP.COM

ARCHITECT

BRIAN NEEPER ARCHITECTURE 630 NORTH OLD WOODWARD, SUITE 203 BIRMINGHAM, MICHIGAN 48009 CONTACT: BRIAN NEEPER PHONE: 248.259.1784 EMAIL: BRIAN@BRIANNEEPER.COM

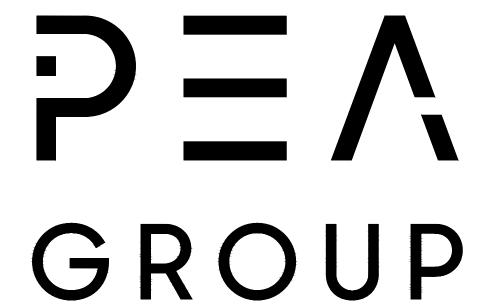

REVISIONS			
DESCRIPTION	DATE		
ORIGINAL ISSUE DATE	12/12/2023		
CITY REVISIONS	5/31/2024		
CITY REVISIONS	7/17/2024		

REFERENCE DRAWINGS: PEA JOB NO. 2018-034

MORTGAGE SURVEY, NOWAK & FRAUS JOB NO. 8801-05, SHEET 1, DATED 08/15/2017

CITY OF TROY UTILITY MAP (FROM PEA JOB NO. 2018-034)

FLOODPLAIN NOTE:

BY GRAPHICAL PLOTTING, SITE IS WITHIN ZONE 'X', AREA DETERMINED TO BE OUTSIDE OF THE 0.2% ANNUAL CHANCE FLOODPLAIN PER FLOOD INSURANCE RATE MAP NUMBER 26125C0553G, DATED 01/16/2009.

BENCHMARKS:

(PER CITY OF TROY DATUM)

ARROW ON A HYDRANT LOCATED ON THE WEST SIDE OF THE PARKING LOT ACROSS FROM THE DUMPSTER BEHIND 1735 E. BIG BEAVER ROAD, NEAR THE CHASE BANK DRIVE-THRU. ELEV. - 649.41

TROY BM #1277

ARROW ON T/HYDRANT (#23-122) ON THE NORTH SIDE OF BIG BEAVER EAST OF THE WEST ENTRANCE TO TROY SPORTS CENTER ELEV. 648.728


TROY BM #1278

ARROW ON T/HYDRANT (#23-123) ON THE NORTH SIDE OF BIG BEAVER EAST OF THE ENTRANCE OF BUILDING 1685 ELEV. 648.184


LEGAL DESCRIPTION:

PARCEL ID 02-23-476-011
Land in the City of Troy, Oakland County, Michigan, described as follows:


T2N, R11E, SEC 23 LASIER GARDENS SUB LOTS 35 & 36 EXC S 49 FT TAKEN FOR BIG BEAVER RD, ALSO VAC BELLINGHAM ST ADJ TO SAME, ALSO W 1/2 OF VAC BRONX AVE ADJ TO SAME

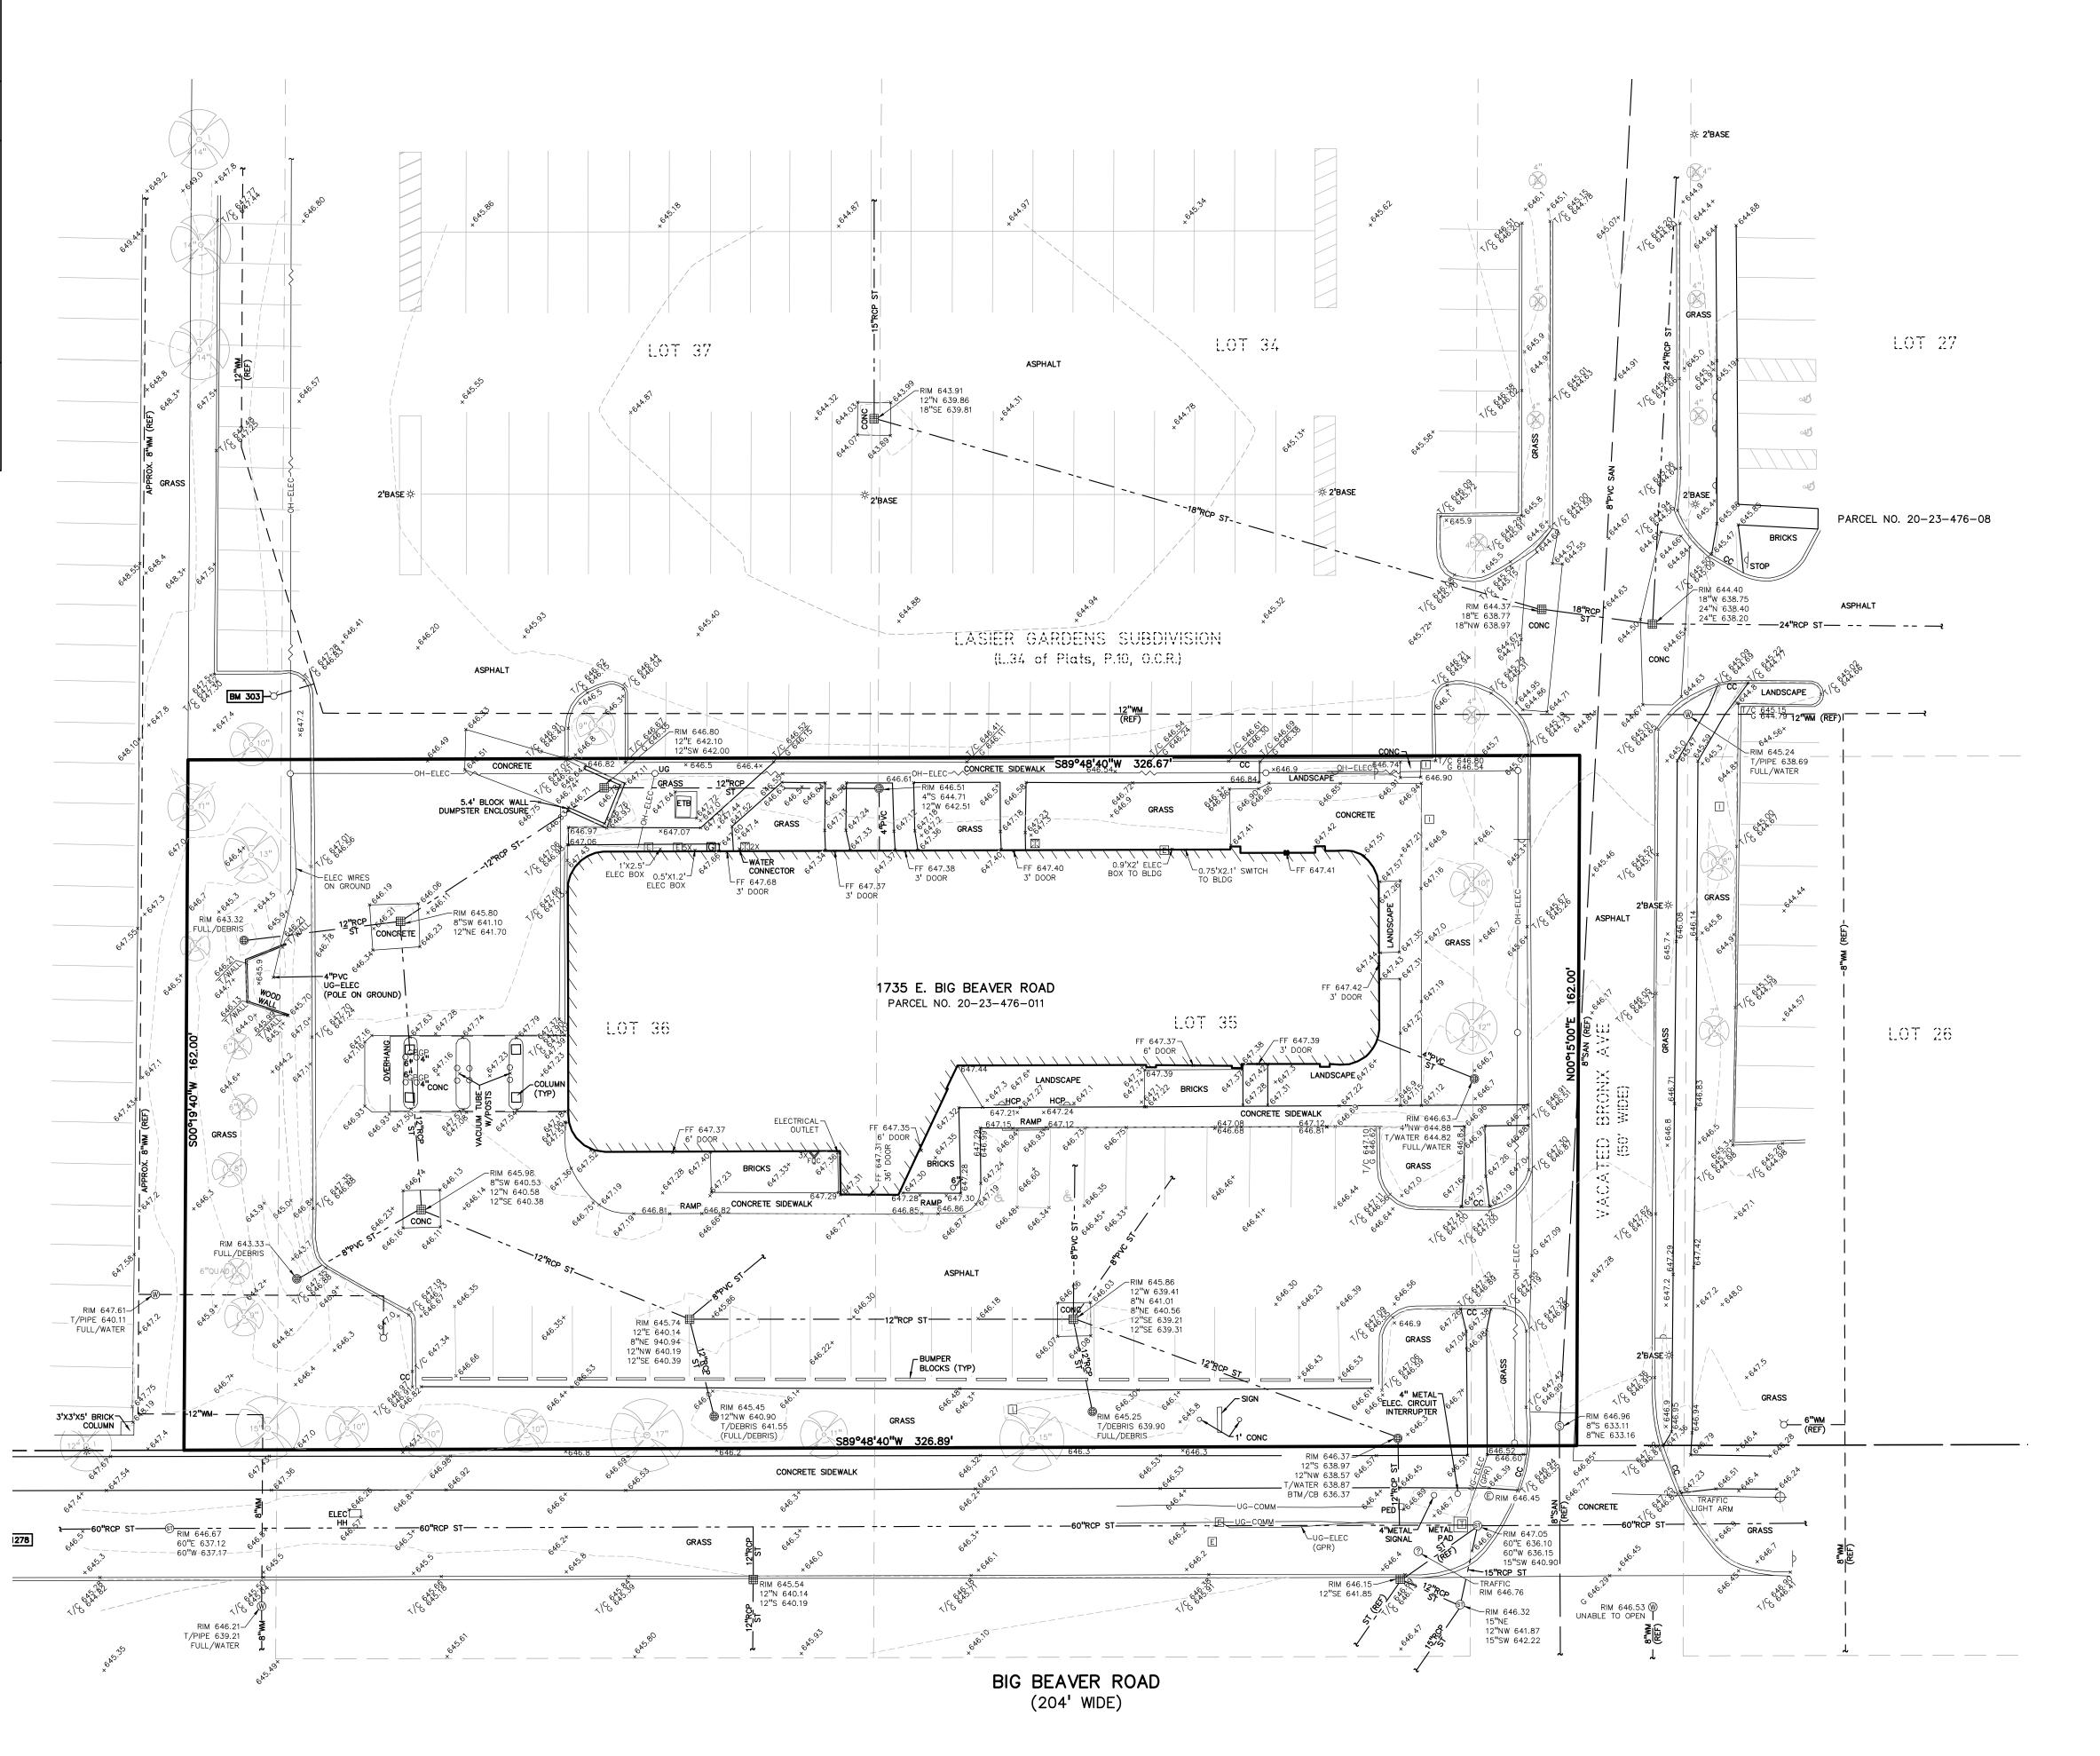



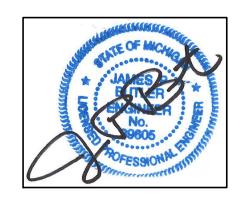




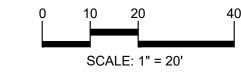



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TROY SPORTS
CENTER, LLC
803 W. BIG BEAVER ROAD, SUITE 100
TROY, MICHIGAN 48084

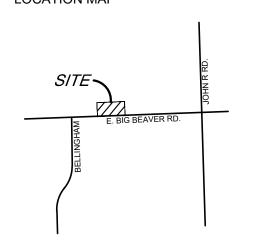PROJECT TITLE

STARBUCKS

1735 E. BIG BEAVER ROAD
CITY OF TROY, OAKLAND COUNTY, MICHIGAN

REVISIONS	
CITY REVISIONS	5/31/2024
CITY REVISIONS	7/17/2024

ORIGINAL ISSUE DATE: FEBRUARY 05, 2024

TOPOGRAPHIC SURVEY

PEA JOB NO.	23-092
P.M.	JP
DN.	K
DES.	JP
DRAWING NUMBER:	

REFERENCE DRAWINGS: PEA JOB NO. 2018-034

MORTGAGE SURVEY, NOWAK & FRAUS JOB NO. 8801-05, SHEET 1, DATED 08/15/2017

CITY OF TROY UTILITY MAP (FROM PEA JOB NO. 2018-034)

FLOODPLAIN NOTE:

BY GRAPHICAL PLOTTING, SITE IS WITHIN ZONE 'X', AREA DETERMINED TO BE OUTSIDE OF THE 0.2% ANNUAL CHANCE FLOODPLAIN PER FLOOD INSURANCE RATE MAP NUMBER 26125C0553G, DATED 01/16/2009.

BENCHMARKS:

(PER CITY OF TROY DATUM)

ARROW ON A HYDRANT LOCATED ON THE WEST SIDE OF THE PARKING LOT ACROSS FROM THE DUMPSTER BEHIND 1735 E. BIG BEAVER ROAD, NEAR THE CHASE BANK DRIVE-THRU. ELEV. - 649.41

TROY BM #1277

ARROW ON T/HYDRANT (#23-122) ON THE NORTH SIDE OF BIG BEAVER EAST OF THE WEST ENTRANCE TO TROY SPORTS CENTER ELEV. 648.728


TROY BM #1278

ARROW ON T/HYDRANT (#23-123) ON THE NORTH SIDE OF BIG BEAVER EAST OF THE ENTRANCE OF BUILDING 1685 ELEV. 648.184

LEGAL DESCRIPTION:

PARCEL ID 02-23-476-011
Land in the City of Troy, Oakland County, Michigan, described as follows:

T2N, R11E, SEC 23 LASIER GARDENS SUB LOTS 35 & 36 EXC S 49 FT TAKEN FOR BIG BEAVER RD, ALSO VAC BELLINGHAM ST ADJ TO SAME, ALSO W 1/2 OF VAC BRONX AVE ADJ TO SAME

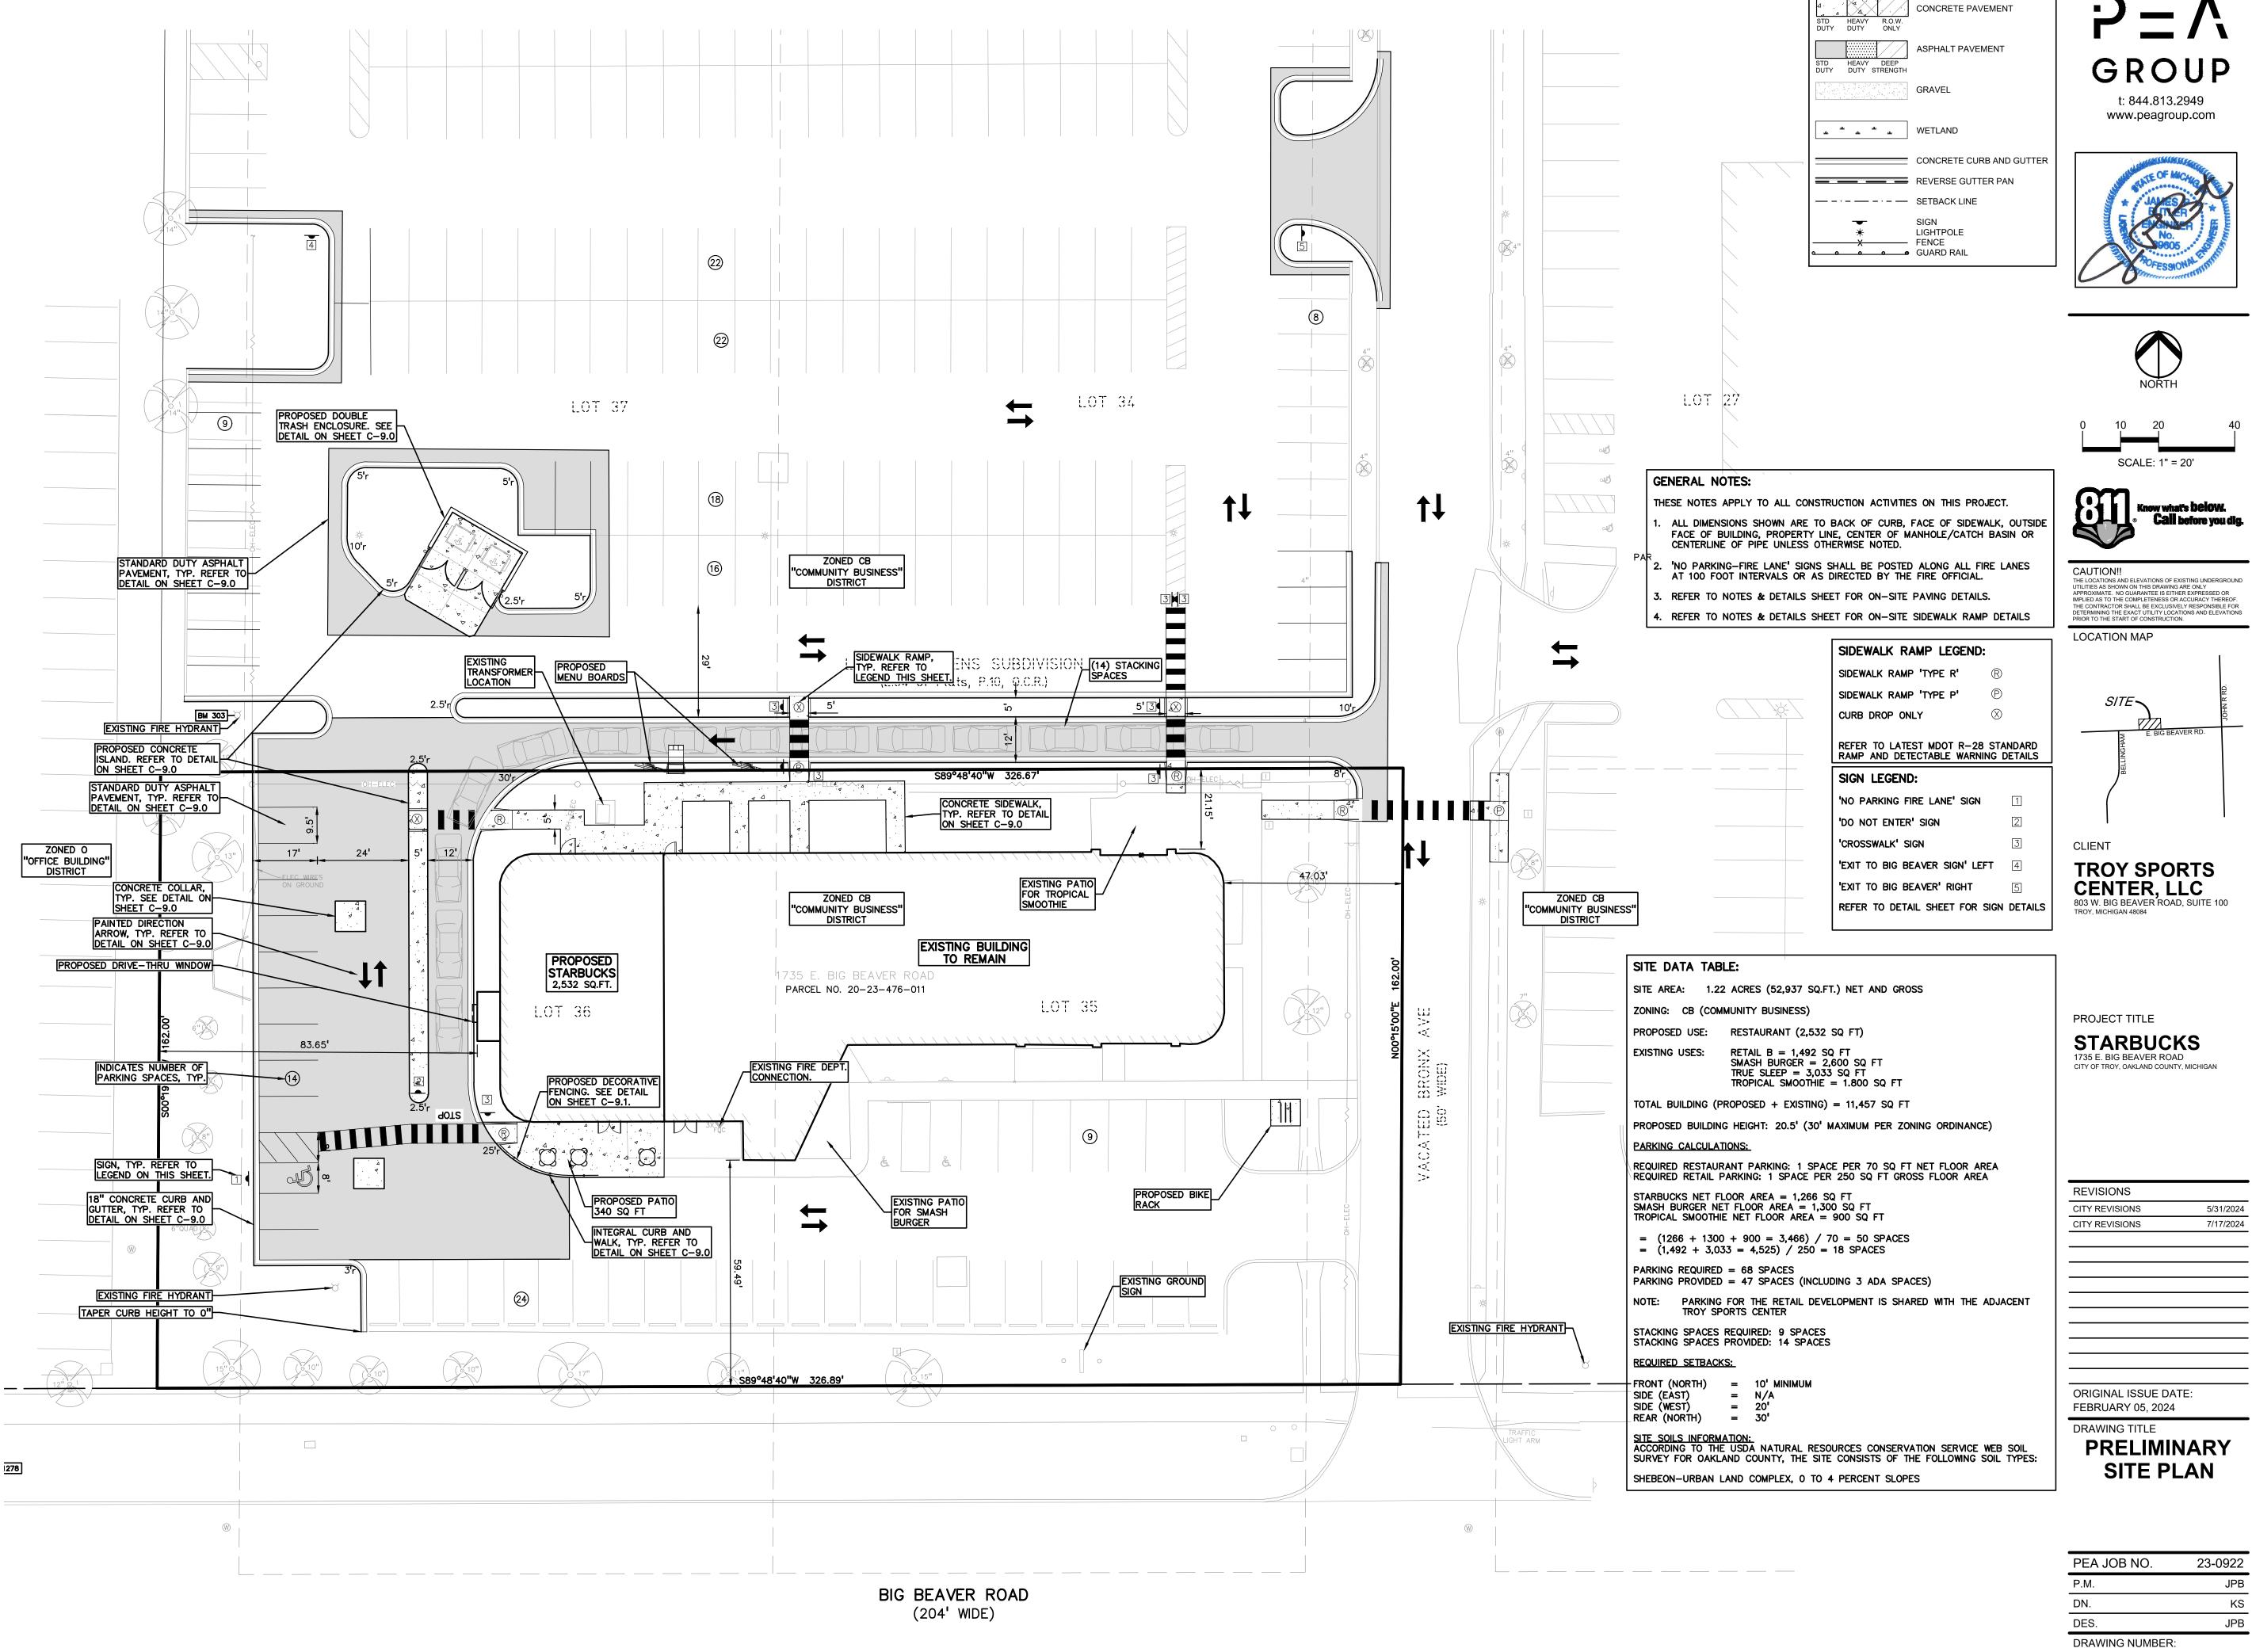

DRAWING NUMBER:

LEGEND:

REFERENCE DRAWINGS: PEA JOB NO. 2018-034

MORTGAGE SURVEY, NOWAK & FRAUS JOB NO. 8801-05, SHEET 1,

CITY OF TROY UTILITY MAP (FROM PEA JOB NO. 2018-034)

FLOODPLAIN NOTE:

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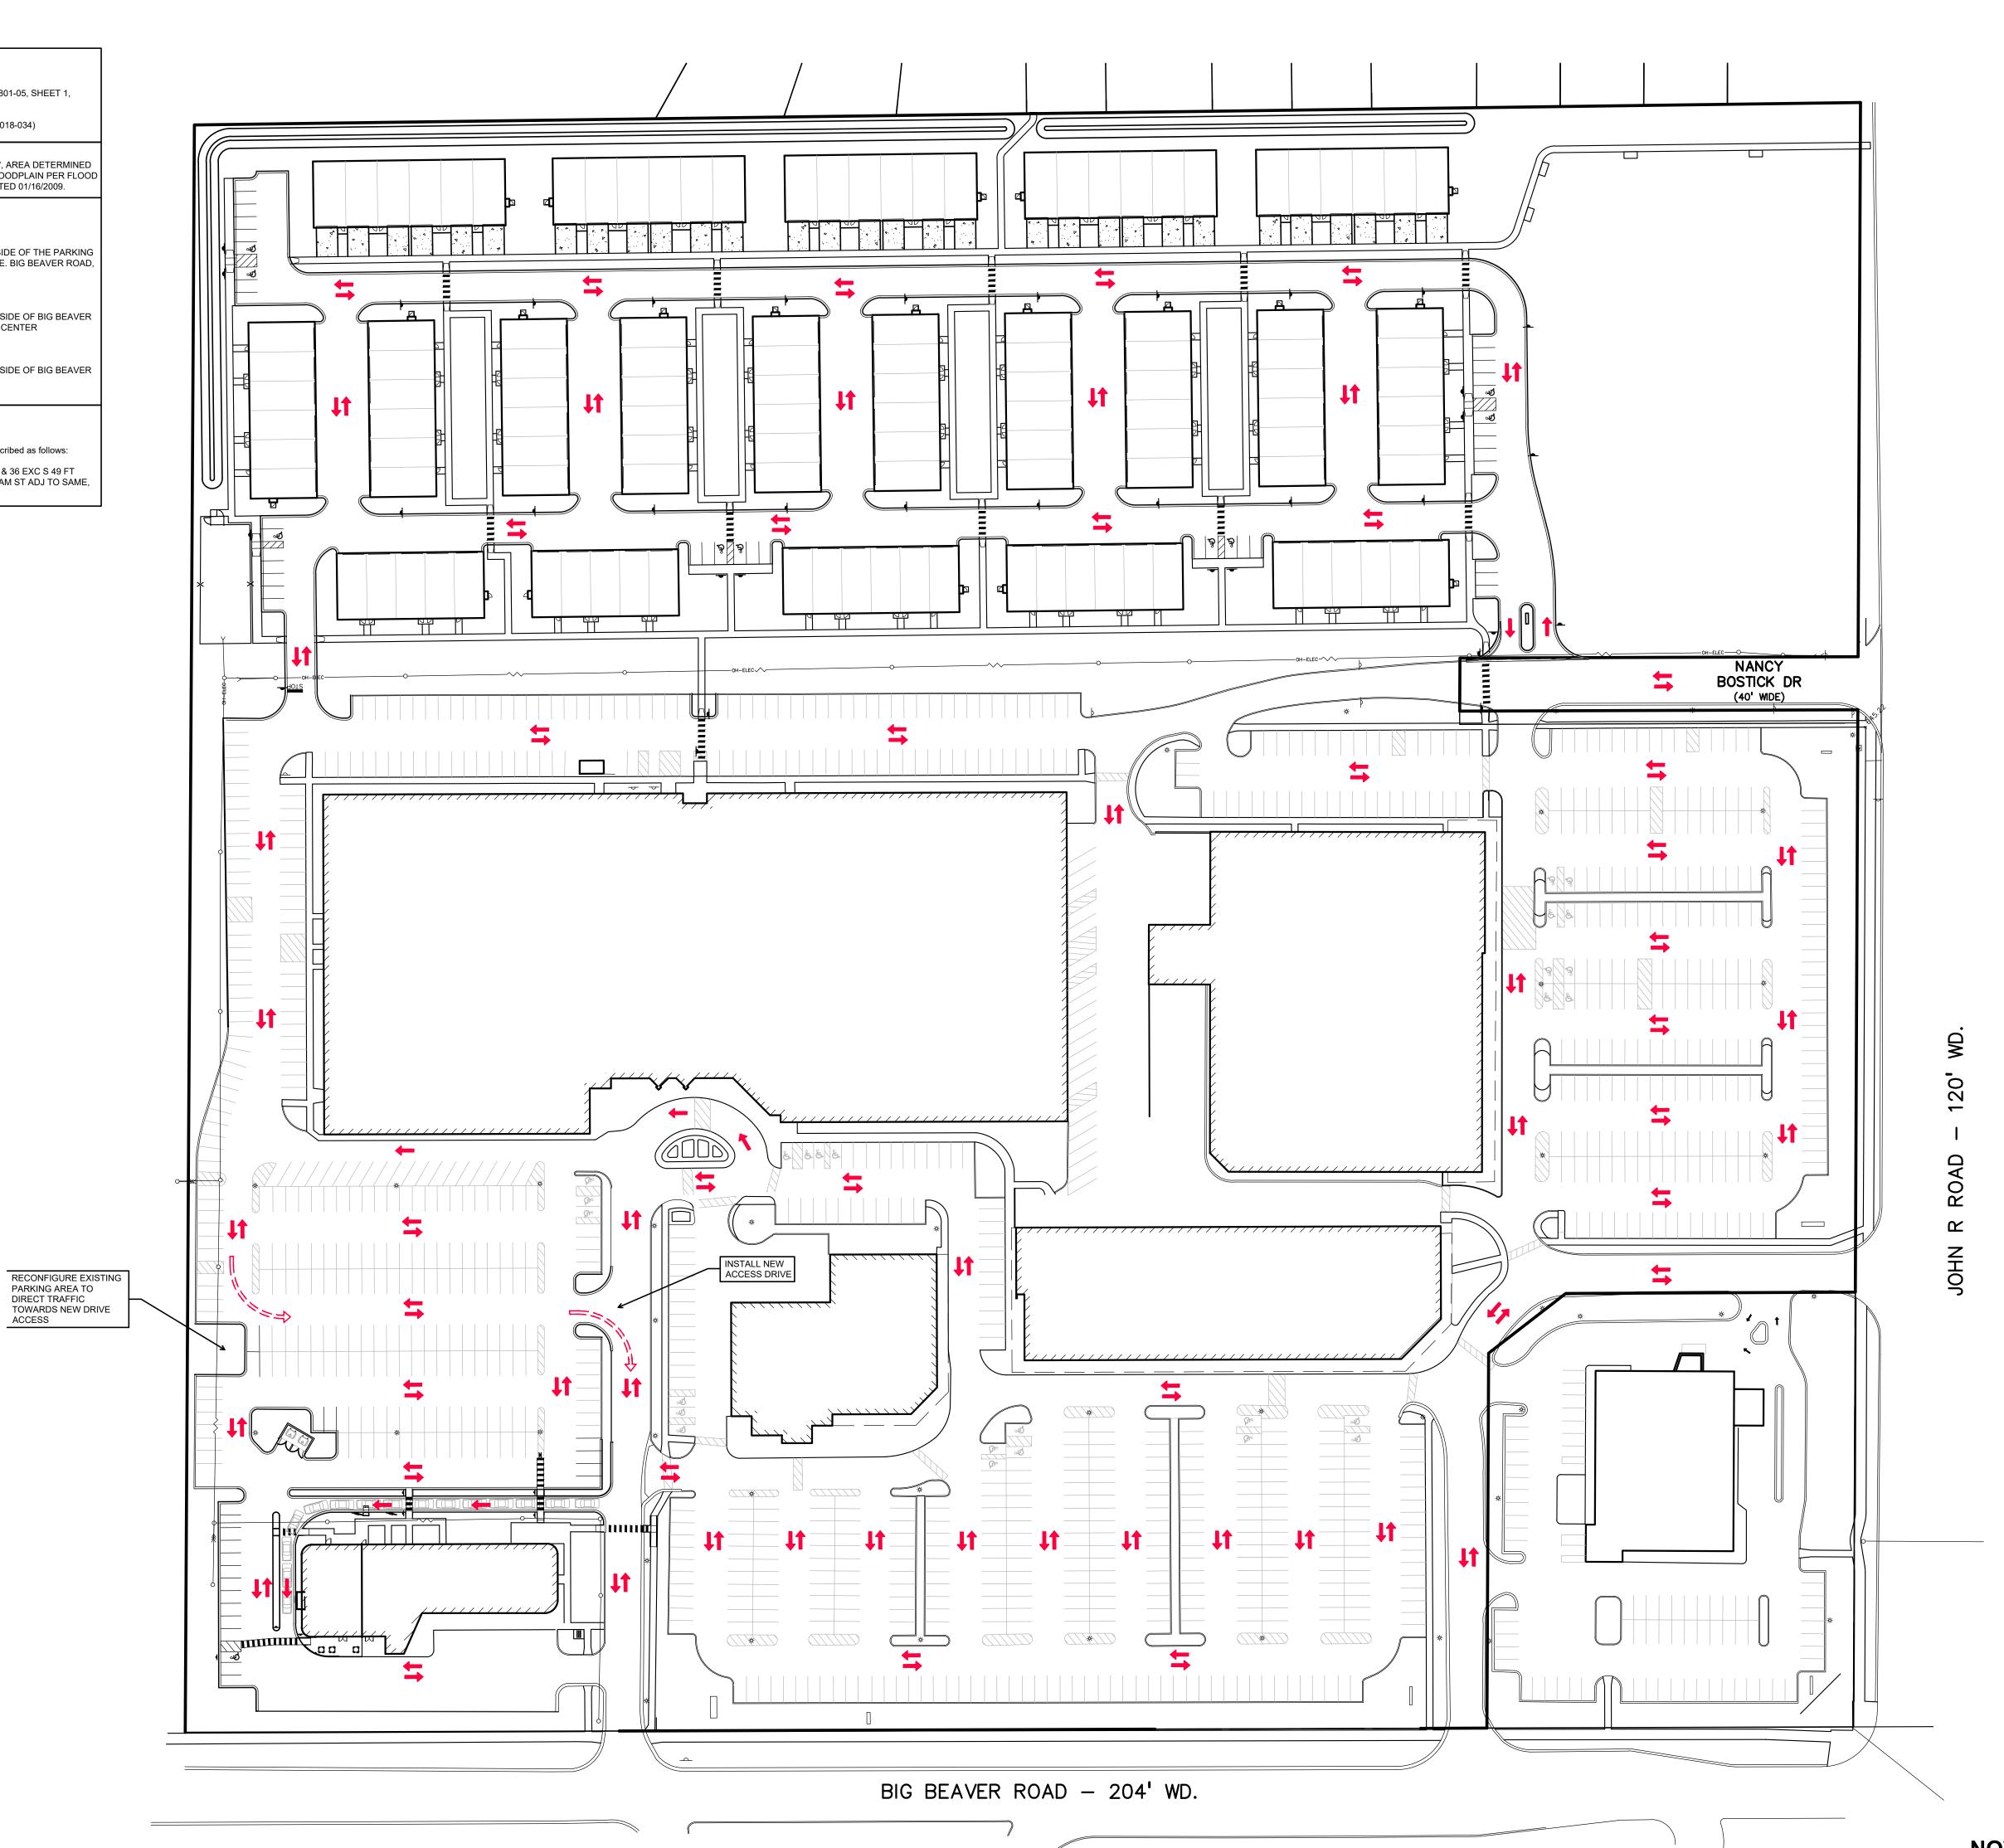
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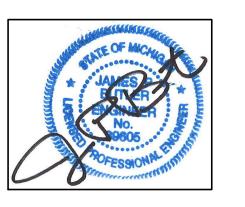
LEGAL DESCRIPTION:

PARCEL ID 02-23-476-011
Land in the City of Troy, Oakland County, Michigan, described as follows:


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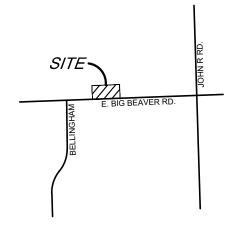




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LOCATION MAP



TROY SPORTS
CENTER, LLC
803 W. BIG BEAVER ROAD, SUITE 100
TROY, MICHIGAN 48084

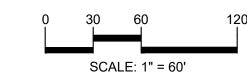PROJECT TITLE


STARBUCKS 1735 E. BIG BEAVER ROAD CITY OF TROY, OAKLAND COUNTY, MICHIGAN


REVISIONS	
CITY REVISIONS	5/31/2024
CITY REVISIONS	7/17/2024

ORIGINAL ISSUE DATE: FEBRUARY 05, 2024

CIRCULATION PLAN


	PEA JOB NO.	23-0922
,	P.M.	JPB
	DN.	KS
	DES.	JPB
,	DRAWING NUMBER:	

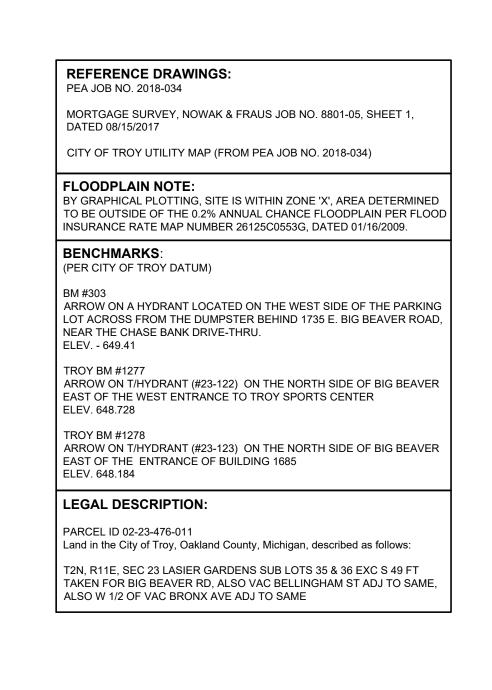

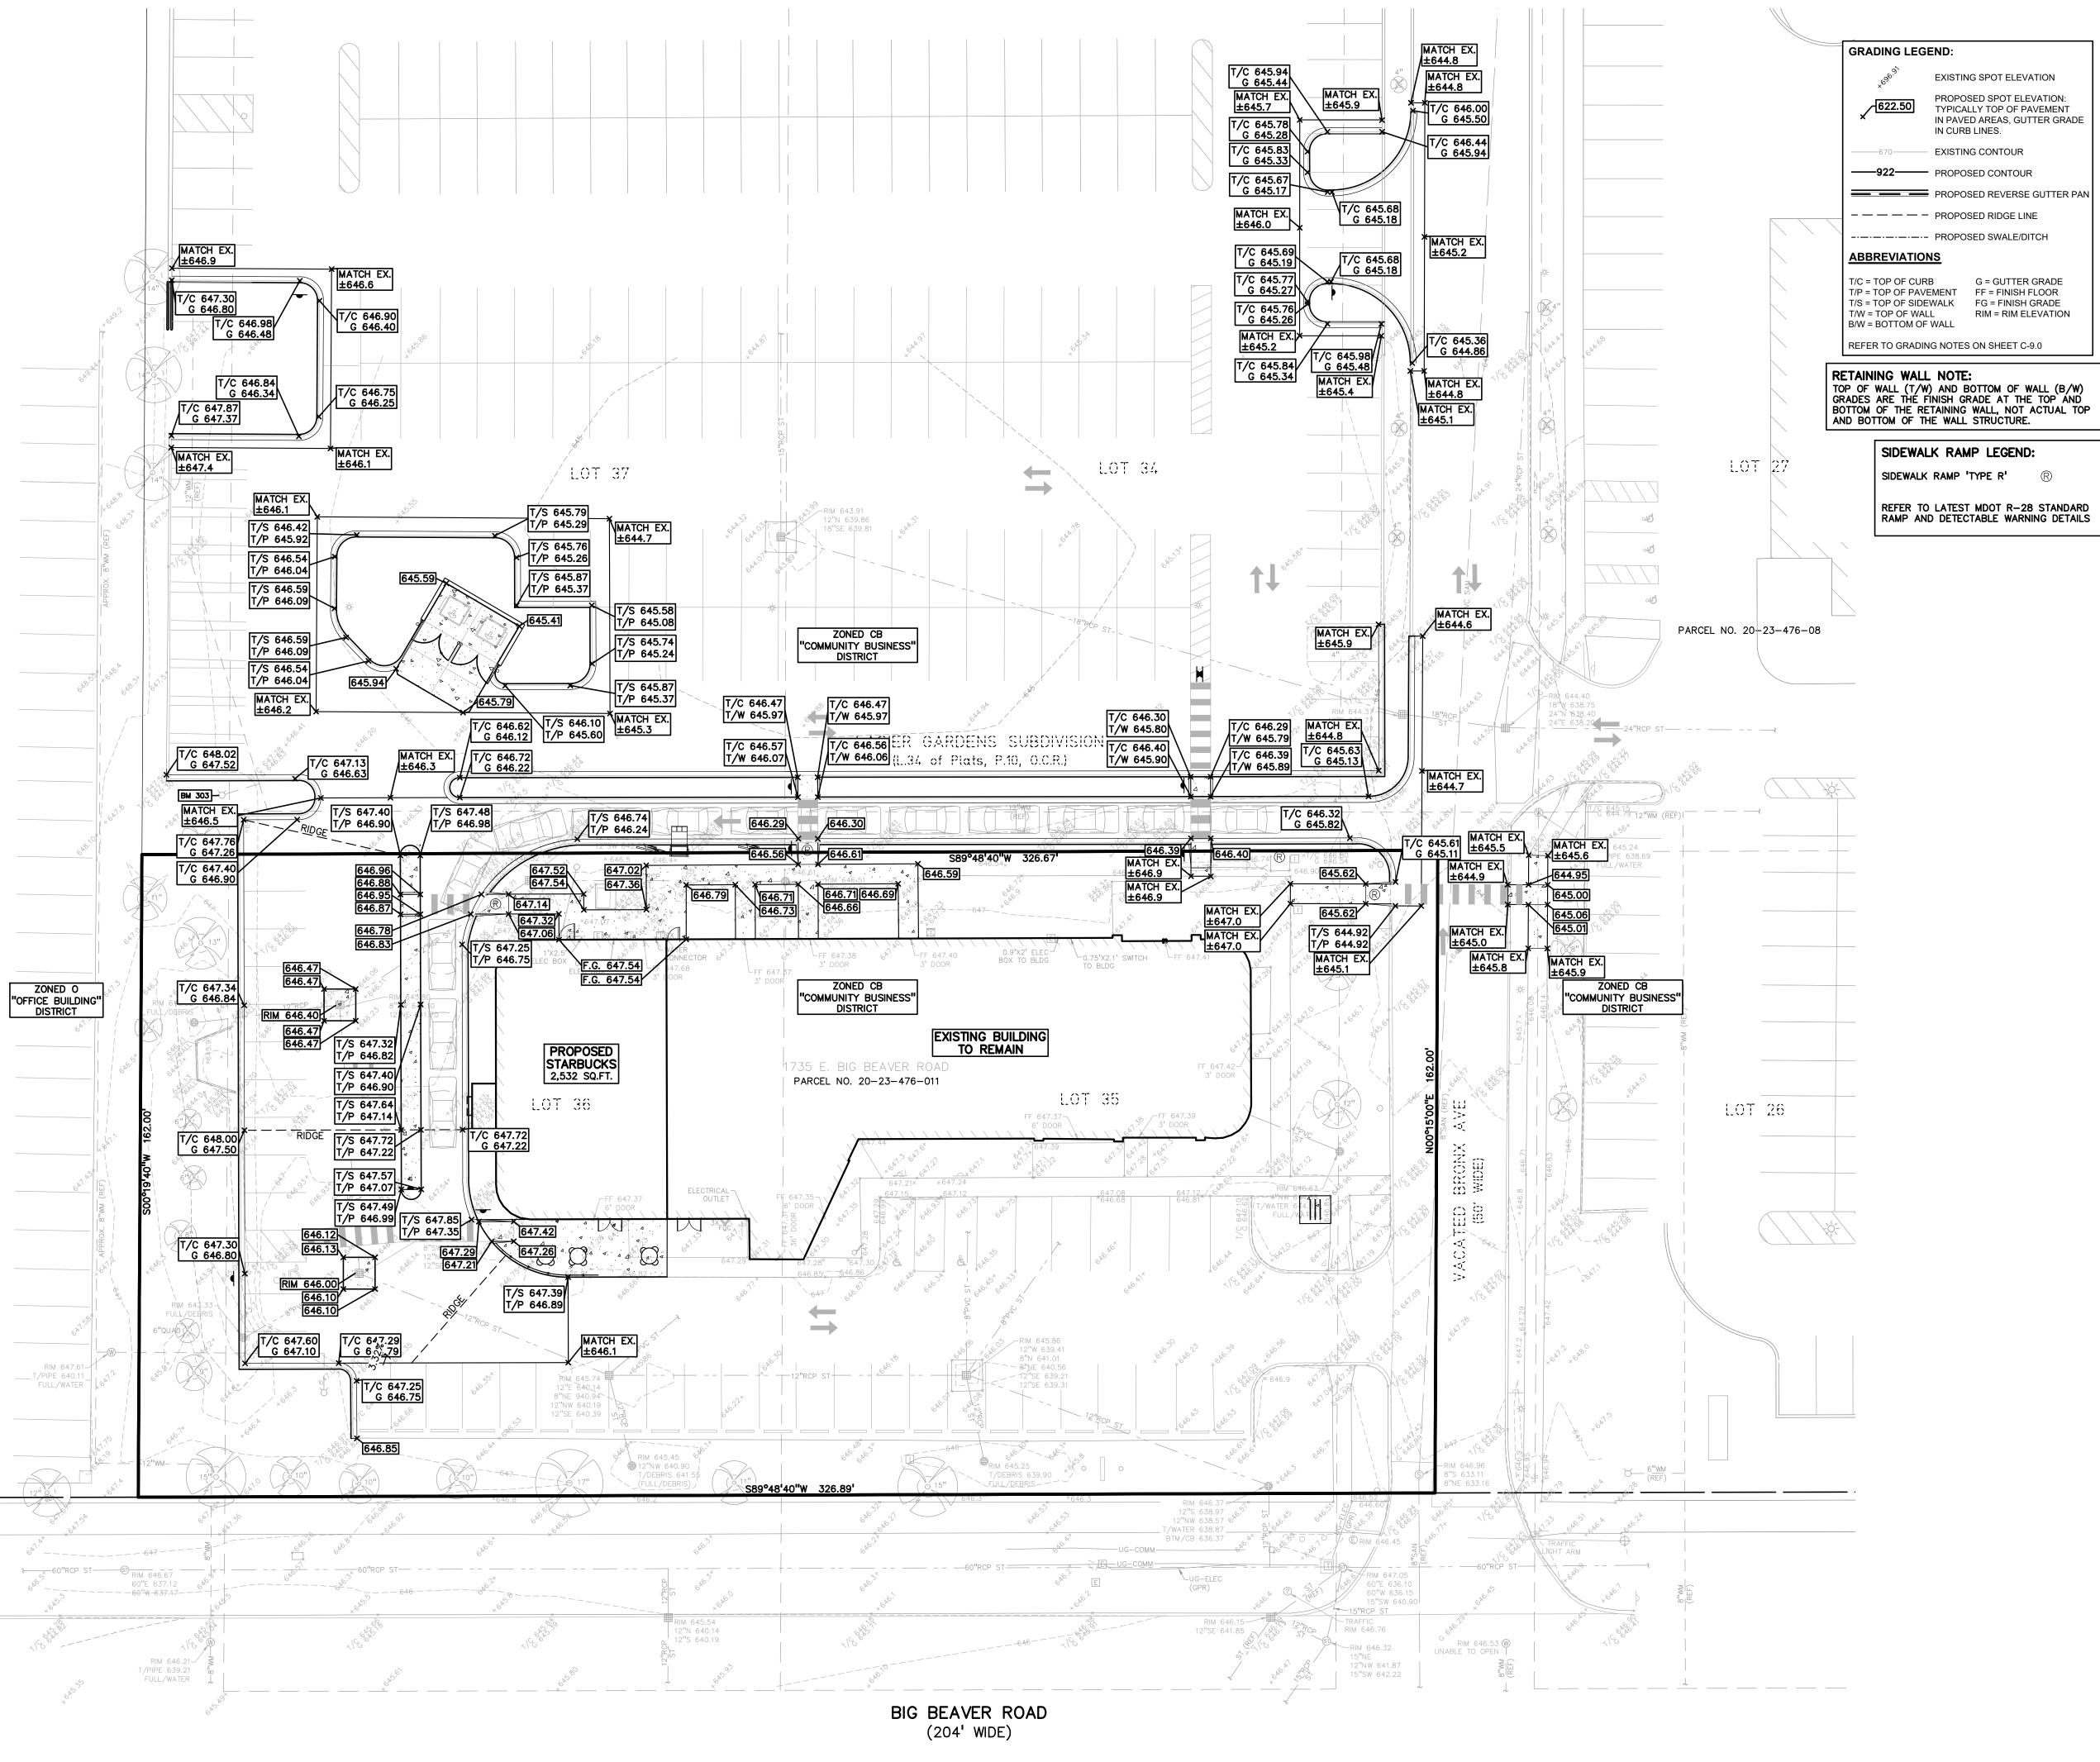

EXISTING SPOT ELEVATION PROPOSED SPOT ELEVATION: TYPICALLY TOP OF PAVEMENT IN PAVED AREAS, GUTTER GRADE IN CURB LINES. t: 844.813.2949 670—EXISTING CONTOUR www.peagroup.com ——922—— PROPOSED CONTOUR PROPOSED REVERSE GUTTER PAN ---- PROPOSED RIDGE LINE ----- PROPOSED SWALE/DITCH G = GUTTER GRADE T/P = TOP OF PAVEMENT FF = FINISH FLOOR FG = FINISH GRADE RIM = RIM ELEVATION REFER TO GRADING NOTES ON SHEET C-9.0




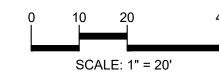



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LOCATION MAP

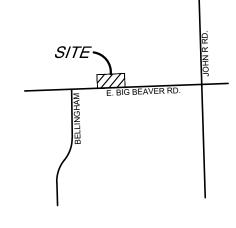

CLIENT

TROY SPORTS CENTER, LLC 803 W. BIG BEAVER ROAD, SUITE 100

PROJECT TITLE

STARBUCKS

1735 E. BIG BEAVER ROAD
CITY OF TROY, OAKLAND COUNTY, MICHIGAN

REVISIONS	
CITY REVISIONS	5/31/2024
CITY REVISIONS	7/17/2024
_	

ORIGINAL ISSUE DATE: FEBRUARY 05, 2024

DRAWING TITLE **PRELIMINARY**

GRADING PLAN

PEA JOB NO.	23-0922
P.M.	JPB
DN.	KS
DES.	JPB
DRAWING NUMBER:	

GENERAL NOTES:

THESE NOTES APPLY TO ALL CONSTRUCTION ACTIVITIES ON THIS PROJECT.

- ALL CONSTRUCTION, WORKMANSHIP AND MATERIALS SHALL BE IN ACCORDANCE WITH CURRENT OSHA, MDOT AND MUNICIPALITY STANDARDS AND REGULATIONS.
- THE CONTRACTOR SHALL NOTIFY THE ENGINEER AND/OR THE AUTHORITY HAVING JURISDICTION 3 BUSINESS DAYS PRIOR TO THE BEGINNING OF CONSTRUCTION.
- THE CONTRACTOR SHALL CONTACT THE ENGINEER SHOULD THEY ENCOUNTER ANY DESIGN ISSUES DURING CONSTRUCTION. IF THE CONTRACTOR MAKES DESIGN MODIFICATIONS WITHOUT THE WRITTEN DIRECTION OF THE DESIGN ENGINEER, THE CONTRACTOR DOES SO
- ALL NECESSARY PERMITS, TESTING, BONDS AND INSURANCES ETC., SHALL BE PAID FOR BY THE CONTRACTOR. THE OWNER SHALL PAY FOR ALL CITY INSPECTION FEES.
- THE CONTRACTOR SHALL NOTIFY THE APPROPRIATE 811/ONE CALL UTILITY LOCATING CENTER, THE CITY ENGINEER AND/OR THE AUTHORITY HAVING JURISDICTION 3 BUSINESS DAYS PRIOR TO THE BEGINNING OF CONSTRUCTION. IF NO NOTIFICATION IS GIVEN AND DAMAGE RESULTS, SAID DAMAGE WILL BE REPAIRED AT SOLE EXPENSE OF THE CONTRACTOR. IF EXISTING UTILITY LINES ARE ENCOUNTERED THAT CONFLICT IN LOCATION WITH NEW CONSTRUCTION, THE CONTRACTOR SHALL NOTIFY THE DESIGN ENGINEER SO THAT THE CONFLICT MAY BE RESOLVED.
- CONTRACTOR SHALL VERIFY THAT THE PLANS AND SPECIFICATIONS ARE THE VERY LATEST PLANS AND SPECIFICATIONS AND FURTHERMORE, VERIFY THAT THESE PLANS AND SPECIFICATIONS HAVE BEEN APPROVED. ALL ITEMS CONSTRUCTED BY THE CONTRACTOR PRIOR TO RECEIVING FINAL APPROVAL, HAVING TO BE ADJUSTED OR RE-DONE, SHALL BE AT THE CONTRACTORS EXPENSE. SHOULD THE CONTRACTOR ENCOUNTER A CONFLICT BETWEEN THESE PLANS AND/OR SPECIFICATIONS, THEY SHALL SEEK CLARIFICATION IN WRITING FROM THE ENGINEER BEFORE COMMENCEMENT OF CONSTRUCTION. FAILURE TO DO SO SHALL BE AT SOLE EXPENSE TO THE CONTRACTOR.
- ANY WORK WITHIN THE STREET OR HIGHWAY RIGHTS-OF-WAY SHALL BE PERFORMED IN ACCORDANCE WITH THE REQUIREMENTS OF THE AGENCIES HAVING JURISDICTION AND SHALL NOT BEGIN UNTIL ALL NECESSARY PERMITS HAVE BEEN ISSUED FOR THE WORK.
- ALL PROPERTIES OR FACILITIES IN THE SURROUNDING AREAS, PUBLIC OR PRIVATE, DESTROYED OR OTHERWISE DISTURBED DUE TO CONSTRUCTION, SHALL BE REPLACED AND/OR RESTORED TO THE ORIGINAL CONDITION BY THE CONTRACTOR.
- THE CONTRACTOR SHALL PROVIDE ALL NECESSARY BARRICADING, SIGNAGE, LIGHTS AND TRAFFIC CONTROL DEVICES TO PROTECT THE WORK AND SAFELY MAINTAIN TRAFFIC IN ACCORDANCE WITH LOCAL REQUIREMENTS AND THE MANUAL OF UNIFORM TRAFFIC CONTROL DEVICES (LATEST EDITION). THE DESIGN ENGINEER, OWNER AND STATE SHALL NOT BE HELD LIABLE FOR ANY CLAIMS RESULTING FROM ACCIDENTS OR DAMAGES CAUSED BY THE CONTRACTOR'S FAILURE TO COMPLY WITH TRAFFIC AND PUBLIC SAFETY REGULATIONS DURING THE CONSTRUCTION PERIOD.
- 0. THE USE OF CRUSHED CONCRETE IS PROHIBITED ON THE PROJECT WITHIN 100 FEET OF ANY WATER COURSE (STREAM, RIVER, COUNTY DRAIN, ETC.) AND LAKE, REGARDLESS OF THE APPLICATION OR LOCATION OF THE WATER COURSE OR LAKE RELATIVE TO THE
- . IT SHALL BE THE RESPONSIBILITY OF THE CONTRACTOR TO ADJUST THE TOP OF ALL EXISTING AND PROPOSED STRUCTURES (MANHOLES, CATCH BASINS, INLETS, GATE WELLS ETC.) WITHIN GRADED AND /OR PAVED AREAS TO FINAL GRADE SHOWN ON THE PLANS. ALL SUCH ADJUSTMENTS SHALL BE INCIDENTAL TO THE JOB AND WILL NOT BE PAID FOR SEPARATELY.

PAVING NOTES:

- IN AREAS WHERE NEW PAVEMENTS ARE BEING CONSTRUCTED, THE TOPSOIL AND SOIL CONTAINING ORGANIC MATTER SHALL BE REMOVED PRIOR TO PAVEMENT CONSTRUCTION.
- REFER TO ARCHITECTURAL PLANS FOR DETAILS OF FROST SLAB AT EXTERIOR BUILDING DOORS.
- CONSTRUCTION TRAFFIC SHOULD BE MINIMIZED ON THE NEW PAVEMENT. IF CONSTRUCTION TRAFFIC IS ANTICIPATED ON THE PAVEMENT STRUCTURE, THE INITIAL LIFT THICKNESS COULD BE INCREASED AND PLACEMENT OF THE FINAL LIFT COULD BE DELAYED UNTIL THE MAJORITY OF THE CONSTRUCTION ACTIVITIES HAVE BEEN COMPLETED. THIS ACTION WILL ALLOW REPAIR OF LOCALIZED FAILURE, IF ANY DOES OCCUR, AS WELL AS REDUCE LOAD DAMAGE ON THE PAVEMENT SYSTEM.
- ALL EXPANSION JOINTS AND CONCRETE PAVEMENT JOINTS TO BE SEALED.
- CONCRETE PAVEMENT JOINTING UNLESS SHOWN OTHERWISE IN THE PLANS OR REQUIRED BY THE AUTHORITY HAVING JURISDICTION; 5.1. WHERE PROPOSED CONCRETE ABUTS A STRUCTURE, PROVIDE A MINIMUM 1/2" EXPANSION JOINT. THE JOINT FILLER BOARD MUST BE AT LEAST THE FULL DEPTH OF THE CONCRETE AND HELD DOWN A 1/2" TO ALLOW FOR SEALING.
- 5.2. WHERE PROPOSED CONCRETE ABUTS EXISTING CONCRETE OR IN BETWEEN POURS OF PROPOSED CONCRETE (CONSTRUCTION JOINT), PROVIDE 5/8" DOWELS EVERY 30" CENTER TO CENTER HALF WAY ALONG THE THICKNESS OF THE PROPOSED PAVEMENT. ALTERNATE DOWELS SIZES AND SPACING MUST BE APPROVED THE ENGINEER PRIOR TO COMMENCING WORK AND VIA THE SUBMITTAL PROCESS
- WHERE PROPOSED CONCRETE ABUTS EXISTING OR PROPOSED SIDEWALK OR CURBING, PROVIDE A MINIMUM 1/2" EXPANSION JOINT. 5.4. CONTROL, LONGITUDINAL AND/OR TRANSVERSE JOINTS SHALL BE PLACED TO PROVIDE PANELS WITHIN THE PAVEMENT AS SQUARE AS POSSIBLE WITH THE FOLLOWING MAXIMUM SPACING PARAMETERS: 5.4.1. 6-INCH THICK CONCRETE PAVEMENT: 12' X 12'
- 5.4.2. 8-INCH THICK CONCRETE PAVEMENT: 15' X 15' 5.5. IRREGULAR-SHAPED PANELS MAY REQUIRE THE USE OF REINFORCING MESH OR FIBER MESH AS DETERMINED BY THE ENGINEER. THE USE OF MESH MUST BE APPROVED THE ENGINEER PRIOR TO COMMENCING WORK AND VIA THE SUBMITTAL PROCESS.
- 5.6. IF A JOINT PLAN IS NOT PROVIDED IN THE PLANS, THE CONTRACTOR SHALL SUBMIT ONE TO THE ENGINEER FOR REVIEW PRIOR
- 6. CONCRETE CURBING JOINTING UNLESS SHOWN OTHERWISE IN THE PLANS OR REQUIRED BY THE AUTHORITY HAVING JURISDICTION 6.1. JOINTS WHEN ADJACENT TO ASPHALT PAVEMENT 6.1.1. PLACE CONTRACTION JOINTS AT 10' INTERVALS
- 6.1.2. PLACE 1/2" EXPANSION JOINT AT CATCH BASINS, EXISTING AND PROPOSED SIDEWALK OR EXISTING CURBING. 6.1.3. PLACE 1" EXPANSION JOINT:
- 6.1.3.1. AT SPRING POINTS OF INTERSECTIONS OR ONE OF THE END OF RADIUS LOCATIONS IN A CURVE
- 6.1.3.2. AT 400' MAXIMUM INTERVALS ON STRAIGHT RUNS 6.1.3.3. AT THE END OF RADIUS AT OPPOSITE ENDS IN A CURBED LANDSCAPE ISLAND
- 6.2. JOINTS WHEN TIED TO CONCRETE PAVEMENT
- 6.2.1. PLACE CONTRACTION JOINTS OPPOSITE ALL TRANSVERSE CONTRACTION JOINTS IN PAVEMENT 6.2.2. PLACE 1/2" EXPANSION JOINT AT CATCH BASINS, EXISTING AND PROPOSED SIDEWALK OR EXISTING CURBING.
- 6.2.3. PLACE 1" EXPANSION JOINT OPPOSITE ALL TRANSVERSE EXPANSION JOINTS IN PAVEMENT
- 6.2.4. CURB AND GUTTER AND CONCRETE SHALL BE TIED TOGETHER SIMILAR TO A LONGITUDINAL LANE TIE JOINT (MDOT B1 JOINT) 6.3. IN BETWEEN POURS OF PROPOSED CONCRETE CURBING (CONSTRUCTION JOINT): 6.3.1. CARRY THE REBAR CONTINUOUSLY BETWEEN POURS
- 6.3.2. IF THE REBAR IS NOT LONG ENOUGH TO CARRY CONTINUOUSLY, THEN TIE TWO PIECES OF REBAR PER THE LATEST MDOT
- CONCRETE SIDEWALK JOINTING UNLESS SHOWN OTHERWISE IN THE PLANS OR REQUIRED BY THE AUTHORITY HAVING JURISDICTION 7.1. PLACE TRANSVERSE CONTRACTION JOINTS EQUAL TO THE WIDTH OF THE WALK WHEN WIDTH IS LESS THAN 8' 7.2. PLACE TRANSVERSE AND LONGITUDINAL CONTRACTION JOINTS EQUAL TO 1/2 THE WIDTH OF THE WALK WHEN WIDTH IS EQUAL TO
- OR GREATER THAN 8' 7.3. PLACE 1" EXPANSION JOINT WHERE ABUTTING SIDEWALK RAMP AND/OR RADIUS IN INTERSECTION
- 7.4. PLACE TRANSVERSE 1/2" EXPANSION JOINT AT MAXIMUM OF 100' SPACING 7.5. PLACE 1/2" EXPANSION JOINT WHEN ABUTTING A FIXED STRUCTURE, OTHER PAVEMENT (CONCRETE PAVEMENT AND DRIVE APPROACHES), UTILITY STRUCTURES, LIGHT POLE BASES AND COLUMNS

GENERAL GRADING AND EARTHWORK NOTES:


BLANKET PEGGED IN PLACE OVER SEED.

THESE NOTES APPLY TO ALL CONSTRUCTION ACTIVITIES ON THIS PROJECT

- CONTRACTOR SHALL FIELD VERIFY ALL EXISTING TREES AND BRUSH AND REMOVE ALL THAT ARE NECESSARY TO GRADE SITE.
- 2. ALL GRADES ARE TO TOP OF PAVEMENT UNLESS OTHERWISE NOTED.

MINIMUM OF 3" OF TOPSOIL IN THESE AREAS UNLESS OTHERWISE NOTED.

- 3. THE STAGING OF CONSTRUCTION ACTIVITIES SHALL OCCUR ONLY WITHIN THE SITE BOUNDARIES. ANY CONSTRUCTION ACTIVITIES OUTSIDE OF THE SITE BOUNDARIES SHALL BE AT THE SOLE RESPONSIBILITY AND RISK OF THE CONTRACTOR.
- I. ALL SOIL EROSION AND SEDIMENTATION CONTROL MEASURES SHALL MEET THE REQUIREMENTS OF THE AUTHORIZED PUBLIC AGENCY OF JURISDICTION. AN EROSION CONTROL PERMIT MUST BE SECURED FROM THE XXXX PRIOR TO CONSTRUCTION.
- 5. ALL EARTHWORK AND GRADING OPERATIONS SHALL BE PERFORMED IN ACCORDANCE WITH THE SOILS INVESTIGATION AND REPORT
- 6. REFER TO SOIL EROSION CONTROL PLAN FOR ADDITIONAL SOIL EROSION AND SEDIMENTATION CONTROL MEASURES AND NOTES. 7. THE DETENTION BASIN SIDE SLOPES AND ALL SLOPE EXCEEDING 1:6 MUST BE STABILIZED BY SODDING OR BY PLACING A MULCH
- 8. ALL DISTURBED AREAS SHALL BE SEEDED AND MULCHED OR SODDED IN ACCORDANCE WITH THE LANDSCAPE PLANS. PROVIDE A
- 9. THE CONTRACTOR SHALL NOTE EXISTING UNDERGROUND UTILITIES WITHIN AND ADJACENT TO THE SITE. BACKFILL FOR EXISTING UTILITY TRENCHES SHALL BE EXAMINED CRITICALLY. ANY TRENCHES FOUND TO HAVE SOFT, UNSTABLE OR UNSUITABLE BACKFILL MATERIAL, IN THE OPINION OF THE THIRD PARTY TESTING COMPANY, THAT ARE TO BE WITHIN THE ZONE OF INFLUENCE OF PROPOSED BUILDINGS OR PAVEMENT SHALL BE COMPLETELY EXCAVATED AND BACKFILLED WITH SUITABLE MATERIAL.
- 10. ON-SITE FILL CAN BE USED IF THE SPECIFIED COMPACTION REQUIREMENTS CAN BE ACHIEVED. IF ON-SITE SOIL IS USED, IT SHOULD BE CLEAN AND FREE OF FROZEN SOIL, ORGANICS, OR OTHER DELETERIOUS MATERIALS.
- 1. THE FINAL SUBGRADE/EXISTING AGGREGATE BASE SHOULD BE THOROUGHLY PROOFROLLED USING A FULLY LOADED TANDEM AXLE TRUCK OR FRONT END LOADER UNDER THE OBSERVATION OF A GEOTECHNICAL/PAVEMENT ENGINEER. LOOSE OR YIELDING AREAS THAT CANNOT BE MECHANICALLY STABILIZED SHOULD BE REINFORCED USING GEOGRIDS OR REMOVED AND REPLACED WITH ENGINEERED FILL OR AS DICTATED BY FIELD CONDITIONS.
- 12. SUBGRADE UNDERCUTTING, INCLUDING BACKFILLING SHALL BE PERFORMED TO REPLACE MATERIALS SUSCEPTIBLE TO FROST HEAVING AND UNSTABLE SOIL CONDITIONS. ANY EXCAVATIONS THAT MAY BE REQUIRED BELOW THE TOPSOIL IN FILL AREAS OR BELOW PROPOSED SUBGRADE IN CUT AREAS WILL BE CLASSIFIED AS SUBGRADE UNDERCUTTING.
- 13. SUBGRADE UNDERCUTTING SHALL BE PERFORMED WHERE NECESSARY AND THE EXCAVATED MATERIAL SHALL BECOME THE PROPERTY OF THE CONTRACTOR. ANY SUBGRADE UNDERCUTTING SHALL BE BACKFILLED AS RECOMMENDED IN THE GEOTECHNICAL ENGINEERING REPORT FOR THE PROJECT.
- 14. ANY SUBGRADE WATERING REQUIRED TO ACHIEVE REQUIRED DENSITY SHALL BE CONSIDERED INCIDENTAL TO THE JOB.

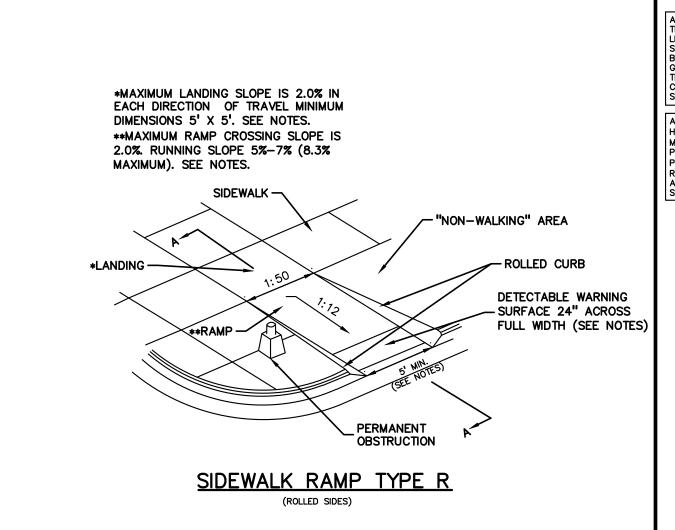

TOP OF CONCRETE
- COLLAR TO MATCH
PAVEMENT ELEVATION

CONCRETE COLLAR DETAIL

VARIES - SEE PLAN

<u>HEAVY DUTY CONCRETE PAD DETAIL</u>

6AA CONCRETE

- DECORATIVE STONE CAP

- #4 AT 16" O.C. VERT.

-12" MIN. OVERLAP W/FOOTING BARS., TYP.

PROVIDE FOOTING BARS EVERY 16" O.C.

WHEN NOT ADDRESSED IN THE
GEOTECHNICAL INVESTIGATION OR THE
ARCHITECTURAL PLAN PLACE ON
NATURAL SOILS OF AT LEAST 1500 PSF
NET ALLOWABLE BEARING CAPACITY OR

EXTEND 12" MIN. ABOVE FOOTING WHEN NOT ADDRESSED IN THE

DOCUMENTED ENGINEERED FILL

SEE PLAN FOR GATE LOCATION

/3 - #4 BARS CONT AT 12" C-C HORIZ.

DUMPSTER ENCLOSURE WALL CROSS SECTION

NOT TO SCALE

ARCHITECTURAL MASONRY TO MATCH BUILDING

PROOF-ROLLED/COMPACTED SUBGRADE OR ENGINEERED FILL COMPACTED TO 95% C

MAX. DRY UNIT WEIGHT PER ASTM D-1557.

PROOF-ROLLED/COMPACTED SUBGRADE OR ENGINEERED

FILL COMPACTED TO 95% OF MAX. DRY UNIT WEIGHT PER ASTM D-1557.

6 MDUI #ZIAA CRUSHED LIMESTONE BASE COURSE COMPACTED TO 95% MAX. DRY UNIT WEIGHT PER ASTM D-1557

8" MASONRY BLOCK —

PROVIDE 1/2"x8"
FIBER JOINT FILLER —
BETWEEN SLAB &

WALL ASTM (D1751

HEAVY DUTY CONCRETE PAD -

4 4 4 4 4

SLOPE TO PROVIDE POSITIVE DRAINAGE TOWARD CATCH BASIN,

FOR MANHOLE STRUCTURE)

(CONSTRUCT FLUSH WITH PAVEMENT

NOTE: ROUT A 1" X 3/4" RESERVOIR AROUND EDGES. POUR HOT RUBBER

NON-SILICONE BASED SEALANT ALONG ALL EDGES OF CONCRETE COLLAR ADJACENT TO ASPHALT PAVEMENT.

NOTE: COLLARS USED AT MANHOLES, GATE WELLS

ETC. CAN UTILIZE THIS SAME DETAIL,
EXCEPT THAT THE PAD GRADES SHOULD
CONFORM TO THE SURROUNDING PAVEMENT
GRADES, NOT PITCH TO THE STRUCTURE
CASTING AS SHOWN FOR CATCH BASINS

HEAVY DUTY CONCRETE

SECTION. REFER TO

SAWCUT CONTRACTION JOINTS

NOTE: ROUT A 1" X 3/4" RESERVOIR

NON-SILICONE BASED SEALANT ALONG ALL EDGES OF CONCRETE COLLAR ADJACENT TO ASPHALT PAVEMENT.

6" Ø STANDARD

PAVEMENT-

PAINT WITH REFLECTIVE YELLOW PAINT

1'-6" Ø CONC. BASE

BAR EACH WAY THRU


ARCHITECTURAL MASONRY TO MATCH FINISH OF BUILDING.

SIDE ELEVATION

6" DIA. GUARD POST DETAIL

DOUBLE TRASH ENCLOSURE DETAILS

DEPTH OF SLAB

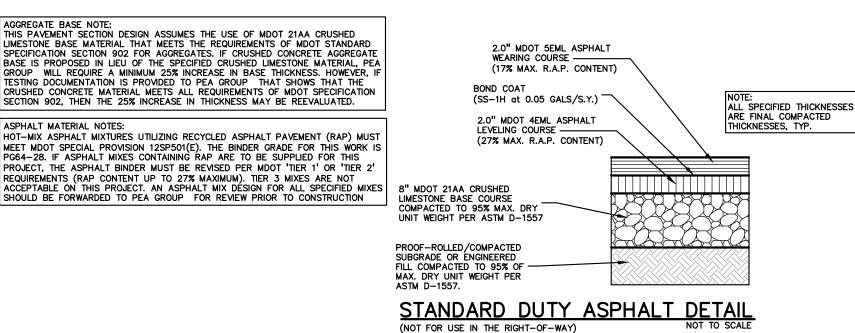

23'-4"

1" x 6" PRESSURE TREATED

MASONRY ON BUILDING

(ACQ) #2 CEDAR ON 2" x 6"

-PRESSURE TREATED (ACQ) FRAME

STAIN TO MATCH ARCHITECTURAL

FRONT ELEVATION

23'-4'

— 6" DIA. CONC. FILLED GUARD

POST SET IN CONCRETE FOOTING, TYP.

<u>DOUBLE DUMPSTER ENCLOSURE DETAIL</u>

TOP HINGE, TYP


-4" CLEARANCE TO SLAB


SEE HEAVY-DUTY CONCRETE PAD DETAIL, THIS SHEET


MATCH FINISH OF BUILDING.


- GATES CONNECTED TO GUARD POSTS BY HEAVY


ASPHALT MIX DESIGN CHART					
COMMERCIAL ADT 0-300	COMMERCIAL ADT 301-1000	COMMERCIAL ADT 1001-3400	COMMERCIAL ADT ≥3401	APPLICATION RATE (LB/YD²), MINIMUM — MAXIMUM	COURSE APPLICATION
2EL	2EML	2EMH	2EH	435-550	BASE
3EL	3EML	ЗЕМН	3EH	330-410	BASE AND/OR LEVELING
4EL	4EML	4EMH	4EH	220-275	LEVELING AND/OR TOP
5EL	5EML	5EMH	5EH	165-220	ТОР
PG 58-28	PG 64-28	PG 64-28	PG 70-28P		

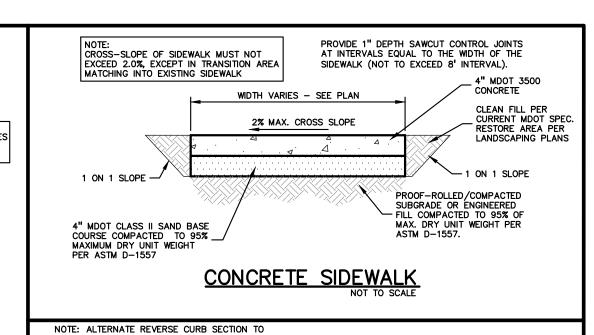


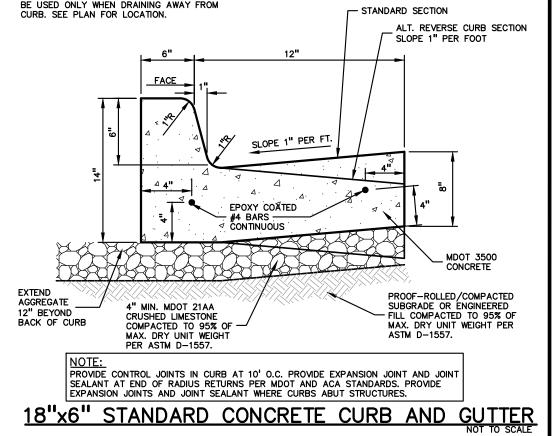


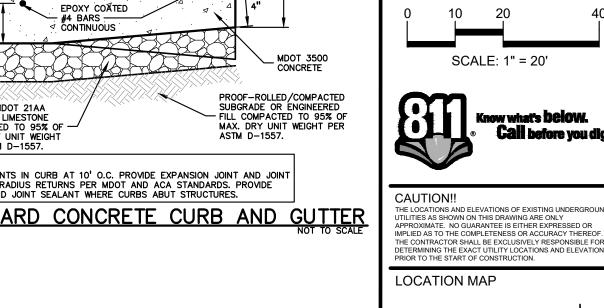


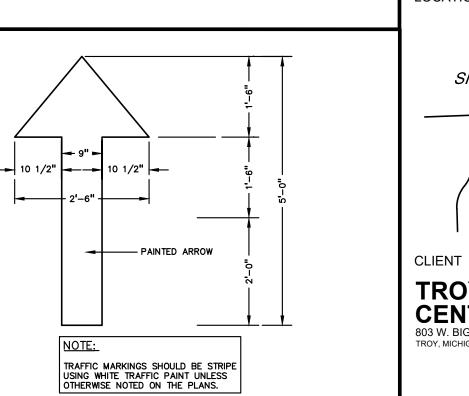

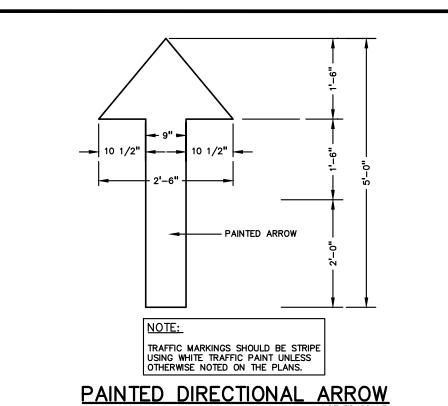


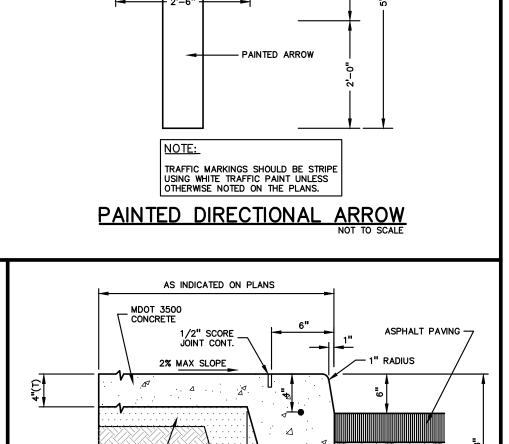

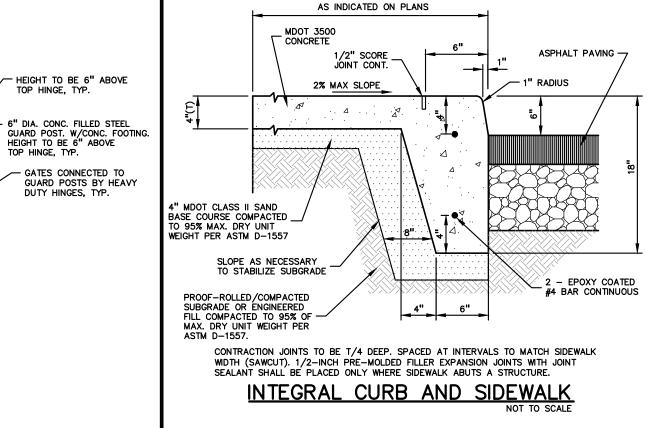

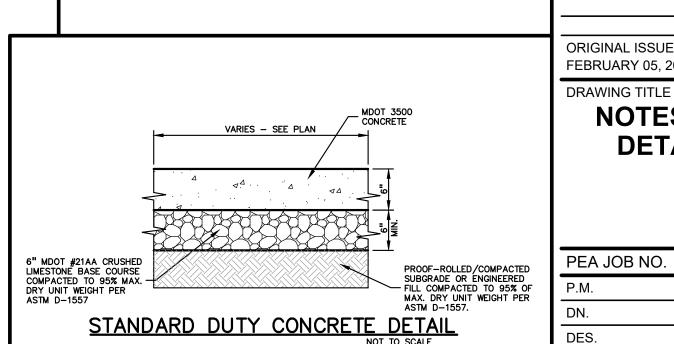

NOT FOR CONSTRUCTION

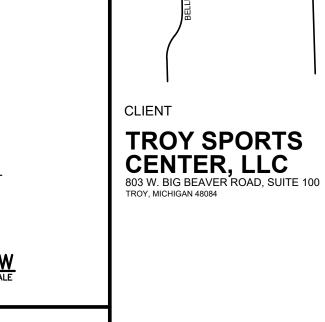

t: 844.813.2949

www.peagroup.com


PROJECT TITLE **STARBUCKS** 1735 E. BIG BEAVER ROAD CITY OF TROY, OAKLAND COUNTY, MICHIGAN

	REVISIONS	
ļ	CITY REVISIONS	5/31/2024
_	CITY REVISIONS	7/17/2024
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ORIGINAL ISSUE DATE: FEBRUARY 05, 2024

> **NOTES AND DETAILS**


PEA JOB NO. 23-0922 JPB KS JPB DRAWING NUMBER:

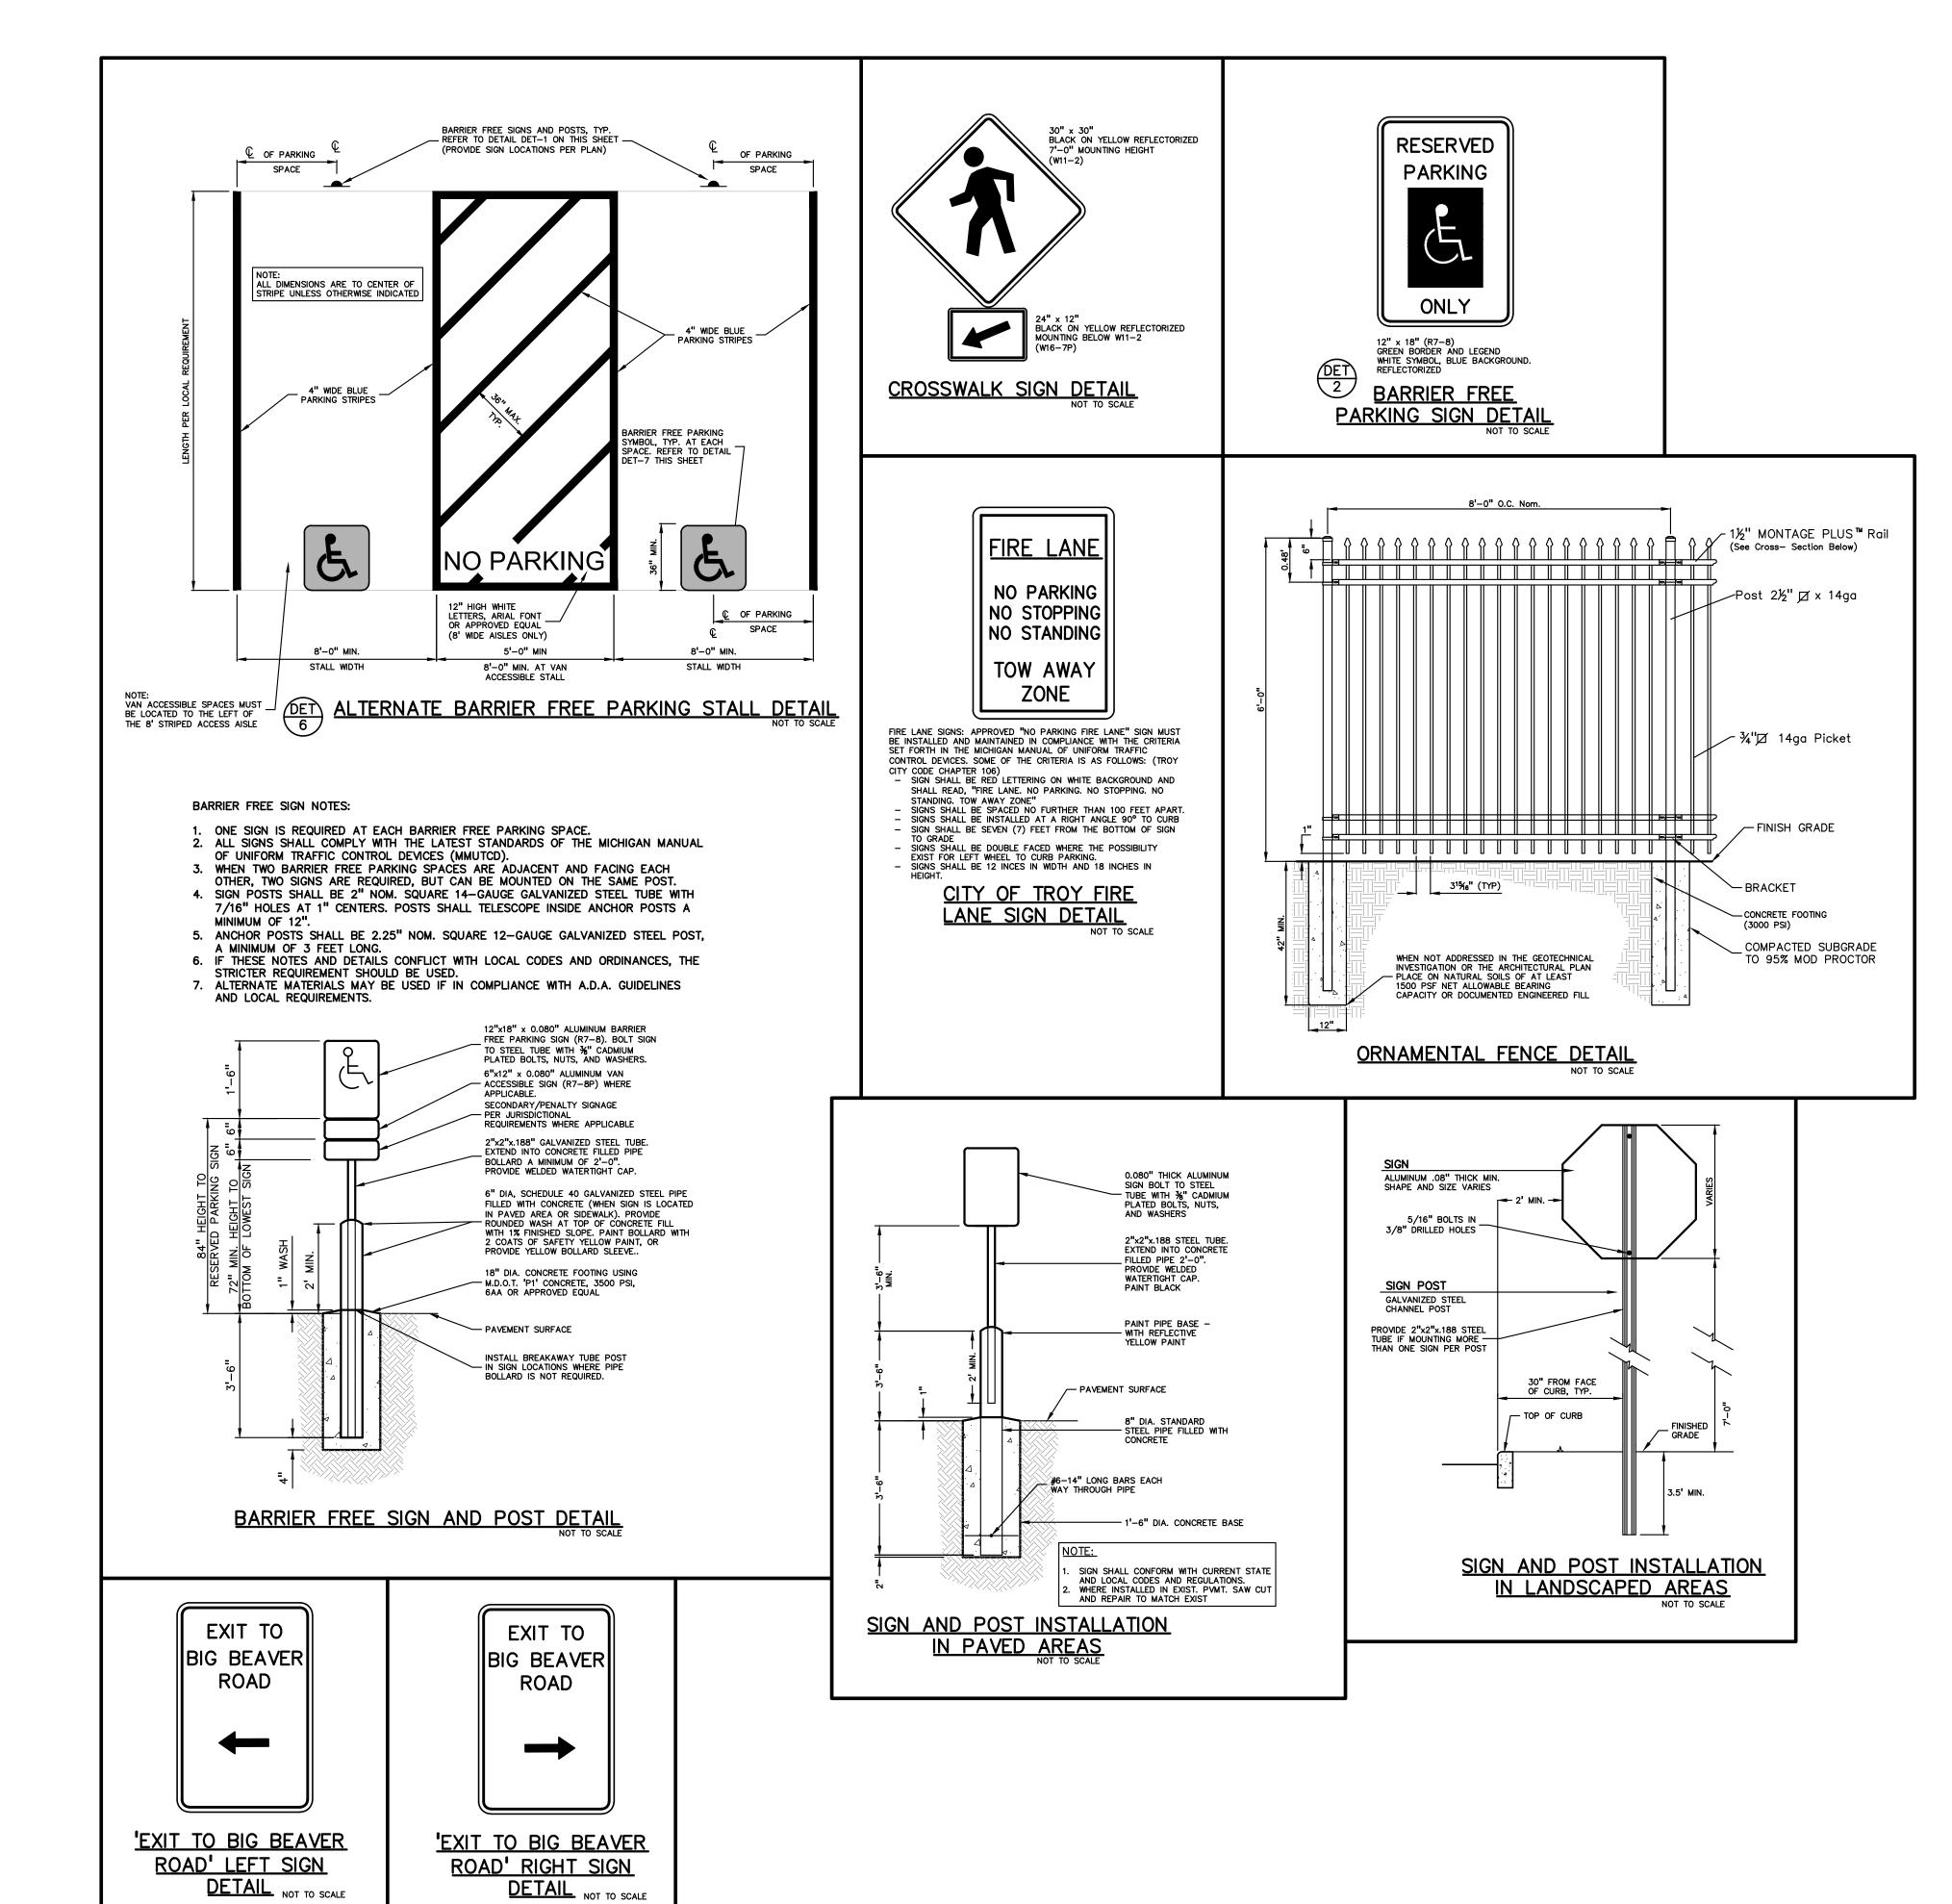

PEA GROUP t: 844.813.2949 www.peagroup.com





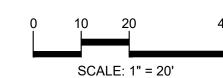




CAUTION!!

THE LOCATIONS AND ELEVATIONS OF EXISTING UNDERGROUND UTILITIES AS SHOWN ON THIS DRAWING ARE ONLY APPROXIMATE. NO GUARANTEE IS EITHER EXPRESSED OR IMPLIED AS TO THE COMPLETENESS OR ACCURACY THEREOF. THE CONTRACTOR SHALL BE EXCLUSIVELY RESPONSIBLE FOR DETERMINING THE EXACT UTILITY LOCATIONS AND ELEVATIONS PRIOR TO THE START OF CONSTRUCTION.

LOCATION MAP

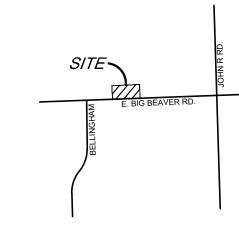

CLIENT

TROY SPORTS CENTER, LLC 803 W. BIG BEAVER ROAD, SUITE 100 TROY, MICHIGAN 48084

PROJECT TITLE

STARBUCKS 1735 E. BIG BEAVER ROAD CITY OF TROY, OAKLAND COUNTY, MICHIGAN


REVISIONS	
CITY REVISIONS	5/31/2024
CITY REVISIONS	7/17/2024

ORIGINAL ISSUE DATE: FEBRUARY 05, 2024

DRAWING TITLE

NOTES AND DETAILS

PEA JOB NO.	23-0922
P.M.	JPB
DN.	KS
DES.	JPB
DDAMING NUMBER.	

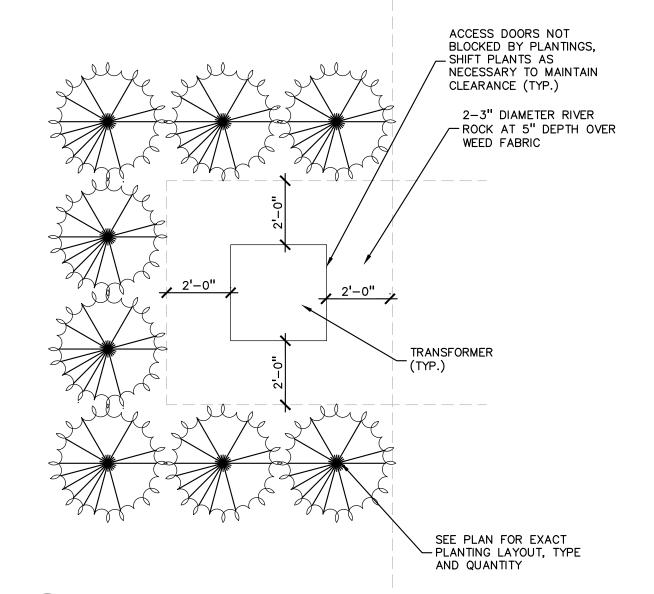

TRANSFORMER SCREENING DETAIL-FOR ACCESS REF. ONLY SCALE: 1'' = 3'-0''

- FACE OF BUILDING/ SIGN/ CURB

2"-3" DIA. RIVER ROCK

GRAY FILTER FABRIC TO

CONCEALED WITH STONE

_HEAVY DUTY ALUMINUM

SUBGRADE, COMPACT TO _ 95% MAX. DRY UNIT DENSITY (PER ASTM 0-1557)

PERMALOC ALUMINUM EDGING OR APPROVED

EQUAL WITH BLACK FINISH

- COMPACTED SUBGRADE

-BED MEDIA

SPECIFICATIONS FOR LANDSCAPE BED EDGING:

PERMALOC 1.800.356.9660

BETWEEN SECTIONS

AT 5" DEPTH

- BE COMPLETELY

EDGE - BLACK

TREE PROTECTION WILL BE ERECTED PRIOR TO START OF CONSTRUCTION ACTIVITIES AND SHALL REMAIN IN PLACE UNTIL CONSTRUCTION IS COMPLETE NO PERSON MAY CONDUCT ANY ACTIVITY WITHIN THE DRIP LINE OF ANY TREE DESIGNATED TO REMAIN; INCLUDING, BUT NOT LIMITED TO PLACING SOLVENTS, BUILDING MATERIAL, CONSTRUCTION EQUIPMENT OR SOIL DEPOSITS WITHIN DRIP LINES LINE OF PROTECTED TREES

GRADE CHANGES MAY NOT OCCUR WITHIN THE DRIP

DURING CONSTRUCTION, NO PERSON SHALL ATTACH ANY DEVICE OR WIRE TO ANY REMAINING TREE

ALL UTILITY SERVICE REQUESTS MUST INCLUDE NOTIFICATION TO THE INSTALLER THAT PROTECTED TREES MUST BE AVOIDED. ALL TRENCHING SHALL OCCUR OUTSIDE OF THE PROTECTIVE FENCING

TREES LOCATED ON ADJACENT PROPERTY THAT MAY BE AFFECTED BY CONSTRUCTION ACTIVITIES MUST BE

TREES TO BE PRESERVED SHALL BE IDENTIFIED WITH FLAGGING PRIOR TO THE TREE CLEARING OPERATIONS PROVIDE FENCE AROUND CRITICAL ROOT ZONE OF

FENCE SHALL BE PLACED IN A CIRCLE WITH A

- EXISTING SOIL

MINIMUM RADIUS OF 1' PER 1" DIAMETER OF THE

TREE MEASURED AT 4.5' ABOVE GROUND 4'HIGH PROTECTIVE FENCING WITH STEEL POSTS - 10' O.C.

GROUP

t: 844.813.2949


www.peagroup.com

TREE PROTECTION DETAIL SCALE: 1'' = 3'-0''



CAUTION!! THE LOCATIONS!

THE LOCATIONS AND ELEVATIONS OF EXISTING UNDERGROUND UTILITIES AS SHOWN ON THIS DRAWING ARE ONLY APPROXIMATE. NO GUARANTEE IS EITHER EXPRESSED OR IMPLIED AS TO THE COMPLETENESS OR ACCURACY THEREOF. THE CONTRACTOR SHALL BE EXCLUSIVELY RESPONSIBLE FOR DETERMINING THE EXACT UTILITY LOCATIONS AND ELEVATIONS PRIOR TO THE START OF CONSTRUCTION. **LOCATION MAP**

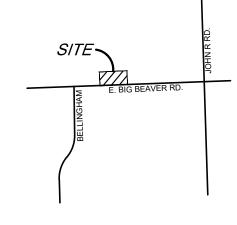

TROY SPORTS **CENTER, LLC** 803 W. BIG BEAVER ROAD, SUITE 100 TROY, MICHIGAN 48084

PROJECT TITLE

REVISIONS

CITY REVISIONS

CITY REVISIONS

DRAWING TITLE

5/31/2024


7/17/2024

STARBUCKS 1735 E. BIG BEAVER ROAD CITY OF TROY, OAKLAND COUNTY, MICHIGAN

PLANT SO THAT TOP OF ROOT BALL IS FLUSH TO GRADE OR 1-2" HIGHER IF IN POORLY DRAINED SOILS DO NOT COVER TOP OF ROOTBALL WITH SOIL FORM SAUCER WITH 4" HIGH CONTINUOUS RIM SHREDDED HARDWOOD BARK MULCH 3" DEEP AND LEAVE 3" CIRCLE OF BARE SOIL AROUND TRUNK. DO NOT PLACE MULCH IN CONTACT WITH TRUNK — FINISH GRADE SPECIFIED PLANTING MIX. WATER AND TAMP TO REMOVE AIR POCKETS REMOVE ALL BURLAP FROM TOP 3 OF ROOTBALL. DISCARD ALL NON-BIODEGRADABLE MATERIAL OFF SITE VARIES ON CONTAINER OR BALL SIZE PLACE ROOTBALL ON UNEXCAVATED OR

SCALE: 1'' = 2' - 0''

SHRUB PLANTING DETAIL

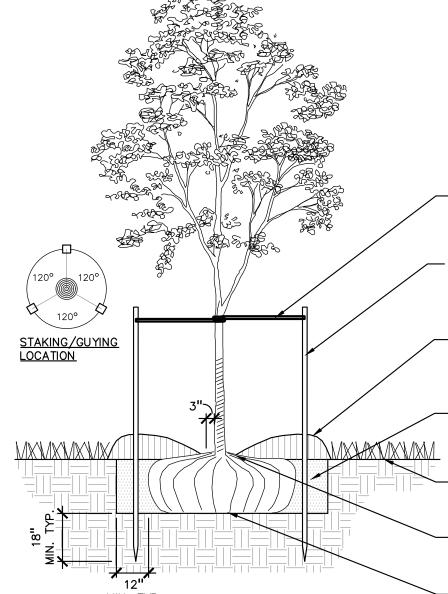

PLANT SO THAT TOP OF ROOT BALL IS FLUSH TO GRADE OR 1-2" HIGHER IF IN POORLY DRAINED SOILS SECURE TREE WRAP WITH BIODEGRADABLE

FIRST WINTER DO NOT PRUNE TERMINAL LEADER PRUNE ONLY DEAD, BROKEN BRANCHES AS

DIRECTED BY LANDSCAPE ARCHITECT STAKE JUST BELOW BRANCHES WITH 2"-3" WIDE NYLON OR PLASTIC STRAPS. CONNECT

(3) THREE 2"X2" HARDWOOD STAKES DRIVEN A MIN. OF 18" DEEP FIRMLY INTO SUBGRADE PRIOR TO BACKFILLING

SHREDDED HARDWOOD BARK MULCH TO DRIPLINE. 3" DEEP AND LEAVE 3" CIRCLE OF ORIGINAL ISSUE DATE: BARE SOIL AROUND TREE TRUNK. DO NOT FEBRUARY 05, 2024 PLACE MULCH IN CONTACT WITH TREE TRUNK. FORM SAUCER WITH 4" HIGH

CONTINUOUS RIM SPECIFIED PLANTING MIX, WATER & TAMP TO - REMOVE AIR POCKETS, AMEND SOIL PER SITE CONDITIONS & TREE REQUIREMENTS

DETAILS

	PEA JOB NO.	23-0922
	P.M.	JPB
	DN.	CAL
	DES.	JLE
_	DRAWING NUMBER:	

LANDSCAPE

MATERIAL AT TOP & BOTTOM, REMOVE AFTER FLEXIBILITY. REMOVE AFTER (1) ONE YEAR. (DO NOT USE WIRE & HOSE) -FINISH GRADE EXPOSE ROOT FLARE OF TREE. CONTRACTOR MAY HAVE TO REMOVE EXCESS SOIL FROM - TOP OF ROOTBALL. REMOVE ALL BURLAP FROM TOP 3 OF ROOTBALL. DISCARD ALL NON-BIODEGRADABLE MATERIAL OFF SITE _ PLACE ROOTBALL ON UNEXCAVATED OR TAMPED SOIL DECIDUOUS TREE PLANTING DETAIL

SCALE: 1'' = 3'-0''

LANDSCAPE BED EDGING SHALL BE ALUMINUM AS MANUFACTURED BY 8' OR 16' SECTIONS SHALL BE USED WITH ONE STAKE PER 38" OF EDGING SHALL BE 语" THICK X 4" DEPTH WHEN ADJ. TO MULCH AND គឺ" THICK X 5 ½" DEPTH WHEN ADJ. TO ROCK, FINISH: BLACK DURAFLEX MEETING AAMA 2603 STAKE SHALL SECURELY ENGAGE EDGING AND SHALL BE ENTIRELY BELOW TOP SURFACE OF EDGING EDGING SHALL HAVE A MINIMUM OF 2" OF INTERLOCKING OVERLAP

INSTALL AS PER MANUFACTURER'S SPECIFICATIONS WITH TOP OF EDGING $\frac{1}{4}$ " ABOVE COMPACTED FINISH GRADE. FINISH GRADE TO BE COMPACTED ON BOTH SIDES OF EDGING TO MAINTAIN STABILITY

ALUMINUM EDGE DETAIL SCALE: 1/2'' = 1'-0''


SEE PLAN


RIVER ROCK EDGE DETAIL

SCALE: $1 \frac{1}{2}$ " = 1'-0"

NOT FOR CONSTRUCTION

 $\fint x - TBLK - 23 - 0101.dwa$

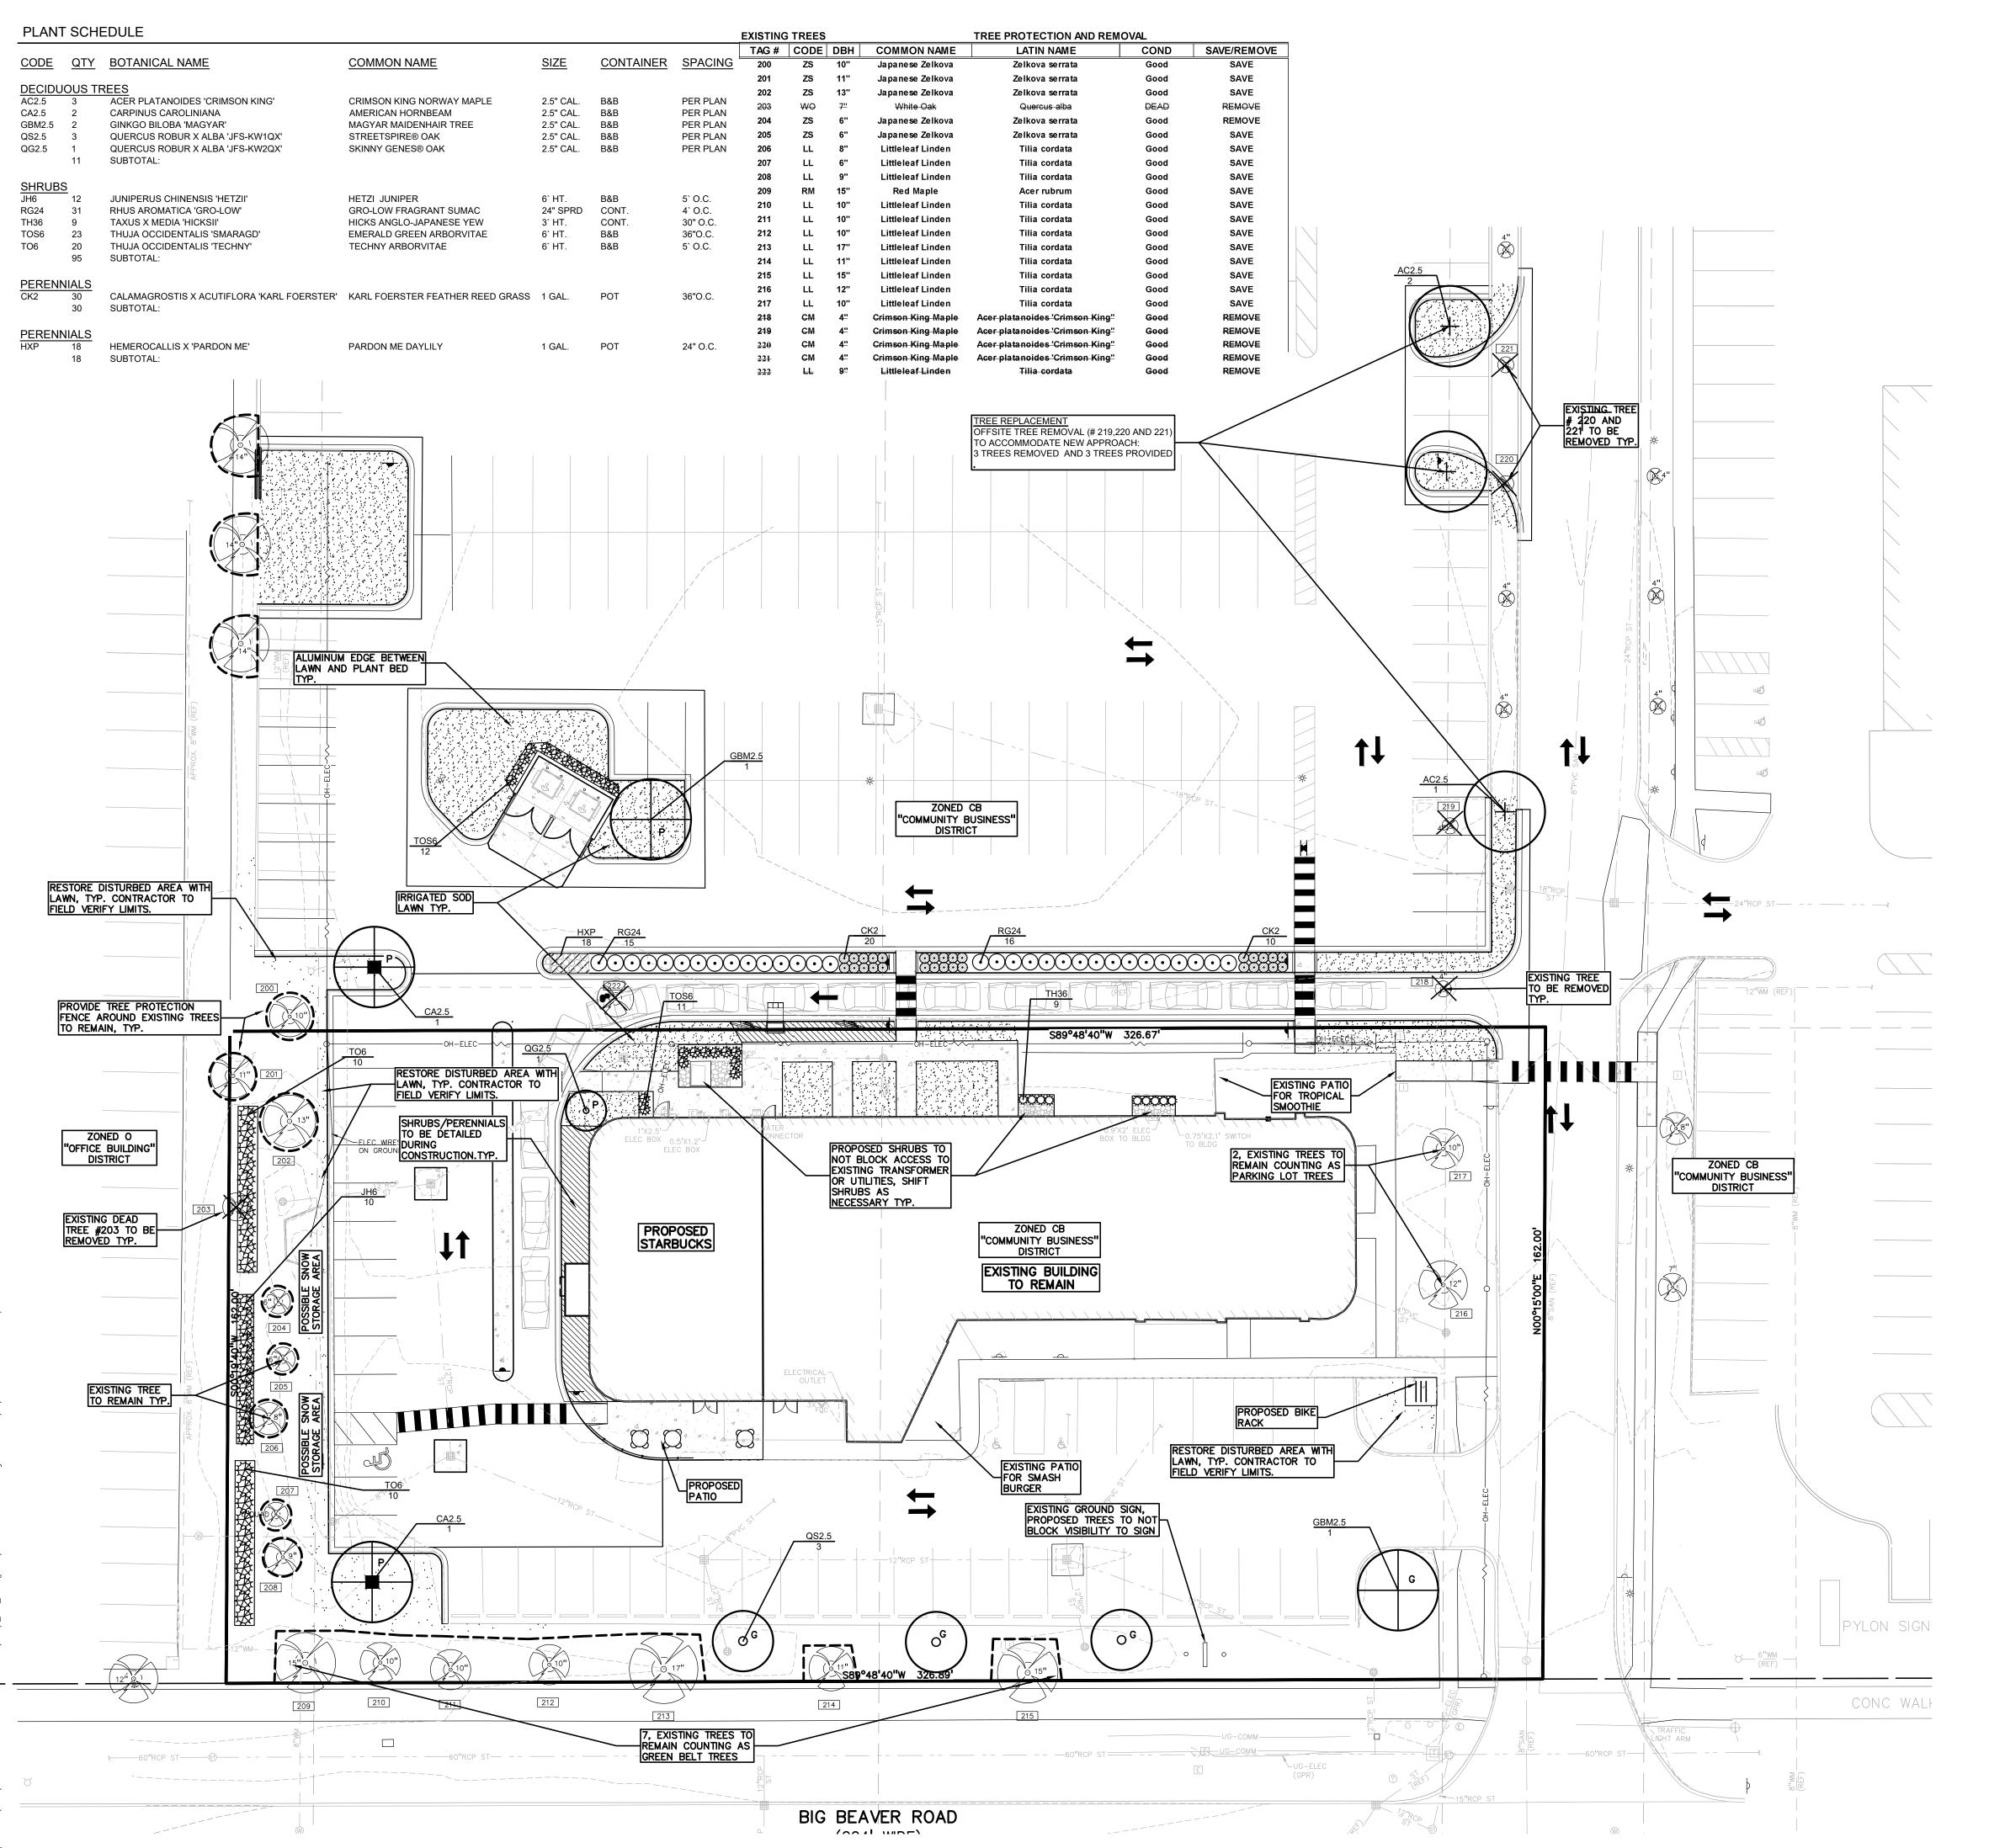

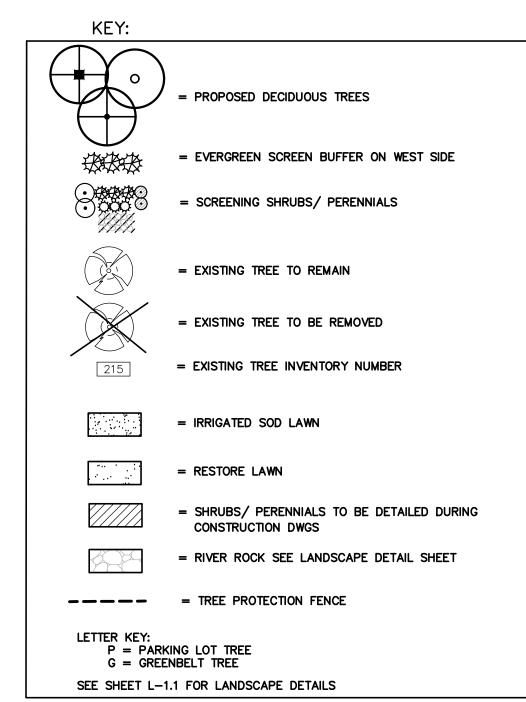

LANDSCAPE CALCULATIONS:
PER CITY OF TROY ZONING ORDINANCE; CB-COMMUNITY BUSINESS DISTRICT PARKING LOT LANDSCAPING = P REQUIRED: 1 TREE / 8 PARKING SPACES 47 PARKING SPACES / 8 = 6 TREES

GREENBELT ON BIG BEAVER ROAD RD = GREQUIRED: 1 DEC TREE / 30 LF OF STREET FRONTAGE BIG BEAVER RD: 326.89 LF / 30 = 11 TREES

PROVIDED: BIG BEAVER RD: 7 EXISTING TREES AND 4 PROPOSED TREES

PROVIDED: PROPOSED 4 DEC. TREES AND 2 EXISTING TREES EAST SIDE OF BLDG

GENERAL SITE LANDSCAPE REQUIRED: 20% OF SITE AREA SHALL BE LANDSCAPE MATERIAL; 1.22 ACRES (52,937 SQ.FT.) * 20% = 10,587.4 SQ FT PROVIDED: 17,253.96 SQ FT OF SOFT SCAPE (32.59% OF SITE AREA)

EQUIPMENT SCREENING
REQUIRED: AT GRADE EQUIPMENT SHALL BE SCREENED BY EVG LANDSCAPE MATERIALS AND DUMPSTER.

PROVIDED: EVERGREEN SHRUBS AROUND TRASH AND UTILITIES

CONTACT LANDSCAPE ARCHITECT WITH ANY CONCERNS.

LANDSCAPE PLAN PRIOR TO PRICING THE WORK.

SCREENING BETWEEN CONFLICTING USES REQUIRED: 1 LG EVERGREEN /10 LF OR 1 NARROW EVERGREEN /5 LF WEST SIDE, 162 LF /10 = 16 LG EVG OR 162 LF/5 = 32 NARROW EVG. PROVIDED: 30 NARROW EVERGREEN WEST SIDE

GENERAL PLANTING NOTES: LANDSCAPE CONTRACTOR SHALL VISIT SITE, INSPECT EXISTING SITE CONDITIONS AND REVIEW PROPOSED PLANTING AND RELATED WORK. IN CASE OF DISCREPANCY BETWEEN PLAN AND PLANT LIST, PLAN SHALL GOVERN QUANTITIES.

CONTRACTOR SHALL VERIFY LOCATIONS OF ALL ON SITE UTILITIES PRIOR TO BEGINNING CONSTRUCTION ON HIS/HER PHASE OF WORK. ELECTRIC, GAS, TELEPHONE, CABLE TELEVISION MAY BE LOCATED BY CALLING MISS DIG 1-800-482-7171. ANY DAMAGE OR INTERRUPTION OF SERVICES SHALL BE THE RESPONSIBILITY OF CONTRACTOR. CONTRACTOR SHALL COORDINATE ALL RELATED ACTIVITIES WITH OTHER TRADES ON THE JOB AND SHALL REPORT ANY UNACCEPTABLE JOB CONDITIONS TO OWNER'S REPRESENTATIVE PRIOR TO COMMENCING.

ALL PLANT MATERIAL TO BE PREMIUM GRADE NURSERY STOCK AND SHALL SATISFY AMERICAN ASSOCIATION OF NURSERYMEN STANDARD FOR NURSERY STOCK. ALL LANDSCAPE MATERIAL SHALL BE NORTHERN GROWN, NO. 1. GRADE.

CONTRACTOR IS RESPONSIBLE FOR VERIFYING ALL QUANTITIES SHOWN ON

THE OWNER'S REPRESENTATIVE RESERVES THE RIGHT TO REJECT ANY PLANT

MATERIAL NOT MEETING SPECIFICATIONS.

ALL SINGLE STEM SHADE TREES TO HAVE STRAIGHT TRUNKS AND SYMMETRICAL

ALL SINGLE TRUNK SHADE TREES TO HAVE A CENTRAL LEADER; TREES WITH FORKED OR IRREGULAR TRUNKS WILL NOT BE ACCEPTED.

ALL MULTI STEM TREES SHALL BE HEAVILY BRANCHED AND HAVE SYMMETRICAL CROWNS. ONE SIDED TREES OR THOSE WITH THIN OR OPEN CROWNS SHALL NOT

ALL EVERGREEN TREES SHALL BE HEAVILY BRANCHED AND FULL TO THE GROUND, SYMMETRICAL IN SHAPE AND NOT SHEARED FOR THE LAST FIVE GROWING SEASONS.

10. ALL TREES TO HAVE CLAY OR CLAY LOAM BALLS, TREES WITH SAND BALLS WILL BE REJECTED.

. NO MACHINERY IS TO BE USED WITHIN THE DRIP LINE OF EXISTING TREES; HAND GRADE ALL LAWN AREAS WITHIN THE DRIP LINE OF EXISTING TREES.

12. ALL TREE LOCATIONS SHALL BE STAKED BY LANDSCAPE CONTRACTOR AND ARE SUBJECT TO THE APPROVAL OF THE LANDSCAPE ARCHITECT PRIOR TO INSTALLATION OF THE PLANT MATERIAL.

13. IT IS MANDATORY THAT POSITIVE DRAINAGE IS PROVIDED AWAY FROM ALL BUILDINGS.

14. ALL PLANTING BEDS SHALL RECEIVE 3" SHREDDED HARDWOOD BARK MULCH WITH PRE EMERGENT, SEE SPECIFICATIONS. SHREDDED PALETTE AND DYED MULCH WILL NOT BE ACCEPTED.

15. ALL LANDSCAPED AREAS SHALL RECEIVE 3" COMPACTED TOPSOIL.

16. SEE SPECIFICATIONS FOR ADDITIONAL COMMENTS, REQUIREMENTS, PLANTING PROCEDURES AND WARRANTY STANDARDS.

7. FOR NON-LAWN SEED MIX AREAS, AS NOTED ON PLAN, BRUSH MOW ONCE SEASONALLY FOR INVASIVE SPECIES CONTROL.

8. CONTRACTOR SHALL NOT INSTALL PLANTS UNDER BUILDING OVERHANG AND

SHALL NOTIFY LANDSCAPE ARCHITECT IF DRAWINGS CONFLICT WITH BUILDING 19. TREES SHALL NOT CONFLICT/ BLOCK PROPOSED REGULATORY/ DIRECTION SIGNAGE, MONUMENT SIGNS, ADDRESS OR LIGHT POLES. SHIFT TREES AS NECESSARY TYP.

DRAWING TITLE

REVISIONS

PRELIMINARY LANDSCAPE **PLAN**


PEA JOB NO.	23-0922
P.M.	JPB
DN.	CAL
DES.	JLE
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NOT FOR CONSTRUCTION










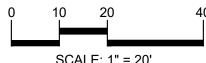

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LOCATION MAP

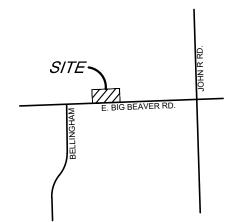

CLIENT


TROY SPORTS CENTER, LLC 803 W. BIG BEAVER ROAD, SUITE 100 TROY, MICHIGAN 48084


PROJECT TITLE

STARBUCKS 1735 E. BIG BEAVER ROAD CITY OF TROY, OAKLAND COUNTY, MICHIGAN

CITY REVISIONS	5/31/2024
CITY REVISIONS	7/17/2024


ORIGINAL ISSUE DATE: FEBRUARY 05, 2024

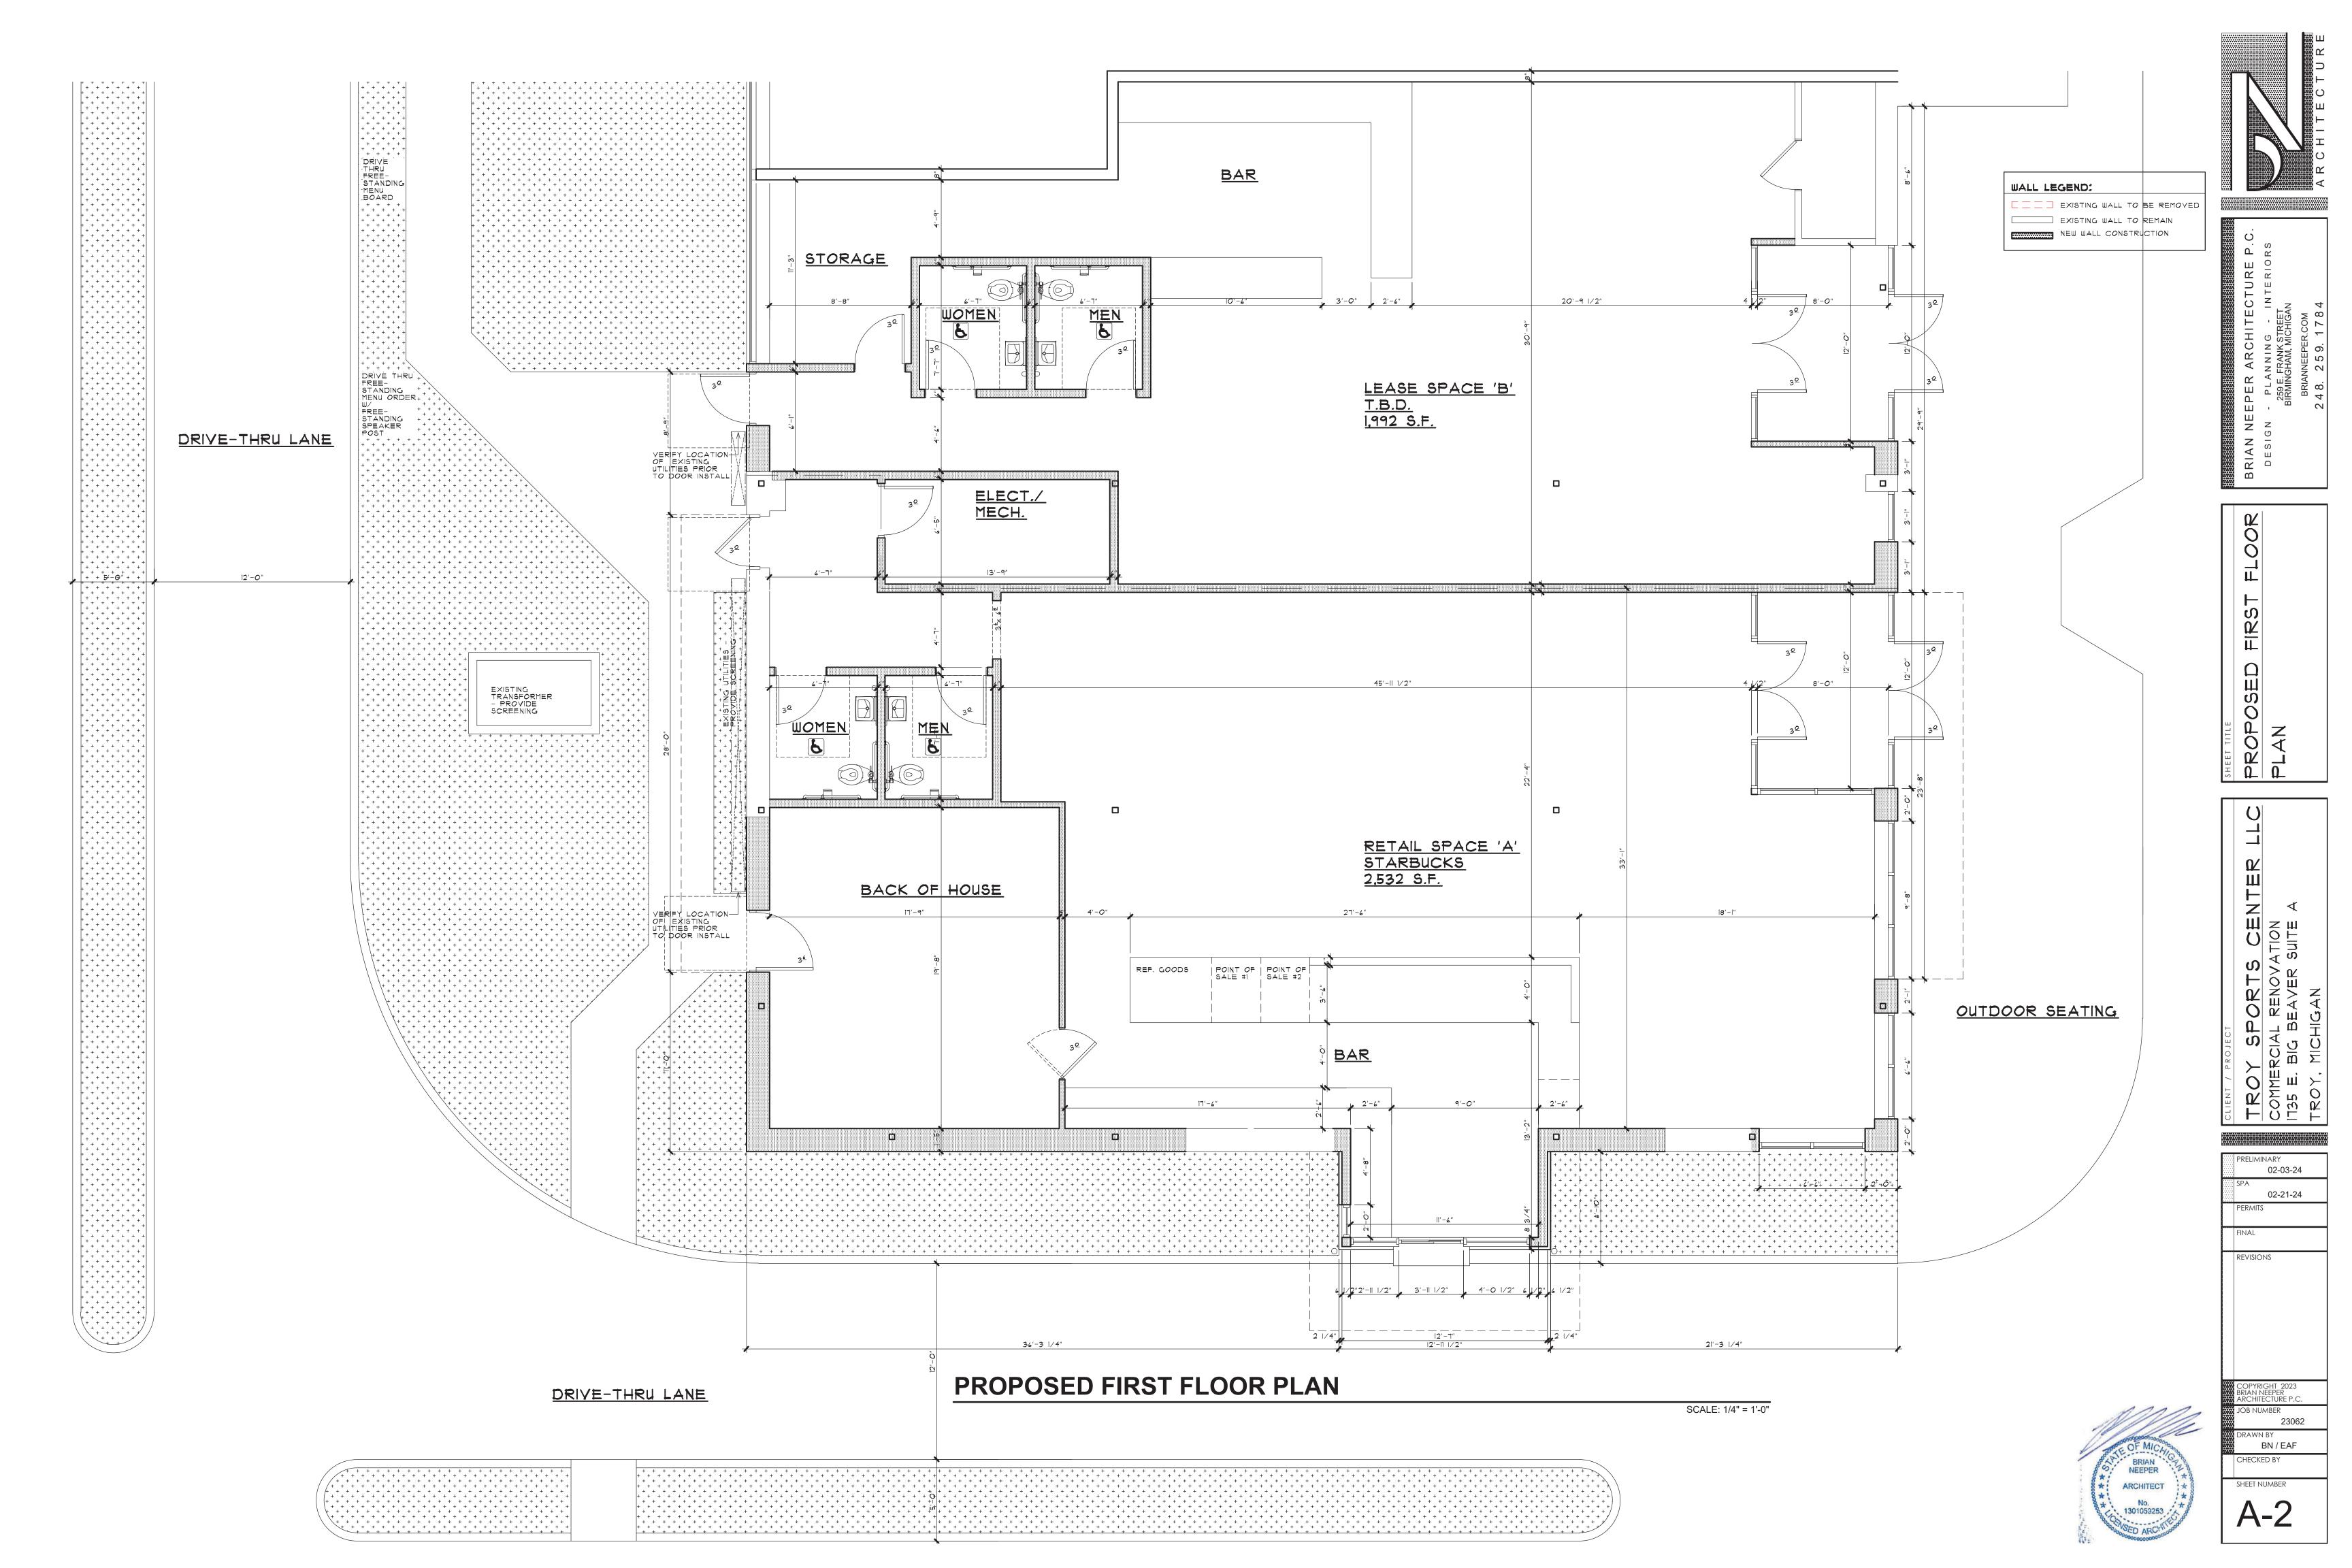

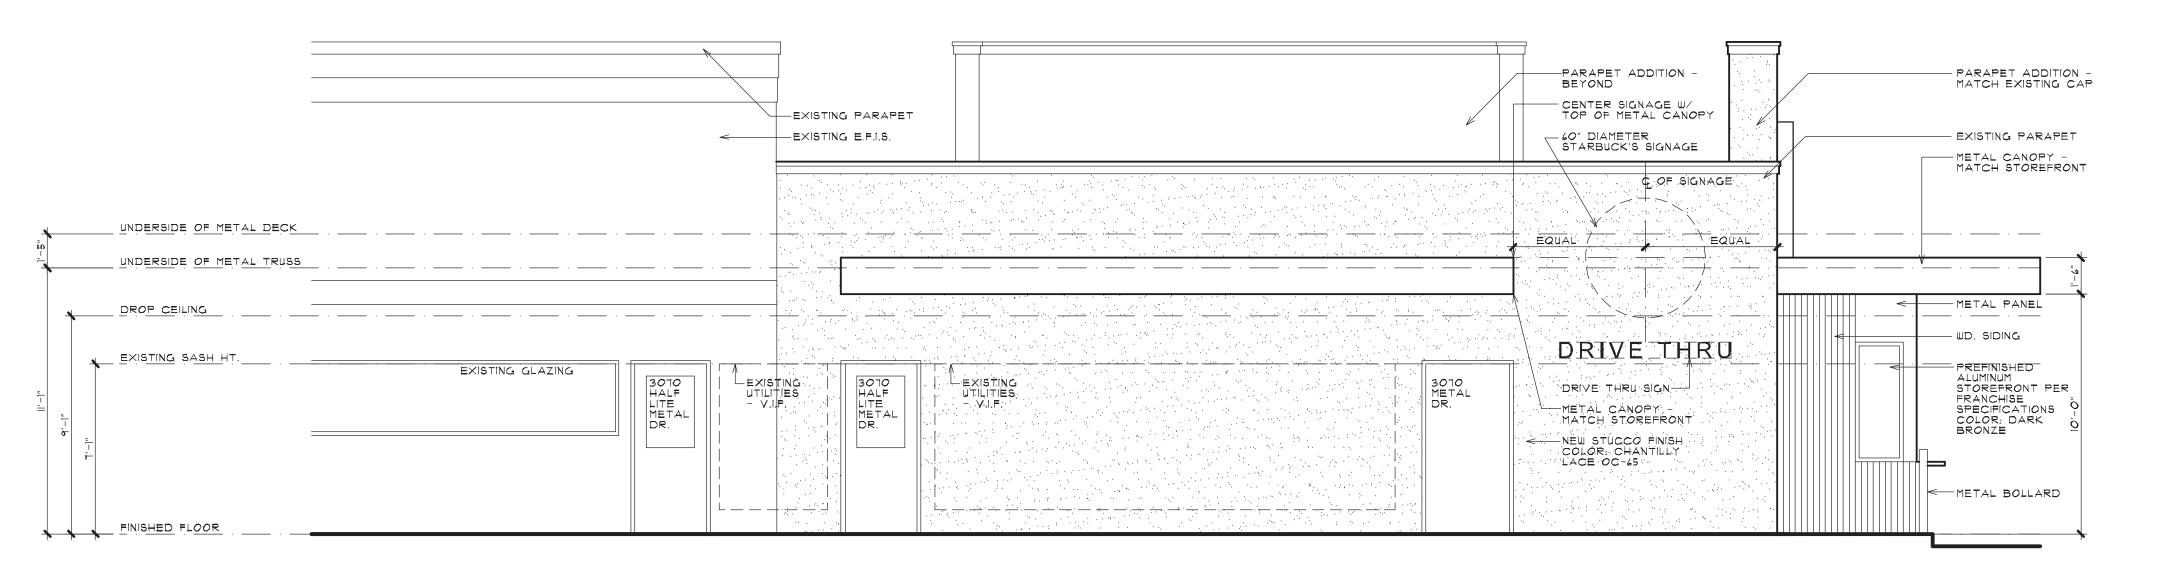


REAR ELEVATION

SCALE: 1/4" = 1'-0"

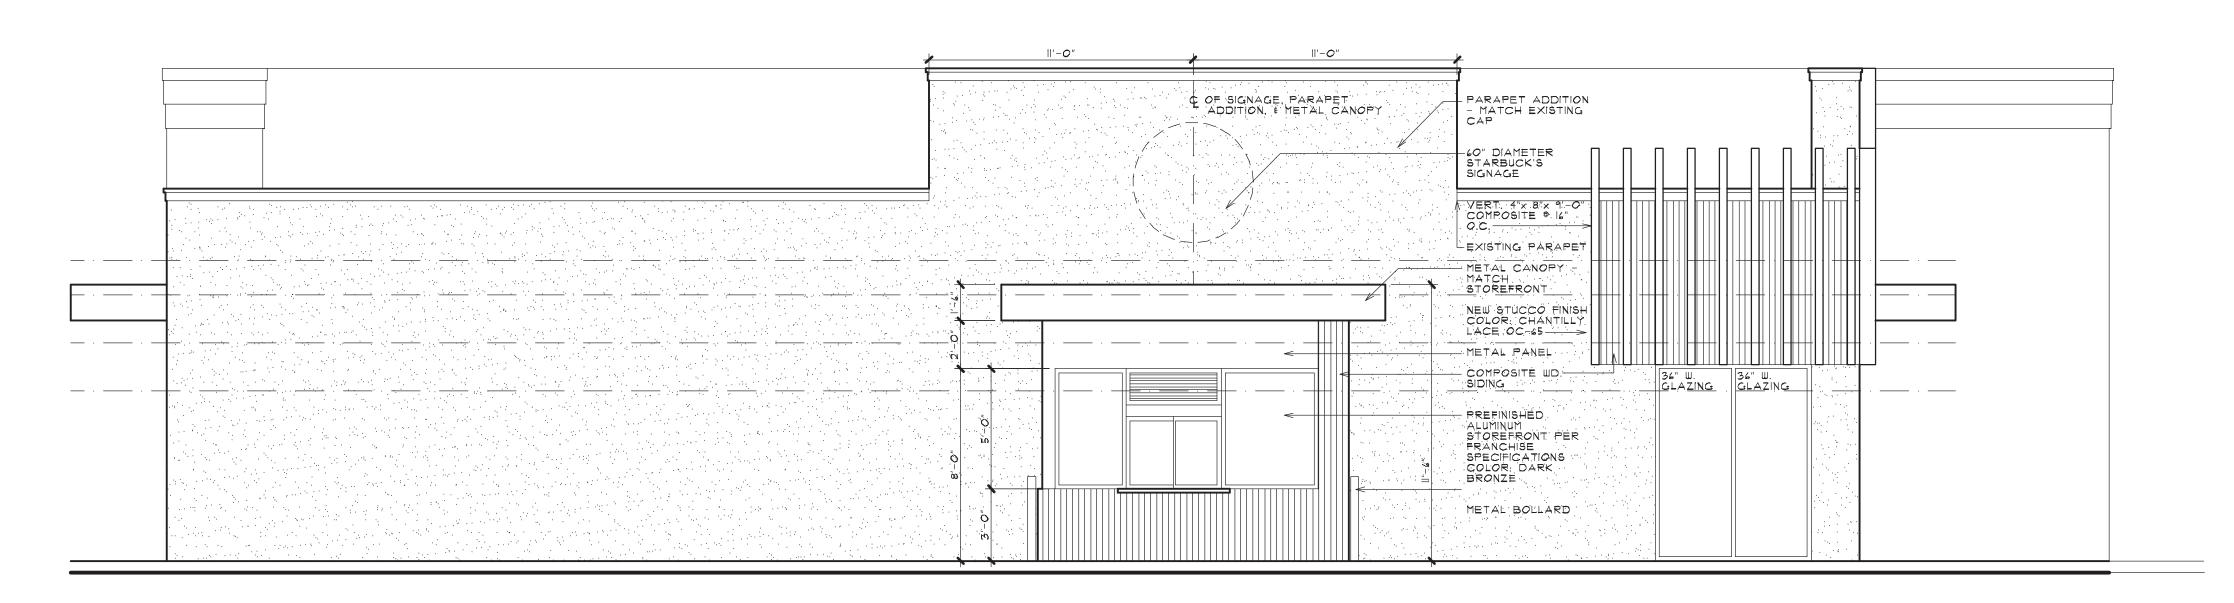


LEFT SIDE ELEVATION

SCALE: 1/4" = 1'-0"

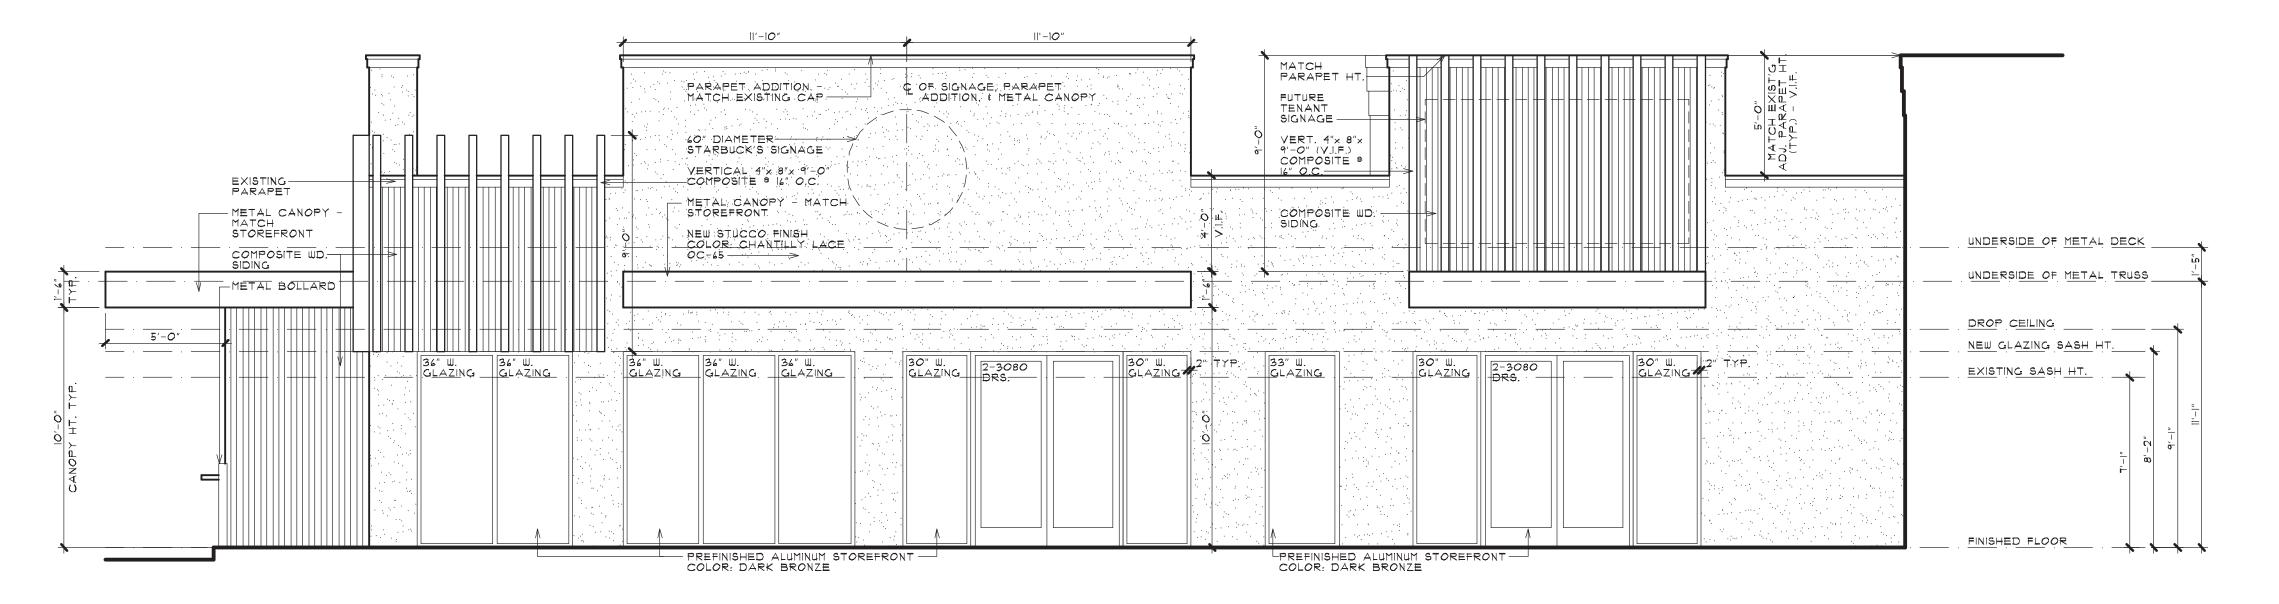

FRONT ELEVATION

SCALE: 1/4" = 1'-0"

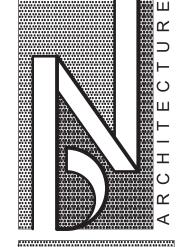

BRIAN NEEPER ARCHITECTURE P.C.

DESIGN - PLANNING - INTERIORS
259E. FRANK STREET
BIRMINGHAM, MICHIGAN
BRIANNEEPER.COM

PROPOSED ELEVATIONS

TROY SPORTS CENTER LI COMMERCIAL RENOVATION 1135 E. BIG BEAVER SUITE A TROY, MICHIGAN

PRELIMINARY
02-03-24

SPA
02-21-24

PERMITS

FINAL

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BRIAN NEEPER
ARCHITECTURE P.C.

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BRIAN NEEPER
ARCHITECTURE P.C.

JOB NUMBER


23062

DRAWN BY
BN / EAF

CHECKED BY

SHEET NUMBER

ARCHITECT

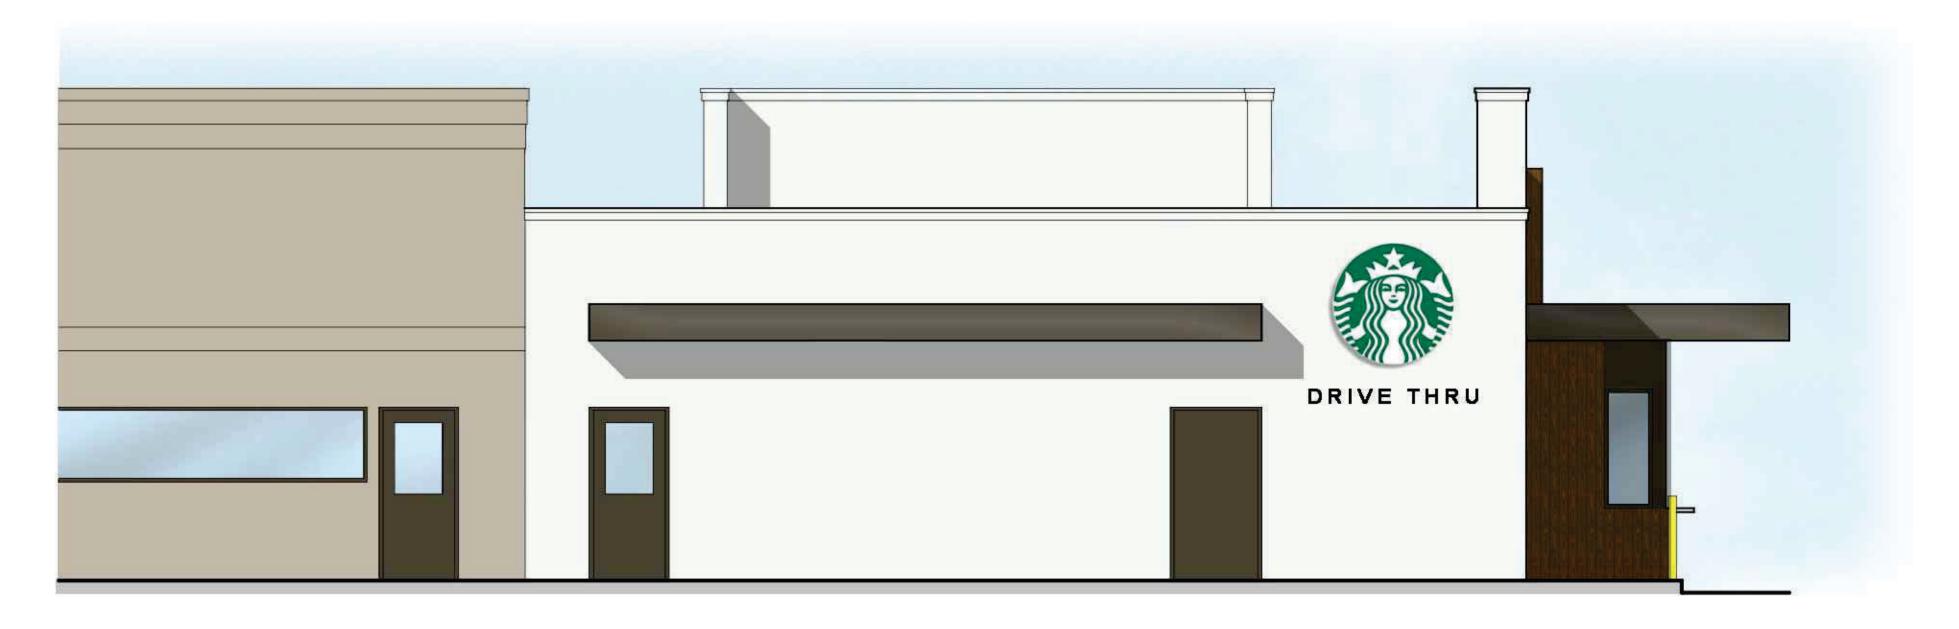

REAR ELEVATION




LEFT SIDE ELEVATION



FRONT ELEVATION

CALE: 1/4" = 1'-0"

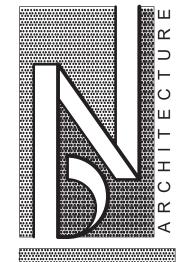

BRIAN NEEPER ARCHITECTURE P.C.

DESIGN - PLANNING - INTERIORS
259 E. FRANK STREET
BIRMINGHAM, MICHIGAN
BRIANNEEPER.COM

MINUTATIO TITIVA IIONS

TROY SPORTS CENTER LI
COMMERCIAL RENOVATION
1135 E. BIG BEAVER SUITE A
TROY MICHIGAN

PRELIMINARY

PRELIMINARY 02-03-24

SPA 02-21-24

INAL

REVISIONS

REVISIONS

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ARCHITECTURE P.C.

JOB NUMBER
23062

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JOB NUMBER
23062

DRAWN BY
BN / EAF

CHECKED BY

A-4

6. PRELIMINARY SITE PLAN APPROVAL (JPLN2023-0028) — Proposed John R Commons Townhome Development, West side of John R, North of Big Beaver (PIN 88-20-23-476-017), Section 23, Zoned MF (Multi-Family Residential) Zoning District

DATE: July 12, 2024

TO: Planning Commission

FROM: R. Brent Savidant, Community Development Director

SUBJECT: PRELIMINARY SITE PLAN APPROVAL (JPLN2023-0028) - Proposed John R

Commons Townhome Development, West side of John R, North of Big Beaver (PIN 88-20-23-476-017), Section 23, Zoned MF (Multi-Family Residential) Zoning District.

The petitioner Troy Sports Center, LLC. submitted the above referenced Preliminary Site Plan application for a 118-unit townhome development. The property is currently zoned MF (Multi-Family) Zoning District. Two-story attached residential units are permitted by right in the MF district. The Planning Commission is responsible for granting Preliminary Site Plan approval for this item.

The Planning Commission considered this item on May 14, 2024 and postponed the item so the applicant could provide a circulation plan and re-evaluate architectural design. On June 25, 2024 the Planning Commission discussed a Circulation Plan for this project, including the proposed Starbucks drive-through to the south.

The attached report prepared by Carlisle/Wortman Associates, Inc. (CWA), the City's Planning Consultant, summarizes the project. CWA prepared the report with input from various City departments including Planning, Engineering, Public Works and Fire. City Management supports the findings of fact contained in the report and the recommendations included therein.

Attachments:

- 1. Maps
- 2. Minutes from May 14, 2024 Planning Commission Regular meeting (excerpt).
- 3. Minutes from June 25, 2024 Planning Commission Regular meeting (excerpt).
- 4. Report prepared by Carlisle/Wortman Associates, Inc.
- 5. Preliminary site plan

G:\SITE PLANS\SP JPLN2023-0028 JOHN R COMMONS TOWNHOME DEVELOPMENT\PC Memo 2024 07 23.docx

PROPOSED RESOLUTION

PRELIMINARY SITE PLAN APPROVAL (JPLN2023-0028) — Proposed John R Gardens Townhome Development, East side of John R, north of Big Beaver (PIN 88-20-23-476-017), Section 23, Zoned MF (Multi-Family Residential) Zoning District.

Resolution	# PC-	2024-	07-
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Moved by: Seconded by:

RESOLVED, That Preliminary Site Plan Approval, pursuant to Article 8 of the Zoning Ordinance, as requested for the proposed John R Gardens Townhome Development, located on the East side of John R, North of Big Beaver, Section 23, Zoned MF (Multi-Family Residential) District, be granted, subject to applicant the following:

) or
(denied, for the following reasons:) or
(postponed, for the following reasons:)
Yes: No:	

MOTION CARRIED/FAILED



GIS Online




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TROY

1,153

GIS Online

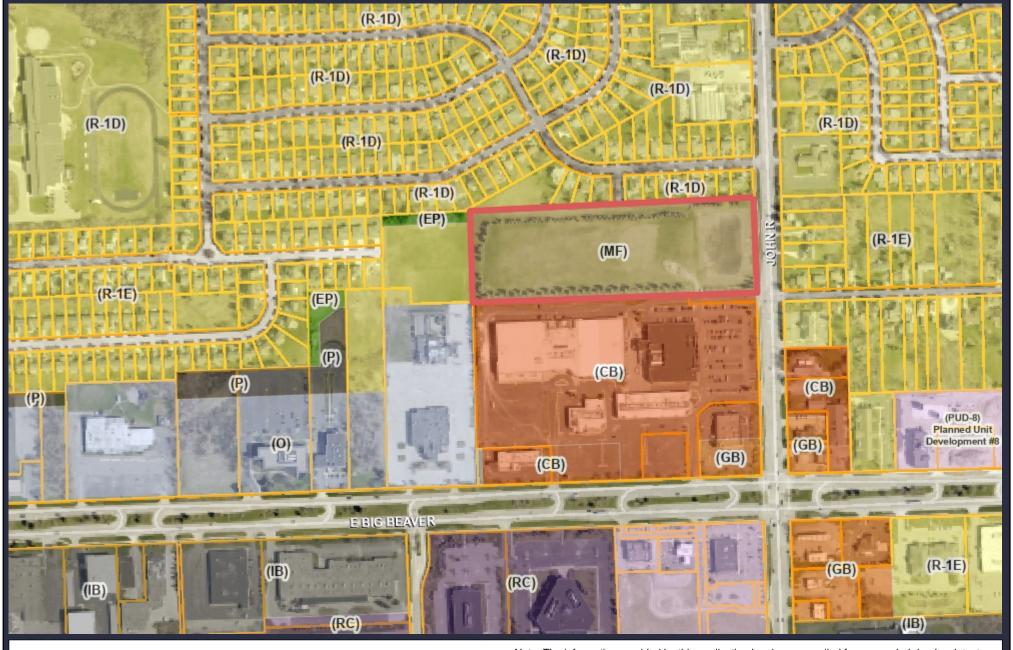

1,153Feet

577

Note: The information provided by this application has been compiled from recorded deeds, plats, tax maps, surveys, and other public records and data. It is not a legally recorded map survey. Users of this data are hereby notified that the source information represented should be consulted for verification.

Chair Perakis called the Regular meeting of the Troy City Planning Commission to order at 7:02pm on May 14, 2024, in the Council Chamber of the Troy City Hall. Chair Perakis presented opening remarks relative to the role of the Planning Commission and procedure of tonight's meeting.

1. ROLL CALL

Present:

Toby Buechner
Carlton M. Faison
Tyler Fox
Michael W. Hutson
Tom Krent
David Lambert
Marianna Perakis

Absent:

Lakshmi Malalahalli

Also Present:

John J. Tagle

R. Brent Savidant, Community Development Director Ben Carlisle, Carlisle Wortman Associates Allan Motzny, Assistant City Attorney Jackie Ferencz, Planning Department staff

2. APPROVAL OF AGENDA

Resolution # PC-2024-05-22

Moved by: Fox Support by: Tagle

RESOLVED, To approve agenda as prepared.

Yes: All present (8)
Absent: Lakshmi Malalahalli

MOTION CARRIED

3. APPROVAL OF MINUTES – April 23, 2024

Resolution # PC-2024-05-23

Moved by: Lambert Support by: Buechner

RESOLVED, To approve the minutes of April 23, 2024 Regular meeting as submitted.

Yes: All present (8)
Absent: Lakshmi Malalahalli

MOTION CARRIED

PRELIMINARY SITE PLAN APPROVAL

7. PRELIMINARY SITE PLAN APPROVAL (JPLN2023-0028) — Proposed John R Commons Townhome Development, West side of John R, North of Big Beaver (PIN 88-20-23-476-017), Section 23, Zoned MF (Multi-Family Residential) Zoning District.

Mr. Carlisle presented on Proposed John R Commons Townhome Development project

Applicants Greg Bono, PEA Group; Dennis Bostick, Troy Sports Center LLC; Greg Neeper, Brian Neeper Architecture, spoke on application.

Chair Perakis opened Public Comment

Chair Perakis closed Public Comment

Planning Commission Discussion

RESOLVED, That Preliminary Site Plan Approval, pursuant to Article 8 of the Zoning Ordinance, as requested for the proposed John R Gardens Townhome Development, located on the East side of John R, North of Big Beaver, Section 23, Zoned MF (Multi-Family Residential) District, be postponed for the following reasons:

Applicant to revisit:

- a circulation plan
- re-evaluate architectural design

Resolution # PC-2024-05-26

Moved by: Fox Seconded by: Tagle

Yes: All (8)

Absent: Lakshmi Malalahalli

MOTION CARRIED

OTHER ITEMS

- 8. PUBLIC COMMENT For Items on the Agenda
- 9. PLANNING COMMISSION COMMENT
- 10. ADJOURN

The Regular meeting of the Planning Commission adjourned at 9:22 p.m.

Respectfully submitted,

Marianna J. Perakis, Chair

Jackie Ferencz, Planning Department Staff

G:\PLANNING COMMISSION MINUTES\2024 PC MINUTES\DRAFT\2024 05 14 FINAL.docx

Chair Perakis called the Regular meeting of the Troy City Planning Commission to order at 7:00 p.m. on June 25, 2024, in the Council Chamber of the Troy City Hall. Chair Perakis and Vice Chair Malalahalli presented opening remarks relative to the role of the Planning Commission and procedure of tonight's meeting.

1. ROLL CALL

Present:

Toby Buechner
Carlton M. Faison
Michael W. Hutson
Tom Krent
David Lambert
Lakshmi Malalahalli
Marianna Perakis
John J. Tagle

Absent:

Tyler Fox

Also Present:

Ben Carlisle, Carlisle Wortman & Associates R. Brent Savidant, Community Development Director Salim Huerta Jr., Commercial Project Collaborator Julie Quinlan Dufrane, Assistant City Attorney Kathy L. Czarnecki, Recording Secretary

2. APPROVAL OF AGENDA

Resolution # PC-2024-06-036

Moved by: Faison Support by: Buechner

RESOLVED, To approve the agenda as prepared.

Yes: All present (8)

Absent: Fox

MOTION CARRIED

3. APPROVAL OF MINUTES – June 11, 2024

Resolution # PC-2024-06-037

Moved by: Buechner Support by: Lambert

RESOLVED, To approve the minutes of June 11, 2024 Regular meeting as submitted.

Discussion on the motion on the floor.

Mr. Lambert said he is pleased that a cricket field, a much-desired recreational amenity for the City and its nearby communities, is moving forward.

Vote on the motion on the floor.

Yes: All present (8)

Absent: Fox

MOTION CARRIED

6. <u>CIRCULATION PLAN DISCUSSION</u> – Proposed John R Commons Townhome Development (JPLN2023-0028) and Starbucks with Drive-through (JPLN2021-024), West of John R, North of Big Beaver, Section 23

Mr. Savidant briefly introduced the proposed townhome development and Starbucks application that the Planning Commission considered at their May 14, 2024 meeting. He stated the circulation plan is for discussion only and the Planning Commission would take no action this evening.

Present were James Butler of PEA Group and City Traffic Consultant Stephen Dearing of OHM Advisors.

Mr. Butler reviewed the reconfiguration of the traffic circulation plan to maneuver traffic to the southwest corner where the Starbucks drive-through is proposed.

Mr. Dearing said the circulation plan is a significant improvement, one that makes the best of an existing circulation configuration that has evolved over time. He recommended approval of the proposed circulation plan.

There was discussion on:

- Bumped out island; extend one parking space.
- Closing off nearest, southern-most drive aisle (north/south) to drive-through.
- Location of trash dumpster.
- Overall landscaping, center aisles, parking lot trees.
- Provide pedestrian pathway on west side.
- Construction/traffic pattern challenges with existing power line.
- Turning curve at beginning of Starbucks drive-through.
- Overall circulation to accommodate existing retail and ice arena.
- Resurfacing existing parking lot to the north.
- Signage to direct traffic to Starbucks drive-through and Big Beaver exit.

Discussion points for consideration by applicant.

- Push "bumped out island" further (one parking space).
- Signage to direct traffic to drive-through and Big Beaver exit.
- Delineation (via landscaping) of Starbucks from ice arena/retail area.
- Provide striped pedestrian crossing within drive-through aisle.
- Consideration of closing off nearest, southern-most drive aisle (north/south) to drive-through.
- Consideration to eliminate three-way traffic pattern(s) for public safety.
- Provide pedestrian pathway on west side.

Chair Perakis cited Zoning Ordinance Article 14.01, C.4 and C.5, Non-Conforming Lots, Uses and Structures.

OTHER ITEMS

7. <u>PUBLIC COMMENT</u> – For Items on the Agenda

There was no one present who wished to speak.

8. PLANNING COMMISSION COMMENT

There were general Planning Commission comments.

9. ADJOURN

The Regular meeting of the Planning Commission adjourned at 8:34 p.m.

Respectfully submitted,	
Marianna J. Perakis, Chair	
Kathy L. Czarnecki, Recording Secretary G:\PLANNING COMMISSION MINUTES\2024 PC MINUTES\FINAL\2024 06 25 FINAL\2024 06 25 FIN	



117 NORTH FIRST STREET SUITE 70 ANN ARBOR, MI 48104 734.662.2200 734.662.1935 FAX

To: Troy Planning Commission

From: Ben Carlisle, AICP

Date: July 15, 2024

RE: NW Corner of Big Beaver and John R. (Troy Commons)

At the May 14, 2024 meeting, the Planning Commission reviewed a proposed Starbucks and a new multiple family development (John R. Commons). Both developments are under the same ownership and located at the NW corner of Big Beaver and John R.

John R. Townhomes was continued for the following reasons:

1. Troy Sports Center Circulation Improvements

The applicant has proposed to make onsite circulation improvements to the Troy Sports Center parking lot. These improvements include:

- Reconfigured access to the Starbucks drive-through; and
- Added a cut-through through the west side of the main drive-aisle of the Troy Sports Center parking lot.

A detailed review of the site circulation plan is provided by OHM. The Planning Commission discussed the site circulation at their June 25th meeting.

 Reevaluate Architectural Design. The applicant has a revised architectural design. For Building A, the applicant has added some additional windows and roof elements. For Building B, the applicant has changed the color scheme, and added larger windows.

I look forward to meeting with you all at your July 23, 2024 meeting.

NW Corner of Big Beaver and John R. (Starbucks) July 15, 2024

Sincerely,

CARLISLE/WORTMAN ASSOC., INC. Benjamin R. Carlisle, AICP, LEED AP President

CARLISLE/WORTMAN ASSOC., INC. Shana Kot Community Planner

CITY OF TROY PRELIMINARY SITE PLAN APPLICATION

CITY OF TROY PLANNING DEPARTMENT 500 W. BIG BEAVER TROY, MICHIGAN 48084 248-524-3364

FAX: 248-524-3382

E-MAIL: planning @ troymi.gov



PRELIMINARY SITE PLAN REVIEW FEE

\$1,500.00 /

ADMINISTRATIVE SITE PLAN REVIEW FEE \$300.00

SITE PLAN RENEWAL (BEFORE EXPIRATION) \$500.00

FINAL SITE PLAN REVIEW \$100.00


REGULAR MEETINGS OF THE CITY PLANNING COMMISSION ARE HELD ON THE SECOND AND FOURTH TUESDAYS OF EACH MONTH AT 7:00 P.M. AT CITY HALL.

PLEASE FILE A COMPLETE PRELIMINARY SITE PLAN APPLICATION THAN THIRTY (30) DAYS PRIOR TO THE DATE OF THAT MEETING	TION, TOGETHER WITH THE APPROPRIATE FEE, NOT LESS G.
1. NAME OF THE PROPOSED DEVELOPMENT:	Commons Townhome Development
2. ADDRESS OF THE SUBJECT PROPERTY: none - vaca	
3. ZONING CLASSIFICATION OF THE SUBJECT PROPERTY	
4. TAX IDENTIFICATION NUMBER(S) OF SUBJECT PROPER	
5. DESCRIPTION OF PROPOSED USE: _Multi-Family Res	
6. APPLICANT· NAME Dennis Bostick	PROPERTY OWNER- NAME Dennis Bostick
COMPANY Troy Sports Center, LLC ADDRESS 1819 East Big Beaver Rd.	COMPANY Troy Sports Center, LLCADDRESS 1819 East Big Beaver Rd.
CITY <u>Troy</u> STATE <u>MI</u> ZIF' <u>48083</u> TELEPHONE <u>(248)</u> 709 - 4001	CITY <u>Troy</u> STATE <u>MI ZIP 48083</u> TELEPHONE (248) 709 - 4001
E-MAIL dennisbostick@att.net	E-MAIL_dennisbostick@att.net
7. THE APPLICANT BEARS THE FOLLOWING RELATIONSHI same	IP TO THE OWNER OF THE SUBJECT PROPERTY:
B. SIGNATURE OF APPLICANT	30-16 DATE 8-18-23
SIGNATURE OF PROPERTY OWNER	DATE 8-18-23

BY THIS SIGNATURE, THE PROPERTY OWNER AUTHORIZES PLACEMENT OF A SIGN ON THE PROPERTY TO INFORM THE PUBLIC AS TO THIS REQUEST FOR PRELIMINIARY SITE PLAN.

JOHN R COMMONS TOWNHOME DEVELOPMENT

PART OF THE SOUTHEAST 1/4
OF SECTION 23, T.2N, R.11E
CITY OF TROY, OAKLAND COUNTY, MICHIGAN

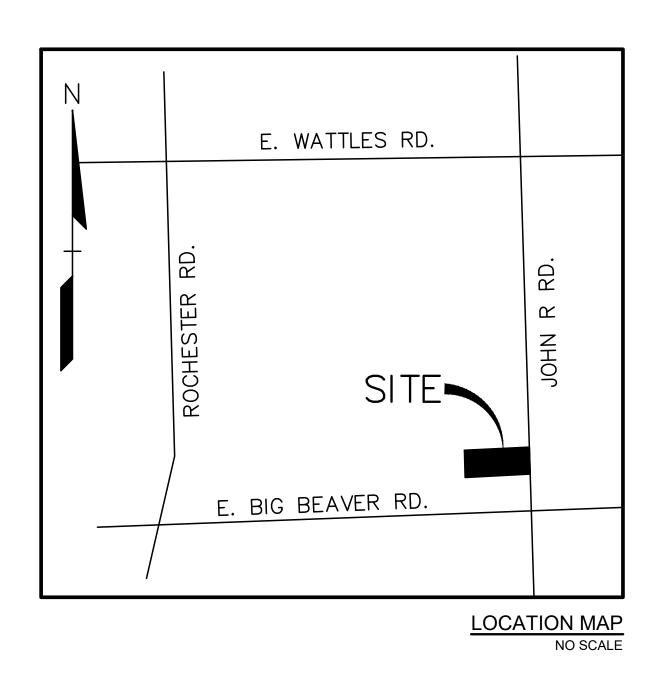

DESIGN TEAM

OWNER/APPLICANT/DEVELOPER

TROY SPORTS CENTER, LLC & JSD REAL ESTATE, LLC 1819 EAST BIG BEAVER ROAD TROY, MI 48083
CONTACT: DENNIS BOSTICK PHONE: 248.709.4001
EMAIL: DENNISBOSTICK@ATT.NET

ARCHITECT

BRIAN NEEPER ARCHITECTURE P.C. 630 N. OLD WOODWARD SUITE 203 BIRMINGHAM, MI 48009 CONTACT: BRIAN NEEPER PHONE: 248.259.1784

CIVIL ENGINEER

PEA GROUP 1849 POND RUN AUBURN HILLS, MI 48326 CONTACT: GREG BONO, PE PHONE: 844.813.2949 EMAIL: GBONO@PEAGROUP.COM

LANDSCAPE ARCHITECT

PEA GROUP 7927 NEMCO WAY, STE. 115 BRIGHTON, MI 48116 CONTACT: JEFF SMITH, PLA, LEED AP PHONE: 844.813.2949 EMAIL: JSMITH@PEAGROUP.COM

NUMBER	TITLE
C-0.0	COVER SHEET
C-1.1	TOPOGRAPHIC SURVEY
C-1.2	TOPOGRAPHIC SURVEY
C-2.0	OVERALL SITE PLAN
C-2.1	PRELIMINARY SITE PLAN
C-2.2	PRELIMINARY SITE PLAN
C-3.1	PRELIMINARY GRADING PLAN
C-3.2	PRELIMINARY GRADING PLAN
C-4.1	PRELIMINARY UTILITY PLAN
C-4.2	PRELIMINARY UTILITY PLAN
C-5.0	NOTES AND DETAILS
L-1.0	OVERALL LANDSCAPE PLAN
L-1.1	PRELIMINARY LANDSCAPE PLAN - WEST
L-1.2	PRELIMINARY LANDSCAPE PLAN - EAST
L-1.3	LANDSCAPE DETAILS
L-1.4	SITE AMENITY DETAILS
T-1.0	TREE SURVEY PLAN - WEST
T-1.1	TREE SURVEY PLAN - EAST
T-1.2	EXISTING TREE LIST
SL-1.0	LIGHTING PLAN
T-1A	TITLE SHEET
A-1A	BUILDING FOUNDATION PLAN - 5 UNIT
A-2A	BUILDING FIRST & SECOND FLOOR PLANS - 5 UNIT
A-3A	BUILDING ROOF PLAN - 5 UNIT
A-4A	BUILDING FOUNDATION PLAN - 6 UNIT
A-5A	BUILDING FIRST & SECOND FLOOR PLAN - 6 UNIT
A-6A	BUILDING ROOF PLAN - 6 UNIT
A-7A	BUILDING ELEVATIONS - 5 UNIT
A-8A	BUILDING ELEVATIONS - 6 UNIT
A-9A	DWELLING UNIT PLANS
A-10A	UNIT ELEVATIONS
A-11A	BUILDING SECTION & EXTERIOR WALL SECTIONS
A-12A	INTERIOR WALL SECTIONS
A-13A	RENDERED FRONT ELEVATION
T-1	TITLE SHEET
A-1B	BUILDING FOUNDATION PLAN - 6 UNIT
A-2B	BUILDING FIRST & SECOND FLOOR PLANS - 6 UNIT
A-3B	BUILDING ROOF PLAN - 6 UNIT
A-4B	BUILDING ELEVATIONS - 6 UNIT
A-5B	DWELLING UNIT PLANS
A-0D	
A-6B	UNIT ELEVATIONS
	BUILDING SECTION & EXTERIOR WALL SECTIONS
A-6B	

INDEX OF DRAWINGS


R	EVISIONS
DESCRIPTION	DATE
ORIGINAL ISSUE DATE	8/18/2023
SPA COMMENTS	11/8/2023
SPA COMMENTS	3/1/2024
SPA/PC COMMENTS	5/3/2024
SPA/PC COMMENTS	7/12/2024









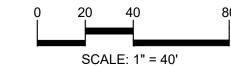



CAUTION!!

THE LOCATIONS AND ELEVATIONS OF EXISTING UNDERGROUND UTILITIES AS SHOWN ON THIS DRAWING ARE ONLY APPROXIMATE. NO GUARANTEE IS EITHER EXPRESSED OR IMPLIED AS TO THE COMPLETENESS OR ACCURACY THEREOF. THE CONTRACTOR SHALL BE EXCLUSIVELY RESPONSIBLE FOR DETERMINING THE EXACT UTILITY LOCATIONS AND ELEVATIONS PRIOR TO THE START OF CONSTRUCTION.

CLIENT

TROY SPORTS CENTER, LLC 1819 EAST BIG BEAVER ROAD

LEGAL DESCRIPTION (20-23-476-015)
(Per City of Troy Assessing)

T2N, R11E, SEC 23 LASIER GARDENS SUB LOTS 1, 2 & 3 EXC E 7 FT TAKEN FOR JOHN R RD, ALSO N 96 FT OF LOT 4 EXC E 7 FT TAKEN FOR JOHN R RD, ALSO N 96 FT OF LOT 7, ALSO LOTS 8 TO 34 INCL EXC S 49 FT OF LOTS 15, 16, 25 & 26 TAKEN FOR BIG BEAVER RD, ALSO EXC PART OF LOTS 2, 9, 12 & VAC MANHATTAN AVE DESC AS BEG AT PT DIST N 00-15-00 E 102 FT & S 89-48-40 W 60 FT & N 00-15-00 E 766.33 FT FROM SE SEC COR, TH N 00-15-00 E 40 FT, TH S 89-48-00 W 300 FT, TH S 00-15-00 W 40 FT, TH N 89-48-40 E 300 FT TO BEG, ALSO LOTS 37 TO 40 INCL, ALSO ALL OF VAC MANHATTAN, ALGER, BRONX, BELLINGHAM & WALFORD AVES ADJ TO SAME EXC E 27 FT OF VAC MANHATTAN AVE ADJ TO LOT 6, ALSO EXC E 27 FT OF VAC MANHATTAN AVE ADJ TO LOT 7 EXC N 96 FT, ALSO EXC W 1/2 OF VAC BRONX AVE ADJ TO LOT 35, ALSO EXC E 7 FT OF VAC WALFORD AVE, ALSO PART OF LOT 4, PART OF LOT 7 & PART OF VAC MANHATTAN AVE DESC AS BEG AT PT DIST N 00-15-00 E 102 FT & S 89-48-00 W 329.14 FT FROM SE SEC COR, TH S 89-48-40 W 2.86 FT, TH N 00-15-00 E 330 FT, TH N 89-48-40 E 272 FT, TH S 00-15-00 W 4.30 FT, TH N 89-45-00 W 211.18 FT, TH S 52-13-38 W 73.56 FT, TH S 00-15-00 W 282.45 FT TO BEG

PROJECT TITLE

TOWNHOME DEVELOPMENT
PART OF THE SE 1/4 OF SECTION 23, T.

2N., R. 11E. TROY, OAKLAND COUNTY, MI

COMMONS

BENCHMARKS (GPS DERIVED - NAVD88)

BM #300
ARROW ON HYDRANT WEST SIDE JOHN R ROAD 11' OF B/CURB, AND 95' SOUTH OF NORTH PROPERTY LINE OF SITE.
ELEV. — 648.05

BM #301
MAG NAIL ON NORTH SIDE OF CONCRETE LIGHT POLE BASE 21' SOUTH
OF CENTERLINE NANCY BOSTICK DRIVE, AND 29' EAST OF ENTRANCE TO
KROGER PARKING LOT FROM SAID DRIVE.
ELEV. — 648.13

BM #302
ARROW ON HYDRANT FLANGE 6' NORTH OF B/CURB FOR PARKING
ALONG NANCY BOSTICK DRIVE, AND ±80' WEST OF EAST BUILDING LINE
OF TROY SPORTS COMPLEX.
ELEV. — 647.09

FLOODPLAIN NOTE:

BY GRAPHICAL PLOTTING, SITE IS WITHIN ZONE 'X', AREA DETERMINED TO BE OUTSIDE OF THE 0.2% ANNUAL CHANCE FLOODPLAIN PER FLOOD INSURANCE RATE MAP NUMBER 26125C0553G, DATED JANUARY 16, 2009.


REVISIONS	
SPA COMMENTS	11/8/23
SPA COMMENTS	3/1/24
SPA/PC COMMENTS	5/3/24
SPA/PC COMMENTS	7/12/24

ORIGINAL ISSUE DATE: AUGUST 18, 2023

DRAWING TITLE

TOPOGRAPHIC SURVEY

PEA JOB NO.	18-0034
P.M.	GME
DN.	CNF
DES.	GME
DRAWING NUMBER:	

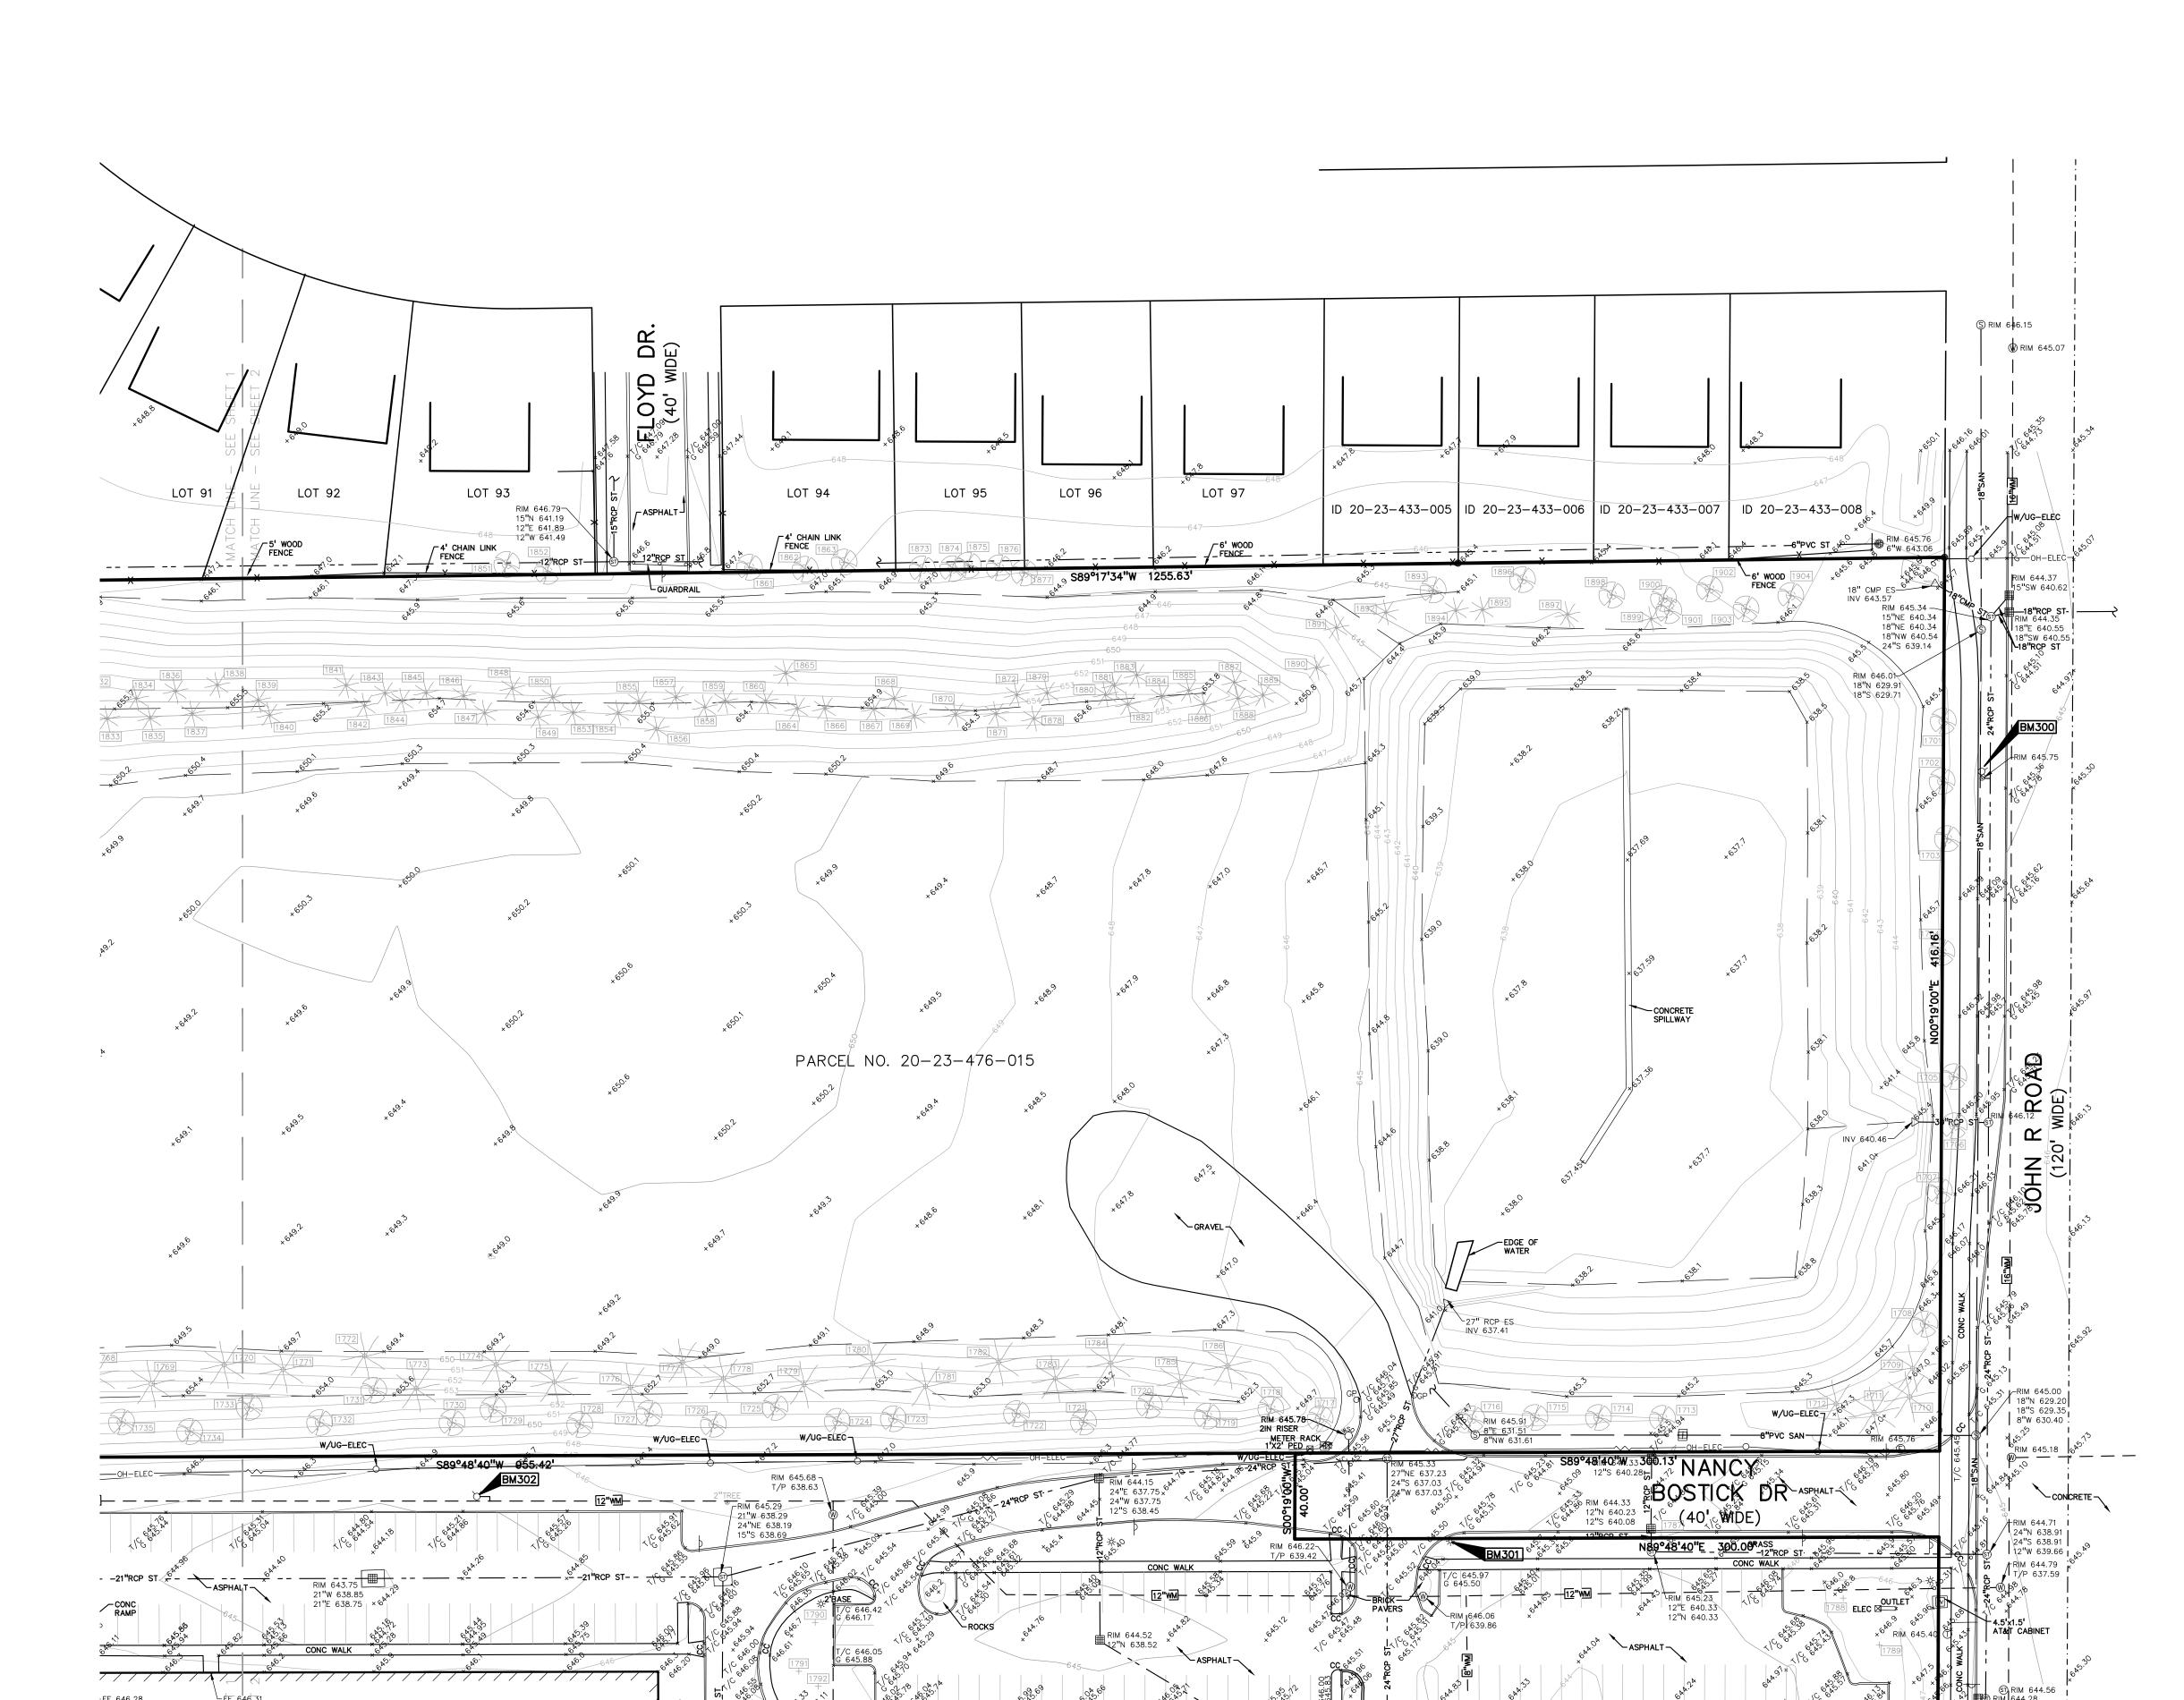

KROGER

RIM 645.23











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PROJECT TITLE

COMMONS **DEVELOPMENT**

PART OF THE SE 1/4 OF SECTION 23, T 2N., R. 11E. TROY, OAKLAND COUNTY, MI

BENCHMARKS (GPS DERIVED - NAVD88)

BM #300
ARROW ON HYDRANT WEST SIDE JOHN R ROAD 11' OF B/CURB, AND 95' SOUTH OF NORTH PROPERTY LINE OF SITE.
ELEV. — 648.05

BM #301 MAG" NAIL ON NORTH SIDE OF CONCRETE LIGHT POLE BASE 21' SOUTH OF CENTERLINE NANCY BOSTICK DRIVE, AND 29' EAST OF ENTRANCE TO KROGER PARKING LOT FROM SAID DRIVE. ELEV. - 648.13

ARROW ON HYDRANT FLANGE 6' NORTH OF B/CURB FOR PARKING ALONG NANCY BOSTICK DRIVE, AND ±80' WEST OF EAST BUILDING LINE OF TROY SPORTS COMPLEX. ELEV. — 647.09

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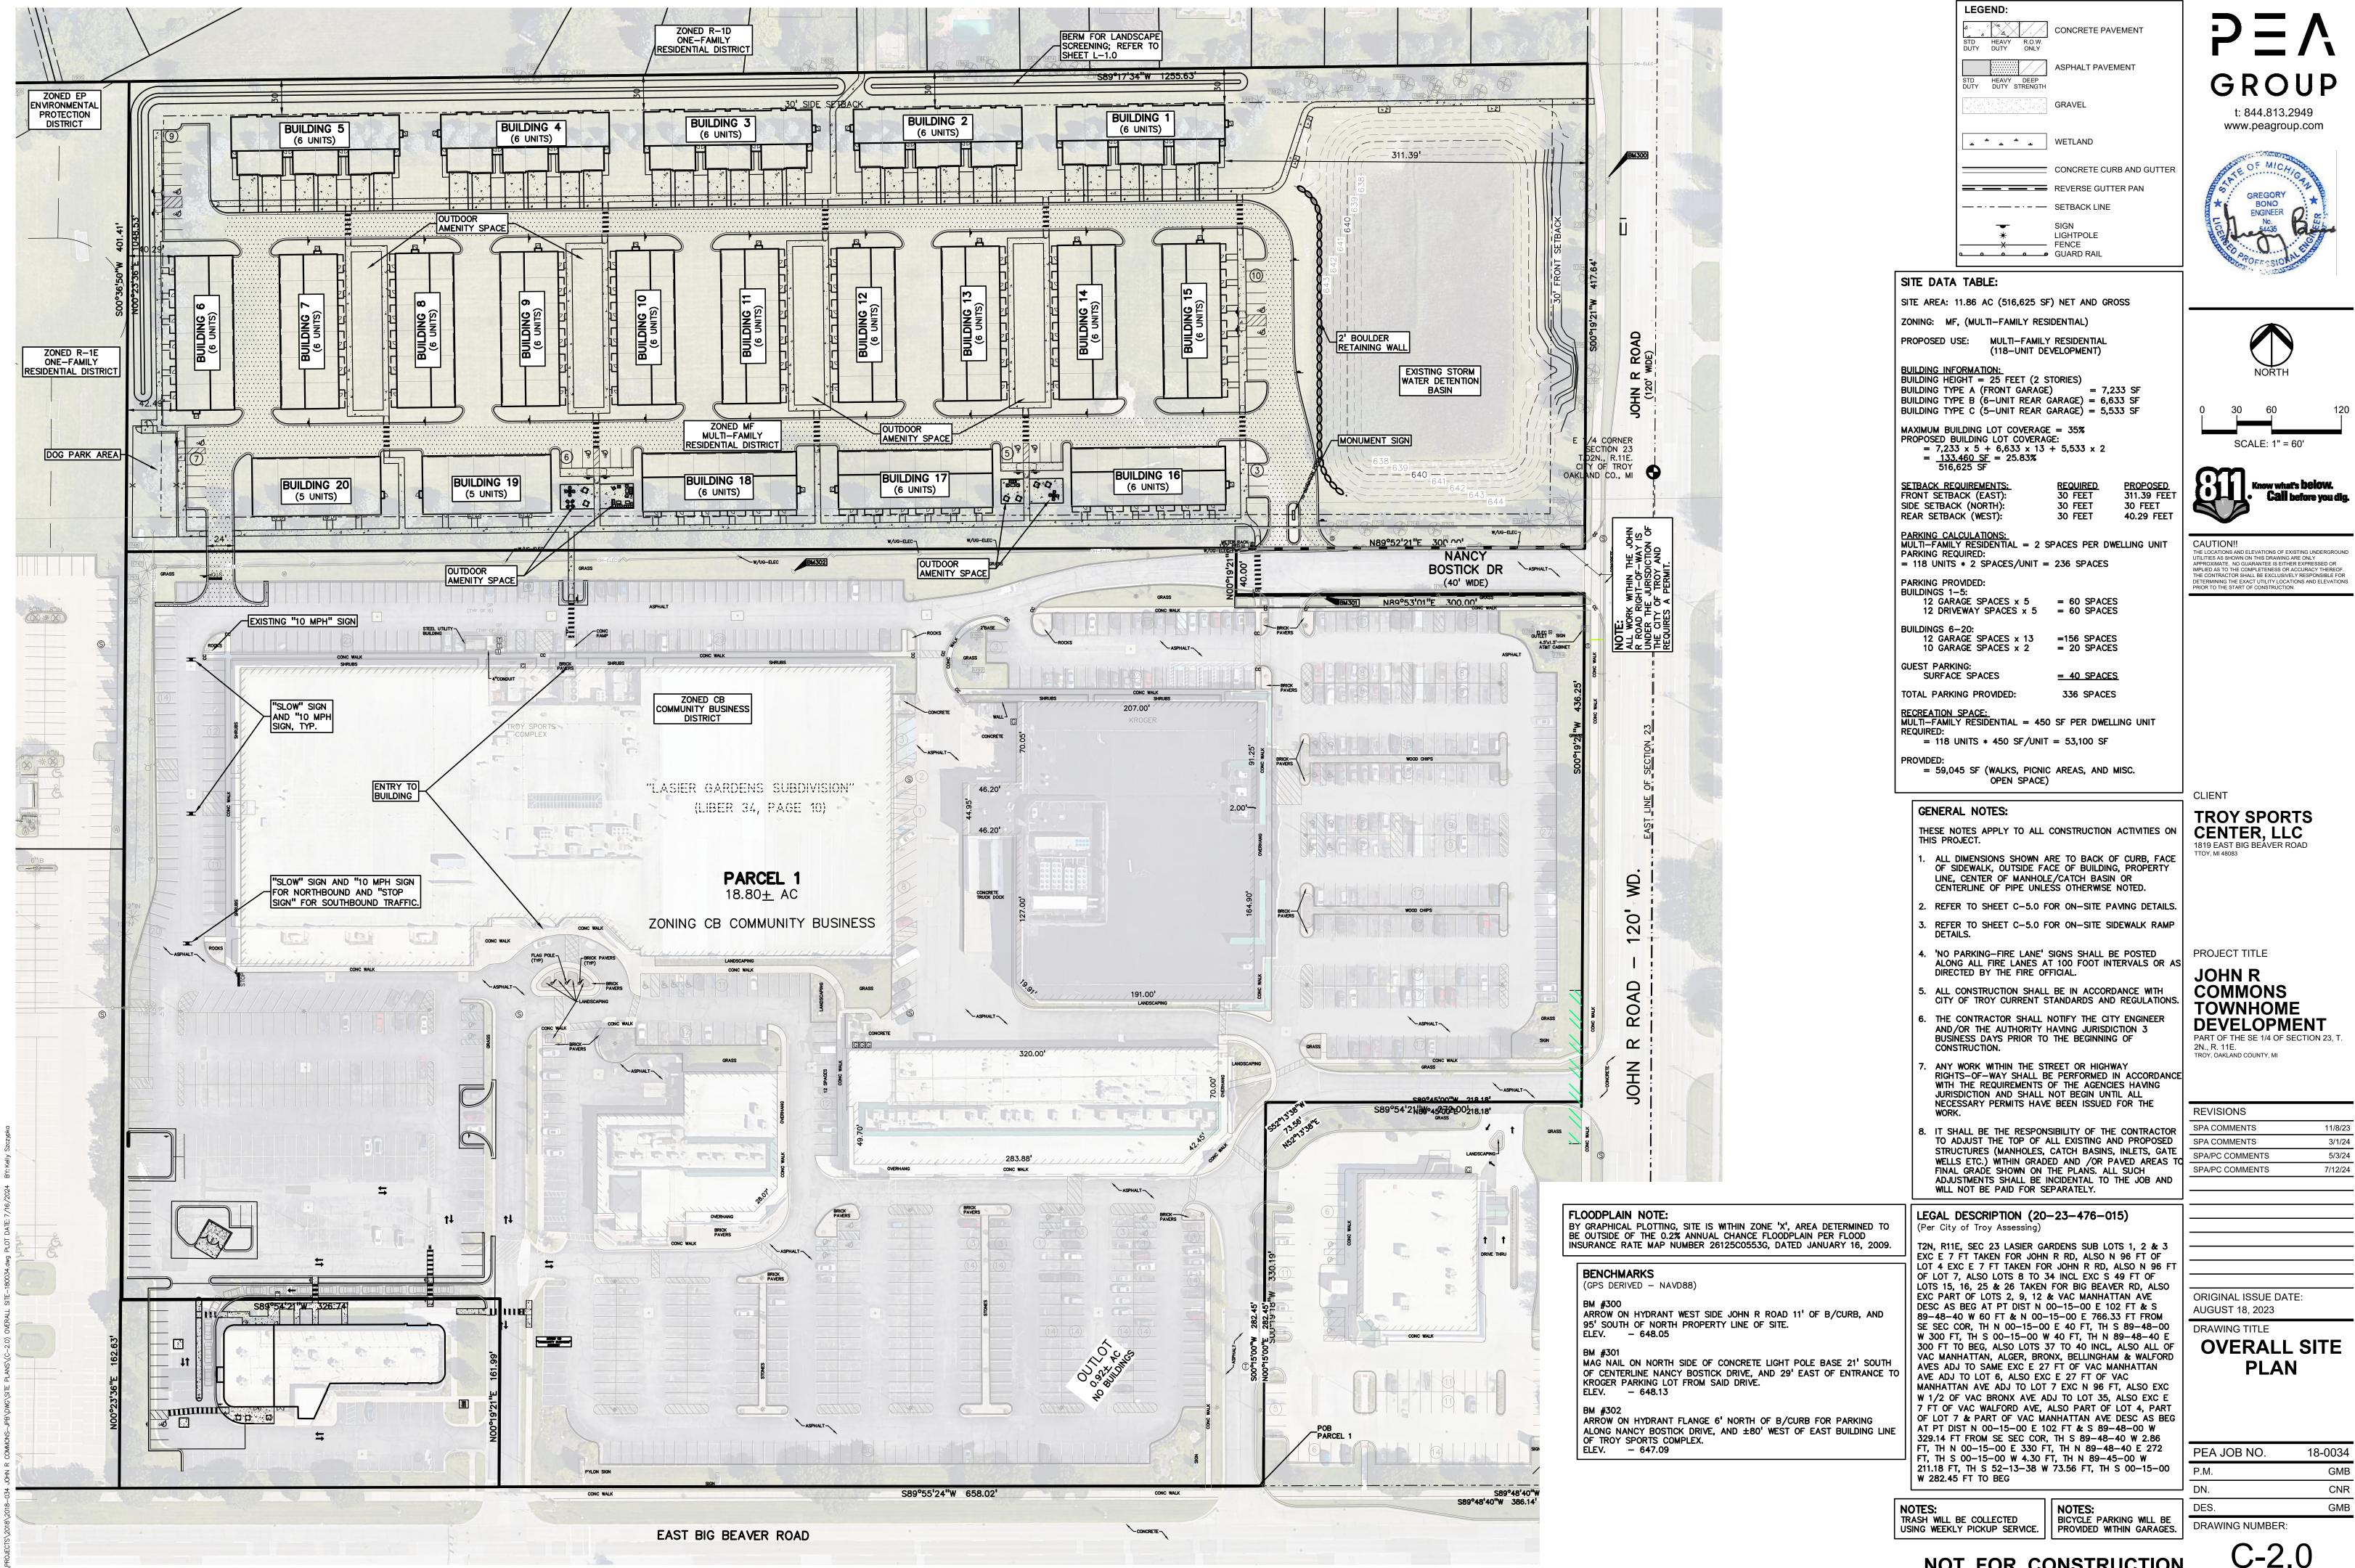
REVISIONS	
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SPA/PC COMMENTS	5/3/24
SPA/PC COMMENTS	7/12/24

ORIGINAL ISSUE DATE: AUGUST 18, 2023

DRAWING TITLE **TOPOGRAPHIC SURVEY**

PEA JOB NO.	18-0034
P.M.	GMB
DN.	CNR
DES	GMB

DRAWING NUMBER:



NOT FOR CONSTRUCTION

BM #300

ARROW ON HYDRANT WEST SIDE JOHN R ROAD 11' OF B/CURB, AND 95' SOUTH OF NORTH PROPERTY LINE OF SITE.

MAG NAIL ON NORTH SIDE OF CONCRETE LIGHT POLE BASE 21' SOUTH OF CENTERLINE NANCY BOSTICK DRIVE, AND 29' EAST OF ENTRANCE TO KROGER PARKING LOT FROM SAID DRIVE.

ELEV. — 648.13

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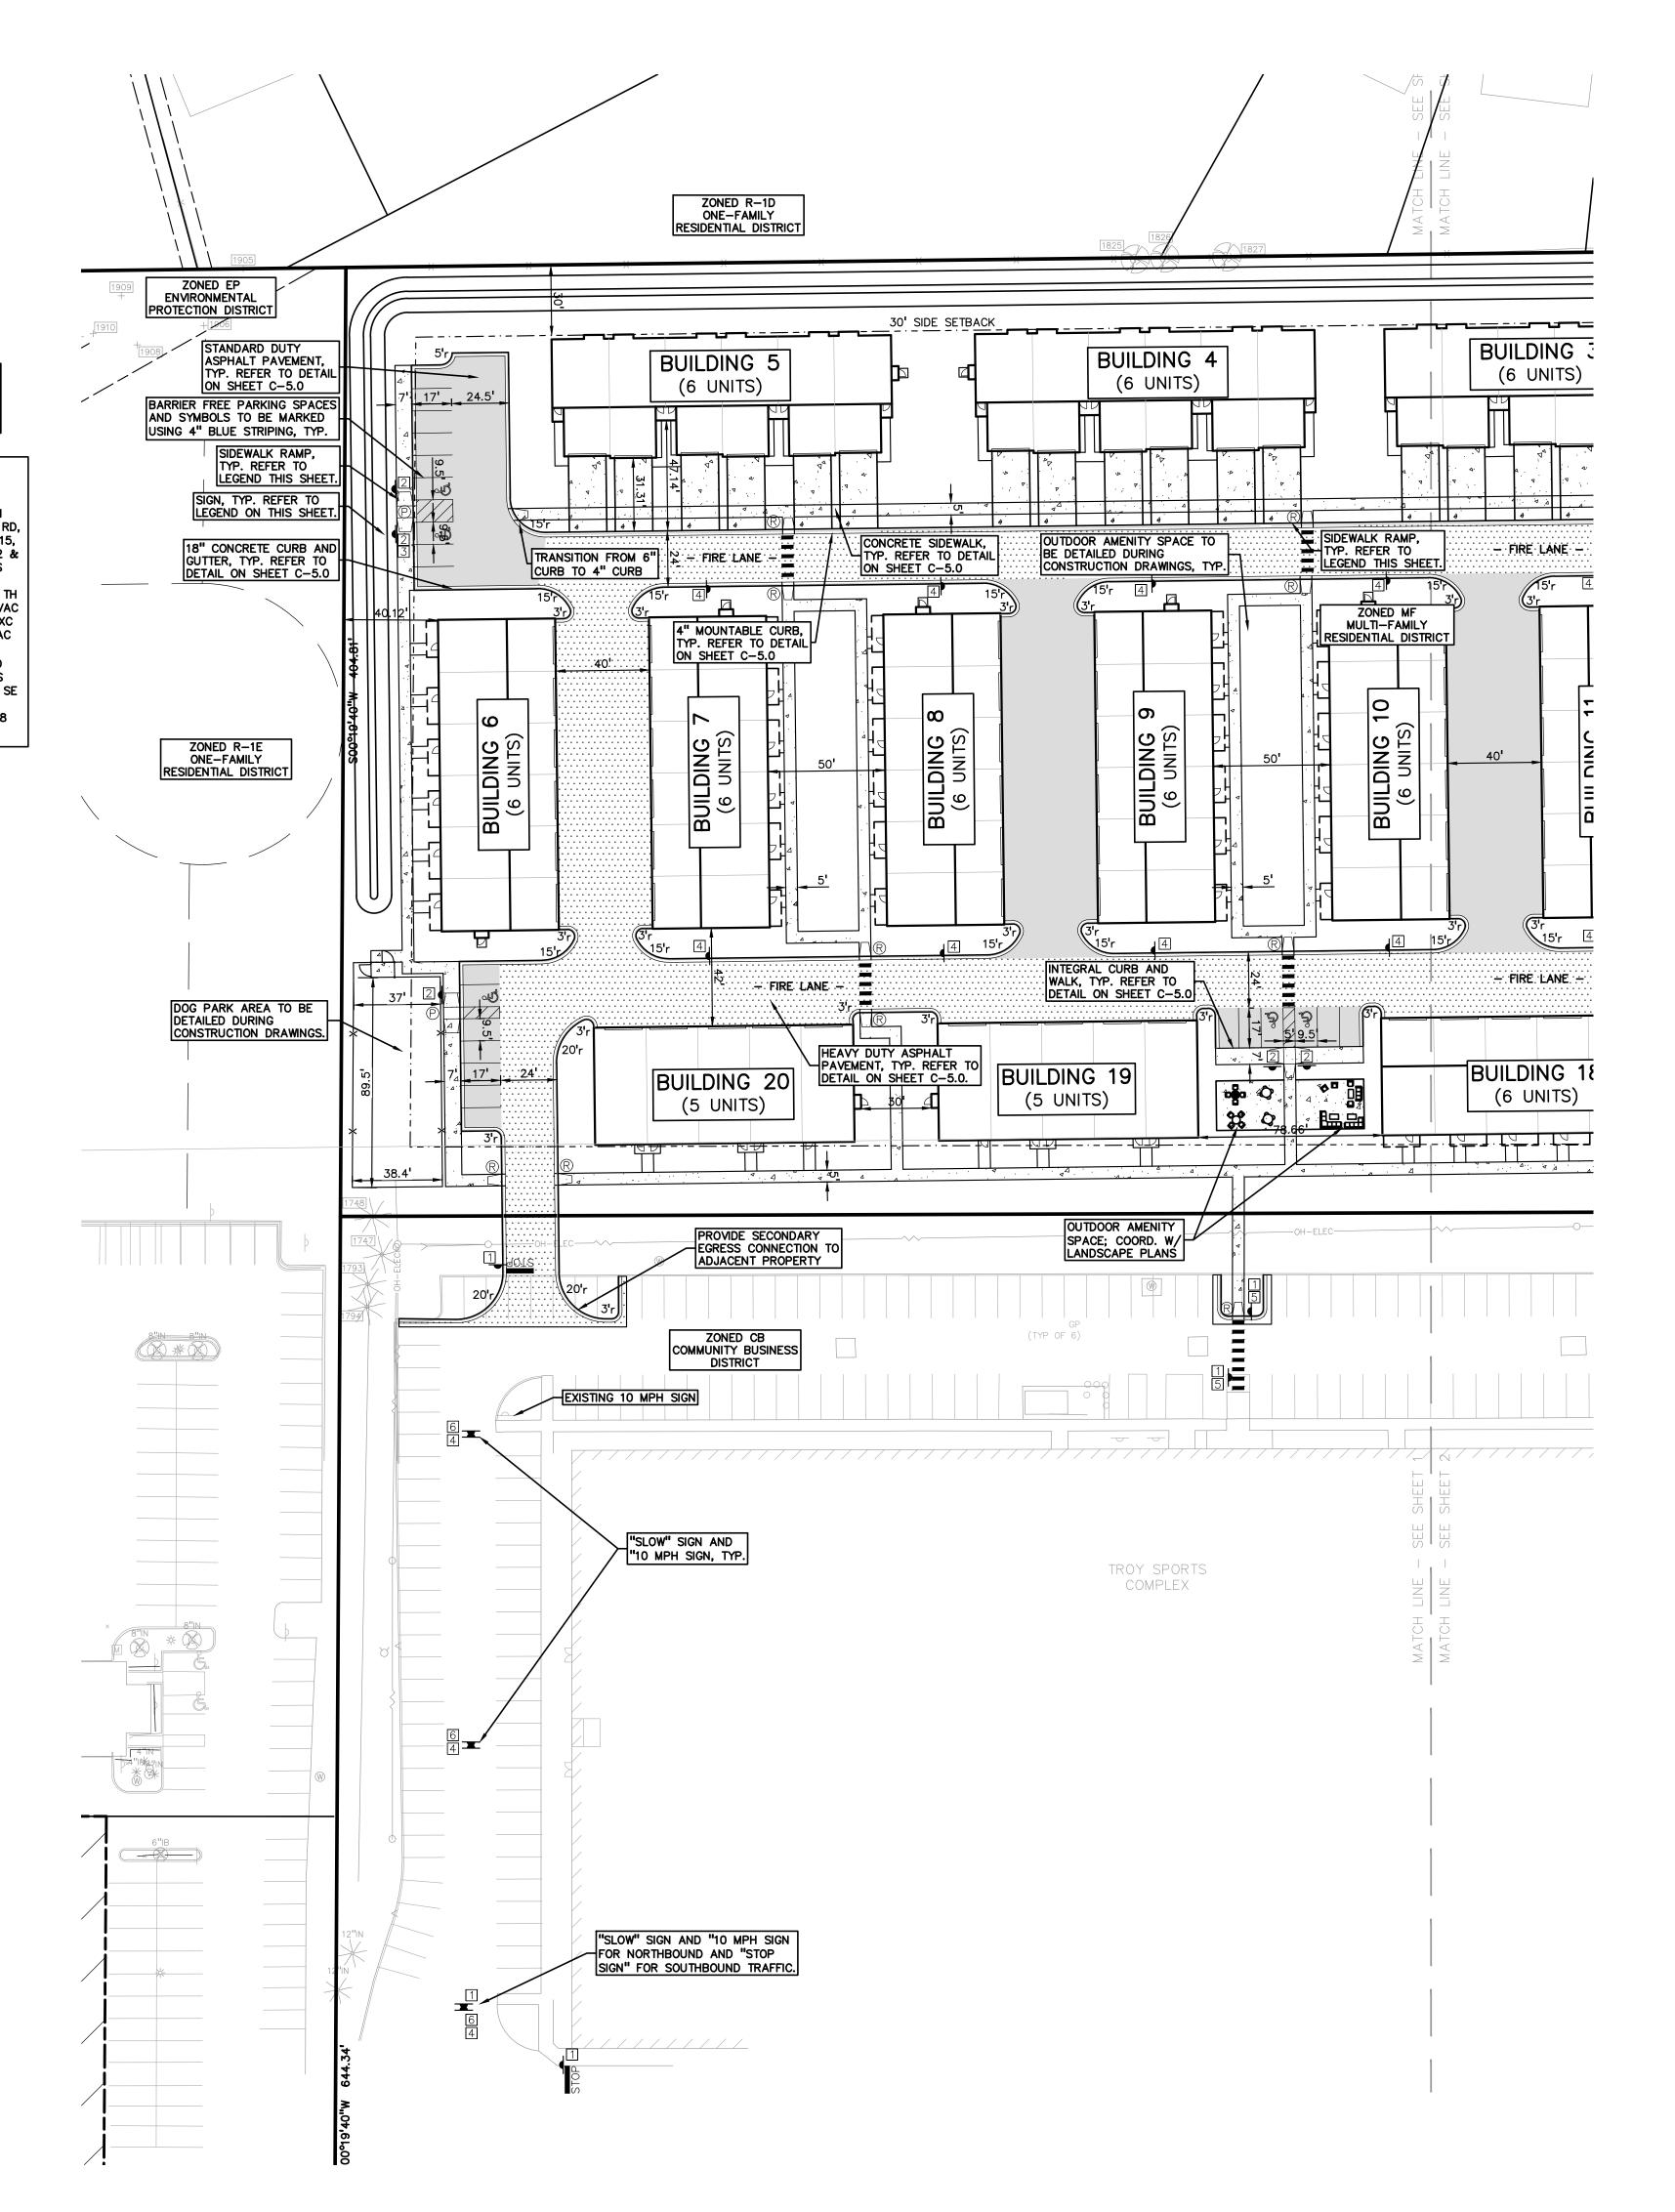
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SIDEWALK RAMP LEGEND:

SIDEWALK RAMP 'TYPE R'

SIDEWALK RAMP 'TYPE P'

REFER TO LATEST M.D.O.T. R-28 STANDARD RAMP AND DETECTABLE WARNING DETAILS

SIGN LEGEND:

'STOP' SIGN

'BARRIER FREE PARKING' SIGN

'VAN ACCESSIBLE' SIGN


'NO PARKING FIRE LANE' SIGN

'CROSSWALK' SIGN

'SLOW' SIGN

'10 MPH' SIGN

REFER TO SHEET C-5.0 FOR SIGN DETAILS

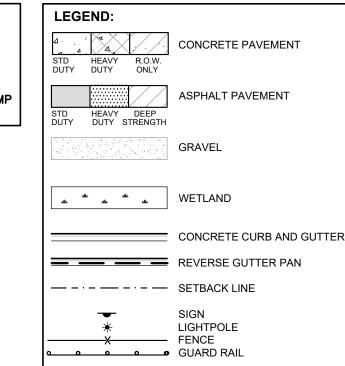





GENERAL NOTES:

THESE NOTES APPLY TO ALL CONSTRUCTION ACTIVITIES ON THIS PROJECT

- ALL DIMENSIONS SHOWN ARE TO BACK OF CURB, FACE OF SIDEWALK, OUTSIDE FACE OF BUILDING, PROPERTY LINE, CENTER OF MANHOLE/CATCH BASIN OR CENTERLINE OF PIPE UNLESS OTHERWISE NOTED.
- 2. REFER TO SHEET C-5.0 FOR ON-SITE PAVING DETAILS.
- 3. REFER TO SHEET C-5.0 FOR ON-SITE SIDEWALK RAMP DETAILS.
- 4. 'NO PARKING-FIRE LANE' SIGNS SHALL BE POSTED ALONG ALL FIRE LANES AT 100 FOOT INTERVALS OR AS DIRECTED BY THE FIRE OFFICIAL.
- 5. ALL CONSTRUCTION SHALL BE IN ACCORDANCE WITH CITY OF TROY CURRENT STANDARDS AND REGULATIONS.
- TROY CURRENT STANDARDS AND REGULATIONS.

 6. THE CONTRACTOR SHALL NOTIFY THE CITY ENGINEER AND/OR
- PRIOR TO THE BEGINNING OF CONSTRUCTION.

 ANY WORK WITHIN THE STREET OR HIGHWAY RIGHTS-OF-WAY SHALL BE PERFORMED IN ACCORDANCE WITH THE REQUIREMENTS OF THE AGENCIES HAVING JURISDICTION AND

SHALL NOT BEGIN UNTIL ALL NECESSARY PERMITS HAVE BEEN

THE AUTHORITY HAVING JURISDICTION 3 BUSINESS DAYS

ISSUED FOR THE WORK.


IT SHALL BE THE RESPONSIBILITY OF THE CONTRACTOR TO ADJUST THE TOP OF ALL EXISTING AND PROPOSED STRUCTURES (MANHOLES, CATCH BASINS, INLETS, GATE WELLS ETC.) WITHIN GRADED AND /OR PAVED AREAS TO FINAL GRADE SHOWN ON THE PLANS. ALL SUCH ADJUSTMENTS SHALL BE INCIDENTAL TO THE JOB AND WILL NOT BE PAID FOR SEPARATELY.

NOTES:
BICYCLE PARKING WILL BE
PROVIDED WITHIN GARAGES.

TRASH WILL BE COLLECTED USING WEEKLY PICKUP SERVICE.





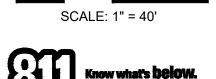



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CLIENT

TROY SPORTS CENTER, LLC 1819 EAST BIG BEAVER ROAD TTOY, MI 48083

PROJECT TITLE

JOHN R
COMMONS
TOWNHOME
DEVELOPMENT
PART OF THE SE 1/4 OF SECTION 23, T
2N., R. 11E.
TROY, OAKLAND COUNTY, MI

REVISIONS	
SPA COMMENTS	11/8/23
SPA COMMENTS	3/1/24
SPA/PC COMMENTS	5/3/24
SPA/PC COMMENTS	7/12/24

ORIGINAL ISSUE DATE: AUGUST 18, 2023

PRELIMINARY
SITE PLAN

PEA JOB NO.	18-0034
P.M.	GME
DN.	CNF
DES.	GME
DRAWING NUMBER:	

ARROW ON HYDRANT WEST SIDE JOHN R ROAD 11' OF B/CURB, AND 95' SOUTH OF NORTH PROPERTY LINE OF SITE.

MAG NAIL ON NORTH SIDE OF CONCRETE LIGHT POLE BASE 21' SOUTH OF CENTERLINE NANCY BOSTICK DRIVE, AND 29' EAST OF ENTRANCE TO KROGER PARKING LOT FROM SAID DRIVE. ELEV. - 648.13

ARROW ON HYDRANT FLANGE 6' NORTH OF B/CURB FOR PARKING ALONG NANCY BOSTICK DRIVE, AND ±80' WEST OF EAST BUILDING LINE OF TROY SPORTS COMPLEX. ELEV. - 647.09

FLOODPLAIN NOTE:

BY GRAPHICAL PLOTTING, SITE IS WITHIN ZONE 'X', AREA DETERMINED TO BE OUTSIDE OF THE 0.2% ANNUAL CHANCE FLOODPLAIN PER FLOOD INSURANCE RATE MAP NUMBER 26125C0553G, DATED JANUARY 16, 2009. LEGAL DESCRIPTION (20-23-476-015)

T2N, R11E, SEC 23 LASIER GARDENS SUB LOTS 1, 2 & 3 EXC E 7 FT TAKEN FOR JOHN R RD, ALSO N 96 FT OF LOT 4 EXC E 7 FT TAKEN FOR JOHN R RD, ALSO N 96 FT OF LOT 7, ALSO LOTS 8 TO 34 INCL EXC S 49 FT OF LOTS 15, 16, 25 & 26 TAKEN FOR BIG BEAVER RD, ALSO EXC PART OF LOTS 2, 9, 12 & VAC MANHATTAN AVE DESC AS BEG AT PT DIST N 00-15-00 E 102 FT & S 89-48-40 W 60 FT & N 00-15-00 E 766.33 FT FROM SE SEC COR, TH N 00-15-00 E 40 FT, TH S 89-48-00 W 300 FT, TH S 00-15-00 W 40 FT, TH N 89-48-40 E 300 FT TO BEG, ALSO LOTS 37 TO 40 INCL, ALSO ALL OF VAC MANHATTAN, ALGER, BRONX, BELLINGHAM & WALFORD AVES ADJ TO SAME EXC E 27 FT OF VAC MANHATTAN AVE ADJ TO LOT 6, ALSO EXC E 27 FT OF VAC MANHATTAN AVE ADJ TO LOT 7 EXC N 96 FT, ALSO EXC W 1/2 OF VAC BRONX AVE ADJ TO LOT 35, ALSO EXC E 7 FT OF VAC WALFORD AVE, ALSO PART OF LOT 4, PART OF LOT 7 & PART OF VAC MANHATTAN AVE DESC AS BEG AT PT DIST N 00-15-00 E 102 FT & S 89-48-00 W 329.14 FT FROM SE SEC COR, TH S 89-48-40 W 2.86 FT, TH N 00-15-00 E 330 FT, TH N

89-48-40 E 272 FT, TH S 00-15-00 W 4.30 FT, TH N 89-45-00 W 211.18


FT, TH S 52-13-38 W 73.56 FT, TH S 00-15-00 W 282.45 FT TO BEG

(Per City of Troy Assessing) SIDEWALK RAMP 'TYPE R' SIDEWALK RAMP 'TYPE P' AND DETECTABLE WARNING DETAILS SIGN LEGEND: 'STOP' SIGN 'VAN ACCESSIBLE' SIGN

SIDEWALK RAMP LEGEND: REFER TO LATEST M.D.O.T. R-28 STANDARD RAMP 'BARRIER FREE PARKING' SIGN

STD HEAVY R.O.W. DUTY DUTY ONLY ASPHALT PAVEMENT ate ate METLAND CONCRETE CURB AND GUTTER REVERSE GUTTER PAN 'NO PARKING FIRE LANE' SIGN — - · - — - · - — SETBACK LINE 'CROSSWALK' SIGN LIGHTPOLE 'SLOW' SIGN X FENCE GUARD RAIL '10 MPH' SIGN REFER TO SHEET C-5.0 FOR SIGN DETAILS


LEGEND:

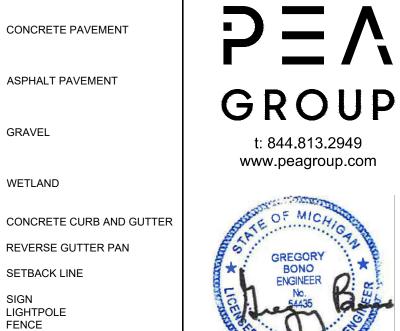

NOTES: BICYCLE PARKING WILL BE PROVIDED WITHIN GARAGES.

TRASH WILL BE COLLECTED USING WEEKLY PICKUP SERVICE.



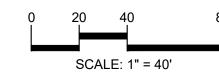



CAUTION!! THE LOCATIONS AND ELEVATIONS OF EXISTING UNDERGROUND UTILITIES AS SHOWN ON THIS DRAWING ARE ONLY APPROXIMATE. NO GUARANTEE IS EITHER EXPRESSED OR IMPLIED AS TO THE COMPLETENESS OR ACCURACY THEREOF. THE CONTRACTOR SHALL BE EXCLUSIVELY RESPONSIBLE FOR DETERMINING THE EXACT UTILITY LOCATIONS AND ELEVATIONS PRIOR TO THE START OF CONSTRUCTION.

CLIENT

TROY SPORTS CENTER, LLC 1819 EAST BIG BEAVER ROAD

PROJECT TITLE JOHN R COMMONS TOWNHOME DEVELOPMENT PART OF THE SE 1/4 OF SECTION 23, T. 2N., R. 11E. TROY, OAKLAND COUNTY, MI


REVISIONS	
SPA COMMENTS	11/8/23
SPA COMMENTS	3/1/24
SPA/PC COMMENTS	5/3/24
SPA/PC COMMENTS	7/12/24

ORIGINAL ISSUE DATE: AUGUST 18, 2023 DRAWING TITLE

PRELIMINARY SITE PLAN

PEA JOB NO.	18-003
P.M.	GM
DN.	CN
DES.	GM
DRAWING NUMBER:	

NOT FOR CONSTRUCTION

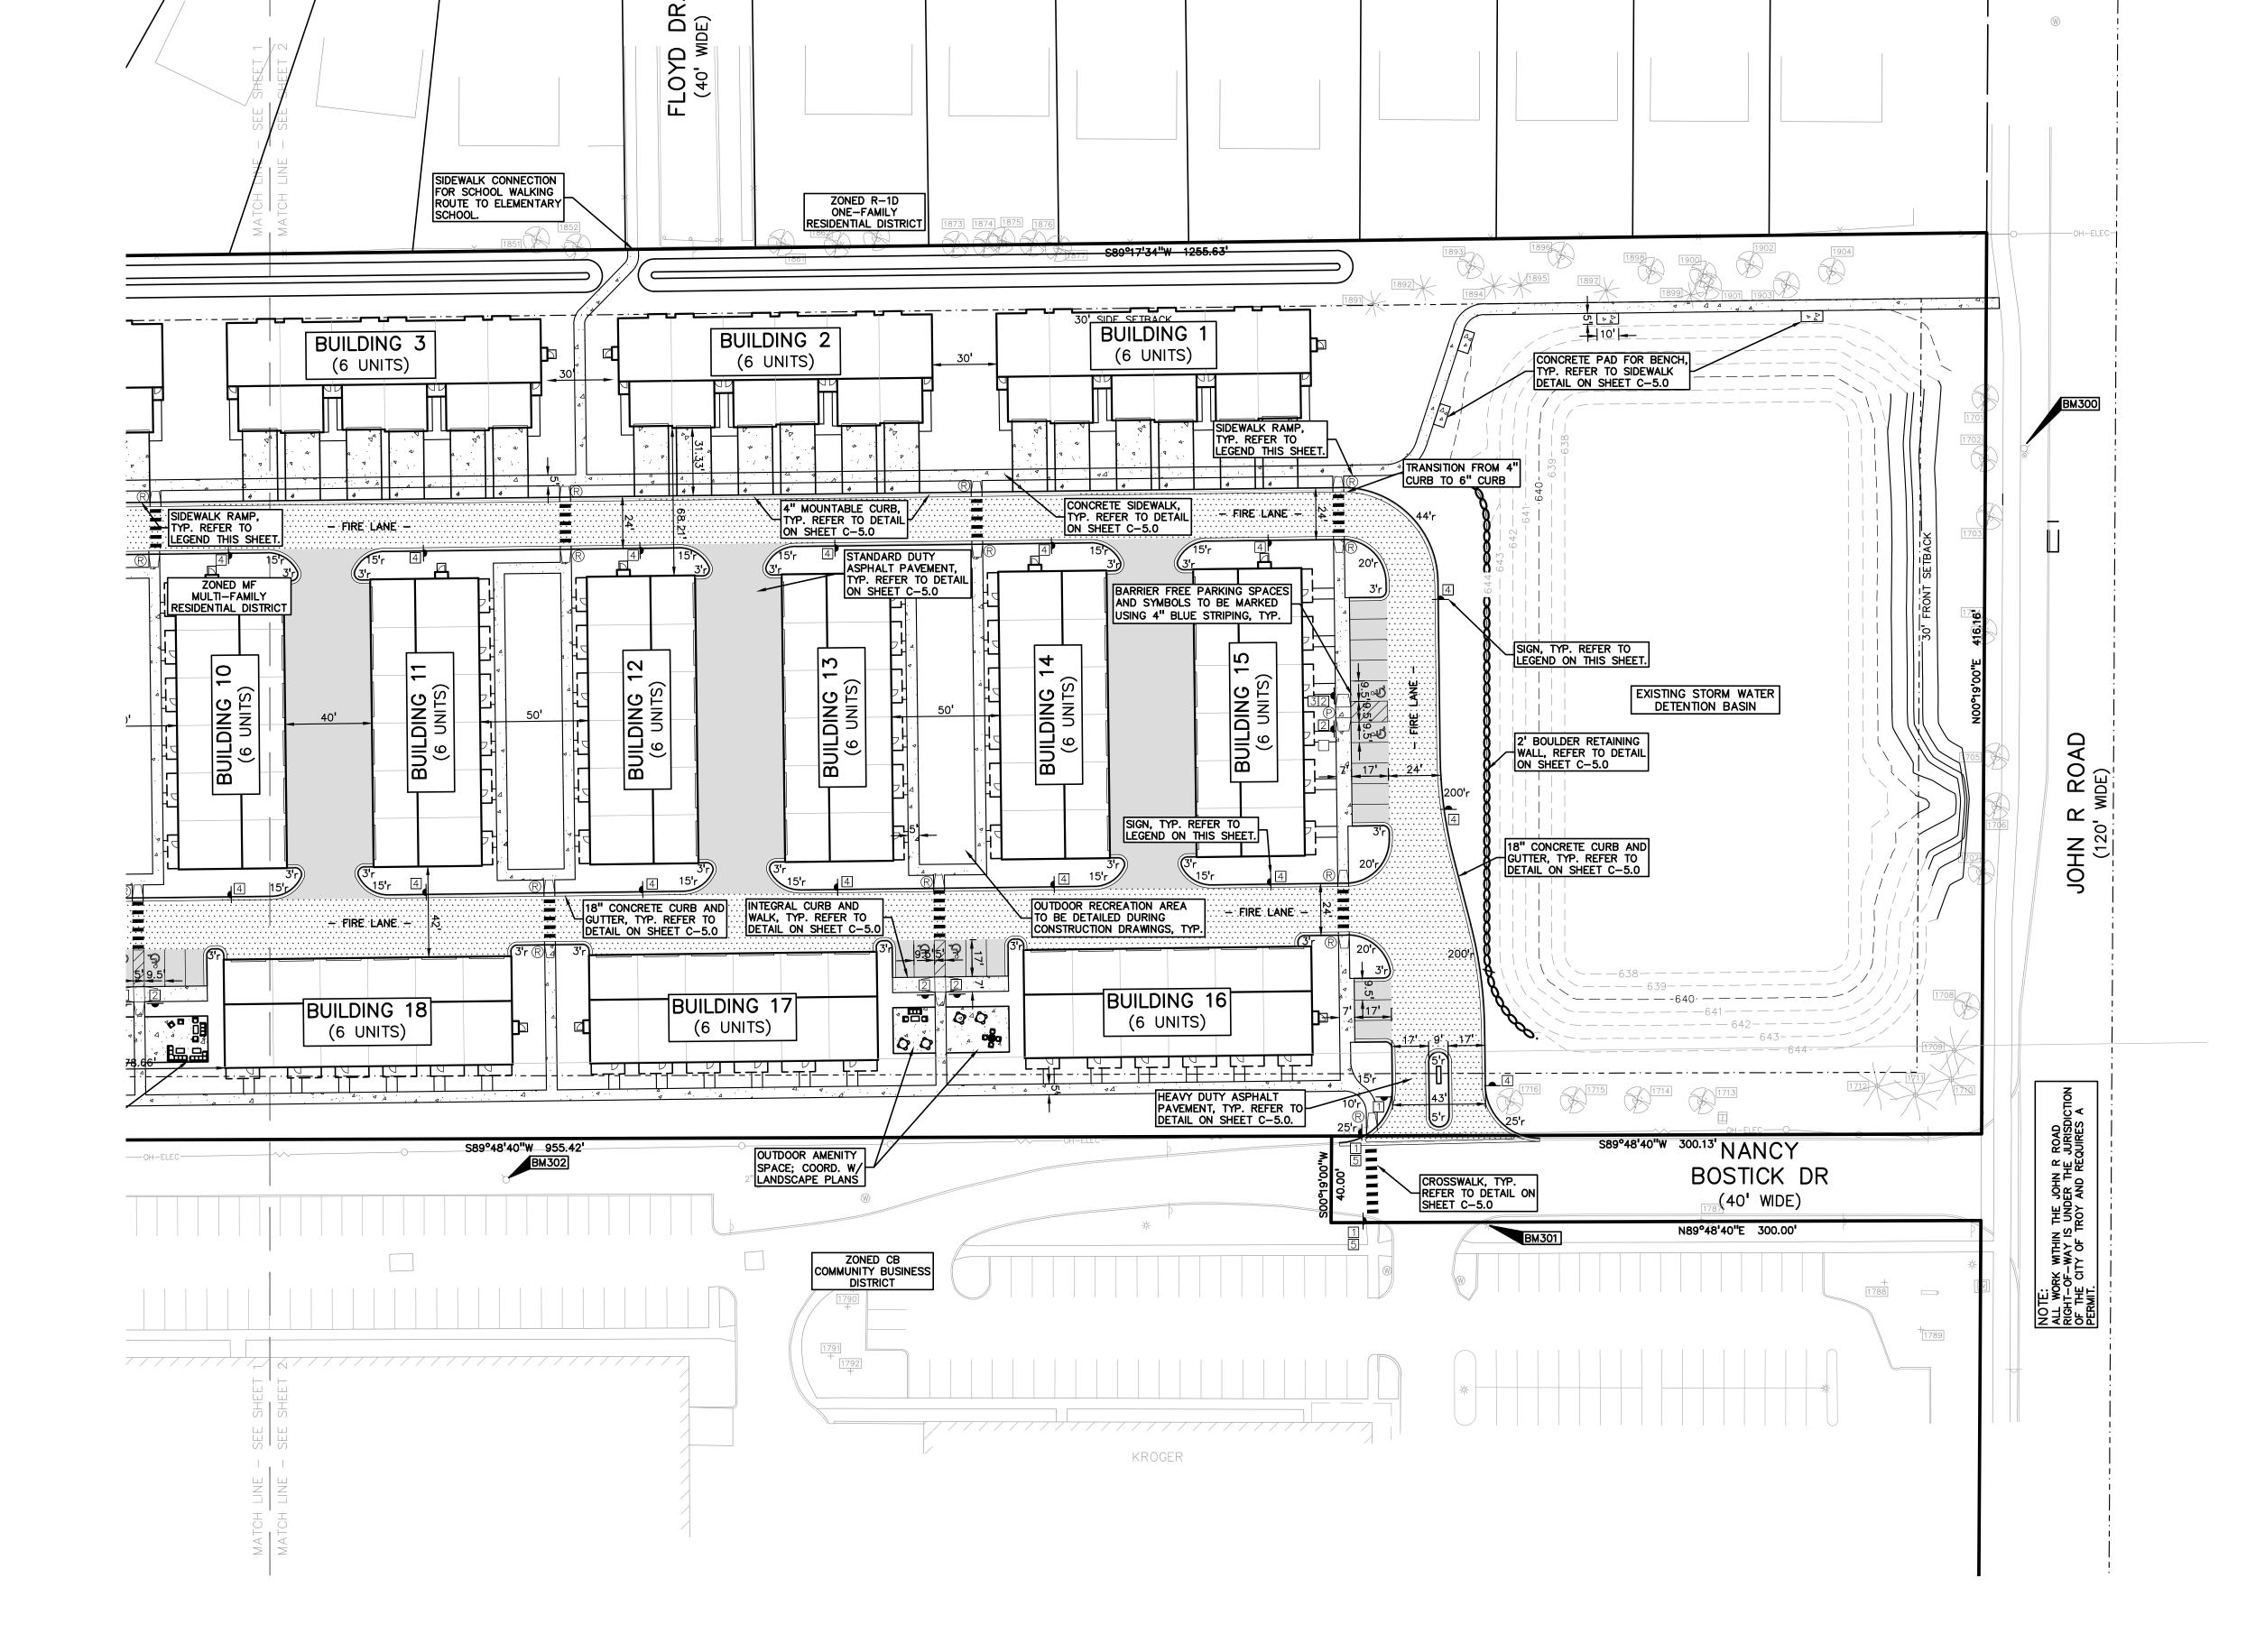


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MAG NAIL ON NORTH SIDE OF CONCRETE LIGHT POLE BASE 21' SOUTH OF CENTERLINE NANCY BOSTICK DRIVE, AND 29' EAST OF ENTRANCE TO KROGER PARKING LOT FROM SAID DRIVE. ELEV. - 648.13

ARROW ON HYDRANT FLANGE 6' NORTH OF B/CURB FOR PARKING ALONG NANCY BOSTICK DRIVE, AND ±80' WEST OF EAST BUILDING LINE OF TROY SPORTS COMPLEX. ELEV. - 647.09

FLOODPLAIN NOTE:

BY GRAPHICAL PLOTTING, SITE IS WITHIN ZONE 'X', AREA DETERMINED TO BE OUTSIDE OF THE 0.2% ANNUAL CHANCE FLOODPLAIN PER FLOOD INSURANCE RATE MAP NUMBER 26125C0553G, DATED JANUARY 16, 2009.

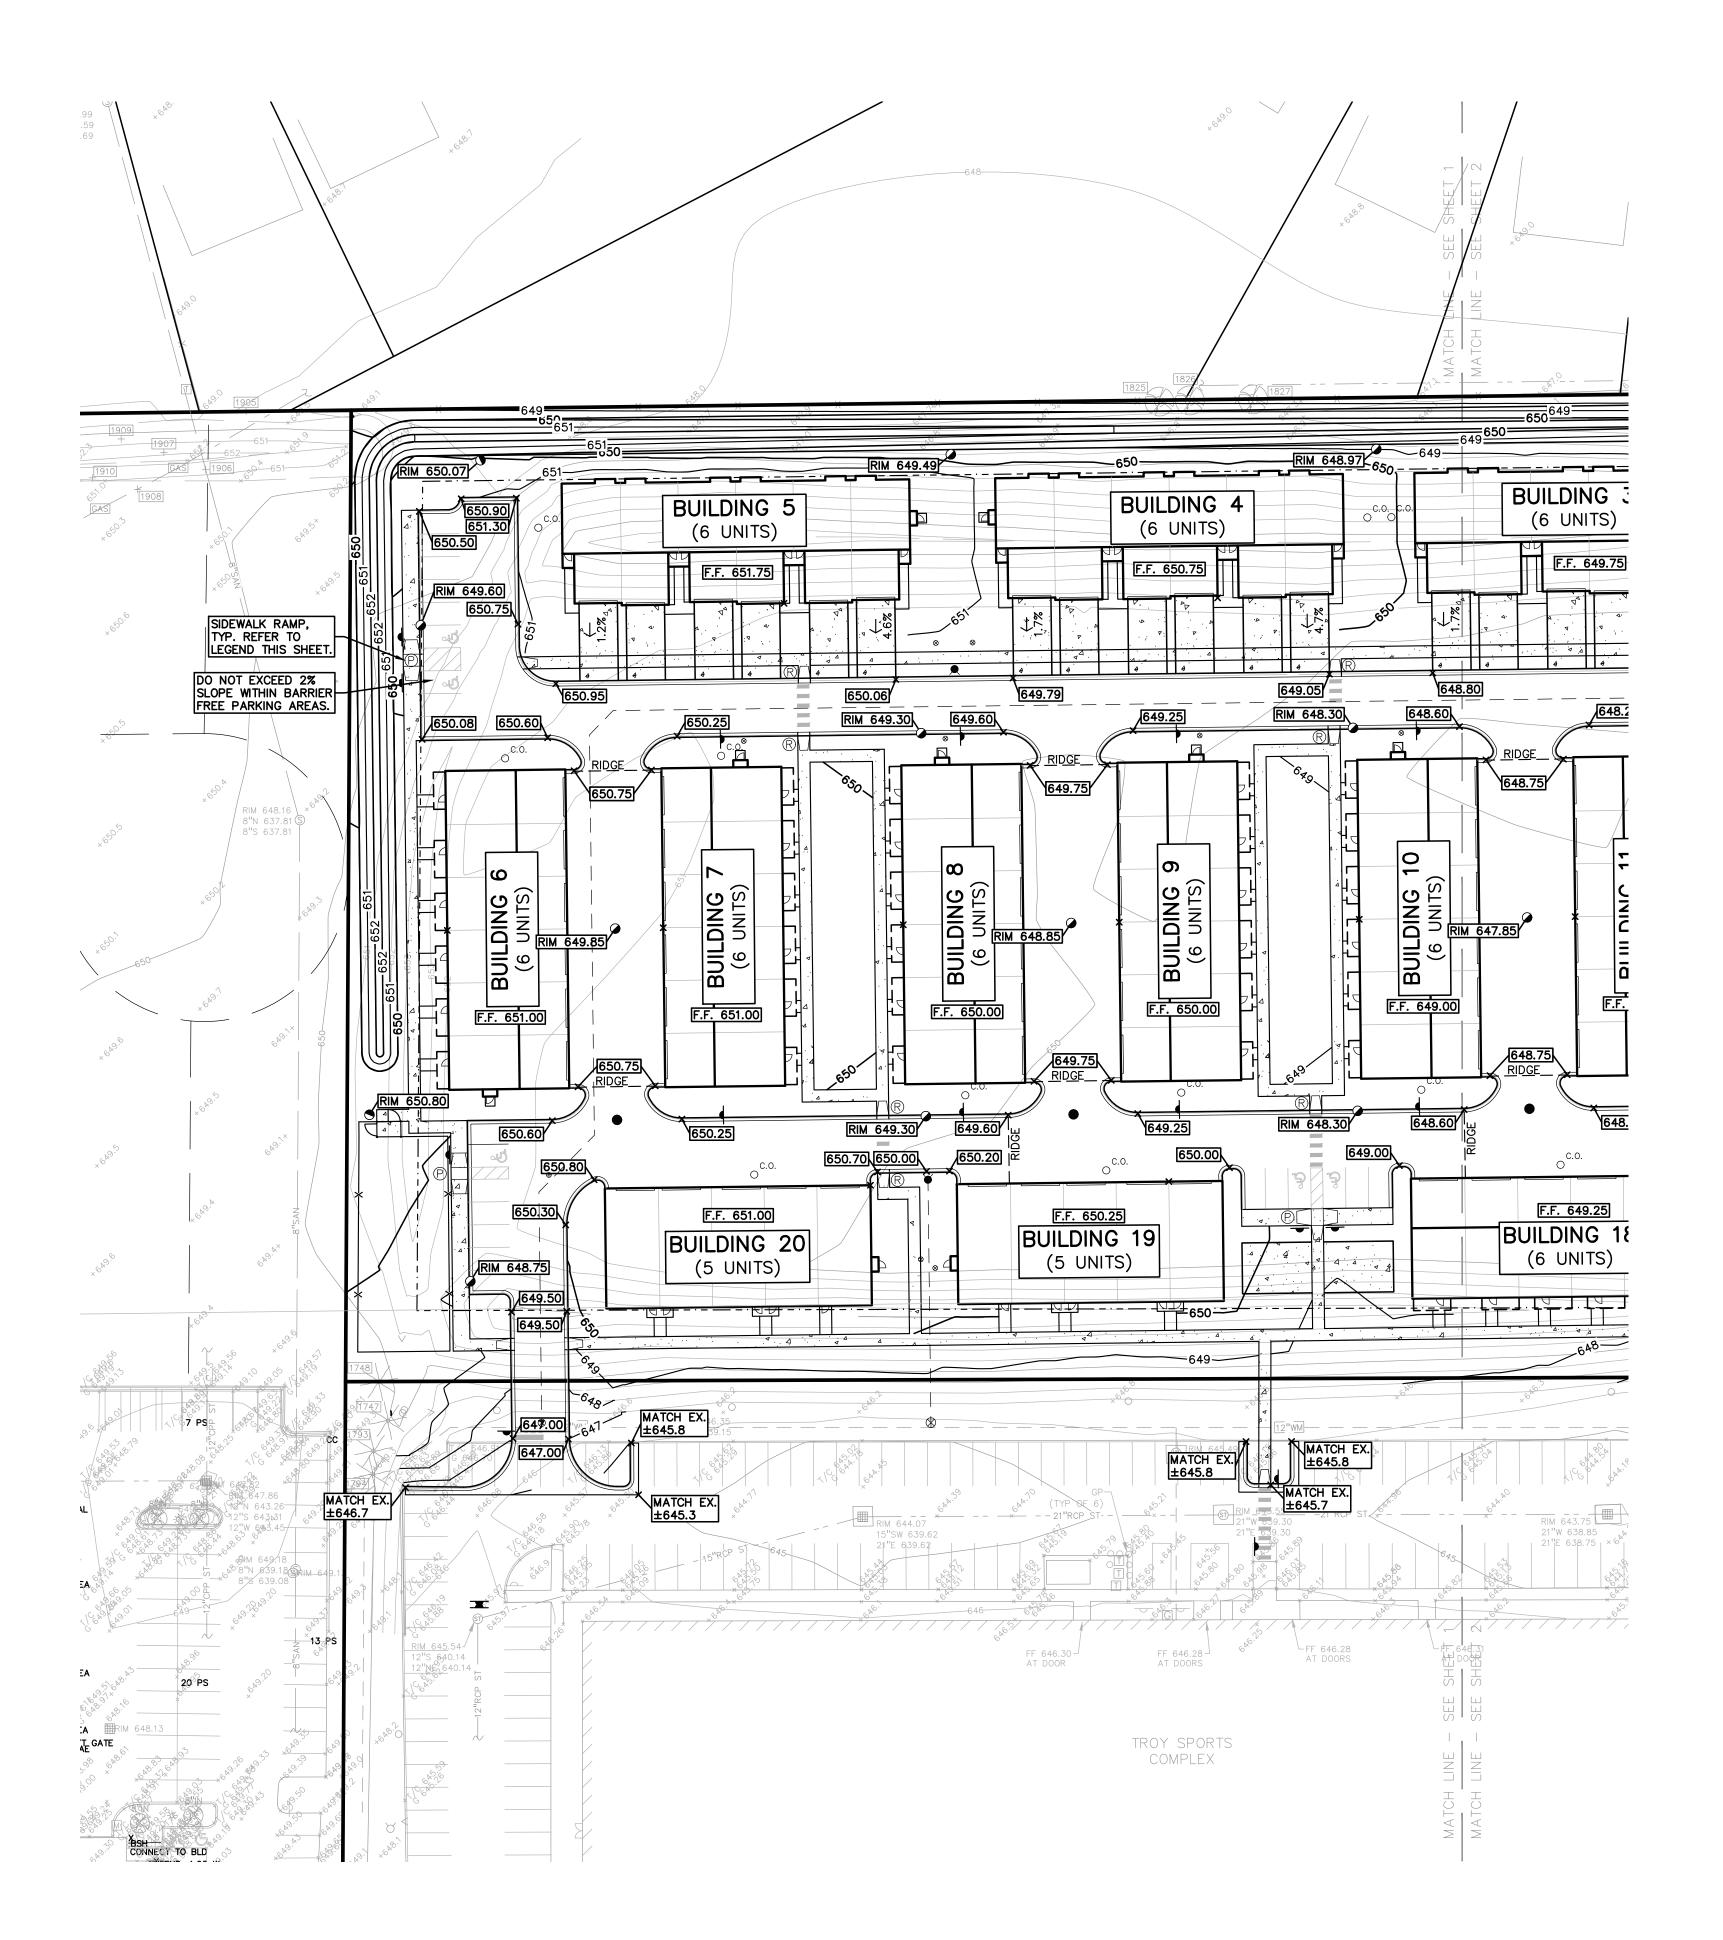

SIDEWALK RAMP LEGEND:

SIDEWALK RAMP 'TYPE R'

SIDEWALK RAMP 'TYPE P'

REFER TO LATEST M.D.O.T. R-28 STANDARD RAMP AND DETECTABLE WARNING DETAILS

SYMBOLS: GRADING

PROPOSED CONTOUR LINE

PROPOSED SPOT GRADE ELEVATION. ALL GRADES INDICATED ARE TOP OF PAVEMENT UNLESS OTHERWISE NOTED.

694.50 ----695---

EARTHWORK BALANCING NOTE:

THE CONTRACTOR SHALL BE RESPONSIBLE FOR IMPORTING OR EXPORTING ALL MATERIALS AS REQUIRED TO PROPERLY GRADE THIS PROJECT TO THE FINISHED ELEVATIONS SHOWN ON THE APPROVED PLANS. THE CONTRACTOR SHALL MAKE THEIR OWN DETERMINATION OF CUT AND FILL QUANTITIES AND ALLOW FOR REMOVAL OF EXCESS OR IMPORTATION OF ADDITIONAL MATERIAL AT NO ADDITIONAL COST TO THE OWNER.

GENERAL GRADING AND EARTHWORK NOTES:


- THESE NOTES APPLY TO ALL CONSTRUCTION ACTIVITIES ON THIS PROJECT
- CONTRACTOR TO FIELD VERIFY ALL EXISTING TREES AND BRUSH AND REMOVE ALL THAT ARE NECESSARY TO GRADE SITE.
- . ALL GRADES ARE TO TOP OF PAVEMENT UNLESS OTHERWISE NOTED.
- THE STAGING OF CONSTRUCTION ACTIVITIES SHALL OCCUR ONLY WITHIN THE SITE BOUNDARIES. ANY CONSTRUCTION ACTIVITIES OUTSIDE OF THE SITE BOUNDARIES SHALL BE AT THE SOLE RESPONSIBILITY AND RISK OF THE CONTRACTOR.
- REQUIREMENTS OF THE CITY OF TROY. AN EROSION CONTROL PERMIT MUST BE SECURED FROM THE CITY PRIOR TO CONSTRUCTION.
- ALL EARTHWORK AND GRADING OPERATIONS SHALL BE PERFORMED IN ACCORDANCE WITH THE SOILS INVESTIGATION AND REPORT.
- THE DETENTION BASIN SIDE SLOPES AND ALL SLOPE EXCEEDING 1:6 MUST BE STABILIZED BY SODDING OR BY PLACING A MULCH BLANKET PEGGED IN PLACE
- ALL DISTURBED AREAS SHALL BE SEEDED AND MULCHED OR SODDED IN ACCORDANCE WITH THE LANDSCAPE PLANS. PROVIDE A MINIMUM OF 3" OF TOPSOIL IN THESE AREAS UNLESS OTHERWISE NOTED.
- . THE CONTRACTOR SHALL NOTE EXISTING UNDERGROUND UTILITIES WITHIN AND ADJACENT TO THE SITE. BACKFILL FOR EXISTING UTILITY TRENCHES SHALL BE EXAMINED CRITICALLY. ANY TRENCHES FOUND TO HAVE SOFT, UNSTABLE OR UNSUITABLE BACKFILL MATERIAL, IN THE OPINION OF THE GEOTECHNICAL ENGINEER, THAT ARE TO BE WITHIN THE ZONE OF INFLUENCE OF PROPOSED BUILDINGS OR PAVEMENT SHALL BE COMPLETELY EXCAVATED AND BACKFILLED WITH SUITABLE MATERIAL.




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CLIENT

TROY SPORTS CENTER, LLC 1819 EAST BIG BEAVER ROAD TTOY, MI 48083

PROJECT TITLE

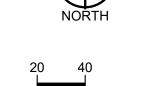JOHN R
COMMONS
TOWNHOME
DEVELOPMENT
PART OF THE SE 1/4 OF SECTION 23, T. 2N., R. 11E. TROY, OAKLAND COUNTY, MI

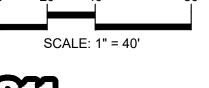
REVISIONS	
SPA COMMENTS	11/8/23
SPA COMMENTS	3/1/24
SPA/PC COMMENTS	5/3/24
SPA/PC COMMENTS	7/12/24

ORIGINAL ISSUE DATE: AUGUST 18, 2023

DRAWING TITLE **PRELIMINARY**

GRADING PLAN

PEA JOB NO.	18-0034
P.M.	GME
DN.	CNR
DES.	GME
DRAWING NUMBER:	

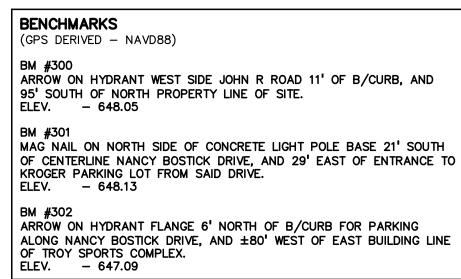

FLOODPLAIN NOTE: BY GRAPHICAL PLOTTING, SITE IS WITHIN ZONE 'X', AREA DETERMINED TO BE OUTSIDE OF THE 0.2% ANNUAL CHANCE FLOODPLAIN PER FLOOD INSURANCE RATE MAP NUMBER 26125C0553G, DATED JANUARY 16, 2009. S RIM 646.15 LOYD (40' W MATCH EX. MATCH EX. ±645.7 <u>±645.6</u> M 648.97 650,-**BUILDING 1 BUILDING 2** BUILDING 3 (6 UNITS) (6 UNITS) (6 UNITS) F.F. 647.75 F.F. 648.75 T/W 645.00 TYP. REFER TO LEGEND THIS SHEET. B/W 645.00 646.70 646.60 648.00 645,60 RIM 645.69 646.25 RIM 646.30 RIM 647.30 648.30 T/W 645.00 B/W 643.00 645.45 646.75 N T/W 645.00 B/W 643.00 EXISTING DETENTION BASIN 645.45 F.F. 647.00 F.F. 647.00 F.F. 648.00 F.F. 648.00 F.F. 649.00 F.F. 649.00 DO NOT EXCEED 2% SLOPE WITHIN BARRIER FREE PARKING AREAS. 647.30 648.00 648.30 647.60 647.25 RIM 646.30 647.00 T/W 645.00 649.00 B/W 643.00 F.F. 647.25 F.F. 648.50 F.F. 649.25 646.25 BUILDING 16 **BUILDING 17** BUILDING 18 T/W 645.00_ (6 UNITS) 645.50 (6 UNITS) 646.25 646.25 646.30 646.30 646.30 (6 UNITS) B/W 645.00 642= (6 UNITS) NANCY MATCH EX. ±645.0 BOSTICK DR MATCH EX. ±645.2 (40' WIDE) MATCH EX. ±645.8 TCH EX. 45.7 -FF 646.28 AT DOORS KROGER

SIDEWALK RAMP LEGEND:

SIDEWALK RAMP 'TYPE R' SIDEWALK RAMP 'TYPE P'

REFER TO LATEST M.D.O.T. R-28 STANDARD RAMP AND DETECTABLE WARNING DETAILS

SYMBOLS: GRADING

PROPOSED SPOT GRADE ELEVATION. ALL GRADES INDICATED ARE TOP OF PAVEMENT UNLESS OTHERWISE NOTED.

----695 ---

EARTHWORK BALANCING NOTE:

PROPOSED CONTOUR LINE

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GENERAL GRADING AND EARTHWORK NOTES:

THESE NOTES APPLY TO ALL CONSTRUCTION ACTIVITIES ON THIS PROJECT


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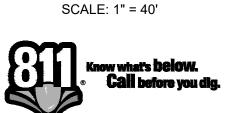


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CLIENT

TROY SPORTS CENTER, LLC 1819 EAST BIG BEAVER ROAD

PROJECT TITLE

JOHN R
COMMONS
TOWNHOME
DEVELOPMENT
PART OF THE SE 1/4 OF SECTION 23, T. 2N., R. 11E.
TROY, OAKLAND COUNTY, MI

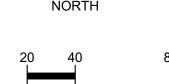REVISIONS	
SPA COMMENTS	11/8/23
SPA COMMENTS	3/1/24
SPA/PC COMMENTS	5/3/24
SPA/PC COMMENTS	7/12/24

ORIGINAL ISSUE DATE: AUGUST 18, 2023

DRAWING TITLE **PRELIMINARY GRADING PLAN**

PEA JOB NO.	18-0034
P.M.	GME
DN.	CNF
DES.	GME
DRAWING NUMBER:	


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MAG NAIL ON NORTH SIDE OF CONCRETE LIGHT POLE BASE 21' SOUTH OF CENTERLINE NANCY BOSTICK DRIVE, AND 29' EAST OF ENTRANCE TO KROGER PARKING LOT FROM SAID DRIVE. ELEV. – 648.13

ARROW ON HYDRANT FLANGE 6' NORTH OF B/CURB FOR PARKING ALONG NANCY BOSTICK DRIVE, AND ±80' WEST OF EAST BUILDING LINE OF TROY SPORTS COMPLEX. ELEV. – 647.09

FLOODPLAIN NOTE:

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SAND BACKFILL NOTE:

ALL UTILITIES UNDER PAVEMENT OR WITHIN 3' OF THE EDGE OF PAVEMENT (OR WITHIN THE 45° LINE OF INFLUENCE OF PAVEMENT) SHALL HAVE M.D.O.T. CLASS II GRANULAR BACKFILL COMPACTED TO 95% MAX. DRY DENSITY (ASTM D-1557).

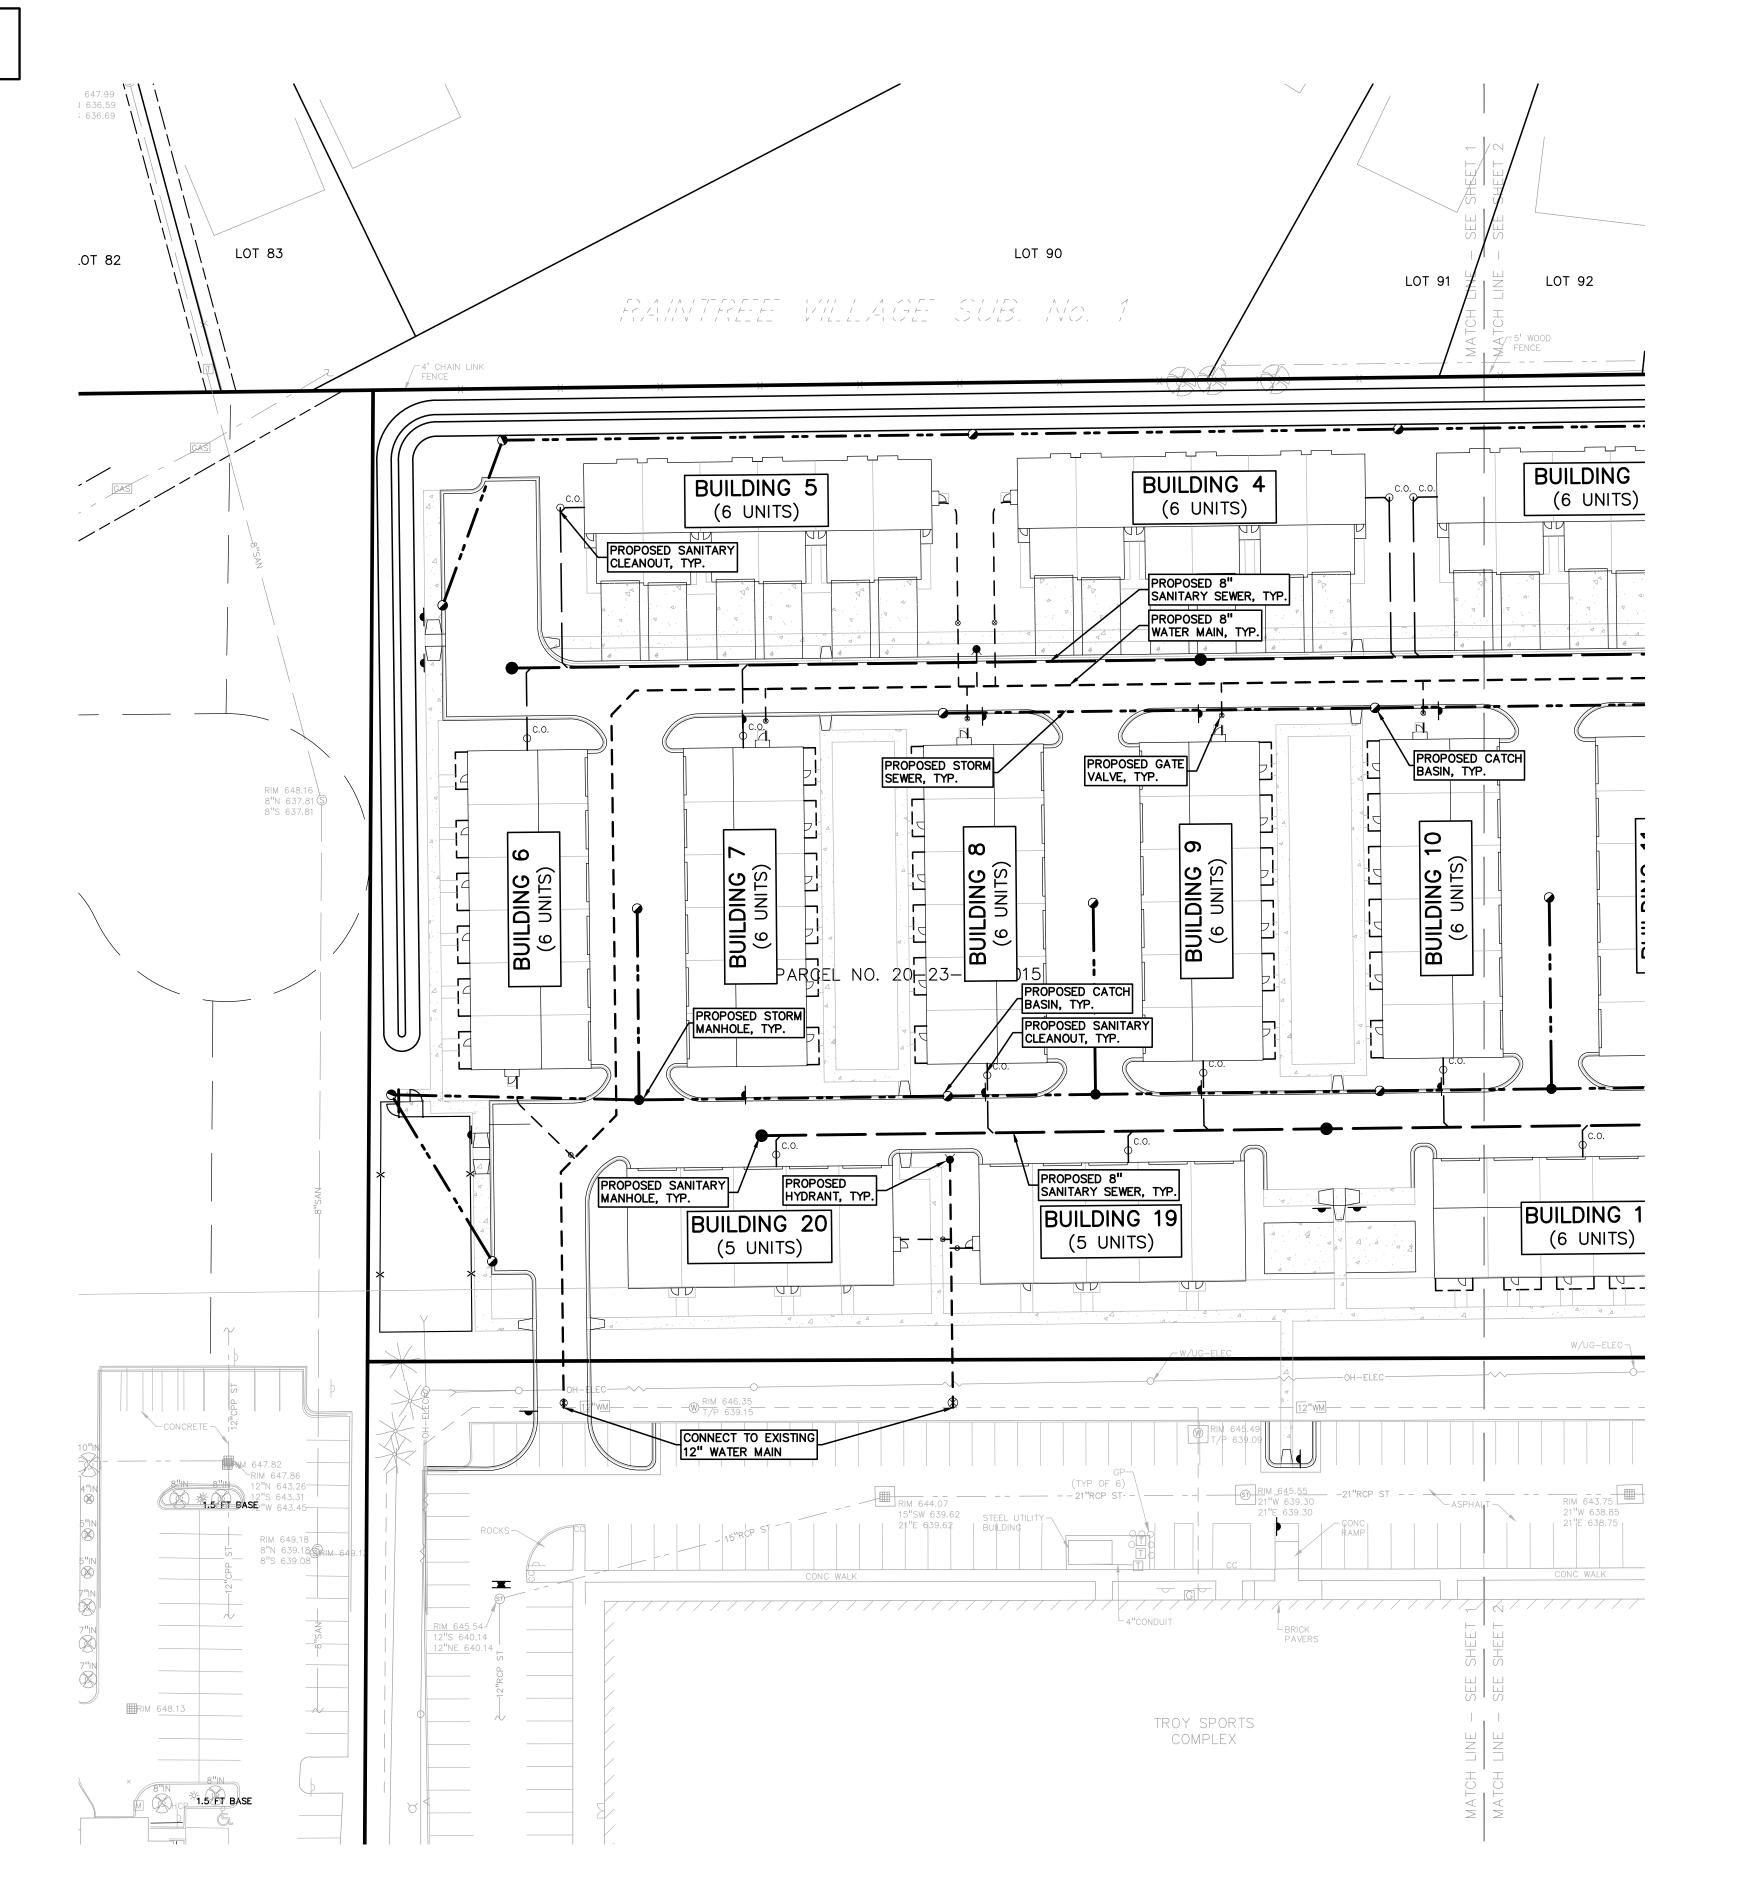PUBLIC UTILITY EASEMENTS:

ALL SANITARY SEWERS 8" AND LARGER IN DIAMETER ARE TO BE PUBLIC AND SHALL BE LOCATED IN A 20' WIDE EASEMENT. ALL WATER MAIN SHALL BE LOCATED IN A 20' WIDE EASEMENT.

UTILITY LEGEND:

-OH-ELEC-W-O- EX. OH. ELEC, POLE & GUY WIRE -UG-ELEC-E-E-EX. U.G. ELEC,MANHOLE, METER & HANDHOLE — – — – EX. GAS LINE © GAS EX. GAS VALVE & GAS LINE MARKER EX. TRANSFORMER & IRRIGATION VALVE — — EX. WATER MAIN ♥ - W EX. HYDRANT, GATE VALVE & POST INDICATOR VALVE

www.peagroup.com EX. SANITARY SEWER S EX. SANITARY CLEANOUT & MANHOLE EX. COMBINED SEWER MANHOLE EX. STORM SEWER EX. CLEANOUT & MANHOLE EX. SQUARE, ROUND, & BEEHIVE CATCH BASIN EX. YARD DRAIN & ROOF DRAIN

EX. UNIDENTIFIED STRUCTURE PROPOSED WATER MAIN PROPOSED HYDRANT AND GATE VALVE PROPOSED TAPPING SLEEVE, VALVE & WELL PROPOSED POST INDICATOR VALVE

PROPOSED SANITARY SEWER OC.O. PROPOSED SANITARY CLEANOUT & MANHOLE PROPOSED STORM SEWER ○ C.O. ■ PROPOSED STORM SEWER CLEANOUT & MANHOLE

PROPOSED CATCH BASIN, INLET & YARD DRAIN

GROUP



t: 844.813.2949







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CLIENT

TROY SPORTS CENTER, LLC 1819 EAST BIG BEAVER ROAD TTOY, MI 48083

PROJECT TITLE

JOHN R
COMMONS
TOWNHOME
DEVELOPMENT
PART OF THE SE 1/4 OF SECTION 23, T. 2N., R. 11E. TROY, OAKLAND COUNTY, MI

REVISIONS	
PA COMMENTS	11/8/23
PA COMMENTS	3/1/24
PA/PC COMMENTS	5/3/24
PA/PC COMMENTS	7/12/24

ORIGINAL ISSUE DATE: AUGUST 18, 2023

DRAWING TITLE

PRELIMINARY UTILITY PLAN

PEA JOB NO.	18-003
P.M.	GM
DN.	CNI
DES.	GM
DRAWING NUMBER:	

BENCHMARKS (GPS DERIVED - NAVD88) ARROW ON HYDRANT WEST SIDE JOHN R ROAD 11' OF B/CURB, AND 95' SOUTH OF NORTH PROPERTY LINE OF SITE. MAG NAIL ON NORTH SIDE OF CONCRETE LIGHT POLE BASE 21' SOUTH OF CENTERLINE NANCY BOSTICK DRIVE, AND 29' EAST OF ENTRANCE TO KROGER PARKING LOT FROM SAID DRIVE. ELEV. - 648.13 ARROW ON HYDRANT FLANGE 6' NORTH OF B/CURB FOR PARKING ALONG NANCY BOSTICK DRIVE, AND ±80' WEST OF EAST BUILDING LINE OF TROY SPORTS COMPLEX. ELEV. - 647.09 FLOODPLAIN NOTE:

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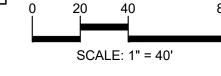
UTILITY LEGEND: OH-ELEC-W-O- EX. OH. ELEC, POLE & GUY WIRE UG-COMM---⊠-T- EX. U.G. COMMUNICATION LINE, PEDESTAL & MANHOL UG-ELEC-E-EKE- EX. U.G. ELEC,MANHOLE, METER & HANDHOLE EX. GAS LINE EX. GAS VALVE & GAS LINE MARKER EX. TRANSFORMER & IRRIGATION VALVE EX. WATER MAIN EX. HYDRANT, GATE VALVE & POST INDICATOR VALVE EX. WATER VALVE BOX & SHUTOFF EX. SANITARY SEWER EX. SANITARY CLEANOUT & MANHOLE EX. COMBINED SEWER MANHOLE EX, STORM SEWER EX. CLEANOUT & MANHOLE EX. SQUARE, ROUND, & BEEHIVE CATCH BASIN EX. YARD DRAIN & ROOF DRAIN EX. UNIDENTIFIED STRUCTURE PROPOSED WATER MAIN PROPOSED HYDRANT AND GATE VALVE PROPOSED TAPPING SLEEVE, VALVE & WELL PROPOSED POST INDICATOR VALVE PROPOSED SANITARY SEWER PROPOSED SANITARY CLEANOUT & MANHOLE PROPOSED STORM SEWER PROPOSED STORM SEWER CLEANOUT & MANHOLE

PROPOSED CATCH BASIN, INLET & YARD DRAIN











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CLIENT TROY SPORTS **CENTER, LLC** 1819 EAST BIG BEÁVER ROAD

TTOY, MI 48083

PROJECT TITLE JOHN R COMMONS TOWNHOME DEVELOPMENT


2N., R. 11E. TROY, OAKLAND COUNTY, MI

REVISIONS	
SPA COMMENTS	11/8/23
SPA COMMENTS	3/1/24
SPA/PC COMMENTS	5/3/24
SPA/PC COMMENTS	7/12/24
_	

ORIGINAL ISSUE DATE: AUGUST 18, 2023 DRAWING TITLE

PRELIMINARY UTILITY PLAN


PEA JOB NO.	18-0034
P.M.	GME
DN.	CNR
DES.	GME
DRAWING NUMBER:	

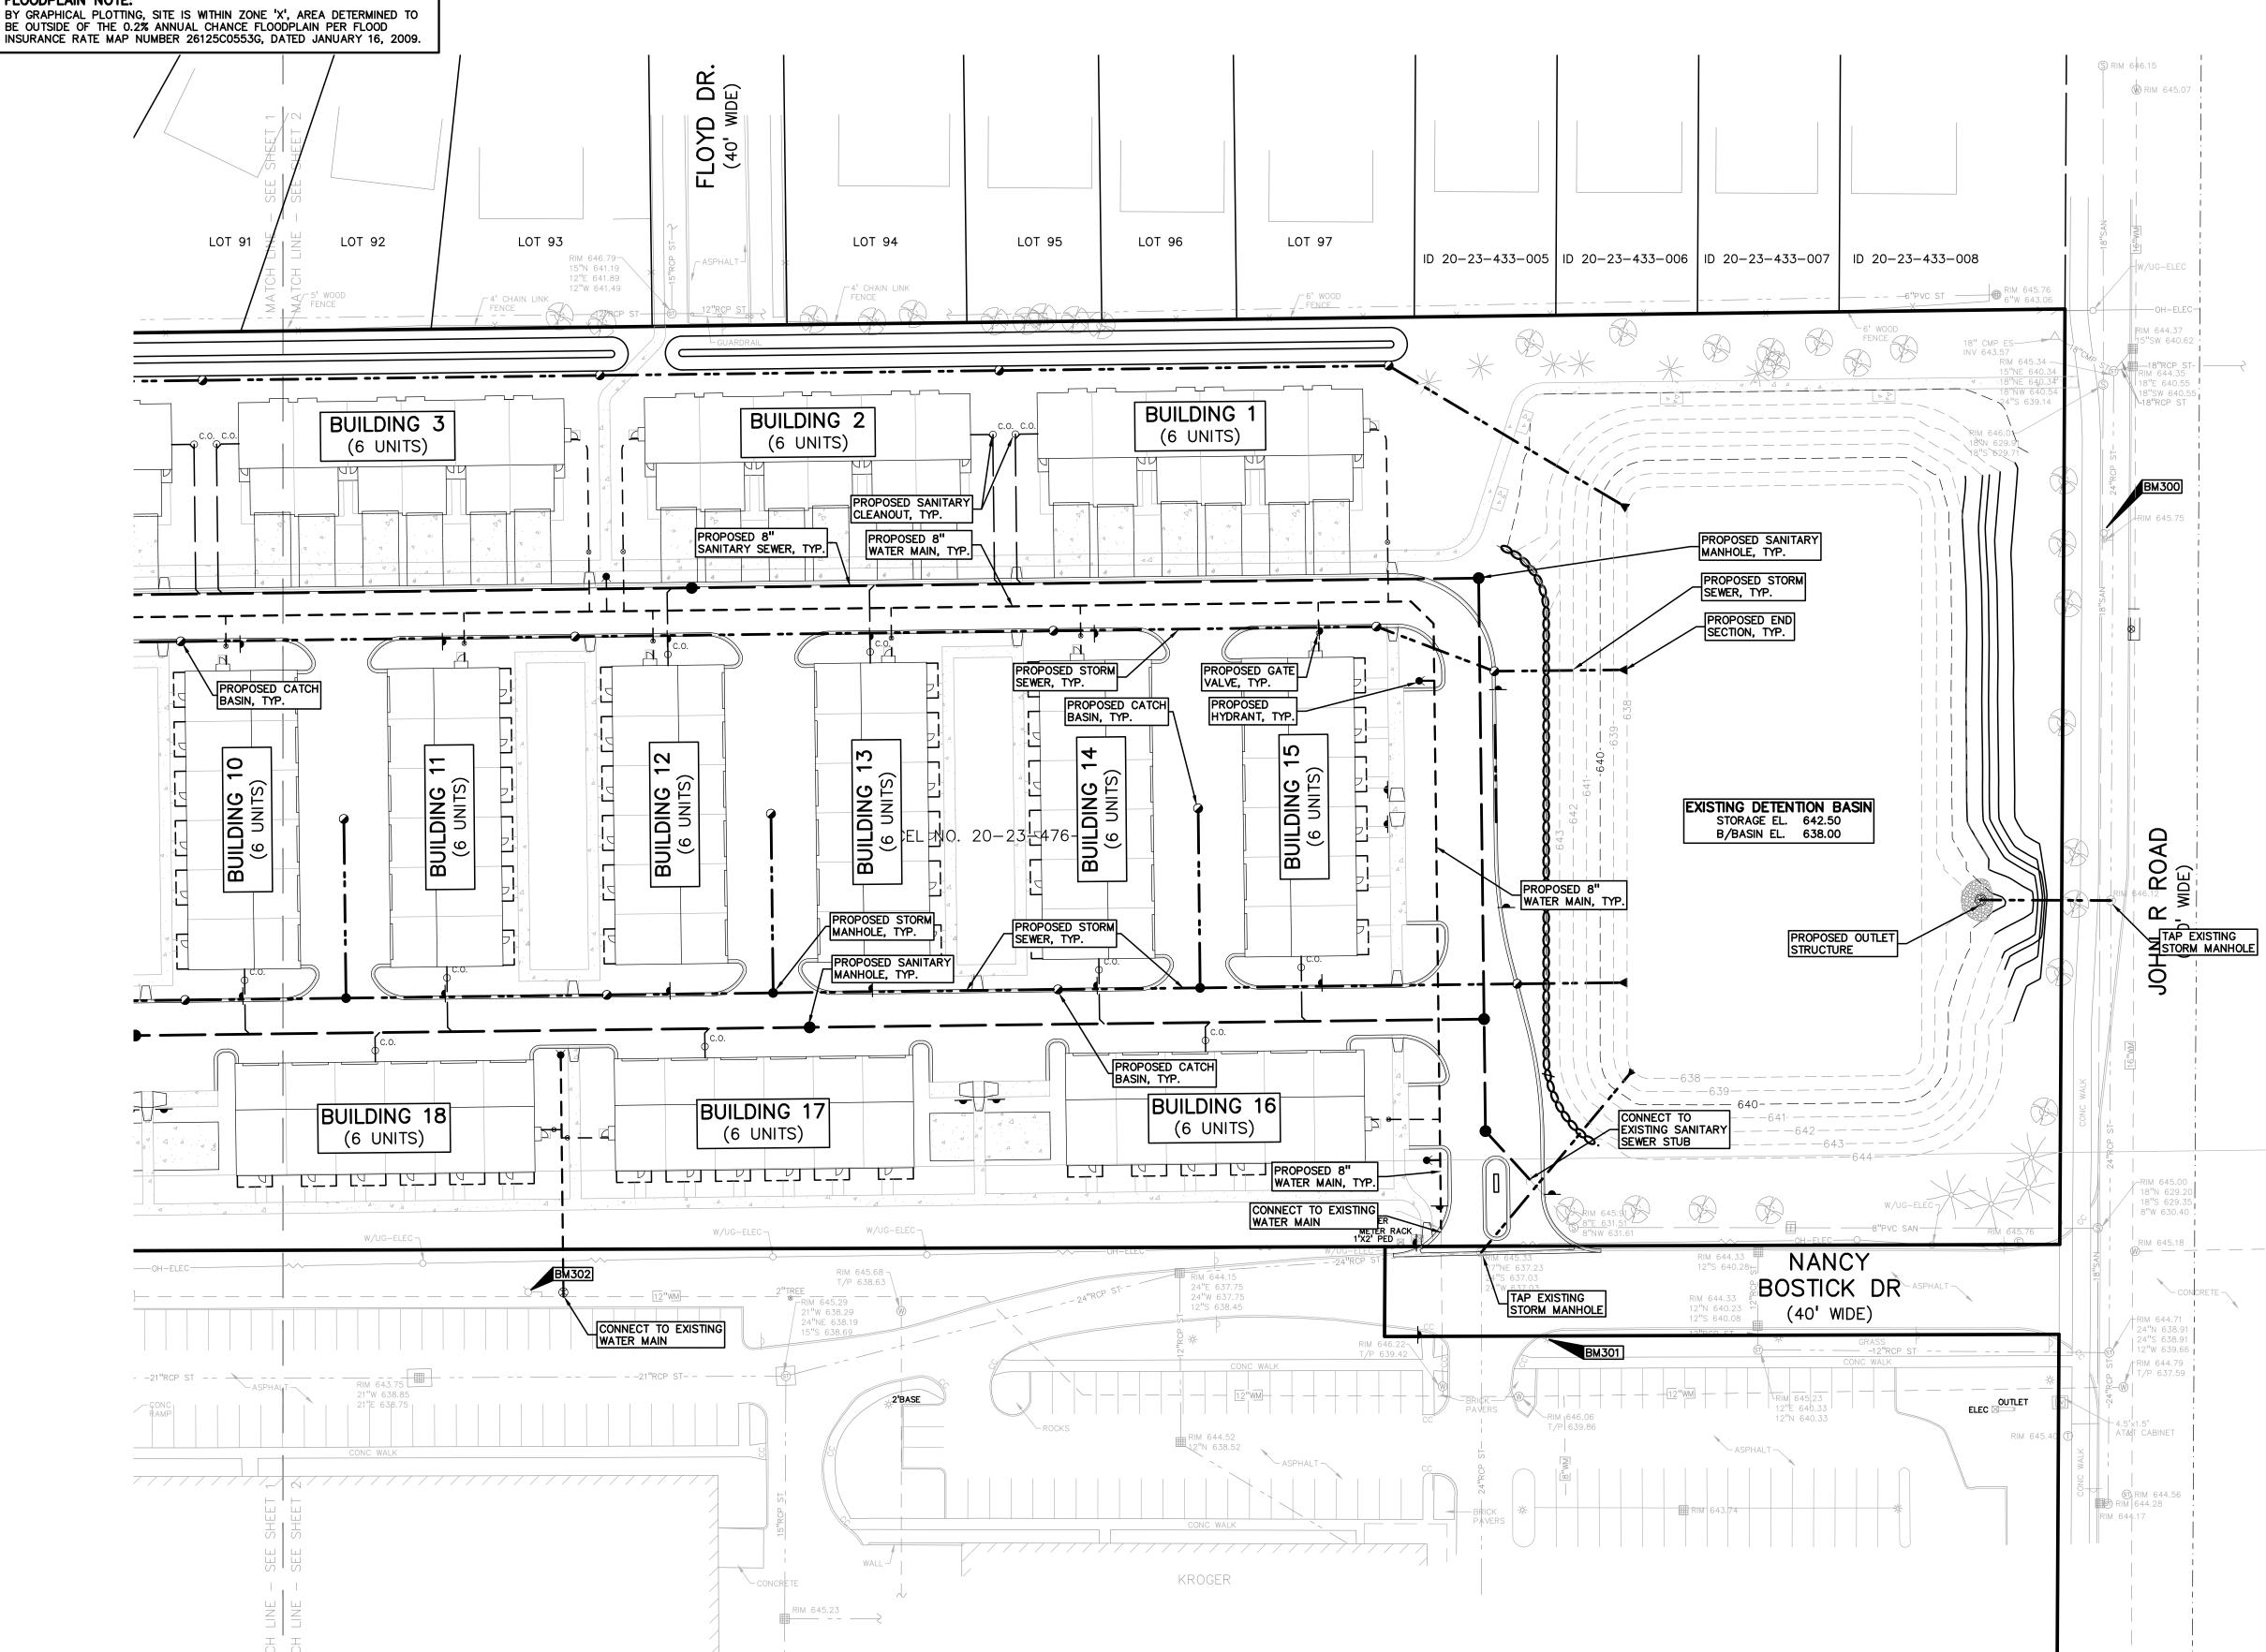

Rainfall Intensity Time of Concentration (Tc) 20.00 min Since 15<Tc<60, use intensity equation $11 = 30.2 / [(T + 9.17)^{\circ}.81]$ 1.97 in/hr $[110 = 50.12 / [(T + 9.17)^{.81}]$ 3.26 in/hr $1100 = 83.3/[(T + 9.17)^{.81}]$ 5.42 in/hr CPVC: Channel Protection Volume Control Volume Vcpvc = (4719)CA 43,095 cf CPRC: Channel Protection Rate Control Volume: Extended Detention VED= (6897)CA 62,985 cf **CPRC Allowable Outlet Rate** $Q_{VED} = V_{ED} / (48*60*60)$ 0.36 cfs Water Quality Control Forebay Volume = (545)CA 4,977 cf 0.03 cfs 100-Year Allowable Outlet Rate Since 2<A<100, Qvrr = 1.1055-0.206xln(A) 0.60 cfs/ac 100-Year Peak Allowable Discharge 11.86 ac Area, A = 7.07 cfs $Q_{100P} = Q_{VRR}(A)$ 100-Year Runoff Volume 173,376 cf V100R = (18,985)CA 100-Year Peak Inflow $Q_{100IN} = C(I_{100})A$ 49.50 cfs Storage Curve Factor (Vs/Vr) $R = 0.206-0.15 \times \ln(Q100P/Q100IN)$ 0.498 100-Year Storage Volume 86,341 cf Vs = R(V100R)Infiltration will be provided. CPVC can be deducted: V100 = Vs-Vcpvc EXISTING VOLUME FROM TROY SPORTS DEVELOPMENT 111,472 cf VTROYSPORTS = DETENTION VOLUME REQUIRED = 197,813 cf

CPRC Extende	CPRC Extended Detention: V _{ED} =			cf
CPRC Allowabl	CPRC Allowable Outlet Rate: Q _{VED} =			cfs
100-Year Stora	ige Volume, V ₁₀₀	_{0D} =	197,813	cf
100-Year Allow	able Outlet Rate	: Q _{VRR} =	7.07	cfs
100 Year Peak	Inflow: Q _{100IN} =		49.50	cfs
Detention Bas	in			
CPRC Storage	Elevation:	<u>639.62</u>	62,985	cf
100-yr Storage	Elevation:	<u>642.31</u>	197,813	cf
Elev. (ft)	Area (sf)	Vol. (cf)	Total Vol. (cf)	
638.00	34,362	0	0	
639.00	39,349	36,856	36,856	
640.00	44,758	42,054	78,909	
641.00	50,391	47,575	126,484	
642.00	56,439	53,415	179,899	
642.50	59,300	28,935	208,833	
643.50	freeboard	0	208,833	
Bottom Elevation			638.00	

Design Requirements

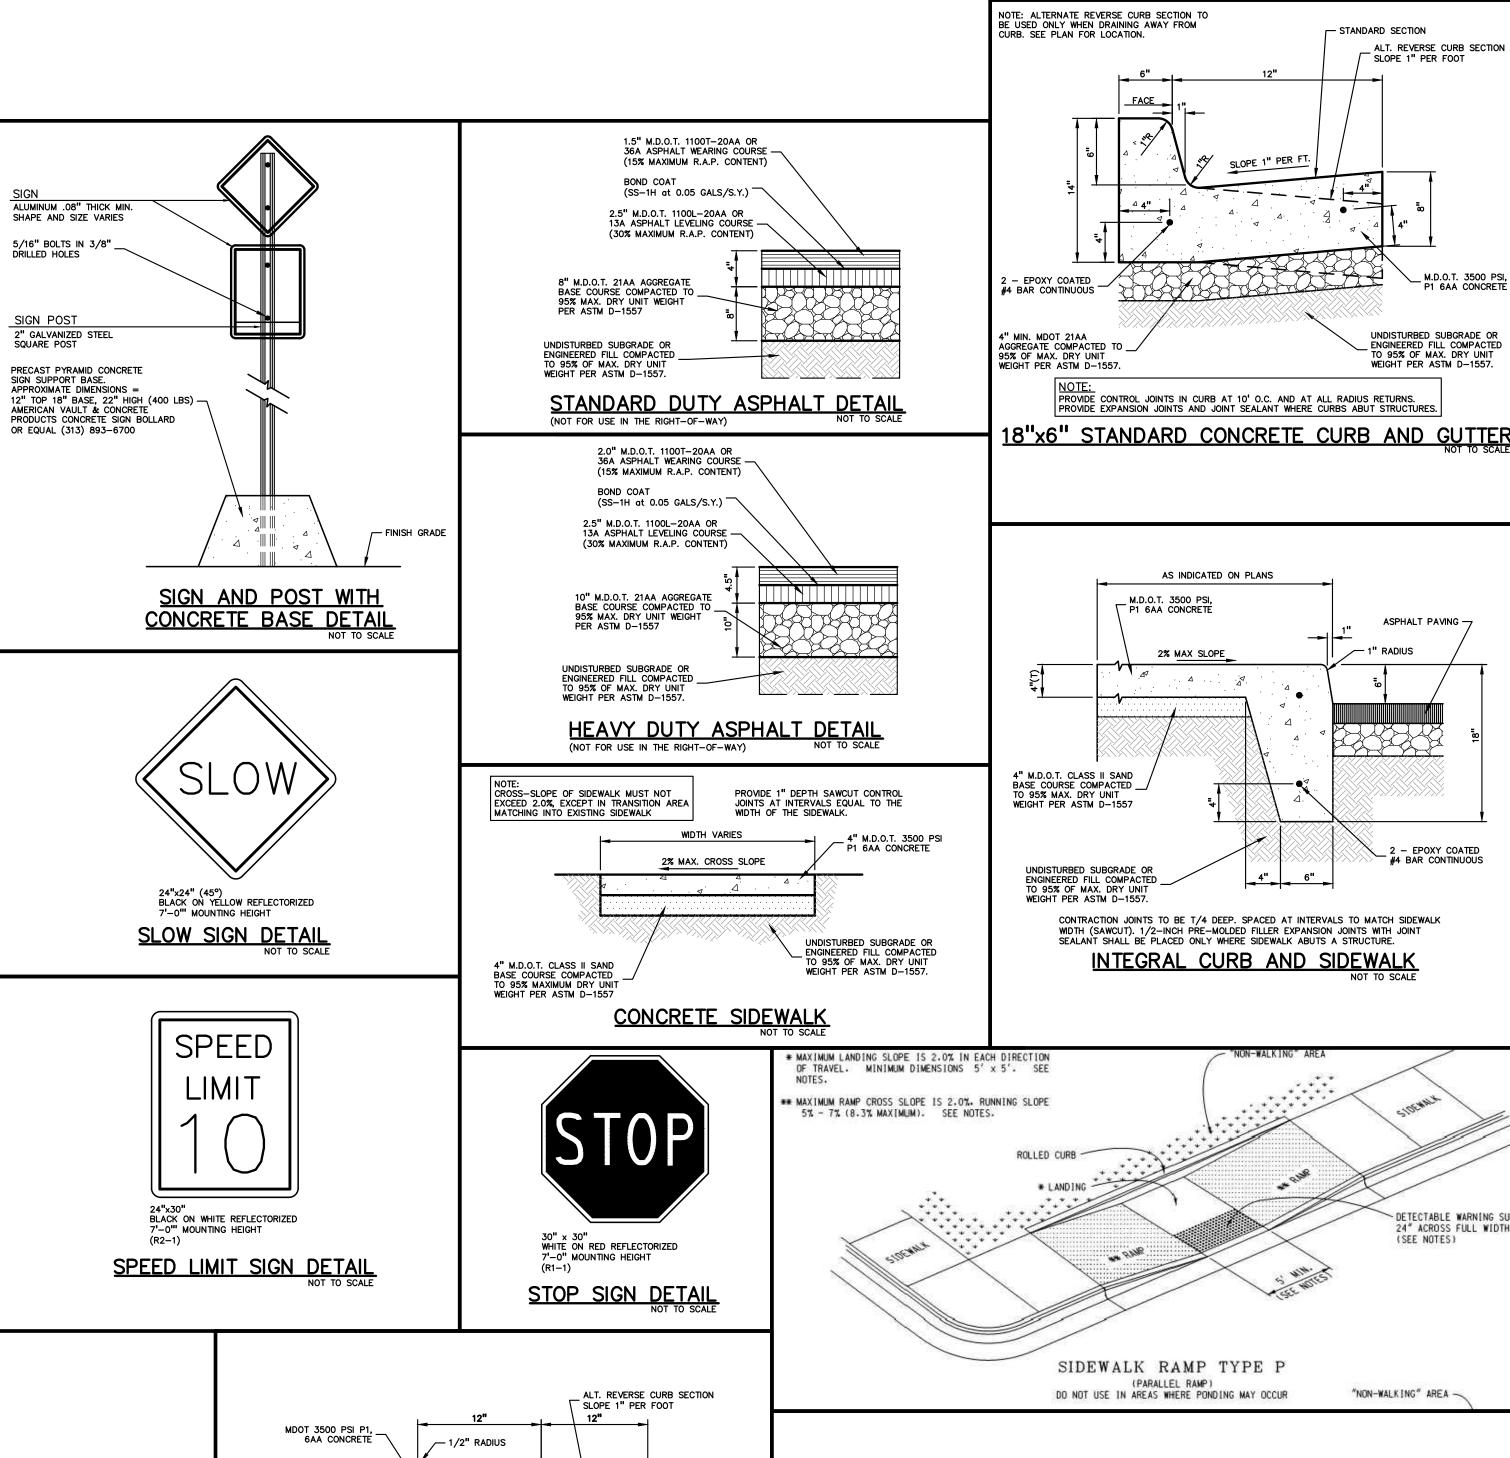

SLOPE\1" PER FT.

EPOXY COATED


PROVIDE CONTROL JOINTS IN CURB AT 10' O.C. PROVIDE EXPANSION JOINT AND JOINT SEALANT AT END OF RADIUS RETURNS PER MDOT AND ACA STANDARDS. PROVIDE EXPANSION JOINTS AND JOINT SEALANT WHERE CURBS ABUT STRUCTURES.

4" MOUNTABLE CURB AND GUTTER DETAIL

EXTEND AGGREGATE 12" BEYOND BACK — OF CURB

4" MIN. MDOT 21AA CRUSHED LIMESTONE COMPACTED TO 95% OF MAX. DRY UNIT WEIGHT PER ASTM D-1557.

COMPACTED SUBGRADE OR ENGINEERED FILL COMPACTED TO 95% OF MAX. DRY UNIT WEIGHT PER ASTM D-1557.

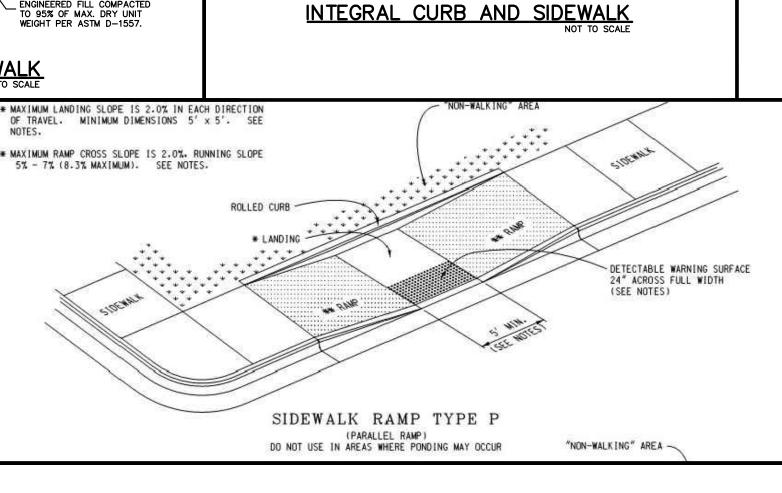

- STANDARD SECTION

SLOPE 1" PER FT.

PROVIDE CONTROL JOINTS IN CURB AT 10' O.C. AND AT ALL RADIUS RETURNS.
PROVIDE EXPANSION JOINTS AND JOINT SEALANT WHERE CURBS ABUT STRUCTURES.

AS INDICATED ON PLANS

CONTRACTION JOINTS TO BE T/4 DEEP. SPACED AT INTERVALS TO MATCH SIDEWALK WIDTH (SAWCUT). 1/2-INCH PRE-MOLDED FILLER EXPANSION JOINTS WITH JOINT

M.D.O.T. 3500 PSI, P1 6AA CONCRETE

2% MAX SLOPE

ALT. REVERSE CURB SECTION

M.D.O.T. 3500 PSI, P1 6AA CONCRETE


UNDISTURBED SUBGRADE OR ENGINEERED FILL COMPACTED TO 95% OF MAX. DRY UNIT


WEIGHT PER ASTM D-1557.


ASPHALT PAVING

- 1" RADIUS


SLOPE 1" PER FOOT

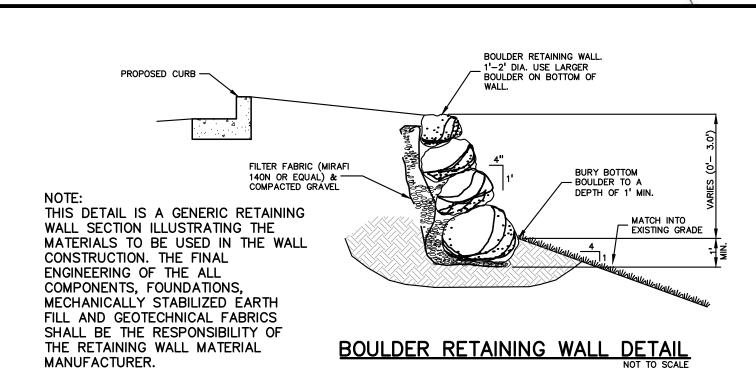


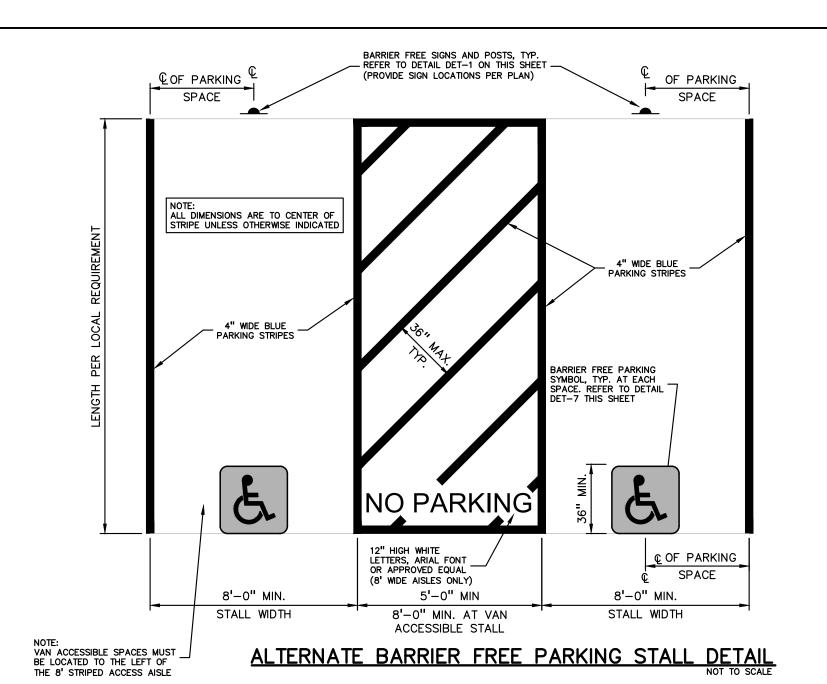

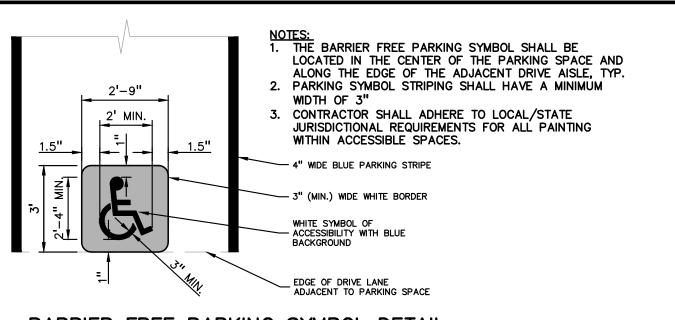

BARRIER FREE PARKING SYMBOL DETAIL (INTERNATIONAL SYMBOL OF ACCESSIBILITY)

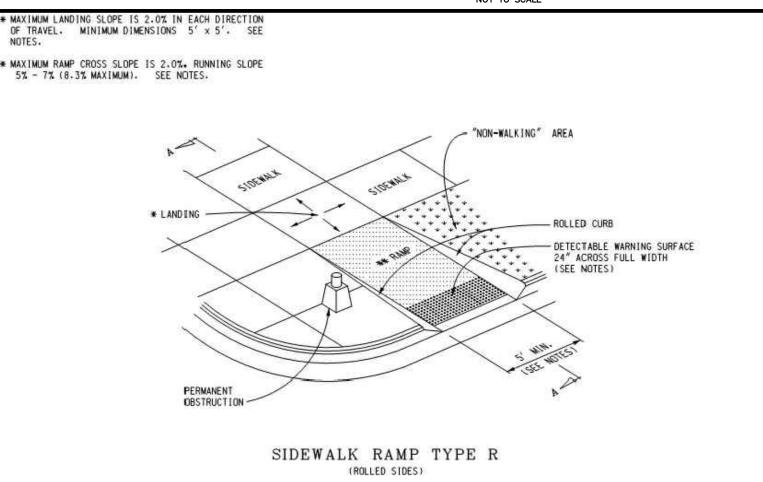

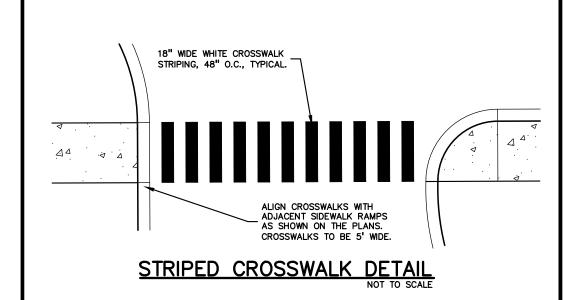

BARRIER FREE SIGN NOTES:

AND LOCAL REQUIREMENTS.

RESERVED

PARKING

ONLY


BARRIER FREE

PARKING SIGN DETAIL

NOT TO SCALE

GREEN BORDER AND LEGEND
WHITE SYMBOL, BLUE BACKGROUND.
REFLECTORIZED

- ONE SIGN IS REQUIRED AT EACH BARRIER FREE PARKING SPACE.
 ALL SIGNS SHALL COMPLY WITH THE LATEST STANDARDS OF THE MICHIGAN MANUAL OF UNIFORM TRAFFIC CONTROL DEVICES (MMUTCD).
- 3. WHEN TWO BARRIER FREE PARKING SPACES ARE ADJACENT AND FACING EACH OTHER, TWO SIGNS ARE REQUIRED, BUT CAN BE MOUNTED ON THE SAME POST.
- 4. SIGN POSTS SHALL BE 2" NOM. SQUARE 14-GAUGE GALVANIZED STEEL TUBE WITH 7/16" HOLES AT 1" CENTERS. POSTS SHALL TELESCOPE INSIDE ANCHOR POSTS A MINIMUM OF 12".
- 5. ANCHOR POSTS SHALL BE 2.25" NOM. SQUARE 12-GAUGE GALVANIZED STEEL POST, A MINIMUM OF 3 FEET LONG.
- 6. IF THESE NOTES AND DETAILS CONFLICT WITH LOCAL CODES AND ORDINANCES, THE STRICTER REQUIREMENT SHOULD BE USED. 7. ALTERNATE MATERIALS MAY BE USED IF IN COMPLIANCE WITH A.D.A. GUIDELINES

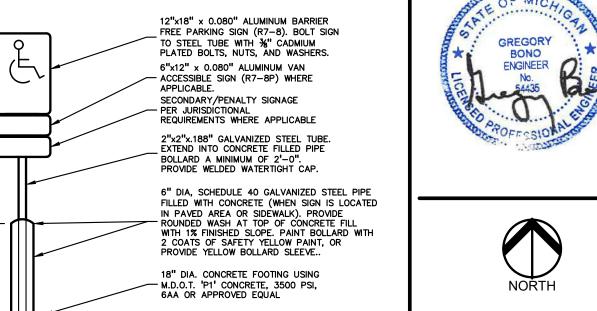



BARRIER FREE SIGN AND POST DETAIL
NOT TO SCALE CAUTION!! THE LOCATIONS AND ELEVATIONS OF EXISTING UNDERGROUND UTILITIES AS SHOWN ON THIS DRAWING ARE ONLY APPROXIMATE. NO GUARANTEE IS EITHER EXPRESSED OR IMPLIED AS TO THE COMPLETENESS OR ACCURACY THEREOF. THE CONTRACTOR SHALL BE EXCLUSIVELY RESPONSIBLE FOR DETERMINING THE EXACT UTILITY LOCATIONS AND ELEVATIONS PRIOR TO THE START OF CONSTRUCTION. **RESERVED**

> CLIENT TROV SPORTS PARKING SIGN DETAIL
>
> NOT TO SCALE INUI SEUNIS

> > PROJECT TITLE JOHN R

> > > **DEVELOPMENT** PART OF THE SE 1/4 OF SECTION 23, 1 2N., R. 11E. TROY, OAKLAND COUNTY, MI

SPA COMMENTS3/1/2SPA/PC COMMENTS5/3/2		
SPA COMMENTS 3/1/2 SPA/PC COMMENTS 5/3/2	REVISIONS	
SPA/PC COMMENTS 5/3/2	SPA COMMENTS	11/8/2
	SPA COMMENTS	3/1/2
SPA/PC COMMENTS 7/12/2	SPA/PC COMMENTS	5/3/2
	SPA/PC COMMENTS	7/12/2


ORIGINAL ISSUE DATE: AUGUST 18, 2023

18-0034 PEA JOB NO. GMB CNR DES. GMB DRAWING NUMBER:

C-5.0

NOTE: ALTERNATE REVERSE CURB SECTION TO BE USED ONLY WHEN DRAINING AWAY FROM CURB. SEE PLANS FOR LOCATION. REDUCE GUTTER PAN SLOPE TO 1.0% TARGET SLOPE (2.0% MAX) AT BARRIER FREE PARKING SPACE LOCATIONS - STANDARD SECTION FACE - ALT. REVERSE CURB SECTION SLOPE AT 1.0% OR 1/8" PER FT. SUBGRADE OR ENGINEERED — FILL COMPACTED TO 95% OF MAX. DENSITY ASTM D-1557. 4" MDOT 21AA AGGREGATE COMPACTED TO 95% DRY — DENSITY ASTM D-1557. MODIFIED CURB AND GUTTER SECTION FOR BARRIER FREE PARKING AREAS SIDEWALK RAMP AT LEAST 5%-7% SLOPE -ROLLED CURB, TAPER FROM ZERO TO 6" CURB HEIGHT ALONG RAMP LENGTH (MAX. SLOPE 8.3%) STANDARD 6" HIGH CONCRETE CURB AND —/ GUTTER SECTION — CONCRETE CURB AND GUTTER SECTION TRANSITION FROM STANDARD CURB SECTION TO MODIFIED CURB SECTION — REQUIRED AT BARRIER FREE AREAS TRANSITION FROM STANDARD CURB SECTION TO MODIFIED CURB SECTION REQUIRED AT BARRIER FREE AREAS DETECTABLE WARNING (AS MODIFIED CONCRETE CURB AND GUTTER SECTION WITH REDUCED GUTTER SLOPE TO MEET A.D.A. REQUIREMENTS REQUIRED). REFER TO PLANS FOR -DETECTABLE WARNING LOCATIONS TYPICAL SIDEWALK RAMP PLAN VIEW (A) THE STANDARD A.D.A. PARKING SPACE WIDTH OF 8.0' SHALL BE MEASURED FROM CENTER OF STRIPING AND OR TO THE CURB FACE (WHERE SPACES ARE DIMENSIONED TO CURB FACE). ENSURE THE PARKING SURFACE IS A.D.A. COMPLIANT BY PROVIDING THE MODIFIED CURB AND GUTTER SECTION ABOVE (B) THE A.D.A. PARKING SPACE LENGTH SHALL BE MEASURED FROM CENTER OF STRIPING AND/OR TO

THE CURB FACE. TO ENSURE THE
PARKING SPACE IS A.D.A.
COMPLIANT. REFER TO MODIFIED
CURB AND GUTTER DETAIL ABOVE TYPICAL BARRIER FREE PARKING SPACES MODIFIED 18"x6" CONCRETE CURB AND GUTTER DETAIL TO BE USED IN BARRIER FREE AREAS

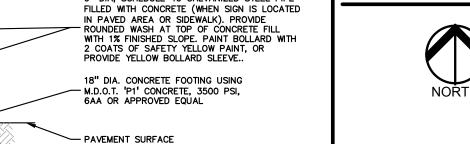

PARKING

ONLY

ACCESSIBLE

VAN ACCESSIBLE

GREEN BORDER AN

LEGEND WHITE SYMBOL, BLUE BACKGROUND. REFLECTORIZED

6" x 12" (R7-8P) GREEN BORDER AND

LEGEND REFLECTORIZED

MAY ONLY BE USED AT 11' WDE SPACES LOCATED ON THE LEFT SIDE OF A

5' WDE AISLE, OR 8' WIDE SPACES LOCATED TO THE LEFT OF 8' WDE AISLES

INSTALL BREAKAWAY TUBE POST - IN SIGN LOCATIONS WHERE PIPE BOLLARD IS NOT REQUIRED.



t: 844.813.2949


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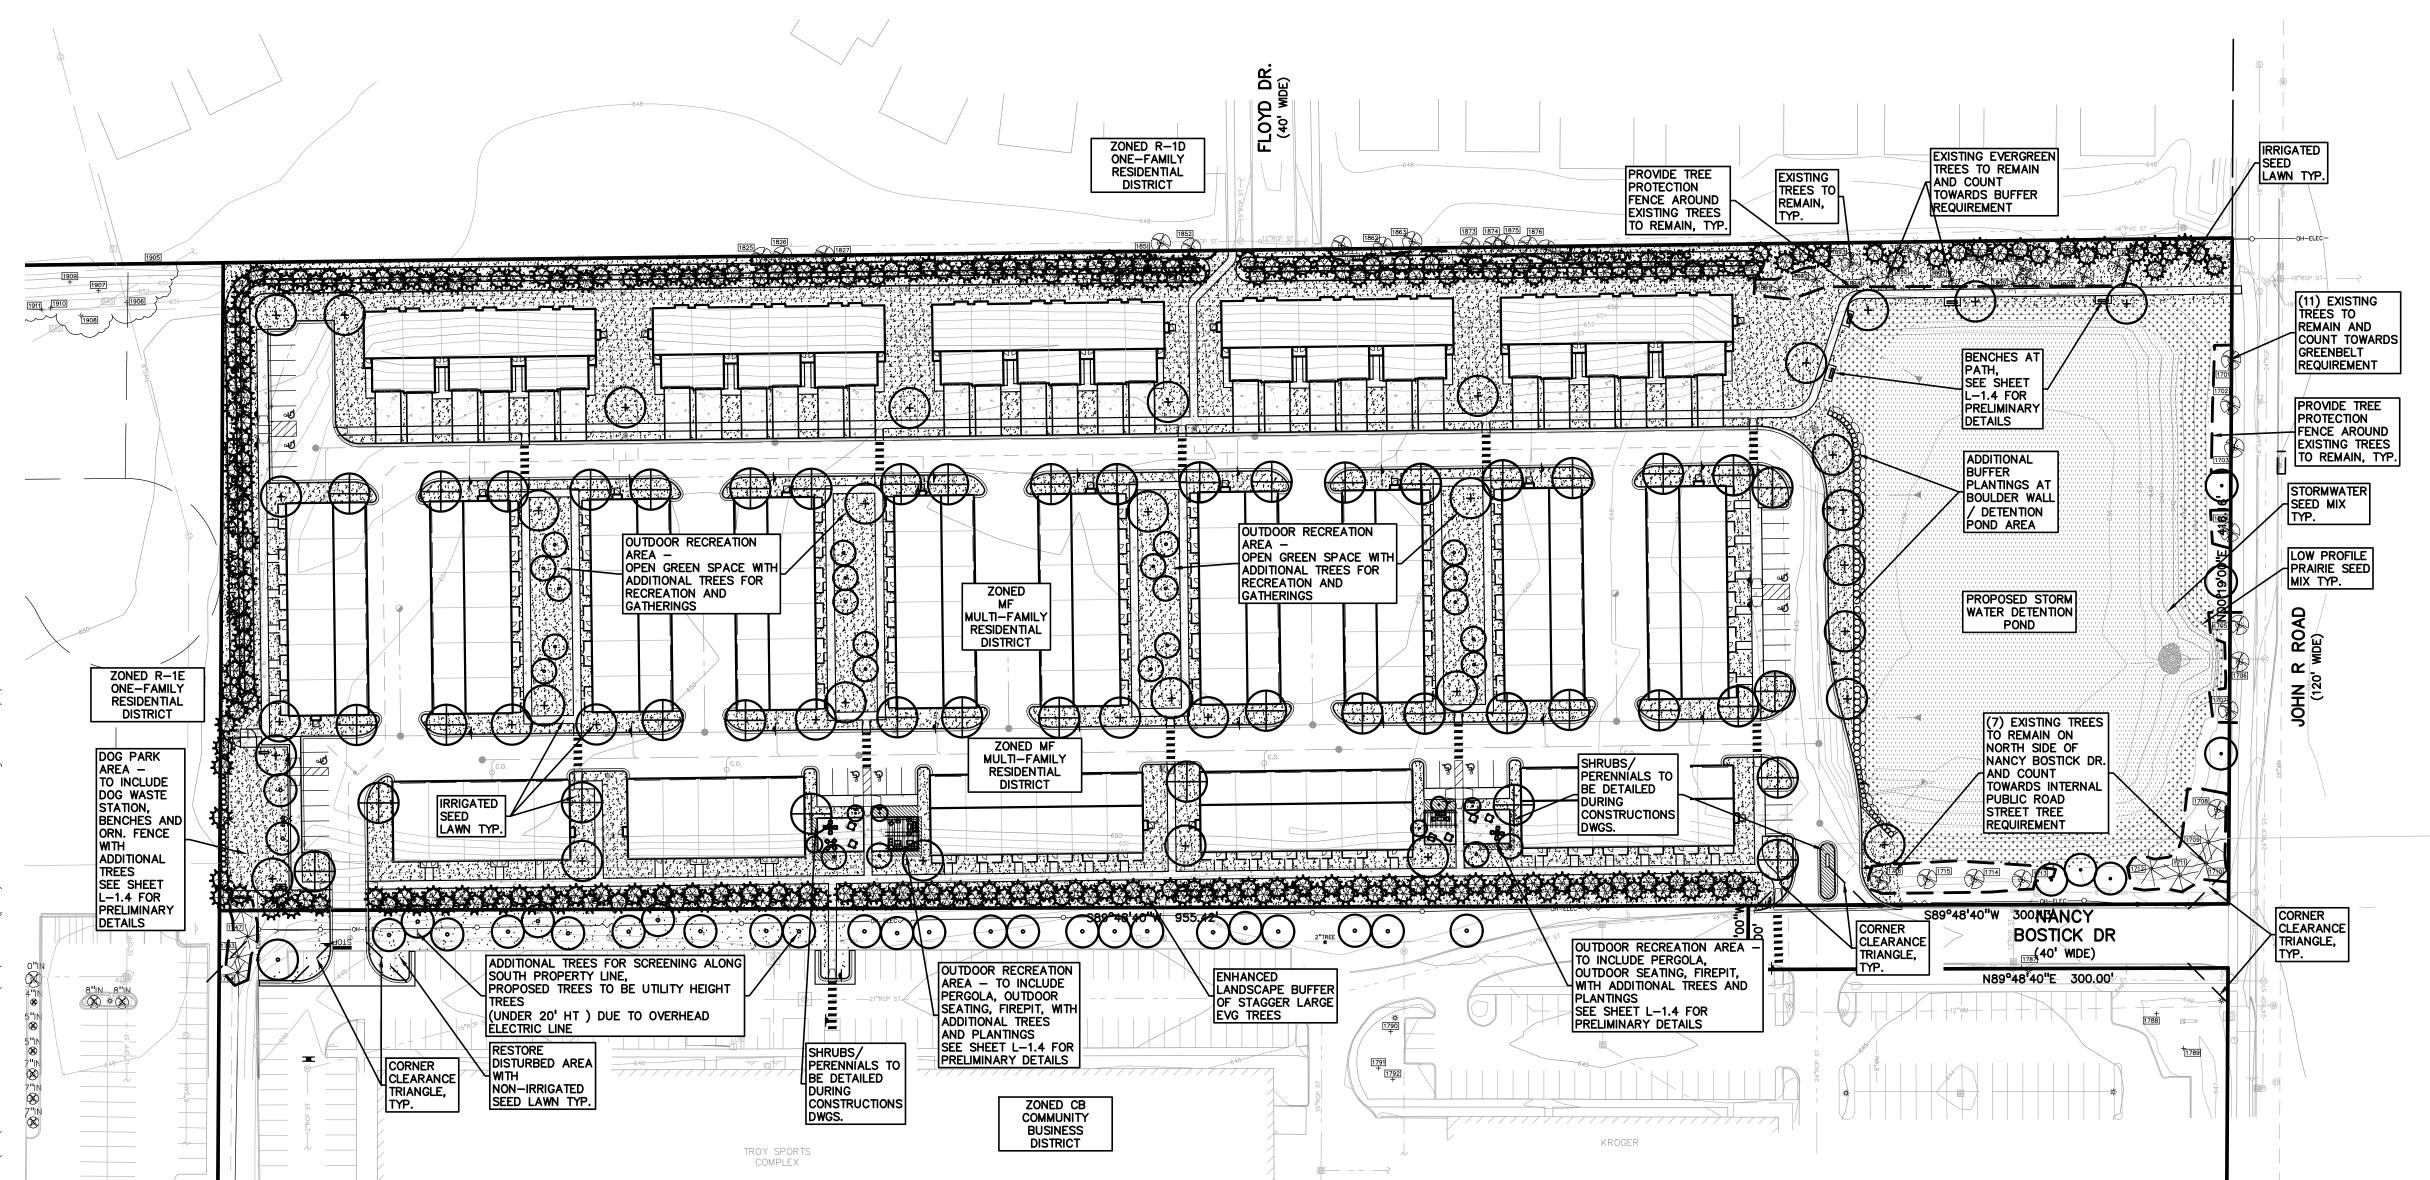
CENTER, LLC

COMMONS TOWNHOME


DRAWING TITLE **NOTES AND DETAILS**

NOT FOR CONSTRUCTION



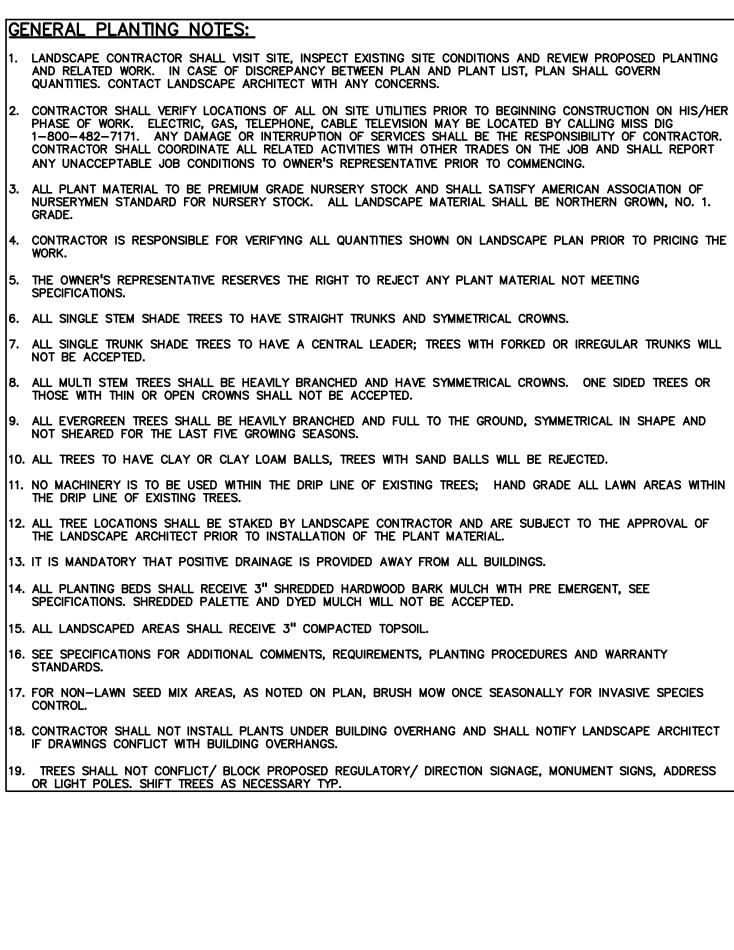

8"IN &

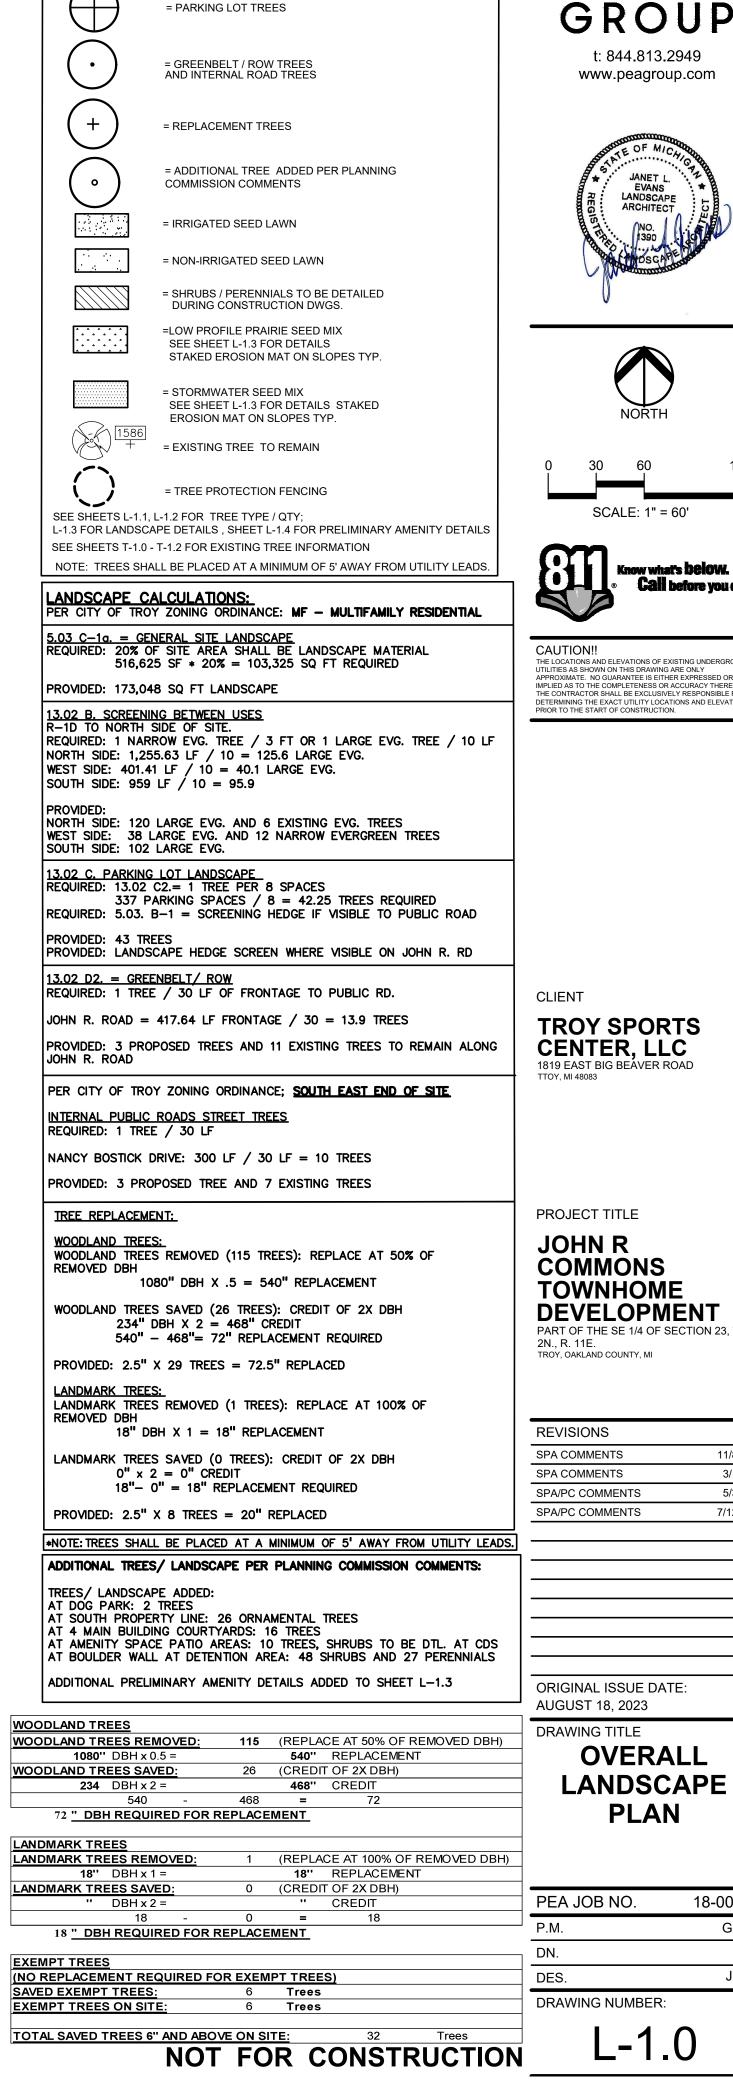

= BUFFER TREES / EVERGREEN SCREENING

BETWEEN USES

www.peagroup.com





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11/8/23 3/1/24 5/3/24 7/12/24

18-0034 GMB ΒZ JLE

DECIDUO	US TREE PL	ANT LIST:			
QUANTITY	KEY SYMBOL	COMMON NAME	SCIENTIFIC NAME	SIZE	SPEC
5	AL8	Allegheny Serviceberry	Amelanchier laevis	8' Ht.	В&В
1	AR2.5	Bowhall Maple	Acer rubrum 'Bowhall'	2.5" Cal.	B&B
1	AS2.5	Green Mountian Sugar Maple	Acer saccharum 'Green Mountain'	2.5" Cal.	B&B
7	CC8	Ace of Heart Eastern Redbud	Cercis canadensis 'Ace of Heart'	8' Ht.	B&B
5	HI8	Arnold Promise Witch Hazel	Hamamelis x intermedia 'Arnold Promise'	8' Ht.	B&B
1	LS2.5	Slender Silhouette Sweetgum	Liquidambar styraciflua 'Slender Silhouette'	2.5" Cal.	В&В
7	MR2.5	Red Jewel Crabapple	Malus 'Red Jewel'	2.5" Cal.	В&В
2	QS2.5	Streetspire Oak	Quercus alba 'JFS-KW1QX' (columnar)	2.5" Cal.	B&B
4	SR2.5	Japanese Tree Lilac	Syringa reticulata	2.5" Cal.	в&в
33	TOTAL DEC.				
SHRUB P	LANT LIST:				
QUANTITY	KEY SYMBOL	COMMON NAME	SCIENTIFIC NAME	SIZE	SPEC
12	JH6	Hetz Columnar Juniper	Juniperus chinensis 'Hetzii Columnaris'	6'	B&B
12	TOTAL SHRUE	BS			

ZONED R-1E ONE-FAMILY RESIDENTIAL DISTRICT

DOG PARK AREA — TO INCLUDE DOG WASTE STATION, BENCHES AND ORN. FENCE WITH

ADDITIONAL TREES
SEE SHEET L-1.4
FOR PRELIMINARY
DETAILS

QUANTITY	KEYSYMBOL	COMMON NAME	SCIENTIFIC NAME	SIZE	SPEC
2	AR2.5	Bowhall Maple	Acer rubrum 'Bowhall'	2.5" Cal.	B&B
2	AS2.5	Green Mountian Sugar Maple	Acer saccharum 'Green Mountain'	2.5" Cal.	B&B
8	GT2.5	Skyline Honeylocust	Gleditsia triacanthos 'Skyline' Inermis	2.5" Cal.	B&B
4	PA2.5	Encore London Planetree	Platanus x acerifolia 'Encore'	2.5" Cal.	B&B
4	QR2.5	Red Oak	Quercus rubra	2.5" Cal.	B&B
8	TC2.5	Greenspire Linden	Tilia cordata 'Greenspire'	2.5" Cal.	B&B
8	UF2.5	Frontier Elm	Ulmus 'Frontier'	2.5" Cal.	B&B
36	TOTAL DEC.				
EVERGRE	EN TREE PL	ANT LIST:			
QUANTITY	KEY SYMBOL	COMMON NAME	SCIENTIFIC NAME	SIZE	SPEC
19	PA8	Norway Spruce	Picea abies	8' Ht.	B&B
32	PG8	Black Hills Spruce	Picea glauca 'Densata'	8' Ht.	B&B
34	PO8	Serbian Spruce	Picea omorika	8' Ht.	B&B
27	PM8	Douglas Fir	Pseudotsuga menziesii	8' Ht.	B&B
5	PS8	Eastern White pine	Pinus strobus	8' Ht.	B&B
10	TC8	Canadian Hemlock	Tsuga canadensis	8' Ht.	B&B
127	TOTAL EVG.				

BUILDING 5


(6 UNITS)

IRRIGATED SEED LAWN TYP.

RESTORE DISTURBED AREA WITH NON-IRRIGATED SEED LAWN TYP.

BUILDING 20 (5 UNITS)

CORNER CLEARANCE TRIANGLE, TYP.

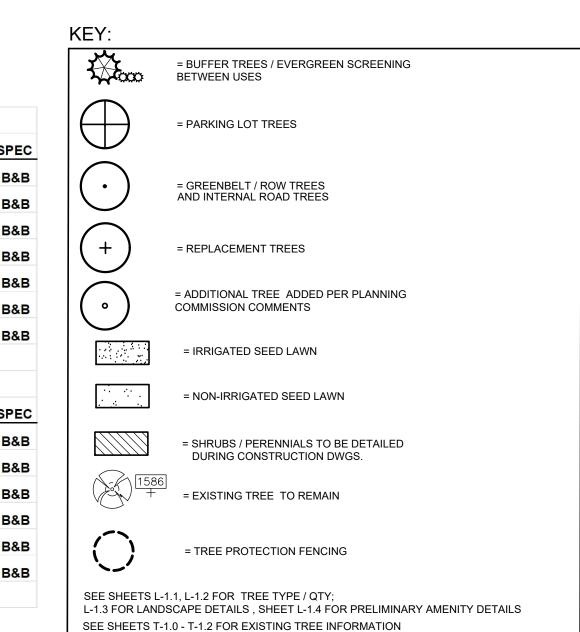

NOTE: TREES SHALL BE PLACED AT A MINIMUM OF 5' AWAY FROM UTILITY LEADS.

BUILDING 4


(6 UNITS)


OUTDOOR RECREATION AREA —
OPEN GREEN SPACE WITH ADDITIONAL
TREES FOR RECREATION AND


SHRUBS/ PERENNIALS TO BE DETAILED DURING CONSTRUCTIONS DWGS.

OUTDOOR RECREATION AREA —
TO INCLUDE PERGOLA, OUTDOOR
SEATING, FIREPIT, WITH
ADDITIONAL TREES AND
PLANTINGS
SEE SHEET L—1.4 FOR
PRELIMINARY DETAILS

ADDITIONAL TREES FOR SCREENING ALONG SOUTH PROPERTY LINE, PROPOSED TREES TO BE UTILITY HEIGHT TREES (UNDER 20' HT) DUE TO OVERHEAD ELECTRIC LINE

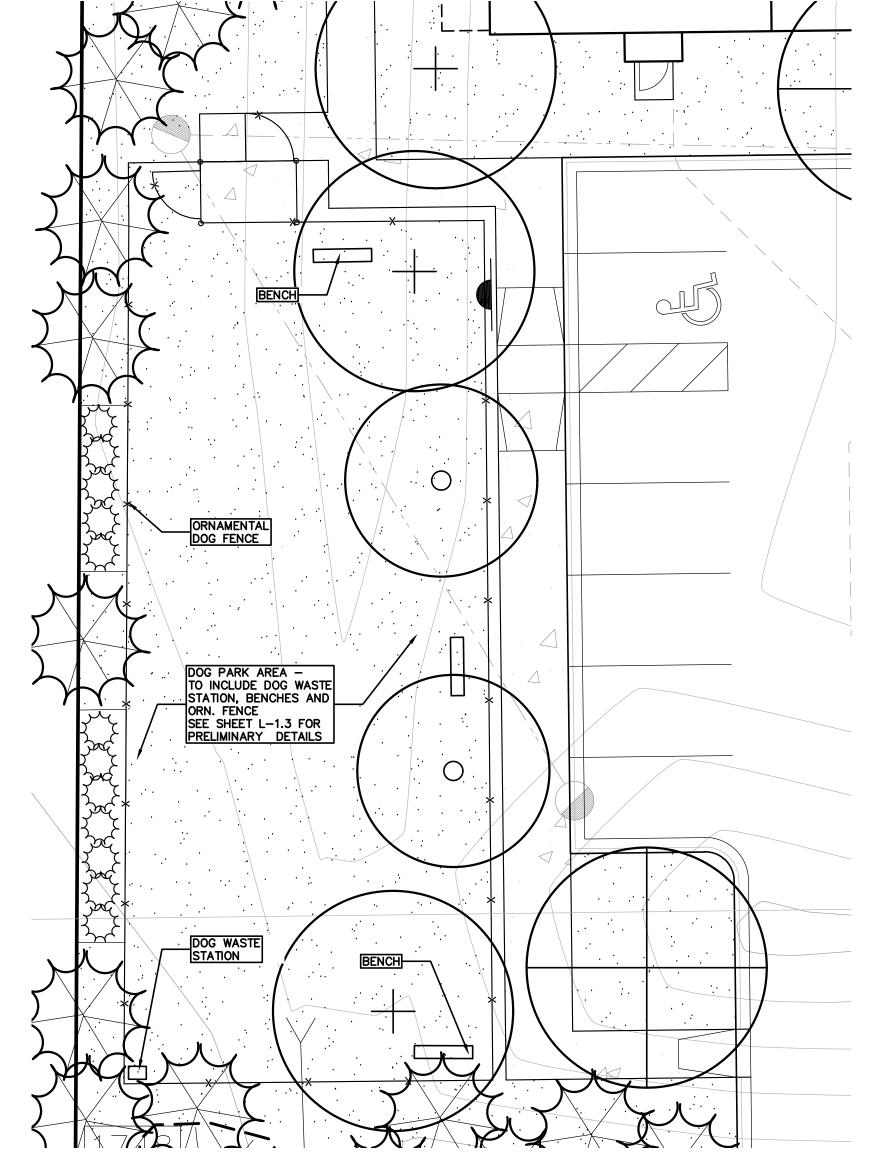

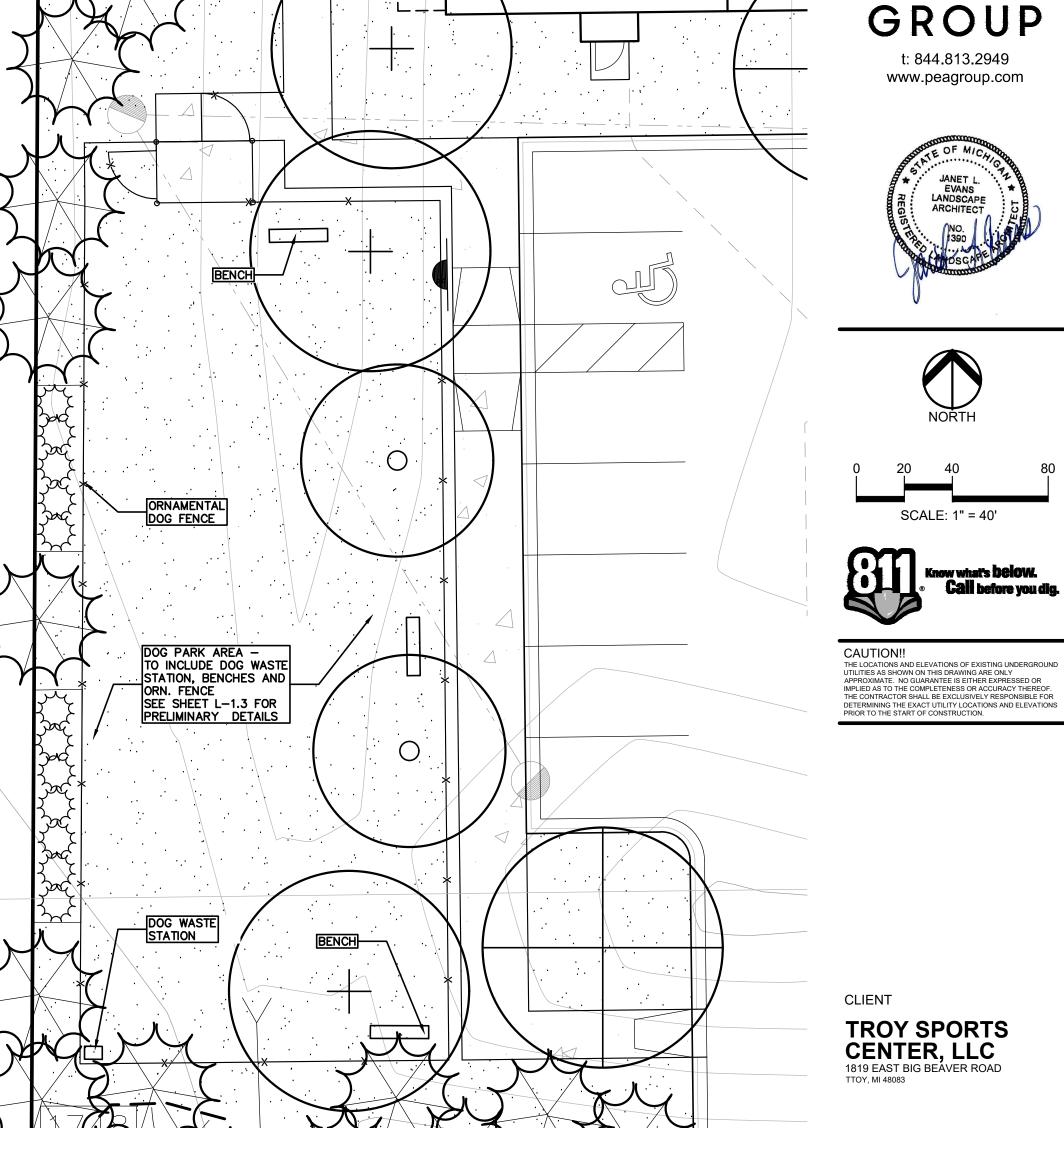

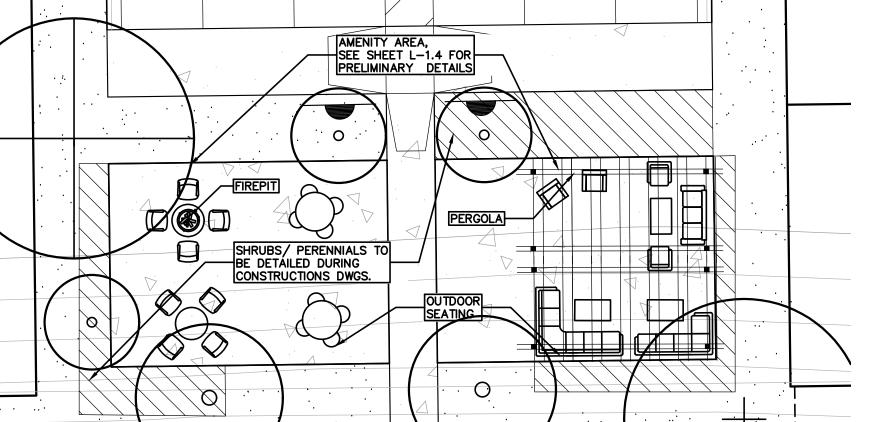

OUTDOOR RECREATION AREA

DOG PARK

SCALE: 1" = 10'-0"

PROJECT TITLE **JOHN R** COMMONS
TOWNHOME
DEVELOPMENT
PART OF THE SE 1/4 OF SECTION 23, T.


2N., R. 11E.
TROY, OAKLAND COUNTY, MI


REVISIONS SPA COMMENTS 11/8/23 SPA COMMENTS 3/1/24 5/3/24 SPA/PC COMMENTS SPA/PC COMMENTS 7/12/24


ORIGINAL ISSUE DATE: AUGUST 18, 2023


DRAWING TITLE **PRELIMINARY** LANDSCAPE **PLAN - WEST**


18-0034 PEA JOB NO. GMB ΒZ JLE DES. DRAWING NUMBER:

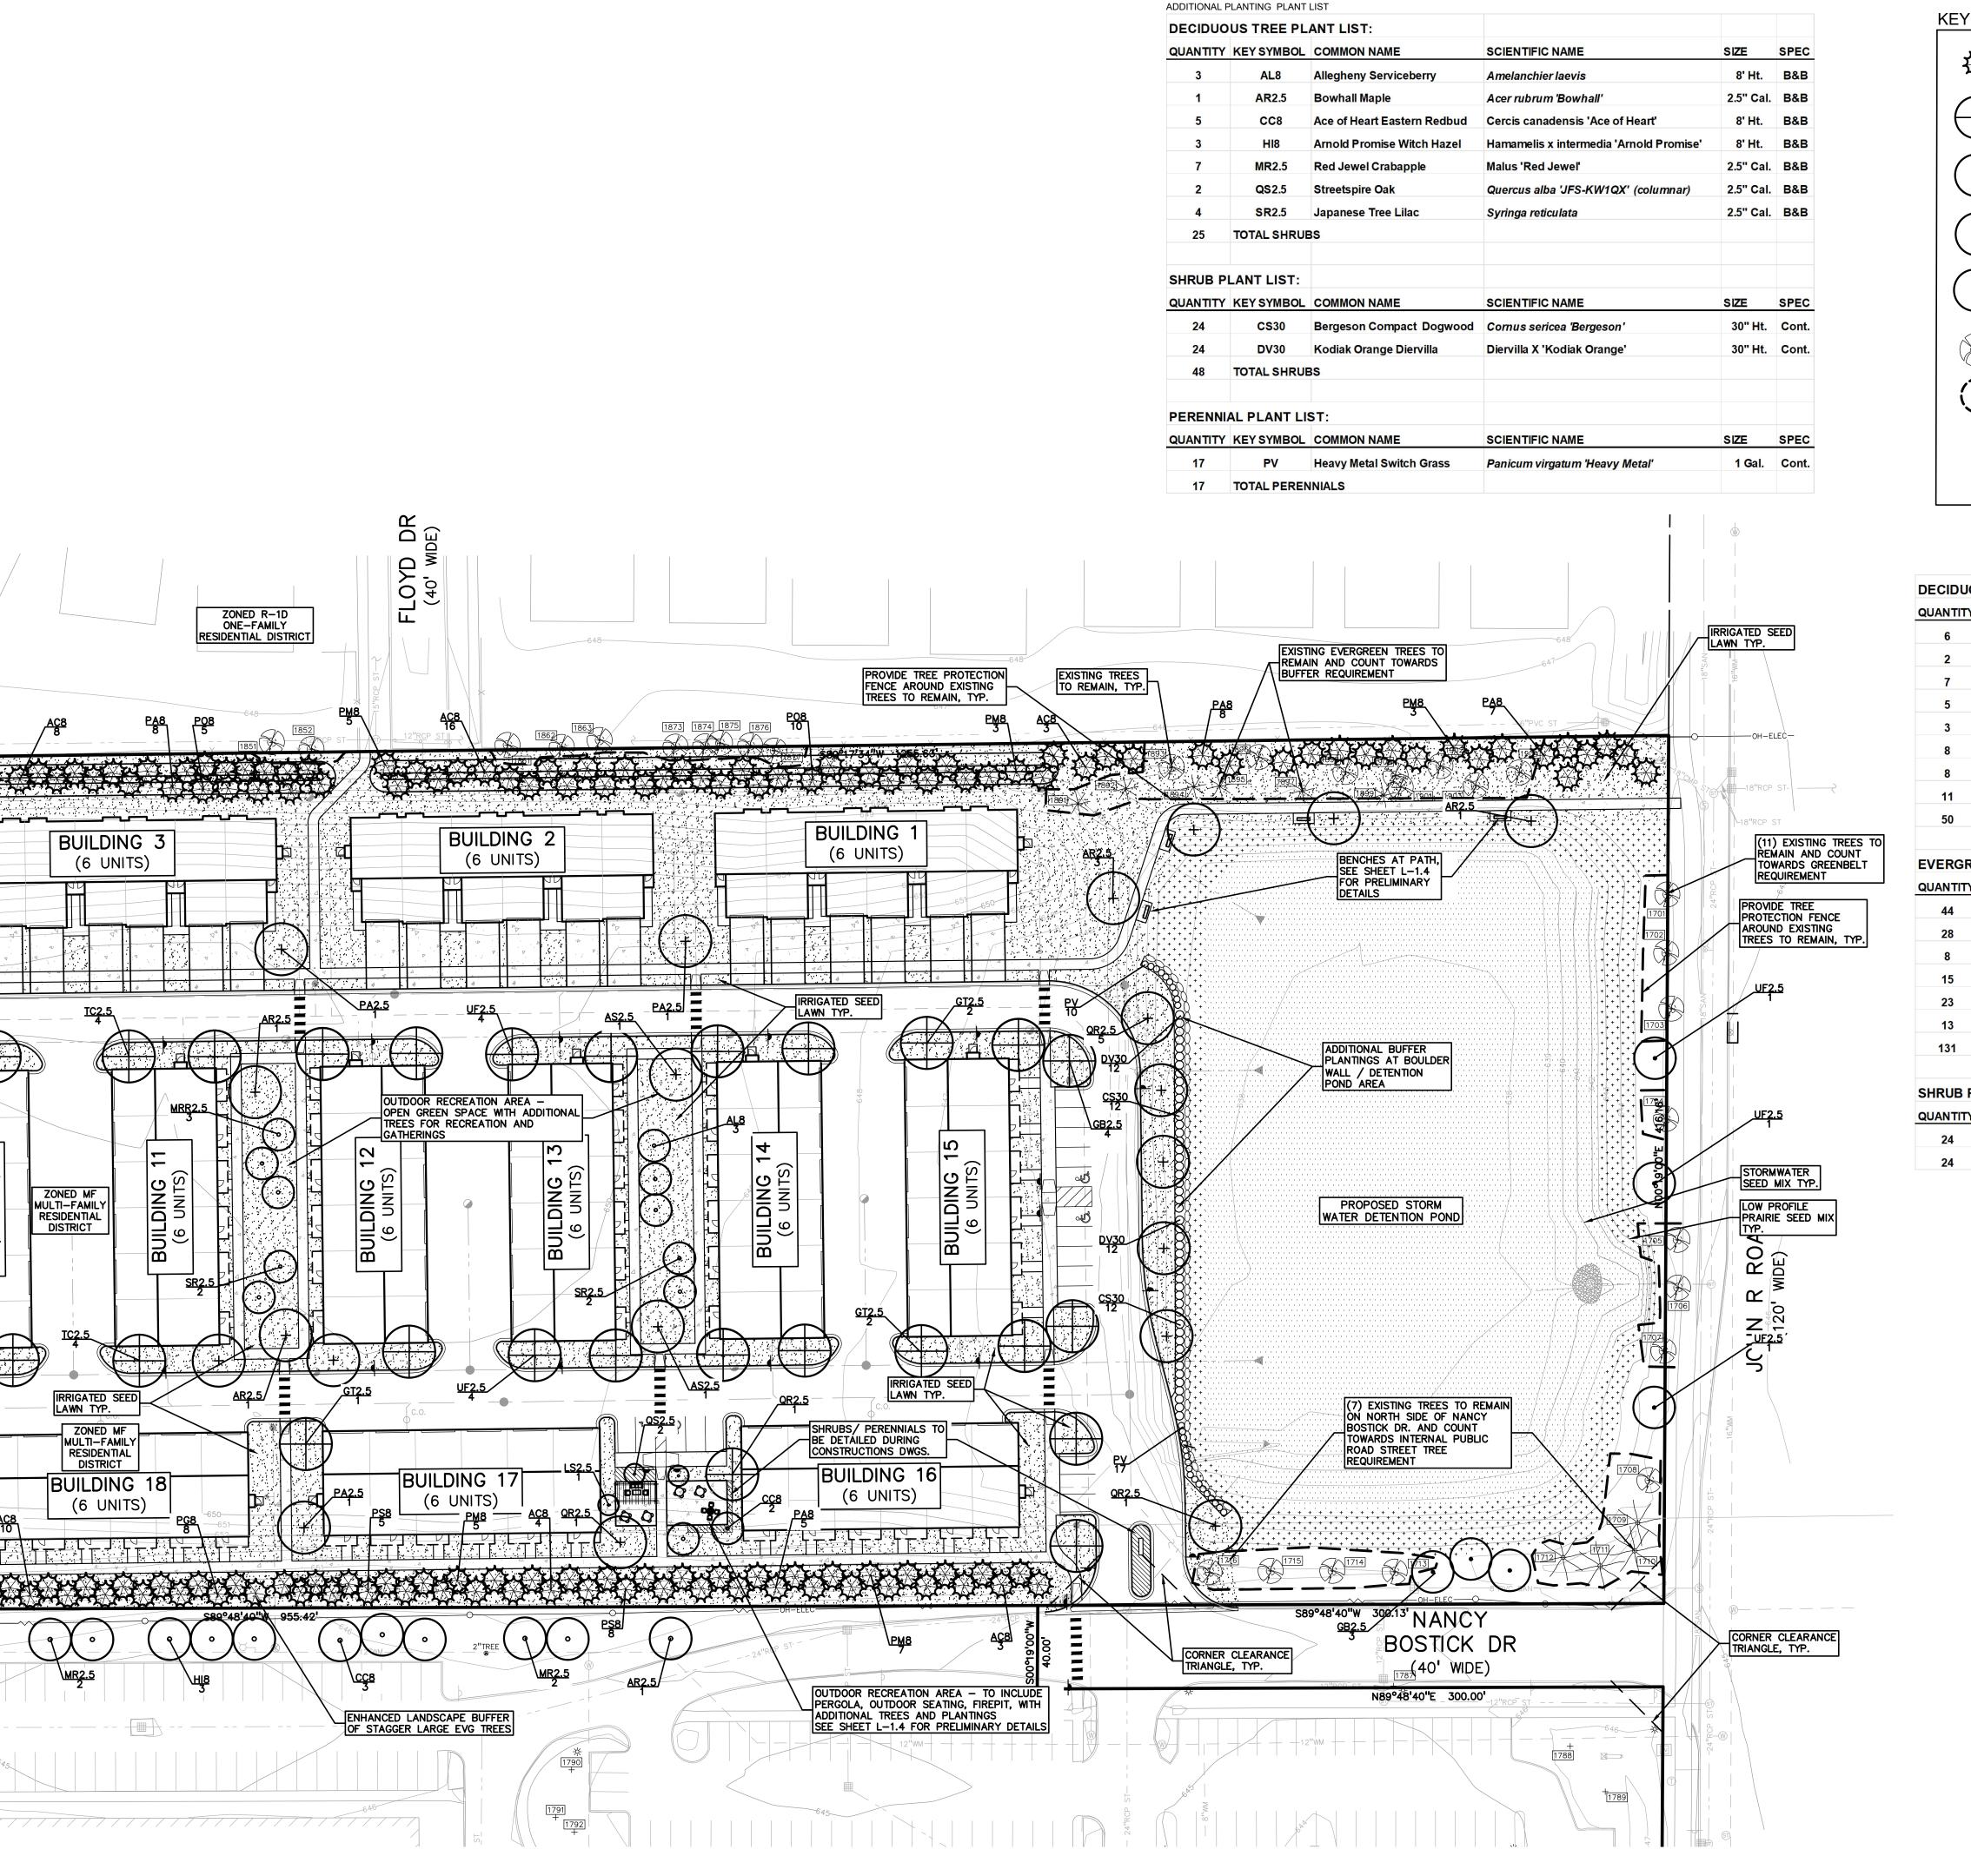


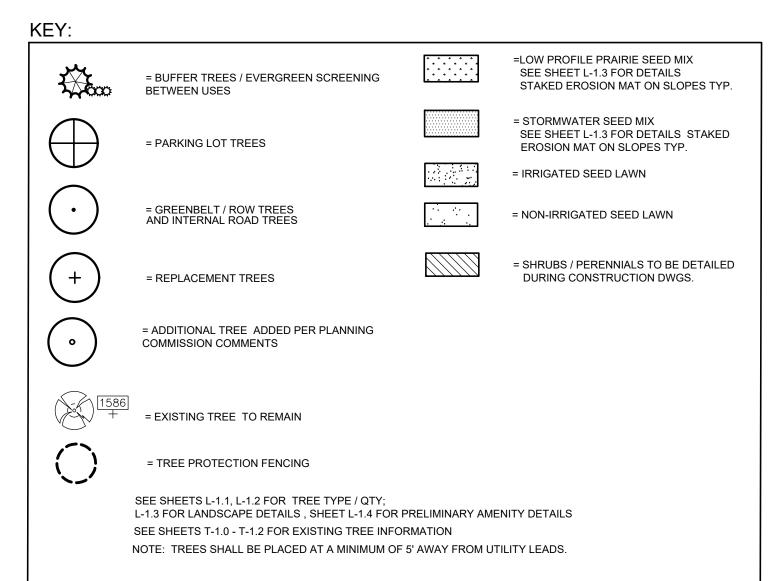

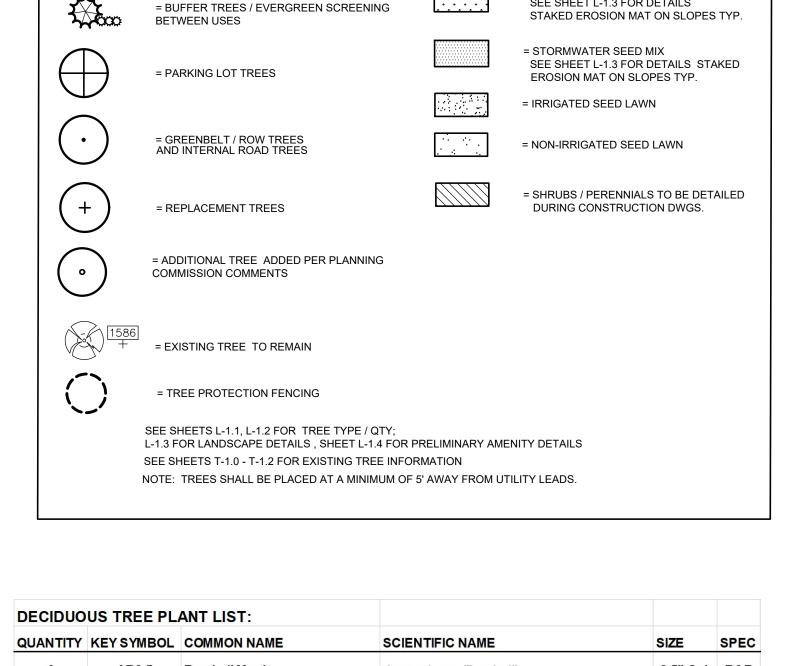

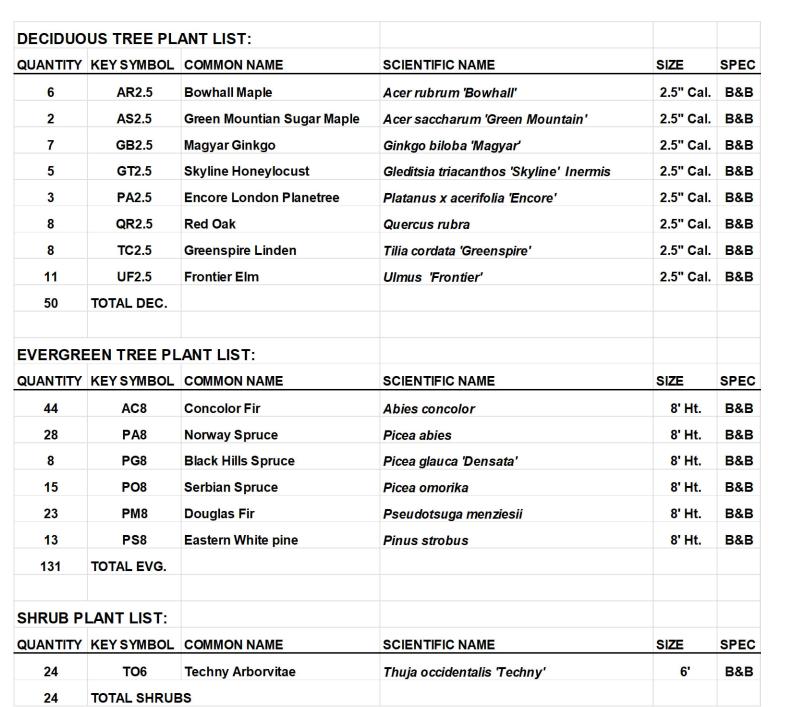

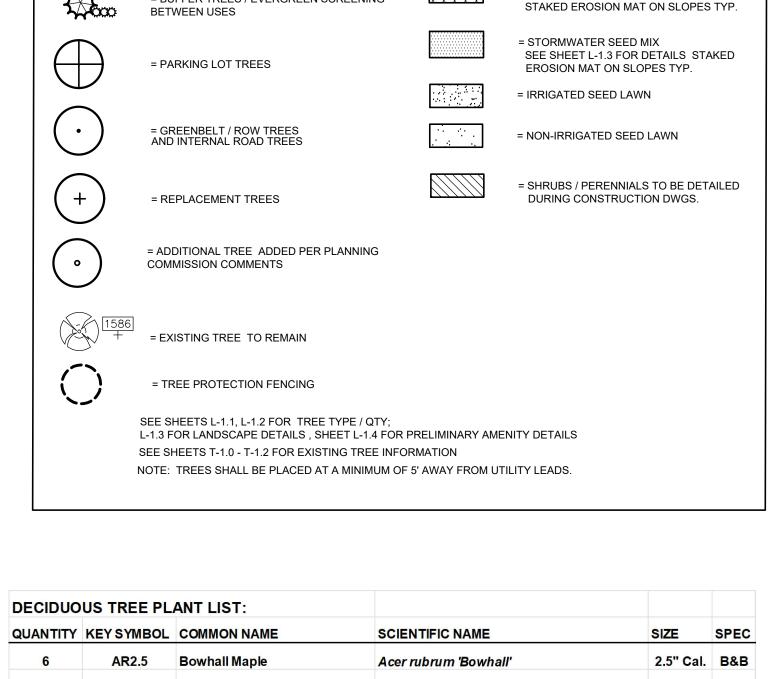

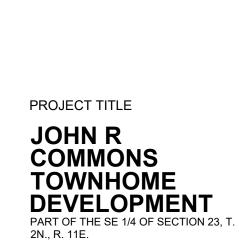

TROY, OAKLAND COUNTY, MI

TROY SPORTS

CENTER, LLC


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SCALE: 1" = 40'

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CAUTION!!



OUTDOOR RECREATION AREA


SCALE: 1'' = 10'-0''

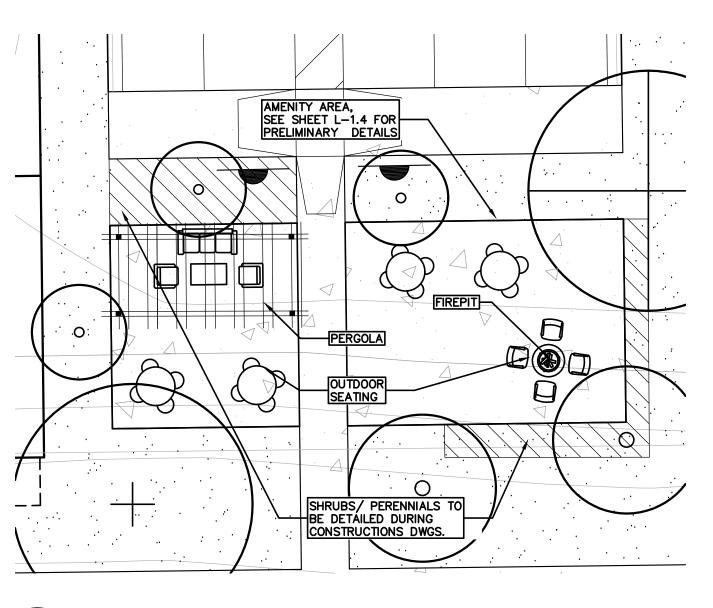REVISIONS	
SPA COMMENTS	11/8/23
SPA COMMENTS	3/1/24
SPA/PC COMMENTS	5/3/24
SPA/PC COMMENTS	7/12/24
ORIGINAL ISSUE DATE:	
AUGUST 18, 2023	
DRAWING TITLE	

PLAN - E	AST
PEA JOB NO.	18-0034
P.M.	GMB
DN.	BZZ
DES	JIF

LANDSCAPE

DRAWING NUMBER:

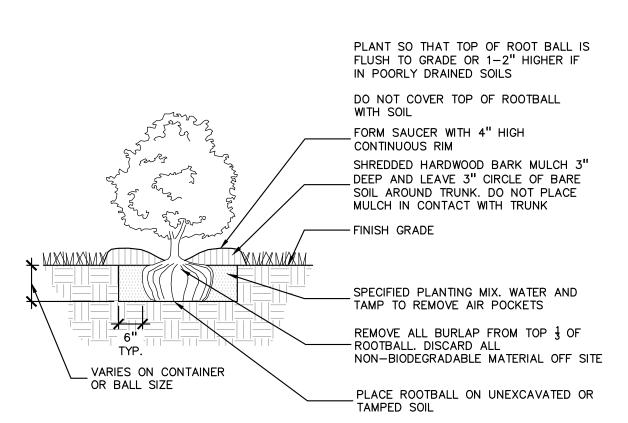



SHRUB PLANTING DETAIL SCALE: 1'' = 2'-0''

STAKING/GUYING

LOCATION

MIN. TYP.

SCALE: 1'' = 3'-0''



CAUTION!! THE LOCATIONS AND ELEVATIONS OF EXISTING UNDERGROUND UTILITIES AS SHOWN ON THIS DRAWING ARE ONLY APPROXIMATE. NO GUARANTEE IS EITHER EXPRESSED OR IMPLIED AS TO THE COMPLETENESS OR ACCURACY THEREOF. THE CONTRACTOR SHALL BE EXCLUSIVELY RESPONSIBLE FOR DETERMINING THE EXACT UTILITY LOCATIONS AND ELEVATIONS PRIOR TO THE START OF CONSTRUCTION.

PLANT SO THAT THE TREE'S ROOT FLARE (TRUNK FLARE) IS FLUSH WITH GRADE OR 1-2" HIGHER IN POORLY DRAIN SOIL. STAKE JUST BELOW BRANCHES WITH 2"-3" WIDE NYLON OR PLASTIC STRAPS. CONNECT FROM TREE TO STAKE AND ALLOW FOR FLEXIBILITY. REMOVE AFTER (1) ONE YEAR. (DO NOT USE WIRE & HOSE)

THREE 2"X2" HARDWOOD STAKES OR STEEL T-POSTS DRIVEN A MIN. OF 18" DEEP FIRMLY INTO SUBGRADE PRIOR TO BACKFILLING SHREDDED HARDWOOD BARK MULCH TO DRIPLINE. 3" DEEP AND LEAVE 3" CIRCLE OF CLIENT BARE SOIL AROUND TREE TRUNK. DO NOT

TRUNK. FORM SAUCER WITH 4" HIGH CONTINUOUS RIM

-FINISH GRADE SPECIFIED PLANTING MIX, WATER & TAMP TO - REMOVE AIR POCKETS, ÁMEND SOIL PER SITE CONDITIONS & TREE REQUIREMENTS EXPOSE ROOT FLARE OF TREE, CONTRACTOR MAY HAVE TO REMOVE EXCESS SOIL FROM TOP OF ROOTBALL. REMOVE ALL BURLAP

FROM TOP 3 OF ROOTBALL. DISCARD ALL

PLACE MULCH IN CONTACT WITH TREE

NON-BIODEGRADABLE MATERIAL OFF SITE PLACE ROOTBALL ON UNEXCAVATED OR

PROJECT TITLE JOHN R COMMONS

> **DEVELOPMENT** PART OF THE SE 1/4 OF SECTION 23,

> > 11/8/23

3/1/24

5/3/24

7/12/24

REVISIONS

SPA COMMENTS

SPA COMMENTS

SPA/PC COMMENTS


SPA/PC COMMENTS

TOWNHOME

TROY SPORTS

CENTER, LLC

2N., R. 11E. TROY, OAKLAND COUNTY, MI

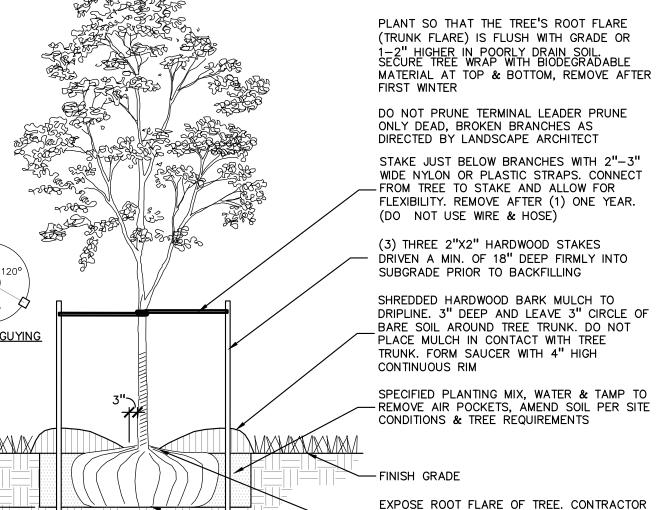

ORIGINAL ISSUE DATE: AUGUST 18, 2023

> DRAWING TITLE **LANDSCAPE**


DETAILS

PEA JOB NO. 18-0034 P.M. GMB DN. BGG DES. JLE DRAWING NUMBER:

VARIES PER SPECIES SEE PLAN FOR QUANTITY SPECIES SEE PLAN FOR QUANTITY PLANT PERENNIALS EQUAL DISTANCE IN ALL DIRECTIONS ALL SPACING IS TO BE TRIANGULAR UNLESS NOTED OR GRAPHICALLY SHOWN OTHERWISE PLAN VIEW 3" SHREDDED BARK MULCH. DO NOT PILE MULCH AGAINST PLANT STEMS SHOVEL CUT EDGE OR ALUMINUM EDGING AS INDICATED ON PLAN - SPECIFIED PLANTING MIX NOTE: REMOVE ALL CONTAINERS PRIOR TO PLANTING SECTION VIEW

PERENNIAL PLANTING DETAIL

SCALE: 1'' = 2'-0''

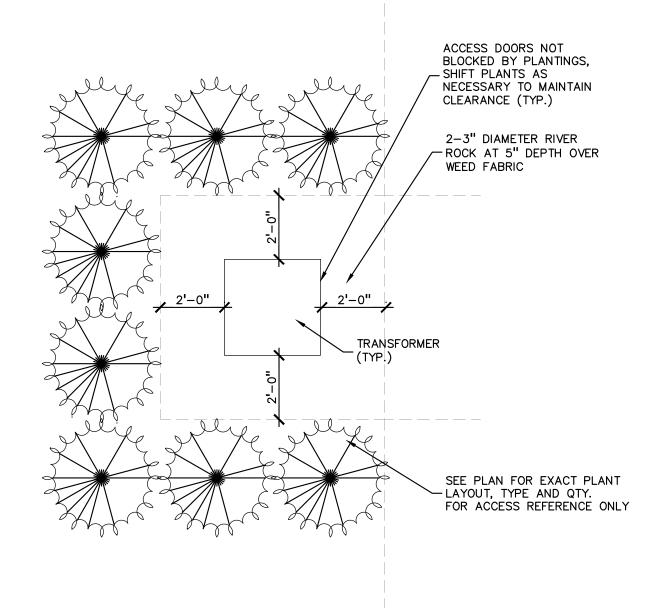

TRANSFORMER SCREENING DETAIL

BE COMPACTED ON BOTH SIDES OF EDGING TO MAINTAIN STABILITY

TREE PROTECTION WILL BE ERECTED PRIOR TO START OF CONSTRUCTION ACTIVITIES AND SHALL REMAIN IN PLACE UNTIL CONSTRUCTION IS COMPLETE NO PERSON MAY CONDUCT ANY ACTIVITY WITHIN THE DRIP LINE OF ANY TREE DESIGNATED TO REMAIN; INCLUDING, BUT NOT LIMITED TO PLACING SOLVENTS, BUILDING MATERIAL, CONSTRUCTION EQUIPMENT OR

GRADE CHANGES MAY NOT OCCUR WITHIN THE DRIP LINE OF PROTECTED TREES

SOIL DEPOSITS WITHIN DRIP LINES

ANY DEVICE OR WIRE TO ANY REMAINING TREE ALL UTILITY SERVICE REQUESTS MUST INCLUDE NOTIFICATION TO THE INSTALLER THAT PROTECTED TREES MUST BE AVOIDED. ALL TRENCHING SHALL OCCUR OUTSIDE OF THE PROTECTIVE FENCING

TREES LOCATED ON ADJACENT PROPERTY THAT MAY BE AFFECTED BY CONSTRUCTION ACTIVITIES MUST BE

TREES TO BE PRESERVED SHALL BE IDENTIFIED WITH FLAGGING PRIOR TO THE TREE CLEARING

TREE MEASURED AT 4.5' ABOVE GROUND

4'HIGH PROTECTIVE FENCING WITH STEEL POSTS - 10' O.C.

Stormwater Seed Mix Stantec Native Plant Nursery 574-586-2412 stantec.com/native-plant-nursery

Botanical Name Permanent Grasses/Sedges/Rushes: Bolboschoenus fluviatilis

Carex cristatella Carex Iurida Carex vulpinoidea Elymus virginicus

Glyceria striata Juncus effusus Leersia oryzoides Panicum virgatum Schoenoplectus tabernaemontani Scirpus atrovirens Scirpus cyperinus

Temporary Cover: Avena sativa Lolium multiflorum

Forbs & Shrubs: Alisma spp. Asclepias incarnata Bidens spp. Helenium autumnale Iris virginica Lycopus americanus Mimulus ringens Oligoneuron riddelli Penthorum sedoides Polygonum spp. Rudbeckia subtomentosa Rudbeckia triloba Sagittaria latifolia Senna hebecarpa Symphyotrichum novae-angliae Thalictrum dasycarpum

Common Name River Bulrush

Crested Oval Sedge Bottlebrush Sedge Brown Fox Sedge Virginia Wild Rye Fowl Manna Grass Common Rush Rice Cut Grass Switch Grass Softstem Bulrush Dark Green Rush Wool Grass

Common Oat Annual Rye

Water Plantain (Various Mix) Swamp Milkweed Bidens (Various Mix) Sneezeweed Blue Flag Common Water Horehound Monkey Flower Riddell's Goldenrod Ditch Stonecrop Pinkweed (Various Mix) Sweet Black-Eyed Susan Brown-Eyed Susan Common Arrowhead Wild Senna New England Aster

Anemone cylindrica Asclepias syriaca Asclepias tuberosa Baptisia alba Chamaecrista fasciculata Coreopsis lanceolata Coreopsis palmata Dalea candida Dalea purpurea Desmanthus illinoensis Echinacea purpurea Eryngium yuccifolium Lespedeza capitata Liatris aspera Lupinus perennis

Monarda fistulosa Oligoneuron rigidum Parthenium integrifolium Penstemon digitalis Penstemon hirsutus Ratibida pinnata Rudbeckia hirta Solidago speciosa Symphyotrichum laeve Tradescantia ohiensis Verbena stricta Vernonia spp. Purple Meadow Rue Veronicastrum virginicum Common Name

Permanent Grasses: Side Oats Grama Bouteloua curtipendula Carex spp. Prairie Carex Mix Canada Wild Rye Elymus canadensis Koeleria pyramidata June Grass Switch Grass Panicum virgatum Schizachyrium scoparium Little Bluestem

FOR ALL SEED MIXES, PROVIDE EROSION MAT ON SLOPES AND AREAS OF WASH OUT TYP.

Stantec Native Plant Nursery 574-586-2412

NO INVASIVE SPECIES PERMITTED, USE ONLY SPECIES NATIVE TO COUNTY.

Low-profile Prairie Seed Mix

stantec.com/native-plant-nursery

Temporary Cover: Avena sativa

Common Oat Lolium multiflorum Annual Rye

Amorpha canescens

INSTALL AND PREP PER MANUFACTURES SPECIFICATIONS.

Botanical Name

Lead Plant ThimbleWeed Common Milkweed Butterfly MilkWeed White Wild Indigo Partridge Pea Sand Coreopsis Prairie Coreopsis White Prairie Clover Purple Prairie Clover Illinois Sensitive Plant Broad-Leaved Purple Coneflower Rattlesnake Master Round-Head Bush Clover Rough Blazing Star Wild Lupine Wild Bergamot Stiff Goldenrod

Common Spiderwort

Ironweed (Various Mix)

Hoary Vervain

Culvers Root

Wild Quinine Foxglove Beard Tongue Hairy Beard Tongue Pycnanthemum virginianum Common Mountain Mint Yellow Coneflower Black-Eyed Susan Rudbeckia subtomentosa Sweet Black-Eyed Susan Silphium terebinthinaceum Prairie Dock Showy Goldenrod Heath Aster Symphyotrichum ericoides Smooth Blue Aster Symphyotrichum novae-angliae New England Aster

TREE PROTECTION DETAIL SCALE: 1'' = 3'-0''

NOT FOR CONSTRUCTION

PERMALOC ALUMINUM EDGING OR APPROVED DURING CONSTRUCTION, NO PERSON SHALL ATTACH EQUAL WITH BLACK FINISH - BED MEDIA - COMPACTED SUBGRADE SPECIFICATIONS FOR LANDSCAPE BED EDGING: LANDSCAPE BED EDGING SHALL BE ALUMINUM AS MANUFACTURED BY PERMALOC 1.800.356.9660 PROVIDE FENCE AROUND CRITICAL ROOT ZONE OF 8' OR 16' SECTIONS SHALL BE USED WITH ONE STAKE PER 38" OF FENCE SHALL BE PLACED IN A CIRCLE WITH A MINIMUM RADIUS OF 1' PER 1" DIAMETER OF THE EDGING SHALL BE 16" THICK X 4" DEPTH WHEN ADJ. TO MULCH AND 급" THICK X 5 1" DEPTH WHEN ADJ. TO ROCK, FINISH: BLACK DURAFLEX MEETING AAMA 2603 STAKE SHALL SECURELY ENGAGE EDGING AND SHALL BE ENTIRELY BELOW TOP SURFACE OF EDGING EDGING SHALL HAVE A MINIMUM OF 2" OF INTERLOCKING OVERLAP BETWEEN SECTIONS INSTALL AS PER MANUFACTURER'S SPECIFICATIONS WITH TOP OF EDGING $\frac{1}{4}$ "- $\frac{1}{2}$ " ABOVE COMPACTED FINISH GRADE. FINISH GRADE TO

ALUMINUM EDGE DETAIL

SCALE: 1/2'' = 1'-0''

120° STAKING/GUYING <u>LOCATION</u> MAY HAVE TO REMOVE EXCESS SOIL FROM - TOP OF ROOTBALL. REMOVE ALL BURLAP FROM TOP 1 OF ROOTBALL. DISCARD ALL NON-BIODEGRADABLE MATERIAL OFF SITE PLACE ROOTBALL ON UNEXCAVATED OR


DECIDUOUS TREE PLANTING DETAIL


SCALE: 1'' = 3'-0''

EVERGREEN TREE PLANTING DETAIL

SHREDDED HARDWOOD BARK MULCH TO DRIPLINE. 3" DEEP AND LEAVE 3" CIRCLE OF BARE SOIL AROUND TREE TRUNK. DO NOT PLACE MULCH IN CONTACT WITH TREE TRUNK. FORM SAUCER WITH 4" HIGH

SPECIFIED PLANTING MIX, WATER & TAMP TO - REMOVE AIR POCKETS, AMEND SOIL PER SITE CONDITIONS & TREE REQUIREMENTS

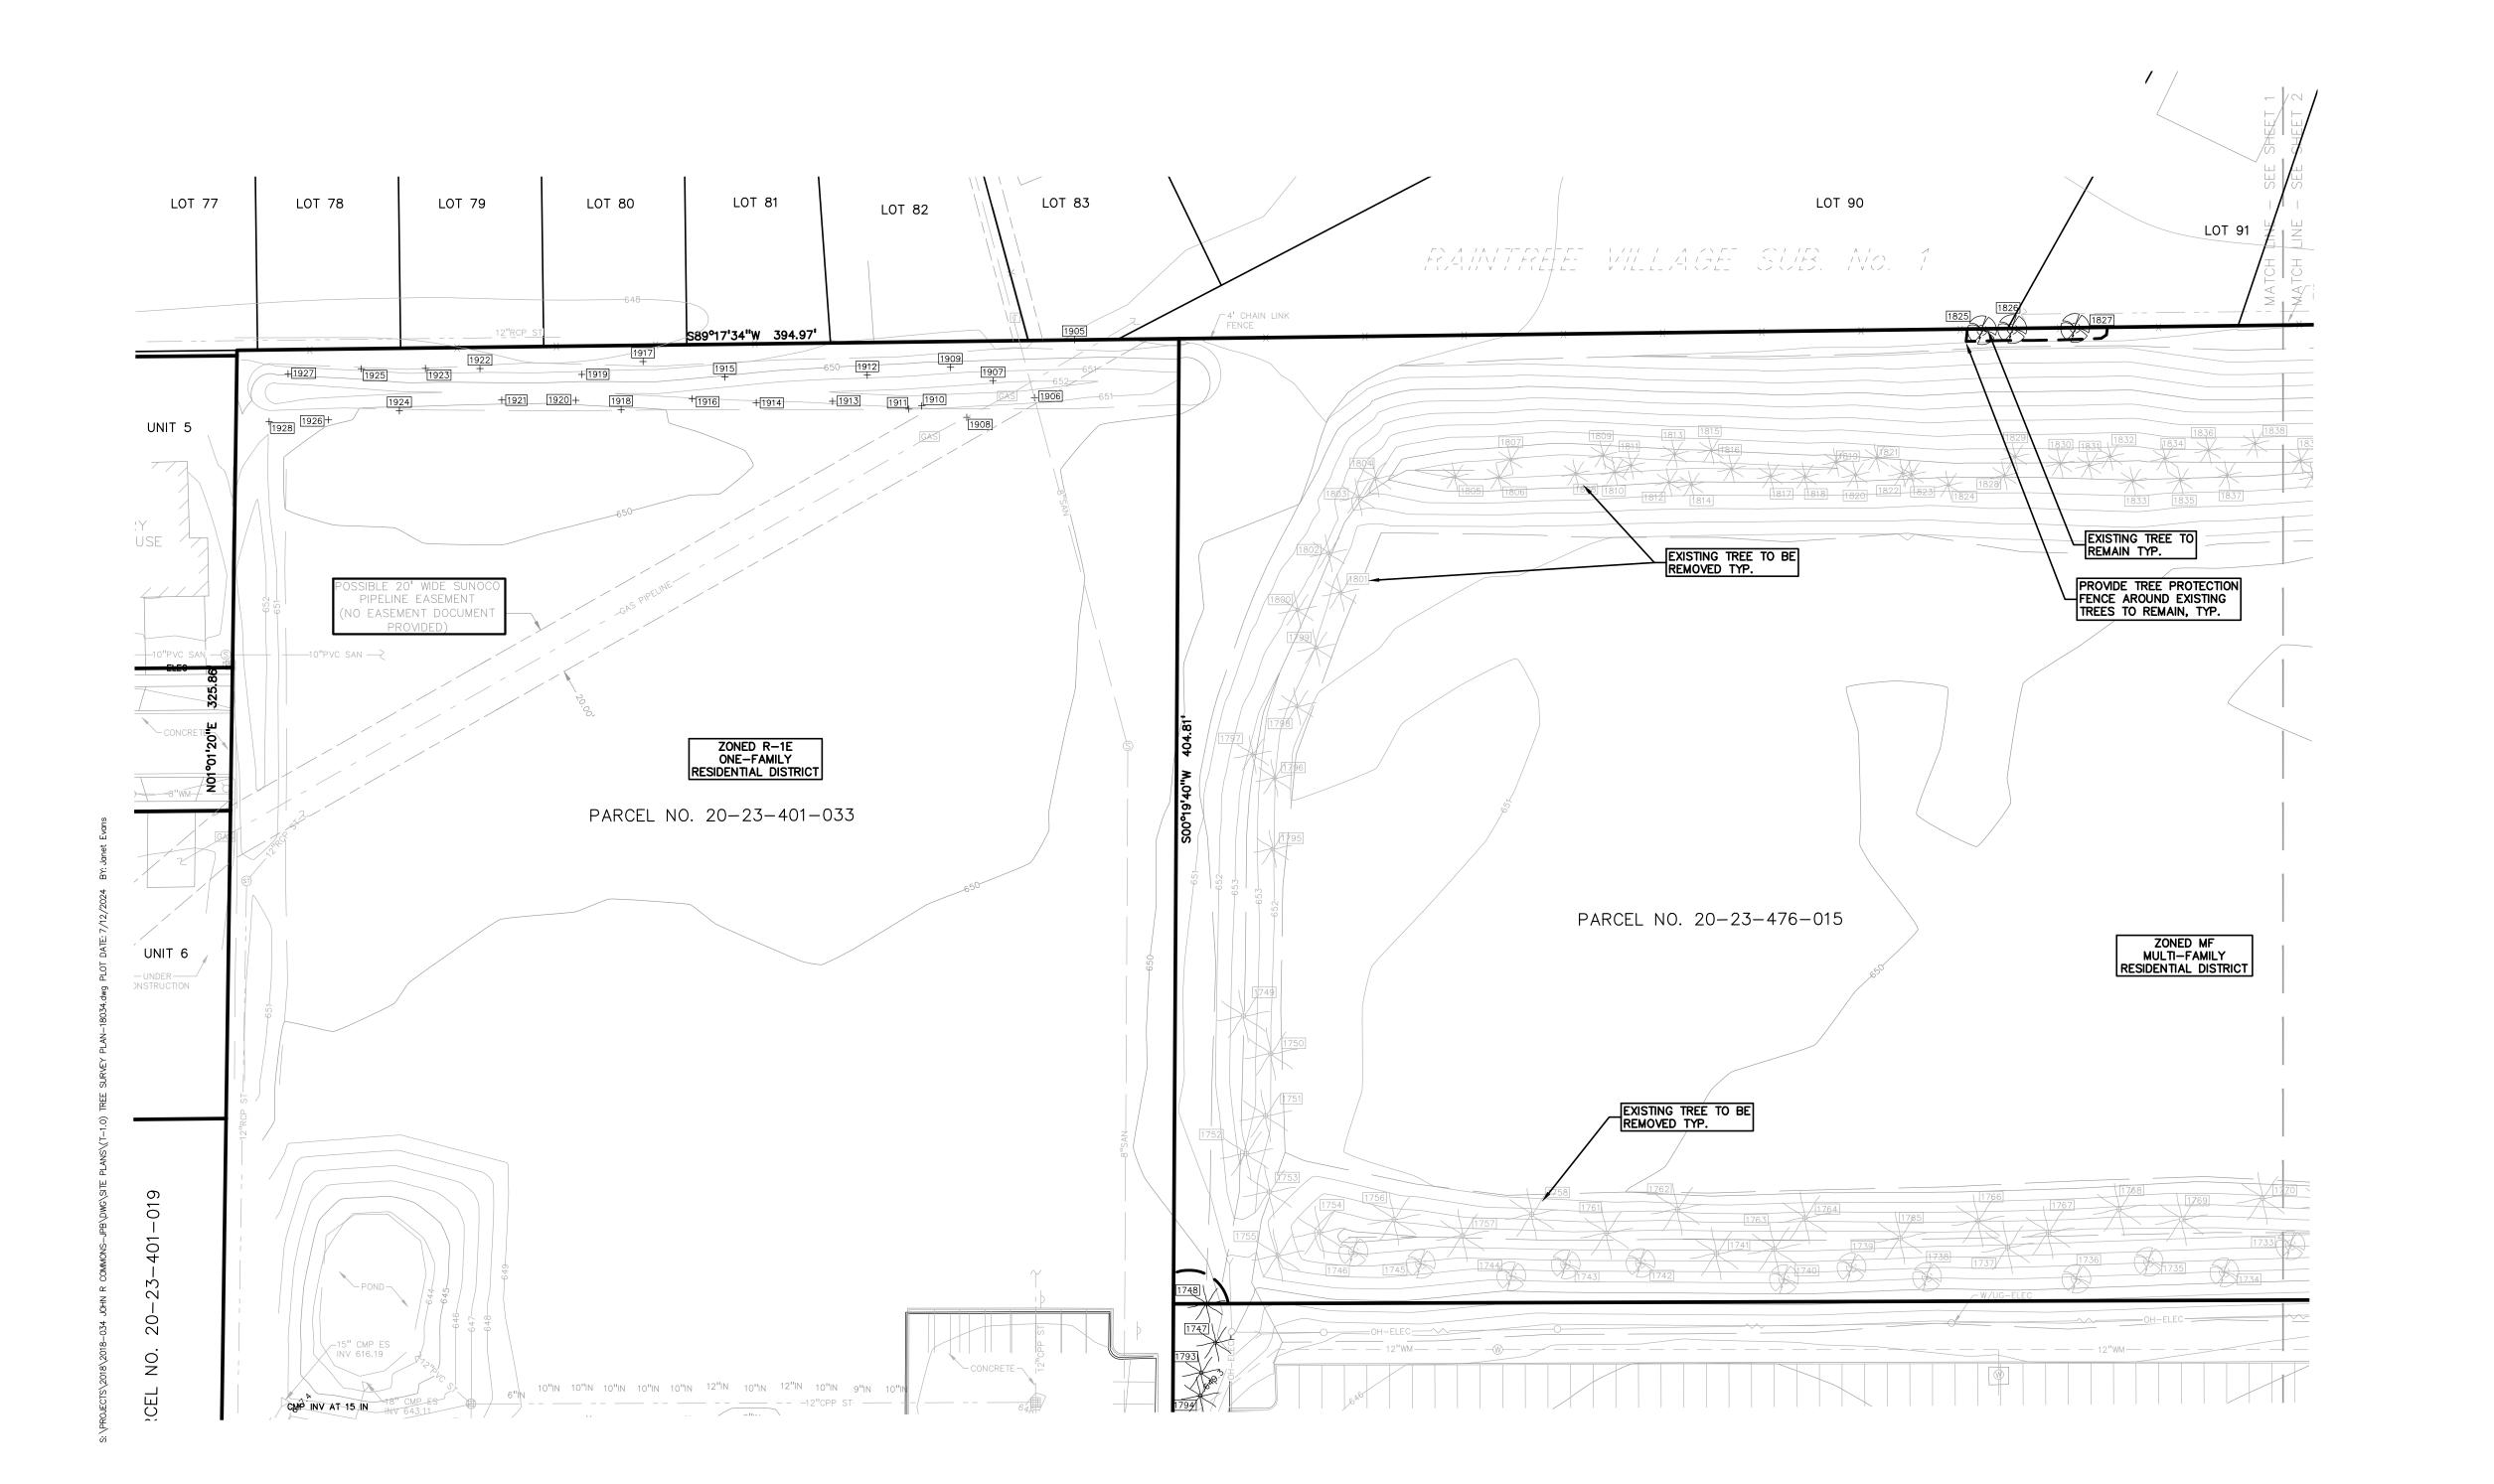

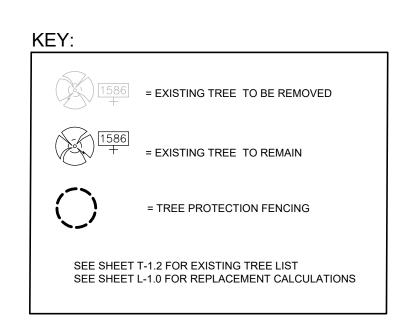

- 4' HIGH PROTECTIVE FENCING WITH STEEL POSTS - 10' O.C.



TREE PROTECTION WILL BE ERECTED PRIOR TO START OF CONSTRUCTION ACTIVITIES AND SHALL REMAIN IN PLACE UNTIL CONSTRUCTION IS COMPLETE.

NO PERSON MAY CONDUCT ANY ACTIVITY WITHIN THE DRIP LINE OF ANY TREE DESIGNATED TO REMAIN; INCLUDING, BUT NOT LIMITED TO PLACING SOLVENTS, BUILDING MATERIAL, CONSTRUCTION EQUIPMENT OR SOIL DEPOSITS
WITHIN DRIP LINES.

NORTH

0 20 40

SCALE: 1" = 40'

GRADE CHANGES MAY NOT OCCUR WITHIN THE DRIP LINE OF PROTECTED TREES.

DURING CONSTRUCTION, NO PERSON SHALL ATTACH ANY DEVICE OR WIRE TO ANY REMAINING TREE.

ALL UTILITY SERVICE REQUESTS MUST INCLUDE NOTIFICATION TO THE INSTALLER THAT PROTECTED TREES MUST BE AVOIDED. ALL TRENCHING SHALL OCCUR OUTSIDE OF THE PROTECTIVE FENCING.

TREES LOCATED ON ADJACENT PROPERTY THAT MAY BE AFFECTED BY CONSTRUCTION ACTIVITIES MUST BE PROTECTED.

TREES TO BE PRESERVED SHALL BE IDENTIFIED WITH FLAGGING PRIOR TO THE TREE CLEARING OPERATIONS.

PROVIDE FENCE AROUND CRITICAL ROOT ZONE OF TREE.

FENCE SHALL BE PLACED IN A CIRCLE WITH A RADIUS OF 1' PER 1" DIAMETER OF THE TREE MEASURED AT 4.5' ABOVE GROUND.

TREE PROTECTION DETAIL

TROY SPORTS CENTER, LLC 1819 EAST BIG BEAVER ROAD TTOY, MI 48083

PROJECT TITLE


JOHN R
COMMONS
TOWNHOME
DEVELOPMENT
PART OF THE SE 1/4 OF SECTION 23, T.
2N., R. 11E.
TROY, OAKLAND COUNTY, MI


REVISIONS	
SPA COMMENTS	11/8/23
SPA COMMENTS	3/1/24
SPA/PC COMMENTS	5/3/24
SPA/PC COMMENTS	7/12/24

ORIGINAL ISSUE DATE: AUGUST 18, 2023 DRAWING TITLE


TREE SURVEY PLAN - WEST


PEA JOB NO.	18-0034
P.M.	GME
DN.	BZ
DES.	JLE
DRAWING NUMBER:	

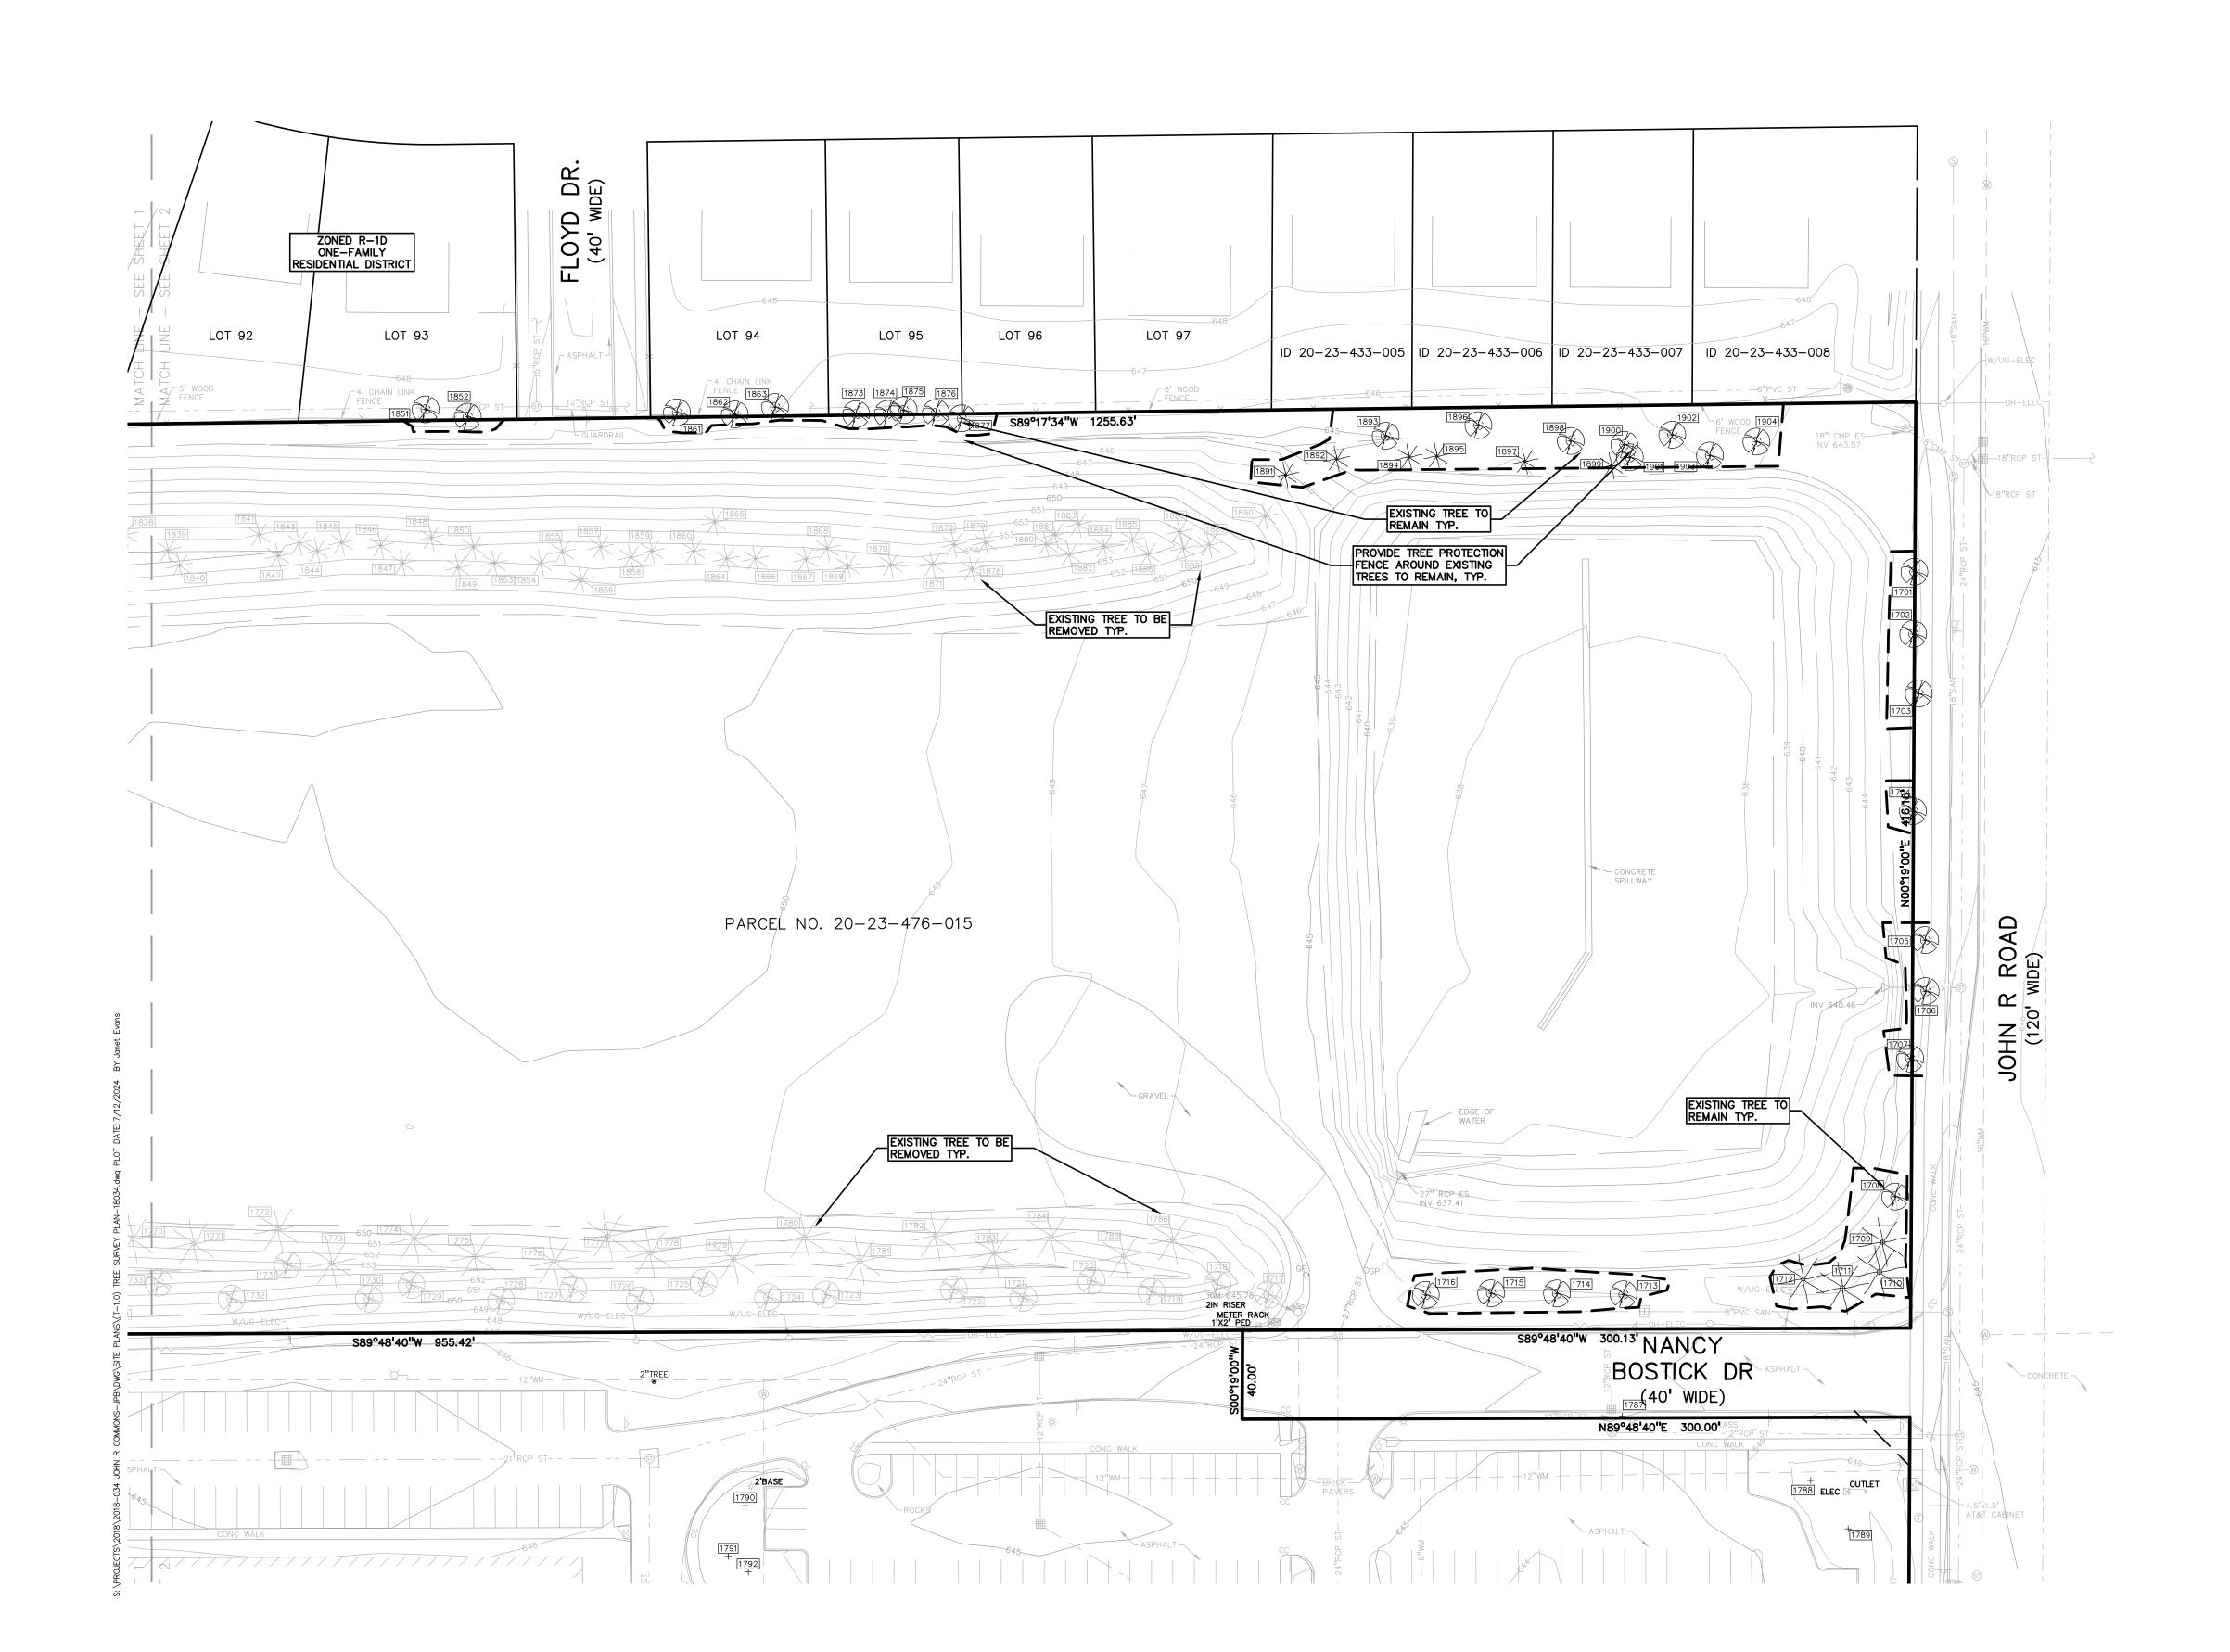

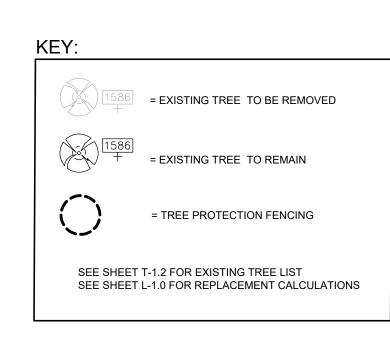



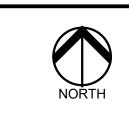

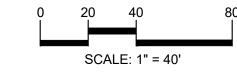



CAUTION!!

THE LOCATIONS AND ELEVATIONS OF EXISTING UNDERGROUND UTILITIES AS SHOWN ON THIS DRAWING ARE ONLY APPROXIMATE. NO GUARANTEE IS EITHER EXPRESSED OR IMPLIED AS TO THE COMPLETENESS OR ACCURACY THEREOF. THE CONTRACTOR SHALL BE EXCLUSIVELY RESPONSIBLE FOR DETERMINING THE EXACT UTILITY LOCATIONS AND ELEVATIONS PRIOR TO THE START OF CONSTRUCTION.

CLIENT TROY SPORTS CENTER, LLC 1819 EAST BIG BEAVER ROAD TTOY, MI 48083

PROJECT TITLE

JOHN R
COMMONS
TOWNHOME
DEVELOPMENT
PART OF THE SE 1/4 OF SECTION 23, T.
2N., R. 11E.
TROY, OAKLAND COUNTY, MI

REVISIONS	
SPA COMMENTS	11/8/23
SPA COMMENTS	3/1/24
SPA/PC COMMENTS	5/3/24
SPA/PC COMMENTS	7/12/24
_	

ORIGINAL ISSUE DATE: AUGUST 18, 2023 DRAWING TITLE

TREE SURVEY PLAN - EAST

PEA JOB NO.	18-0034
P.M.	GMB
DN.	BZ
DES.	JLE
DRAWING NUMBER:	

G NO.	BP BP	DBH 15	COMMON NAME Bradford Pear	Pyrus calleryanna	COND Fair	COMMENTCLASSINVASIVE	S	ON-SITE]- \]-
702 703	BP BP	13 15	Bradford Pear Bradford Pear	Pyrus calleryanna Pyrus calleryanna	Fair Fair	INVASIVE	S S	Y N]-
'04	BP	15	Bradford Pear	Pyrus calleryanna	Fair	INVASIVE INVASIVE	S	Y	<u>[</u>
705 706	BP BP	14 14	Bradford Pear Bradford Pear	Pyrus calleryanna Pyrus calleryanna	Fair Poor	INVASIVE INVASIVE	S S	N N	<u> </u> -
'07 '08	BP WS	11 8	Bradford Pear White Spruce	Pyrus calleryanna Picea glauca	Fair Poor	INVASIVE	S	Y]-
709	BS	10	Blue Spruce	Picea gladca Picea pungens	Fair	WOODLAND WOODLAND	S S	Y	<u>-</u>
710 711	BS BS	9 12	Blue Spruce Blue Spruce	Picea pungens Picea pungens	Good Good	WOODLAND WOODLAND	S S	Y	<u> </u> -
712	WS	12	White Spruce	Picea glauca	Fair	WOODLAND	S	Y]-
713 714	G G	6	Ginkgo Ginkgo	Ginkgo biloba Ginkgo biloba	Good Good	WOODLAND WOODLAND	S S	Y	_ - -
715 716	G G	6 6	Ginkgo Ginkgo	Ginkgo biloba Ginkgo biloba	Good	WOODLAND	S	Y Y	1-
1716	SU	8	Sugar Maple	Acer saccharum	Poor	WOODLAND WOODLAND	S R	¥	<u> </u>
718 719	SU SU	10 10	Sugar Maple Sugar Maple	Acer saccharum Acer saccharum	Good Good	WOODLAND WOODLAND	R R	Y Y	REPLAC REPLAC
720	SU	6	Sugar Maple	Acer saccharum	Good	WOODLAND	R	¥	REPLAC
721 722	SU SU	9	Sugar Maple Sugar Maple	Acer saccharum Acer saccharum	Good Good	WOODLAND WOODLAND	R R	¥ ¥	REPLAC REPLAC
1 723	SU SU	6 8	Sugar Maple Sugar Maple	Acer saccharum Acer saccharum	Good Good	WOODLAND WOODLAND	R R	¥ ¥	REPLAC REPLAC
1725	SU	9	Sugar Maple	Acer saccharum	Good	WOODLAND	R	¥	REPLAC
1 726 1 727	SU SU	8 9	Sugar Maple Sugar Maple	Acer saccharum Acer saccharum	Good Good	WOODLAND WOODLAND	R R	¥ ¥	REPLAC REPLAC
1728 1729	SU SU	9 10	Sugar Maple Sugar Maple	Acer saccharum Acer saccharum	Good Good	WOODLAND	R	¥ ¥	REPLAC REPLAC
1730	SU	10	Sugar Maple	Acer saccharum	Good	WOODLAND WOODLAND	R R	¥	REPLAC
1731 1732	SU SU	10 8	Sugar Maple Sugar Maple	Acer saccharum Acer saccharum	Good Good	WOODLAND WOODLAND	R R	¥ ¥	REPLAC REPLAC
1733	SU	10	Sugar Maple	Acer saccharum	Good	WOODLAND	R	¥	REPLAC
1734 1735	SU SU	10 10	Sugar Maple Sugar Maple	Acer saccharum Acer saccharum	Good Good	WOODLAND WOODLAND	R R	¥ ¥	REPLAC REPLAC
1736 1737	SU SU	9	Sugar Maple Sugar Maple	Acer saccharum Acer saccharum	Good Good	WOODLAND WOODLAND	R R	¥ ¥	REPLAC REPLAC
1738	SU	9	Sugar Maple	Acer saccharum	Good	WOODLAND	R	¥	REPLAC
1739 1740	SU SU	9	Sugar Maple Sugar Maple	Acer saccharum Acer saccharum	Good Good	WOODLAND WOODLAND	R R	¥ ¥	REPLAC REPLAC
1741 1742	SU SU	9	Sugar Maple Sugar Maple	Acer saccharum Acer saccharum	Good	WOODLAND	R	¥ ¥	REPLAC REPLAC
1743	SU	10	Sugar Maple	Acer saccharum	Good	WOODLAND WOODLAND	R R	¥	REPLAC
1744 1745	SU SU	8 8	Sugar Maple Sugar Maple	Acer saccharum Acer saccharum	Good Good	WOODLAND WOODLAND	R R	¥ ¥	REPLAC REPLAC
1746	SU	8	Sugar Maple	Acer saccharum	Good	WOODLAND	R	¥	REPLAC
1747 1748	BS WS	11 11	Blue Spruce White Spruce	Picea pungens Picea glauca	Good Good	WOODLAND WOODLAND	S S	Y]-]-
1749 1750	WS WS	15 9	White Spruce White Spruce	Picea glauca Picea glauca	Fair Very Poor	WOODLAND WOODLAND	R R	¥ ¥	REPLAC
1751	BS	16	Blue Spruce	Picea pungens	Fair	WOODLAND	R	¥	REPLAC
1 752 1 753	BS BS	18 16	Blue Spruce Blue Spruce	Picea pungens Picea pungens	Fair Poor	LANDMARK WOODLAND	R R	¥ ¥	REPLAC -
1754 1755	BS WS	16 10	Blue Spruce White Spruce	Picea pungens Picea glauca	Good Fair	WOODLAND WOODLAND	R R	¥ ¥	REPLAC REPLAC
1756	BS	11	Blue Spruce	Picea pungens	Good	WOODLAND	R	¥	REPLAC
1757 1758	BS WS	12 14	Blue Spruce White Spruce	Picea pungens Picea glauca	Good Poor	WOODLAND WOODLAND	R R	<u>Ұ</u>	REPLAC -
1761 1762	WS WS	13 14	White Spruce White Spruce	Picea glauca	Fair	WOODLAND	R	¥	REPLAC
1763	BS	12	Blue Spruce	Picea glauca Picea pungens	Good Fair	WOODLAND WOODLAND	R R	¥ ¥	REPLAC REPLAC
1764 1765	BS BS	15 15	Blue Spruce Blue Spruce	Picea pungens Picea pungens	Good Good	WOODLAND WOODLAND	R R	¥ ¥	REPLAC REPLAC
1766	WS	10	White Spruce	Picea glauca	Poor	WOODLAND	R	¥	-
1767 1768	BS BS	11 15	Blue Spruce Blue Spruce	Picea pungens Picea pungens	Very Poor Fair	WOODLAND WOODLAND	R R	¥ ¥	- REPLAC
1769 1770	BS BS	12 12	Blue Spruce Blue Spruce	Picea pungens Picea pungens	Fair Fair	WOODLAND WOODLAND	R R	¥ ¥	REPLAC REPLAC
1771	BS	12	Blue Spruce	Picea pungens	Fair	WOODLAND	R	¥	REPLAC
1772 1773	BS BS	13 12	Blue Spruce Blue Spruce	Picea pungens Picea pungens	Good Fair	WOODLAND WOODLAND	R R	¥ ¥	REPLAC REPLAC
1774 1775	BS BS	12 14	Blue Spruce Blue Spruce	Picea pungens Picea pungens	Fair Fair	WOODLAND	R	¥ ¥	REPLAC REPLAC
1776	BS	12	Blue Spruce	Picea pungens	Good	WOODLAND WOODLAND	R R	¥	REPLAC
1777 1778	BS BS	12 11	Blue Spruce Blue Spruce	Picea pungens Picea pungens	Fair Fair	WOODLAND WOODLAND	R R	¥ ¥	REPLAC REPLAC
1779 1780	NS NS	9 10	Norway Spruce Norway Spruce	Picea Abies	Poor Poor	WOODLAND	R	¥ ¥	1
1781	NS	11	Norway Spruce	Picea Abies	Poor	WOODLAND WOODLAND	R R	¥	-
1782 1783	NS RA	43 8	Norway Spruce Norway Spruce	Picea Abies Picea Abies	Good Fair	WOODLAND WOODLAND	R R	¥ ¥	REPLAC REPLAC
1784	NS NS	10	Norway Spruce	Picea Abies	Fair	WOODLAND	R	¥	REPLAC
1785 1786	RA SH	8 10	Norway Spruce Norway Spruce	Picea Abies Picea Abies	Poor Fair	WOODLAND WOODLAND	R R	¥ ¥	- REPLAC
1787 1788	G BS	8 7	Ginkgo Blue Spruce	Ginkgo biloba Picea pungens	Good Fair	WOODLAND WOODLAND	S S	N Y	 -
1789	BS	7	Blue Spruce	Picea pungens	Fair	WOODLAND	S	Υ	1-
1790 1791	NS BS	7	Norway Spruce Blue Spruce	Picea Abies Picea pungens	Fair Poor	WOODLAND WOODLAND	S S	Y	<u>-</u>
1792 1793	BS NS	8 14	Blue Spruce Norway Spruce	Picea pungens Picea Abies	Poor Good	WOODLAND WOODLAND	S S	Y Y	<u> </u> - -
1794	NS	12	Norway Spruce	Picea Abies	Good	WOODLAND	S	Υ	1
1795 1796	BS BS	16 13	Blue Spruce Blue Spruce	Picea pungens Picea pungens	Good Good	WOODLAND WOODLAND	R R	¥ ¥	REPLAC REPLAC
1797 1798	WS BS	12 10	White Spruce Blue Spruce	Picea glauca Picea pungens	Fair Poor	WOODLAND WOODLAND	R	¥ ¥	REPLAC
1799	₩S	10	White Spruce	Picea glauca	Fair	WOODLAND	R R	¥	- REPLAC
1800 1801	BS BS	13 12	Blue Spruce Blue Spruce	Picea pungens Picea pungens	Fair Poor	WOODLAND WOODLAND	R	¥ ¥	REPLAC
1802	BS BS	10	Blue Spruce	Picea pungens	Poor	WOODLAND	R	¥	- -
1804	BS	9	Blue Spruce Blue Spruce	Picea pungens Picea pungens	Fair	WOODLAND WOODLAND	R R	¥	REPLAC REPLAC
1805 1806	WS WS	8 8	White Spruce White Spruce	Picea glauca Picea glauca	Fair Fair	WOODLAND WOODLAND	R R	¥ ¥	REPLAC REPLAC
1807	₩S	8	White Spruce	Picea glauca	Fair	WOODLAND	R	¥	REPLAC
1808 1809	BS BS	7 7	Blue Spruce Blue Spruce	Picea pungens Picea pungens	Good Fair	WOODLAND WOODLAND	R R	¥ ¥	REPLAC REPLAC
1810 1811	BS BS	8 8	Blue Spruce	Picea pungens Picea pungens	Fair Fair	WOODLAND WOODLAND	R R	¥ ¥	REPLAC REPLAC
1812	BS	7	Blue Spruce	Picea pungens	Fair	WOODLAND	R	¥	REPLAC
1813 1814	BS BS	8	Blue Spruce Blue Spruce	Picea pungens Picea pungens	Fair Poor	WOODLAND WOODLAND	R R	¥ ¥	REPLAC
1815 1816	BS	8 7	Blue Spruce	Picea pungens	Fair	WOODLAND	R	¥	REPLAC
1816 1817	BS BS	8	Blue Spruce Blue Spruce	Picea pungens Picea pungens	Fair Fair	WOODLAND WOODLAND	R R	¥ ¥	REPLAC REPLAC
1818	BS	7	Blue Spruce	Picea pungens	Poor	WOODLAND	R	¥	L

1821	BS	DBH 9	Blue Spruce	Picea pungens	COND	COMMENT	CLASS WOODLAND	SAVE / REMOVE	¥	REPLACE
1822	₩S	6	White Spruce	Picea glauca	Fair		WOODLAND	R	¥	REPLACE
1823 1824	BS BS	8 7	Blue Spruce	Picea pungens	Fair		WOODLAND	R	¥	REPLACE
1825	SM	6	Blue Spruce Silver Maple	Picea pungens Acer saccharinum	Poor Good		WOODLAND INVASIVE	R S	Y Y	┨.
1826	SC	16	Scotch Pine	Pinus sylvestris	Fair		WOODLAND	S	Y]-
1827 1828	WP BS	16 7	(Eastern) White Pine Blue Spruce	Pinus strobus Picea pungens	Fair Fair		WOODLAND	S	Y ¥	- REPLACE
1829	BS	8	Blue Spruce	Picea pungens	Fair		WOODLAND WOODLAND	R R	¥	REPLACE
1830	WS	7	White Spruce	Picea glauca	Fair		WOODLAND	R	¥	REPLACE
1831 1832	WS WS	6	White Spruce White Spruce	Picea glauca Picea glauca	Poor		WOODLAND	R	¥ ¥	
1833	WS	6	White Spruce	Picea glauca	Poor		WOODLAND WOODLAND	R R	¥	┨.
1834	₩S	6	White Spruce	Picea glauca	Poor		WOODLAND	R	¥	_ -
1835 1836	WS BS	6	White Spruce Blue Spruce	Picea glauca Picea pungens	Fair Good		WOODLAND	R	¥ ¥	REPLACE REPLACE
1837	₩S	6	White Spruce	Picea glauca	Poor		WOODLAND WOODLAND	R R	¥	- REPLACE
1838	₩S	7	White Spruce	Picea glauca	Fair		WOODLAND	R	¥	REPLACE
1839 1840	WS WS	8	White Spruce White Spruce	Picea glauca Picea glauca	Fair Fair		WOODLAND	R	¥ ¥	REPLACE REPLACE
1841	BS	8	Blue Spruce	Picea pungens	Good		WOODLAND WOODLAND	R R	¥	REPLACE
1842	₩\$	7	White Spruce	Picea glauca	Fair		WOODLAND	R	¥	REPLACE
1843 1844	BS WS	9	Blue Spruce White Spruce	Picea pungens Picea glauca	Fair Poor		WOODLAND	R	¥ ¥	REPLACE
1845	BS	8	Blue Spruce	Picea pungens	Fair		WOODLAND WOODLAND	R R	¥	_ REPLACE
1846	BS	9	Blue Spruce	Picea pungens	Good		WOODLAND	R	¥	REPLACE
1847 1848	₩ S BS	6 8	White Spruce Blue Spruce	Picea glauca	Poor Fair		WOODLAND	R	¥ ¥	- - -
1849	BS	7	Blue Spruce	Picea pungens Picea pungens	Fair		WOODLAND WOODLAND	R R	¥	REPLACE REPLACE
1850	BS	8	Blue Spruce	Picea pungens	Fair		WOODLAND	R	¥	REPLACE
1851	NS	12	Norway Spruce	Picea Abies	Fair		WOODLAND	S	N]-
1852 1853	NS BS	13 8	Norway Spruce Blue Spruce	Picea Abies Picea pungens	Fair Fair		WOODLAND WOODLAND	S R	N ¥	- REPLACE
1854	WS	8	White Spruce	Picea glauca	Fair		WOODLAND	R	¥	REPLACE
1855	BS	8	Blue Spruce	Picea pungens	Fair		WOODLAND	R	¥	REPLACE
1856 1857	WS BS	9 8	White Spruce Blue Spruce	Picea glauca Picea pungens	Fair Fair		WOODLAND WOODLAND	R R	¥ ¥	REPLACE REPLACE
1858	WS	6	White Spruce	Picea glauca	Poor		WOODLAND	R	¥	
1859	BS	8	Blue Spruce	Picea pungens	Fair		WOODLAND	R	¥	REPLACE
1860 1861	BS NM	9 10	Blue Spruce Norway Maple	Picea pungens Acer platanoides	Fair Good		WOODLAND INVASIVE	R S	Y N	REPLACE
1862	BP	13	Bradford Pear	Pyrus calleryanna	Good		INVASIVE	S	N	┨.
1863	SM	12	Silver Maple	Acer saccharinum	Fair		INVASIVE	S	N]-
1864 1865	BS BS	7 9	Blue Spruce Blue Spruce	Picea pungens Picea pungens	Poor Fair		WOODLAND WOODLAND	R R	¥ ¥	- REPLACE
1866	WS	9	White Spruce	Picea glauca	Poor		WOODLAND	R R	¥	-
1867	₩S	6	White Spruce	Picea glauca	Poor		WOODLAND	R	¥]-
1868 1869	BS WS	7 5	Blue Spruce White Spruce	Picea pungens Picea glauca	Fair Poor		WOODLAND	R	¥ ¥	REPLACE
1870	₩S	5	White Spruce	Picea glauca	Poor		WOODLAND WOODLAND	R R	¥	-[-
1871	₩S	6	White Spruce	Picea glauca	Poor		WOODLAND	R	¥	_ -
1872 1873	BS NM	8	Blue Spruce	Picea pungens Acer platanoides	Fair Good		WOODLAND	R G	¥	REPLACE
1874	NM	6	Norway Maple Norway Maple	Acer platanoides Acer platanoides	Good		INVASIVE INVASIVE	S S	N N	┨.
1875	NM	6	Norway Maple	Acer platanoides	Good		INVASIVE	S	N	
1876 1877	NS	8	Norway Spruce	Picea Abies	Good		WOODLAND	S	N	-}-
1878	NS BS	8 7	Norway Spruce Blue Spruce	Picea Abies Picea pungens	Good Fair		WOODLAND WOODLAND	S R	Y ¥	_ REPLACE
1879	BS	8	Blue Spruce	Picea pungens	Good		WOODLAND	R	¥	REPLACE
1880	BS	8	Blue Spruce	Picea pungens	Good		WOODLAND	R	¥	REPLACE
1881 1882	BS BS	9 7	Blue Spruce Blue Spruce	Picea pungens Picea pungens	Fair Poor		WOODLAND WOODLAND	R R	¥ ¥	REPLACE
1883	BS	9	Blue Spruce	Picea pungens	Fair		WOODLAND	R	¥	REPLACE
1884	BS	7	Blue Spruce	Picea pungens	Fair		WOODLAND	R	¥	REPLACE
1885 1886	BS BS	8	Blue Spruce Blue Spruce	Picea pungens Picea pungens	Fair Fair		WOODLAND WOODLAND	R R	¥ ¥	REPLACE REPLACE
1887	BS	7	Blue Spruce	Picea pungens	Fair		WOODLAND	R	¥	REPLACE
1888	₩S	8	White Spruce	Picea glauca	Fair		WOODLAND	R	¥	REPLACE
1889 1890	WS BS	8 7	White Spruce Blue Spruce	Picea glauca Picea pungens	Fair Poor		WOODLAND	R R	¥ ¥	REPLACE
1891	BS	7	Blue Spruce	Picea pungens	Fair		WOODLAND WOODLAND	S	Y	-[.
1892	BS	6	Blue Spruce	Picea pungens	Poor		WOODLAND	S	Υ]-
1893 1894	BS BS	11	Blue Spruce Blue Spruce	Picea pungens Picea pungens	Fair Fair		WOODLAND	S	Y	-[
1895	WS BS	8	White Spruce	Picea glauca	Poor		WOODLAND WOODLAND	S S	Y	
1896	NS	12	Norway Spruce	Picea Abies	Fair		WOODLAND	S	Y].
1897 1898	BS BS	12 11	Blue Spruce	Picea pungens	Fair Poor		WOODLAND	S	Y	1
1898 1899	WW BS	11	Blue Spruce Weeping Willow	Picea pungens Salix babylonica	Poor		WOODLAND INVASIVE	S S	Y	
1900	WW	13	Weeping Willow	Salix babylonica	Fair		INVASIVE	S	Y]-
1901	NS NS	8	Norway Spruce	Picea Abies	Very Poor		WOODLAND	S	Y	1
1902 1903	NS BS	7 10	Norway Spruce Blue Spruce	Picea Abies Picea pungens	Very Poor Very Poor		WOODLAND WOODLAND	S S	Y	-[
	NS	14	Norway Spruce	Picea Abies	Fair		WOODLAND	S	Y	<u></u>
1904	AU	27	Austrian Pine	Pinus nigra	Good		LANDMARK	S	N	1
1905		23	Austrian Pine Red Pine	Pinus nigra Pinus resinosa	Good Fair		LANDMARK LANDMARK	S S	N N	-[
	AU RP	19		Pinus resinosa	Fair		WOODLAND	S	N].
1905 1906 1907 1908	AU RP RP	14	Red Pine		Good		INVASIVE	S	N	-
1905 1906 1907 1908 1909	AU RP RP CT	14 58	Red Pine Cottonwood	Populus deltoides			XXX ~ ~ -			I-
1905 1906 1907 1908	AU RP RP	14	Red Pine Cottonwood Red Pine		Fair Good		WOODLAND LANDMARK	S	N N	┪.
1905 1906 1907 1908 1909 1910 1911 1912	AU RP RP CT RP RP RP	14 58 14 20 22	Red Pine Cottonwood Red Pine Red Pine Red Pine	Populus deltoides Pinus resinosa	Fair		WOODLAND LANDMARK LANDMARK	S S S	N N N].].
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1905 1906 1907 1908 1909 1910 1911 1912 1913 1914 1915 1916 1917	AU RP RP CT RP	14 58 14 20 22 23 18 21 19	Red Pine Cottonwood Red Pine	Populus deltoides Pinus resinosa	Fair Good Good Good Fair Fair Poor Fair		LANDMARK LANDMARK LANDMARK LANDMARK LANDMARK LANDMARK WOODLAND	S S S S	N N N N	- - - - - - - - - - - - - - - - - - -
1905 1906 1907 1908 1909 1910 1911 1912 1913 1914 1915 1916 1917 1918	AU RP RP CT RP	14 58 14 20 22 23 18 21 19 17	Red Pine Cottonwood Red Pine	Populus deltoides Pinus resinosa	Fair Good Good Fair Fair Poor Fair Poor		LANDMARK LANDMARK LANDMARK LANDMARK LANDMARK LANDMARK WOODLAND	S S S S S S S S S S	N N N N N N	-
1905 1906 1907 1908 1909 1910 1911 1912 1913 1914 1915 1916 1917	AU RP RP CT RP	14 58 14 20 22 23 18 21 19 17 17	Red Pine Cottonwood Red Pine	Populus deltoides Pinus resinosa	Fair Good Good Good Fair Fair Poor Fair		LANDMARK LANDMARK LANDMARK LANDMARK LANDMARK LANDMARK WOODLAND WOODLAND LANDMARK	S S S S S S S S S S S S S S S S S S S	N N N N N	-
1905 1906 1907 1908 1909 1910 1911 1912 1913 1914 1915 1916 1917 1918 1919	AU RP RP CT RP	14 58 14 20 22 23 18 21 19 17	Red Pine Cottonwood Red Pine	Populus deltoides Pinus resinosa	Fair Good Good Fair Fair Poor Fair Poor Poor		LANDMARK LANDMARK LANDMARK LANDMARK LANDMARK LANDMARK WOODLAND	S S S S S S S S S S	N N N N N N N N N N N N N N N N N N N	
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KEY: NIC FOR REPLACEMENT = DEAD, DAMAGED, DISEASED, INVASIVE SPECIES

STRIKETHROUGH, R = TREES TO REMOVE
TYP. TEXT = TREES TO SAVE, S

SEE SHEET L-1.0 FOR TREE REPLACEMENT IF APPLICABLE

 WOODLAND TREES
 115
 (REPLACE AT 50% OF REMOVED DBH)

 1080" DBH x 0.5 =
 540" REPLACEMENT

 WOODLAND TREES SAVED:
 26
 (CREDIT OF 2X DBH)

 234
 DBH x 2 =
 468" CREDIT

 540
 468
 =
 72

72 " DBH REQUIRED FOR REPLACEMENT

 LANDMARK TREES

 LANDMARK TREES REMOVED:
 1
 (REPLACE AT 100% OF REMOVED DBH)

 18"
 DBH x 1 =
 18"
 REPLACEMENT

 LANDMARK TREES SAVED:
 0
 (CREDIT OF 2X DBH)

 "
 DBH x 2 =
 "
 CREDIT

 18
 0
 =
 18

18 " DBH REQUIRED FOR REPLACEMENT

EXEMPT TREES			
(NO REPLACEMENT REQUIRED	FOR EXEM	IPT TREES)	
SAVED EXEMPT TREES:	6	Trees	
EXEMPT TREES ON SITE:	6	Trees	

PEA GROUP

t: 844.813.2949 www.peagroup.com





CAUTION!!

THE LOCATIONS AND ELEVATIONS OF EXISTING UNDERGROUND UTILITIES AS SHOWN ON THIS DRAWING ARE ONLY APPROXIMATE. NO GUARANTEE IS EITHER EXPRESSED OR IMPLIED AS TO THE COMPLETENESS OR ACCURACY THEREOF. THE CONTRACTOR SHALL BE EXCLUSIVELY RESPONSIBLE FOR DETERMINING THE EXACT UTILITY LOCATIONS AND ELEVATIONS PRIOR TO THE START OF CONSTRUCTION.

CLIENT

TROV SI

TROY SPORTS CENTER, LLC 1819 EAST BIG BEAVER ROAD TTOY, MI 48083

PROJECT TITLE

JOHN R
COMMONS
TOWNHOME
DEVELOPMENT
PART OF THE SE 1/4 OF SECTION 23, T.
2N., R. 11E.
TROY, OAKLAND COUNTY, MI


REVISIONS	
SPA COMMENTS	11/8/23
SPA COMMENTS	3/1/24
SPA/PC COMMENTS	5/3/24
SPA/PC COMMENTS	7/12/24

ORIGINAL ISSUE DATE: AUGUST 18, 2023

DRAWING TITLE

EXISTING TREE LIST

PEA JOB NO.	18-0034
P.M.	GMB
DN.	BZ
DES.	JLE
DRAWING NUMBER:	

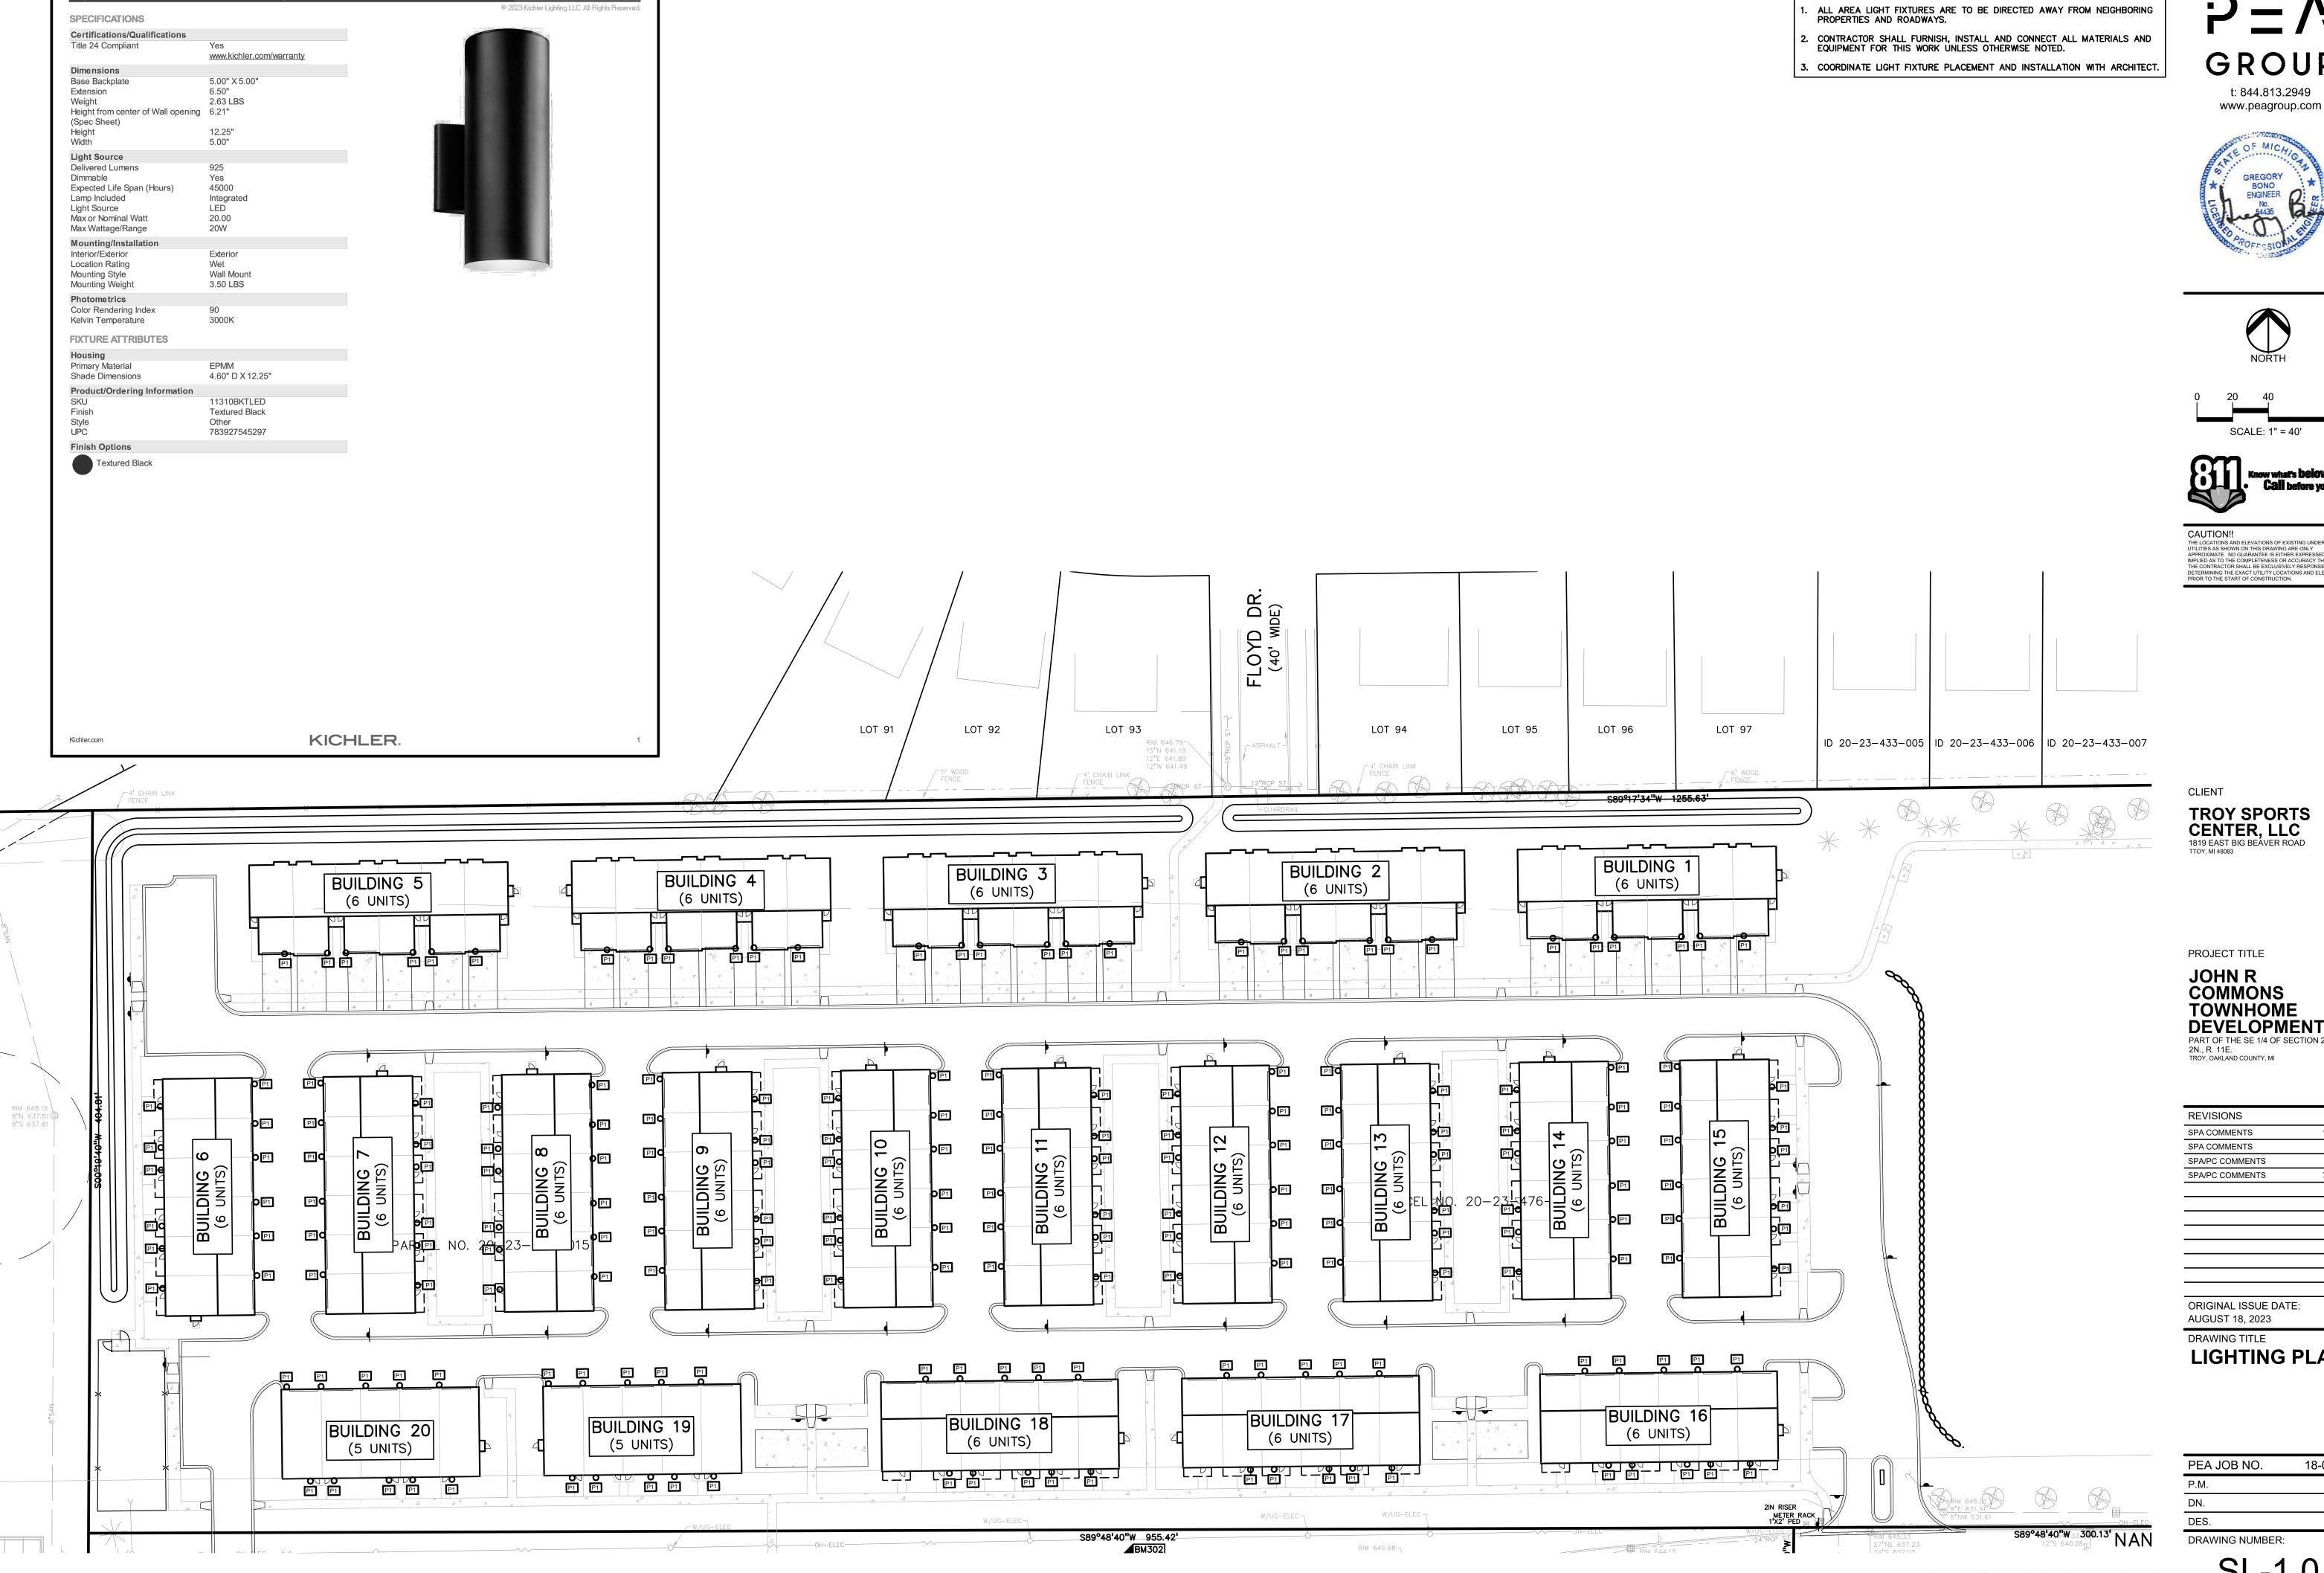

Cylinder 3000K LED 12.25" Wall Light

GROUP

t: 844.813.2949

GENERAL SITE LIGHTING NOTES:









THE LOCATIONS AND ELEVATIONS OF EXISTING UNDERGROUND UTILITIES AS SHOWN ON THIS DRAWING ARE ONLY APPROXIMATE. NO GUARANTEE IS EITHER EXPRESSED OR IMPLIED AS TO THE COMPLETENESS OR ACCURACY THEREOF. THE CONTRACTOR SHALL BE EXCLUSIVELY RESPONSIBLE FOR DETERMINION THE EXACT UTILITY LOCATIONS AND ELEVATIONS PRIOR TO THE START OF CONSTRUCTION.

TROY SPORTS CENTER, LLC 1819 EAST BIG BEAVER ROAD TTOY, MI 48083

JOHN R
COMMONS
TOWNHOME
DEVELOPMENT
PART OF THE SE 1/4 OF SECTION 23, T.
2N., R. 11E.
TROY, OAKLAND COUNTY, MI

REVISIONS	
SPA COMMENTS	11/8/23
SPA COMMENTS	3/1/24
SPA/PC COMMENTS	5/3/24
SPA/PC COMMENTS	7/12/24

ORIGINAL ISSUE DATE:

LIGHTING PLAN

18-0034 GMB CNR GMB

DRAWING NUMBER:

NOT FOR CONSTRUCTION

JOHN R. TOWNHOME DEVELOPMENT

BUILDING TYPE 'A'

TROY, MICHIGAN

CODE SUMMARY


CODE:
2015 MICHIGAN RESIDENTIAL CODE: TOWNHOUSE OPTION


TENANT SEPARATION: I HOUR REQUIRED
2 HOUR PROVIDED

FIRE SUPPRESSION: N/A

TYPE 'A' DWELLING UNITS: N/A

TYPE 'B' DWELLING UNITS: N/A (MULTI-STORY DWELLING UNITS)

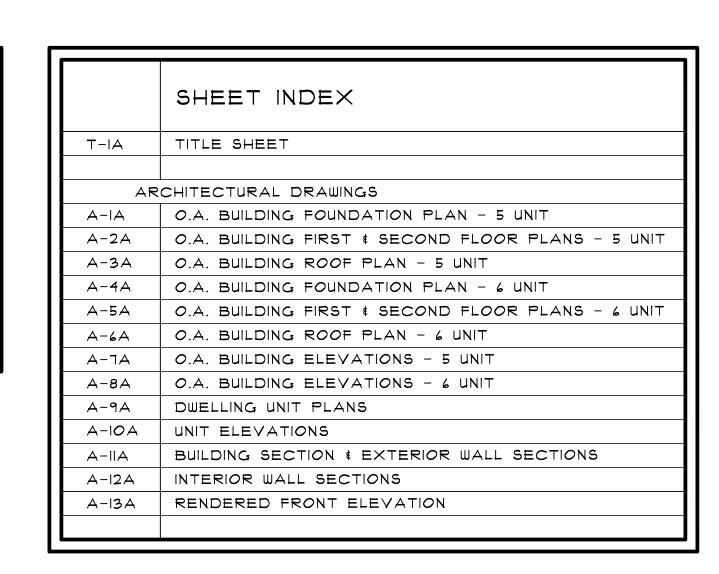

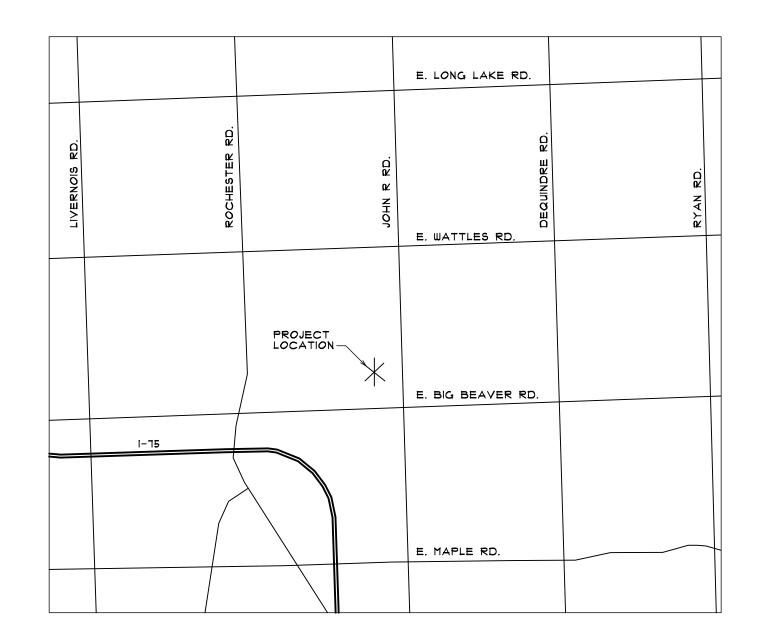




ARCHITECT:

BRIAN NEEPER ARCHITECTURE P.C. 630 N. OLD WOODWARD, SUITE 203

BIRMINGHAM, MICHIGAN 48009 248. 259. 1784

Brian•BrianNeeper.com

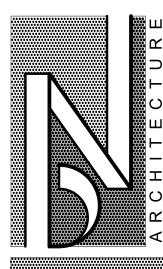

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BIRMINGHAM, MICHIGAN
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TITLE SHEET

JOHN R TOWNHOME DEV BUILDING TYPE 'A' TROY, MICHIGAN

03-27-24

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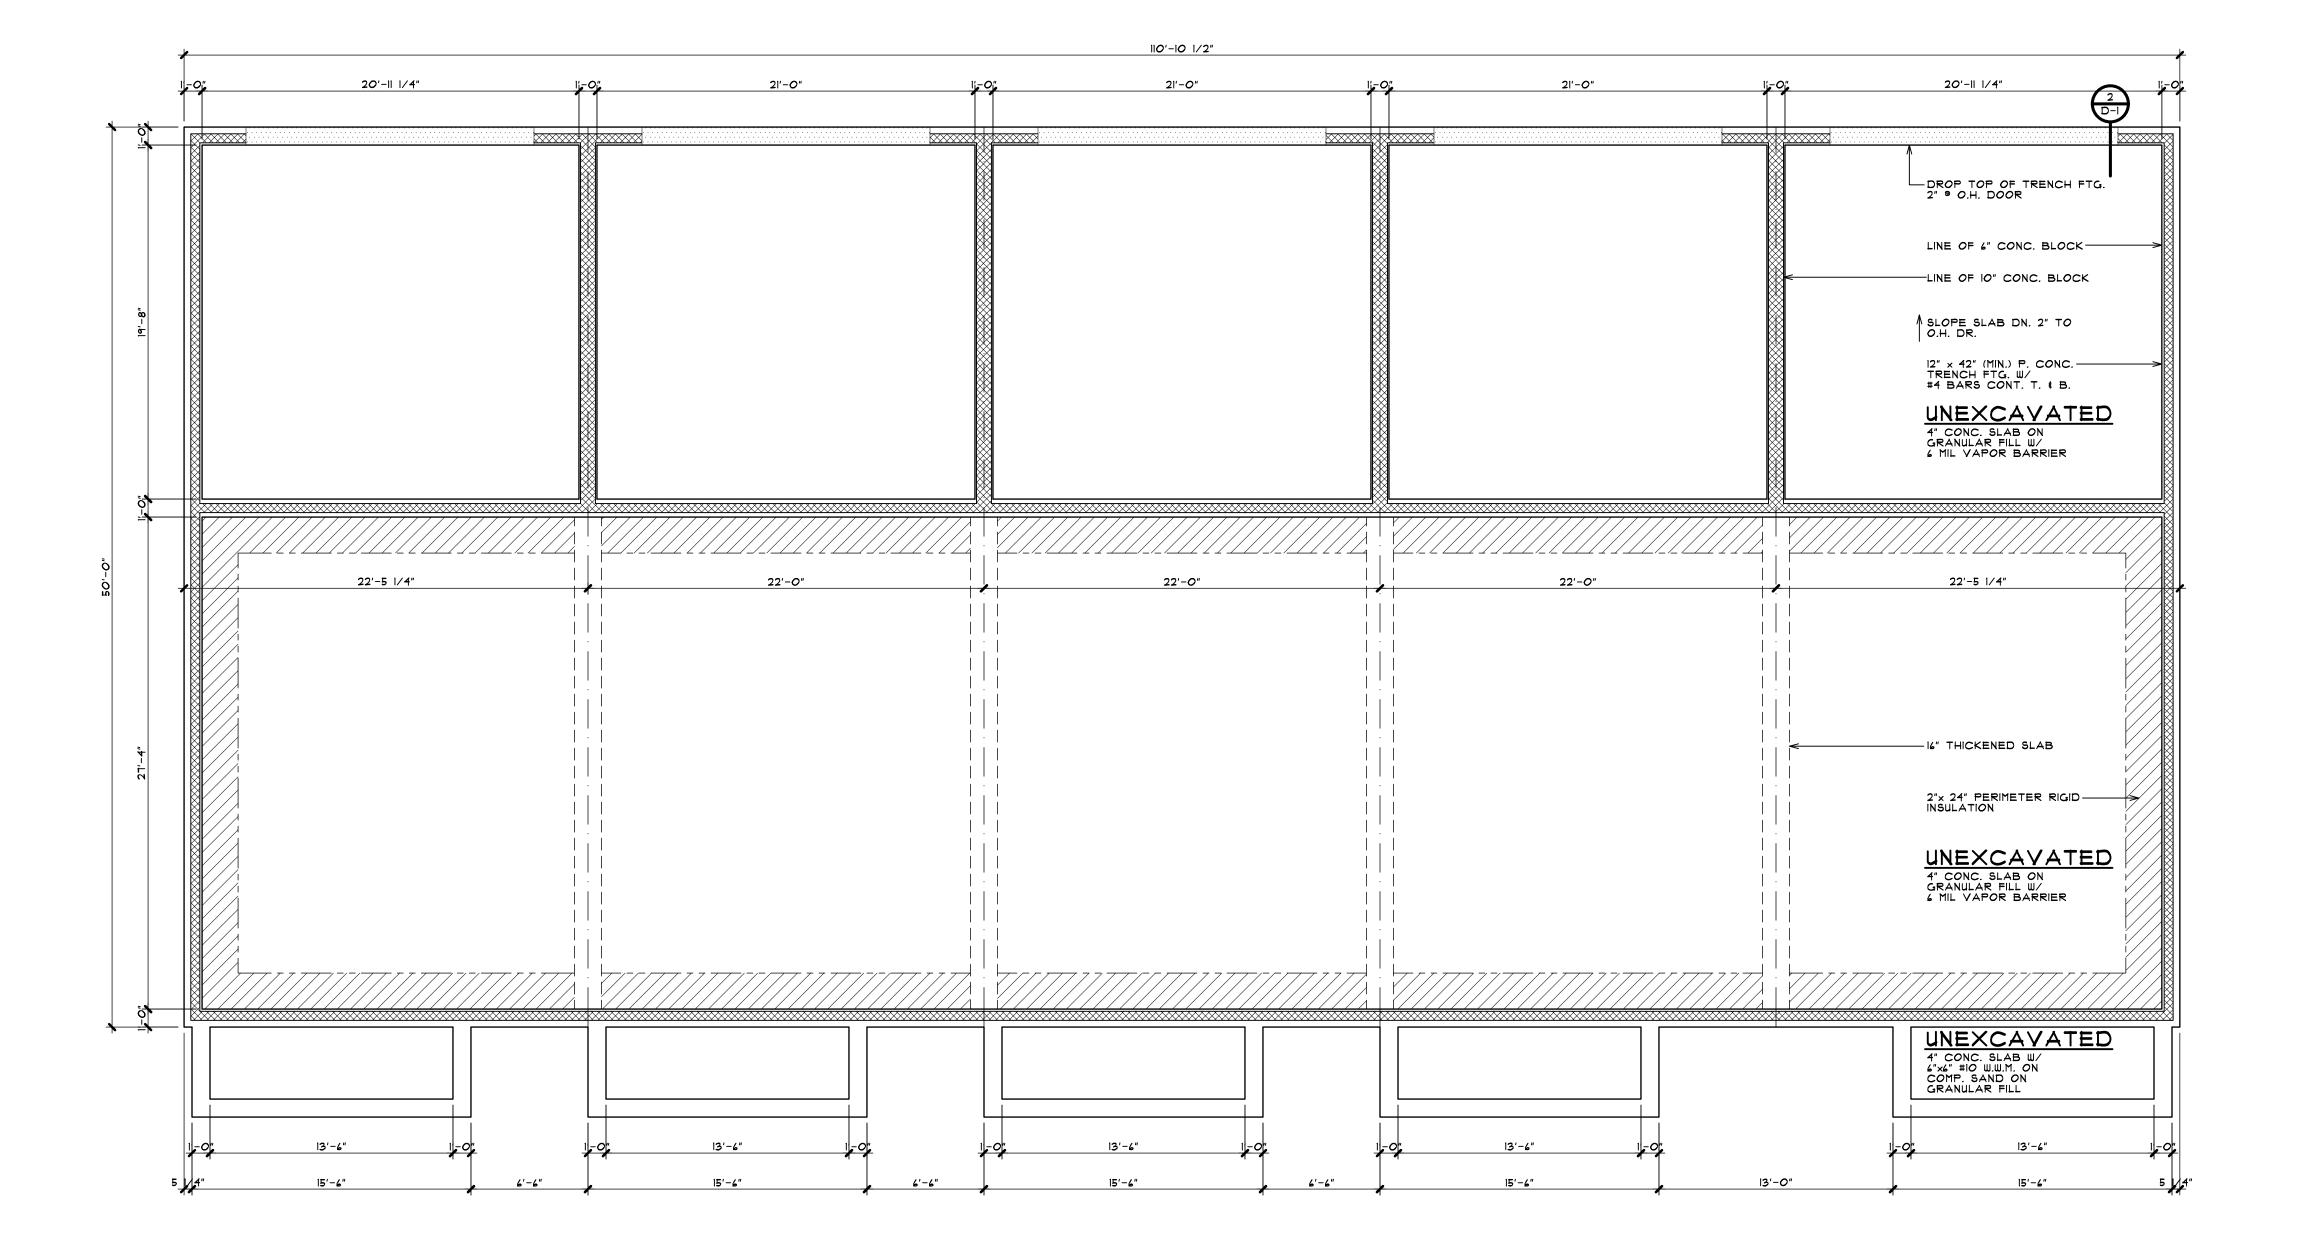
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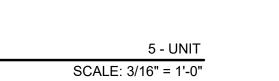
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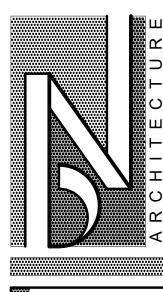
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FOUNDATION PLAN - BUILDING TYPE 'A'





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BIRMINGHAM, MICHIGAN
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DG. TYPE 'A'-5

OHN R TOWNHOME DEV

	PRELIMINARY
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	BIDS
	PERMITS
	FINAL
	REVISIONS 07-10-24


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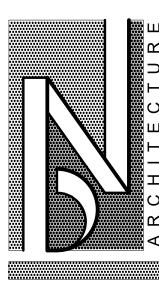
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FIRST FLOOR PLAN - BUILDING TYPE 'A'

5 - UNIT SCALE: 1/8" = 1'-0"



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BIRMINGHAM, MICHIGAN

lst & 2nd FLOOR PL BLDG, TYPE 'A'-5

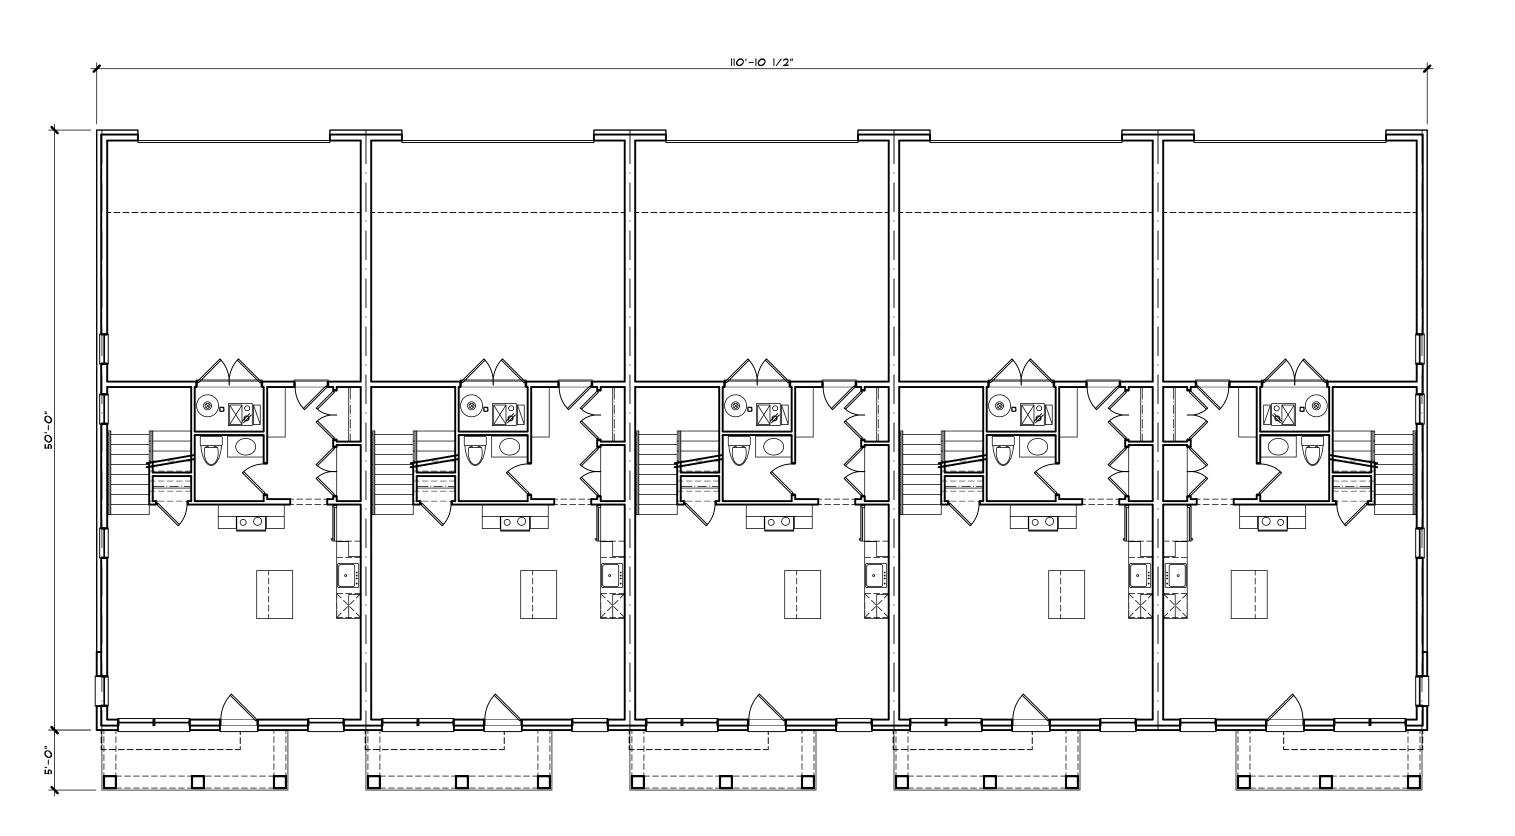JOHN R TOWNHOME DE BUILDING TYPE 'A'

PRELIMINARY 03-27-24
BIDS
PERMITS
FINAL
REVISIONS 07-10-24

EXCEPTION: THE MINIMUM NET FREE VENTILATION AREA SHALL BE 1/300 OF THE VENTED SPACE, PROVIDED BOTH OF THE FOLLOWING CONDITIONS ARE MET:

IN CLIMATE ZONES 4, 7, AND 8, A CLASS I OR II VAPOR RETARDER IS INSTALLED ON THE WARM-IN-WINTER SIDE OF THE CEILING.

2. NOT LESS THAN 40 PERCENT AND NOT MORE THAN 50 PERCENT OF THE REQUIRED VENTILATING AREA IS PROVIDED BY VENTILATORS LOCATED IN THE UPPER PORTION OF THE ATTIC OR RAFTER SPACE. UPPER VENTILATORS SHALL BE LOCATED NOT MORE THAN 3 FEET BELOW THE RIDGE OR HIGHEST POINT OF THE SPACE, MEASURED VERTICALLY. THE BALANCE OF THE REQUIRED VENTILATION PROVIDED SHALL BE LOCATED IN THE BOTTOM ONE-THIRD OF THE ATTIC SPACE. WHERE THE LOCATION OF WALL OR ROOF FRAMING MEMBERS CONFLICTS WITH THE INSTALLATION OF UPPER VENTILATORS, INSTALLATION MORE THAN 3 FEET BELOW THE RIDGE OR HIGHEST POINT OF THE SPACE SHALL BE PERMITTED.

OVERHANGS & DRAINAGE

PROVIDE GUTTERS & DOWNSPOUTS FOR DRAINAGE OF ROOF WATER. DOWNSPOUTS ARE TO BE CONNECTED TO STORM WATER COLLECTION SYSTEM. SEE CIVIL ENGINEER DWGs FOR CONNECTION DETAILS/LOCATIONS. DOWNSPOUT LOCATIONS ARE TO BE DETERMINED BY THE

UNLESS NOTED OTHERWISE OVERHANG DIMENSIONS ARE 12" FROM SHEATHING. RAKE DIMENSIONS ARE 4" AT BRICK AND 6" AT SIDING.

ROOF VENTING CALCULATIONS:

PROPOSED VENT AREA PER UNIT VENT AREA RATIO 1:150 ATTIC AREA = 966 SQ.FT. (1/300)

VENT AREA = 3.22 SQ.FT. x 144 = 464 SQ.IN. 55% SOFFIT = 255 SQ.IN. EACH 45% RIDGE = <u>209</u> SQ.IN. EACH

VENT AREA PROVIDED * RIDGE

CONT. RIDGE TYPE 9 18 SQ.IN. PER FT. = 12 LIN.FT. TOTAL VENTING AT RIDGE = 216 SQ.IN.

VENT AREA PROVIDED & SOFFIT

16"x 8" SOFFIT VENT 9 <u>50</u> SQ.IN. PER UNIT = <u>6</u> UNITS TOTAL VENTING AT SOFFIT = 300 SQ.IN.

PROPOSED VENT AREA PER UNIT ® LOWER GARAGE VENT AREA RATIO 1:150


ATTIC AREA = 143 SQ.FT. (1/150) VENT AREA = <u>0.95</u> SQ.FT. x 144 = <u>137</u> SQ.IN.

50% SOFFIT AND 50% RIDGE = _68.5 SQ.IN. EACH

VENT AREA PROVIDED * RIDGE OMNI-WALL VENT ® 9 SQ.IN. PER FT. = 8 LIN.FT. TOTAL VENTING AT RIDGE = 12 SQ.IN.

VENT AREA PROVIDED * SOFFIT

CONTINUOUS SOFFIT TYPE 9 9 SQ.IN. PER FT. = 8 LIN.FT. TOTAL VENTING AT SOFFIT = 12 SQ.IN.

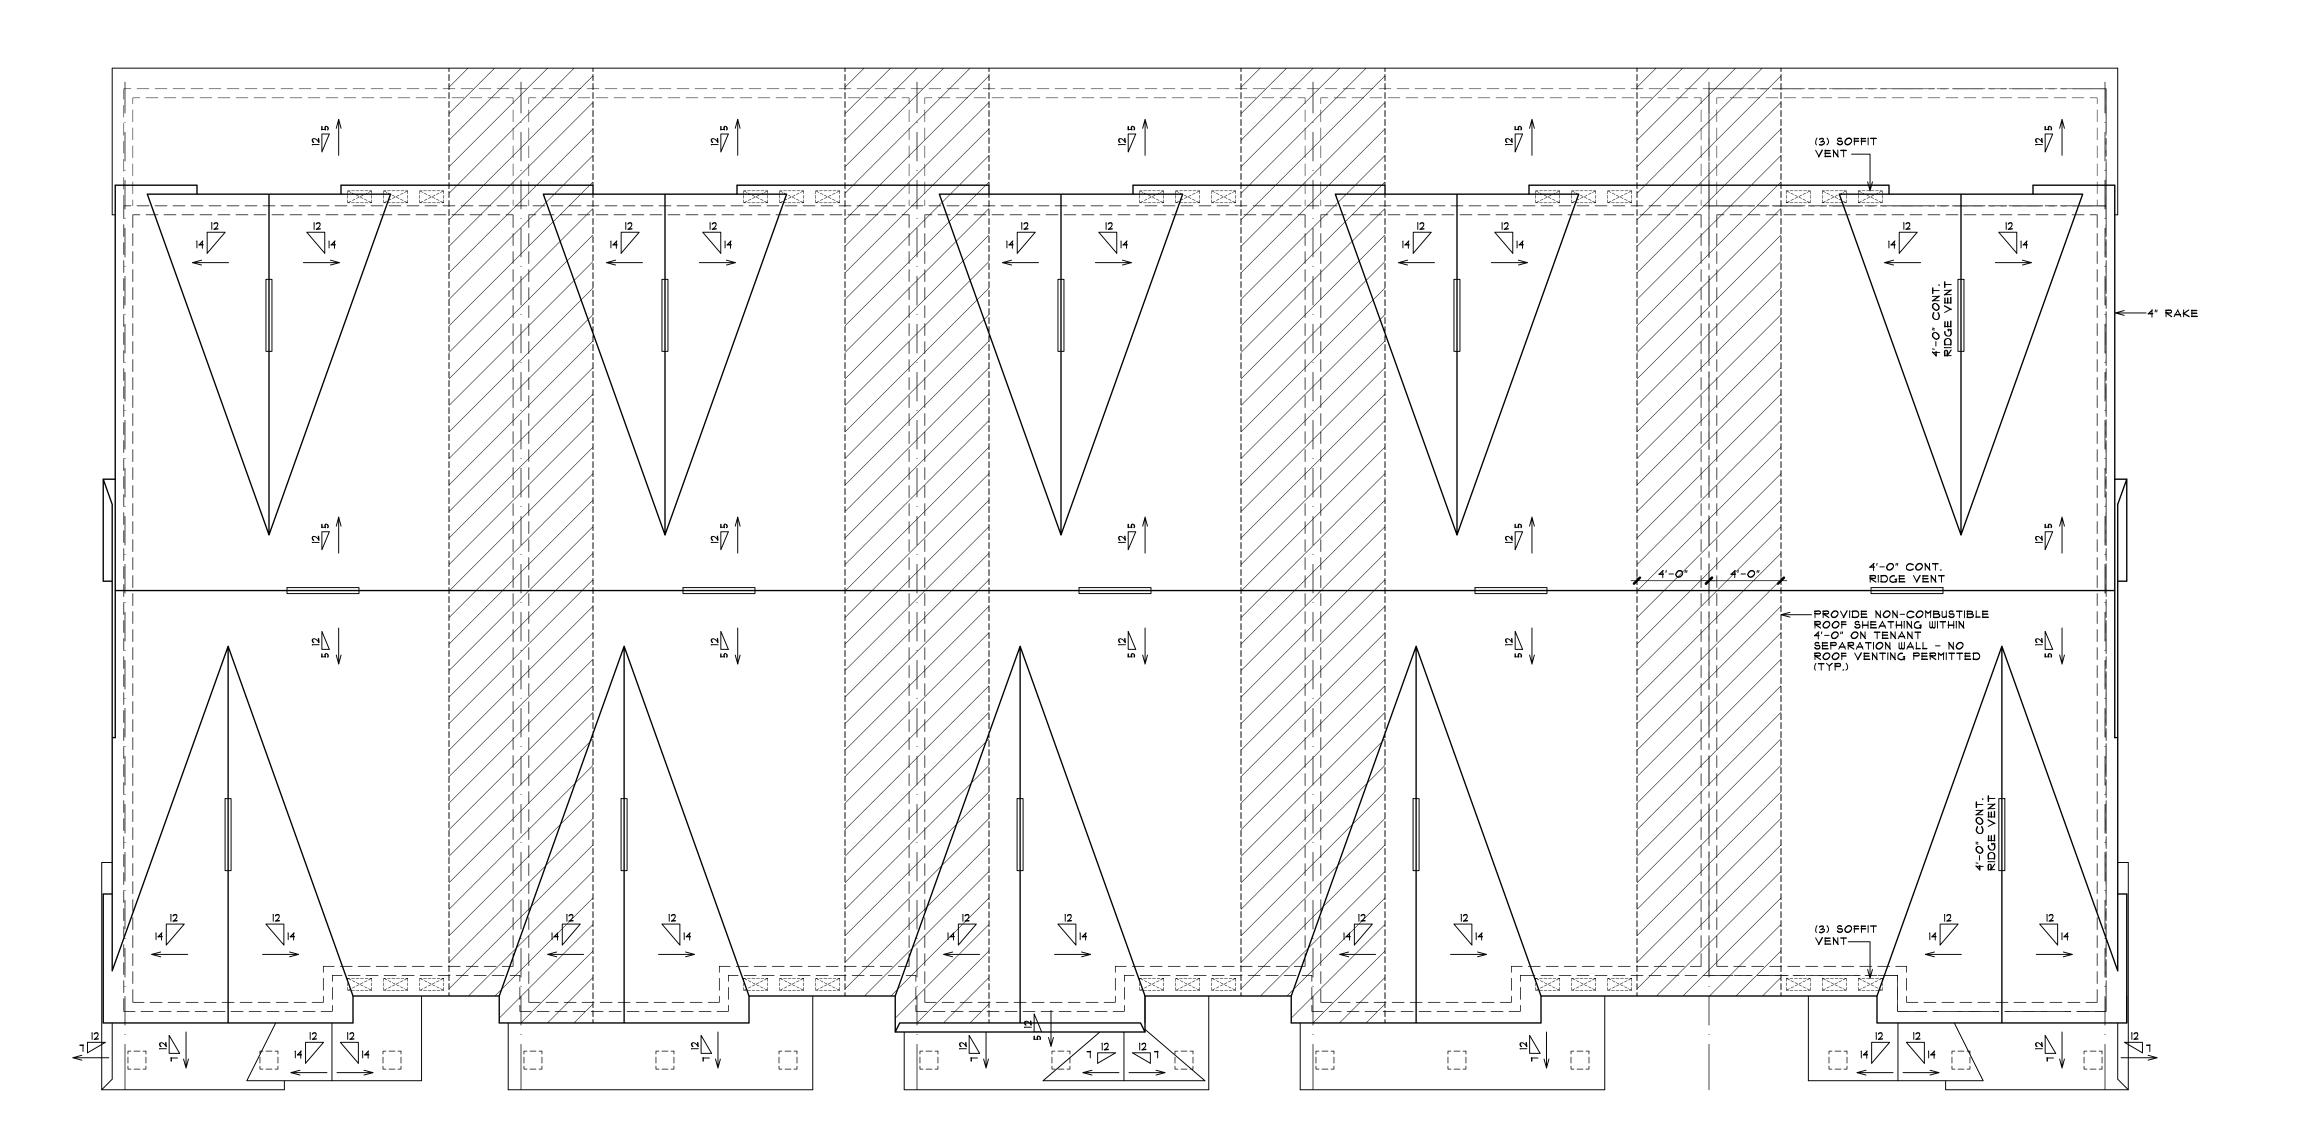

ROOF PLAN - BUILDING TYPE 'A'

SCALE: 3/16" = 1'-0"


5 - UNIT



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ANNING - INTERIORS
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TION PLAN YPE 'A'-6 UNIT

BLDG. TY

JOHN R TOWNHOME I BUILDING TYPE 'A'
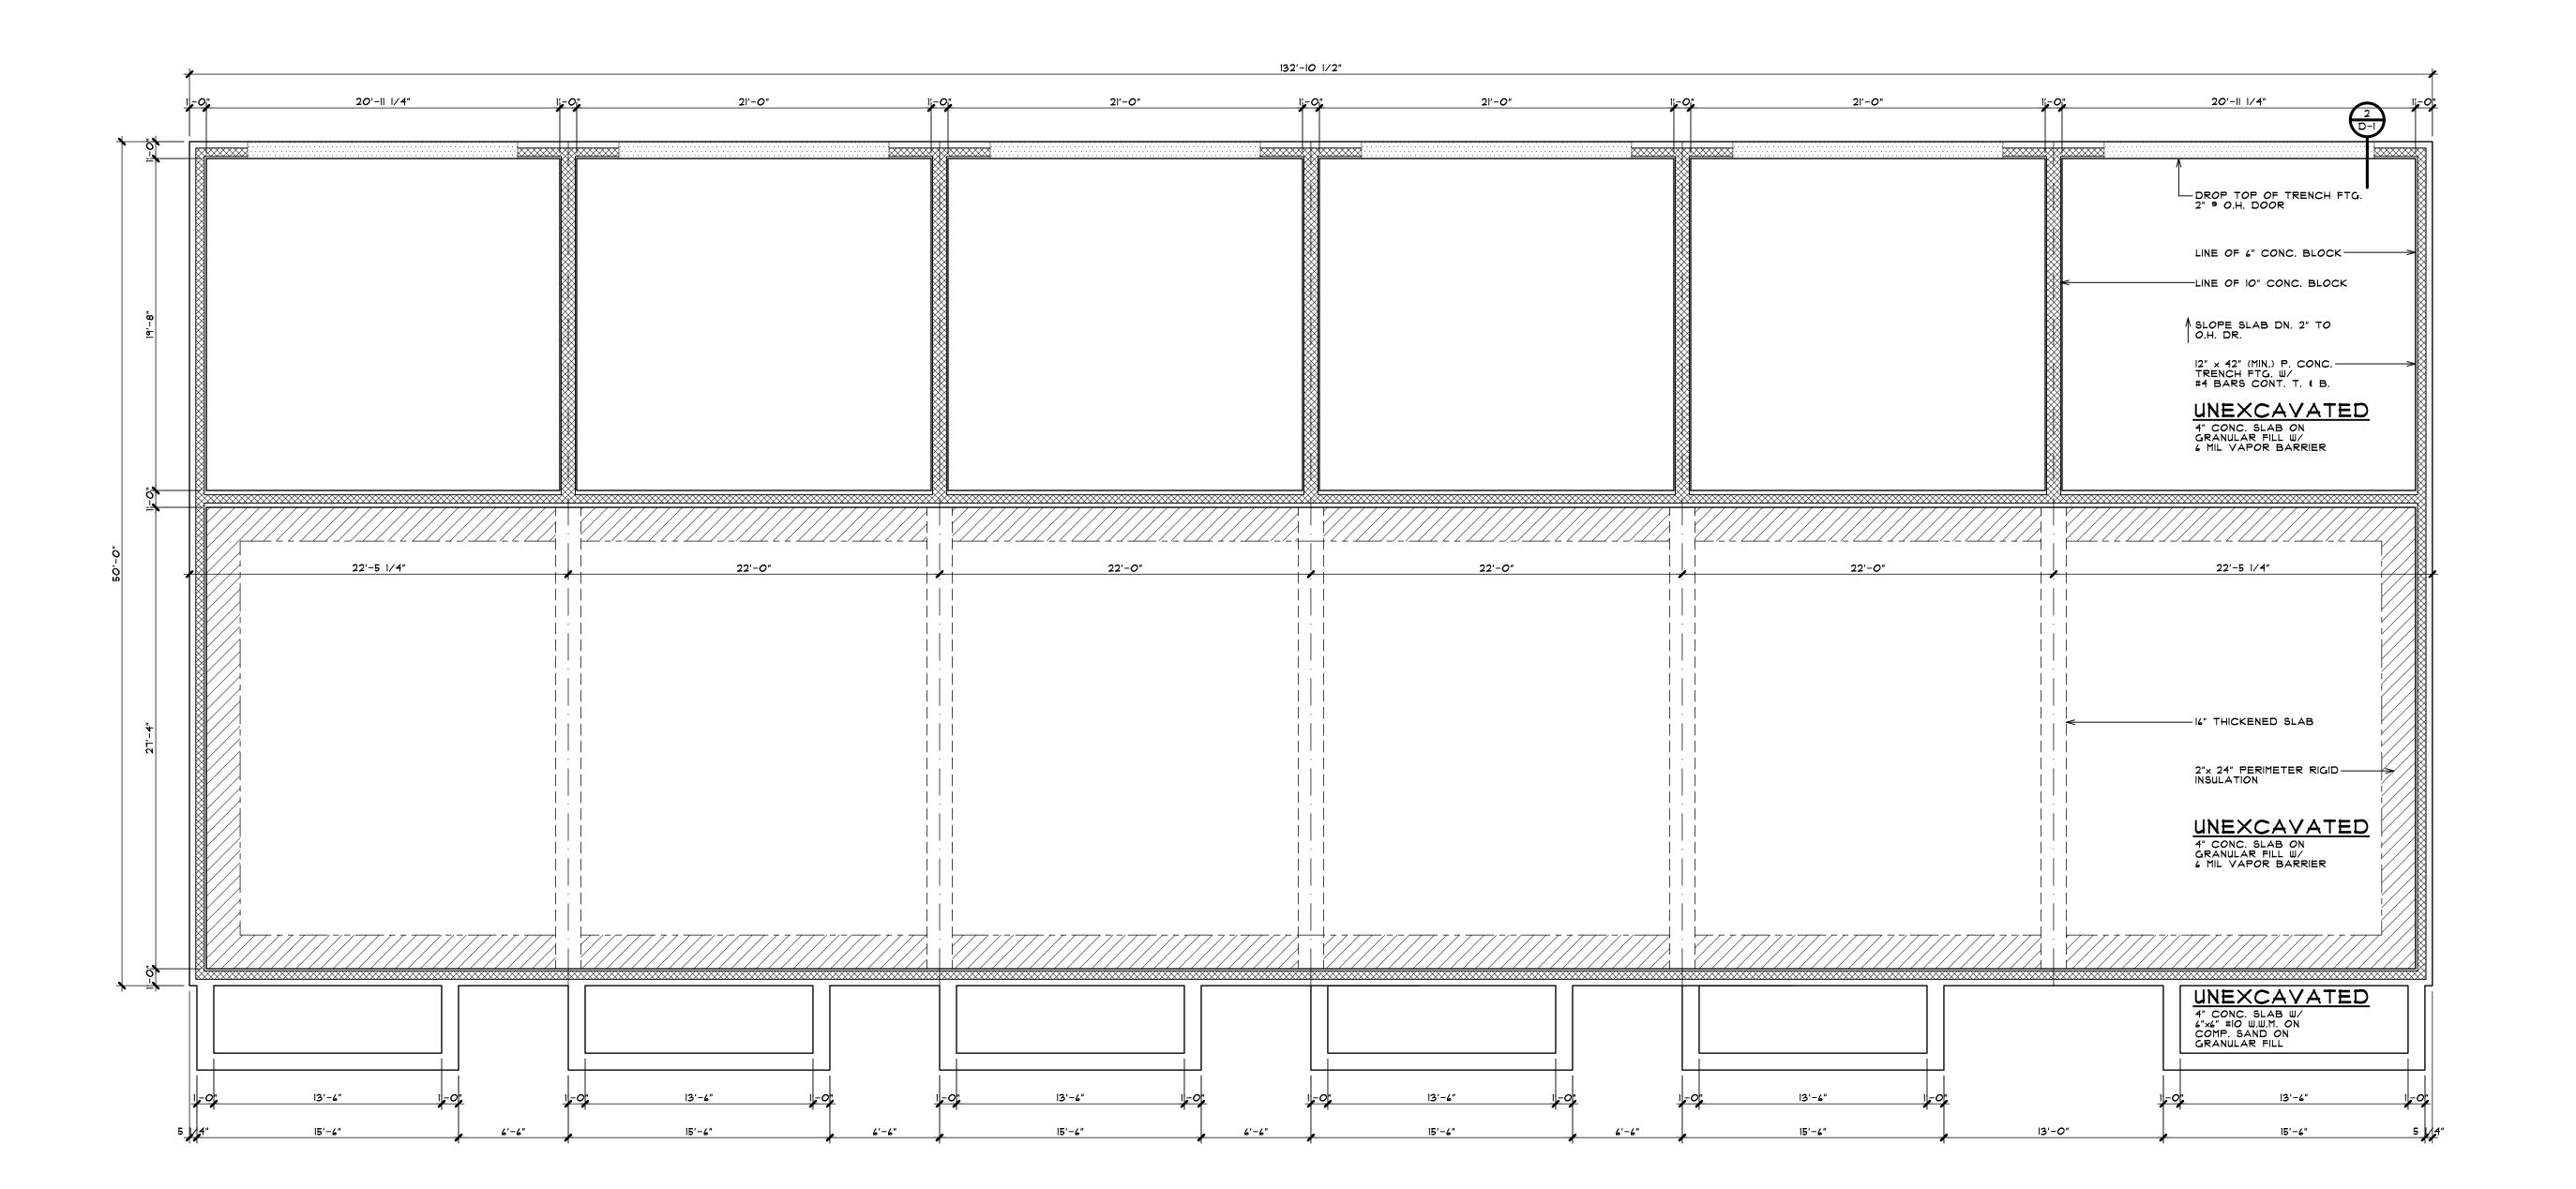
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PERMITS

FINAL


REVISIONS 07-10-24


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St & 2nd FLOOR PLA BLDG, TYPE 'A'-6 UI

JOHN R TOWNHOME DE BUILDING TYPE 'A'

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EXCEPTION: THE MINIMUM NET FREE VENTILATION AREA SHALL BE 1/300 OF THE VENTED SPACE, PROVIDED BOTH OF THE FOLLOWING CONDITIONS ARE MET:

WARM-IN-WINTER SIDE OF THE CEILING.

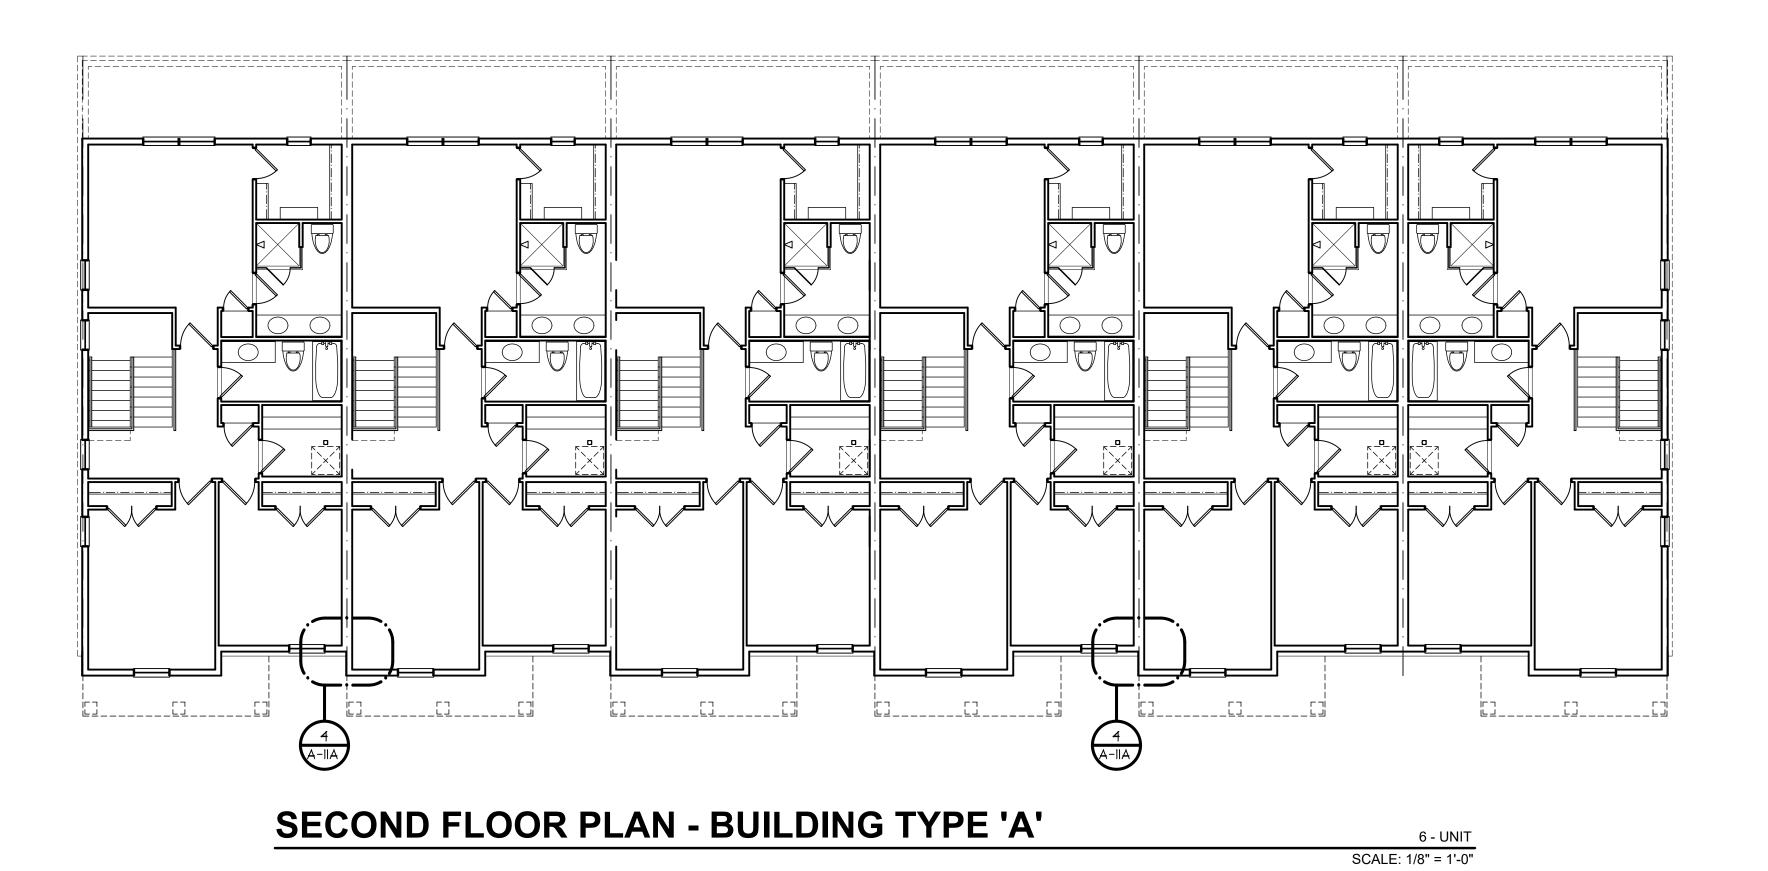IN CLIMATE ZONES 4, 7, AND 8, A CLASS I OR II VAPOR RETARDER IS INSTALLED ON THE

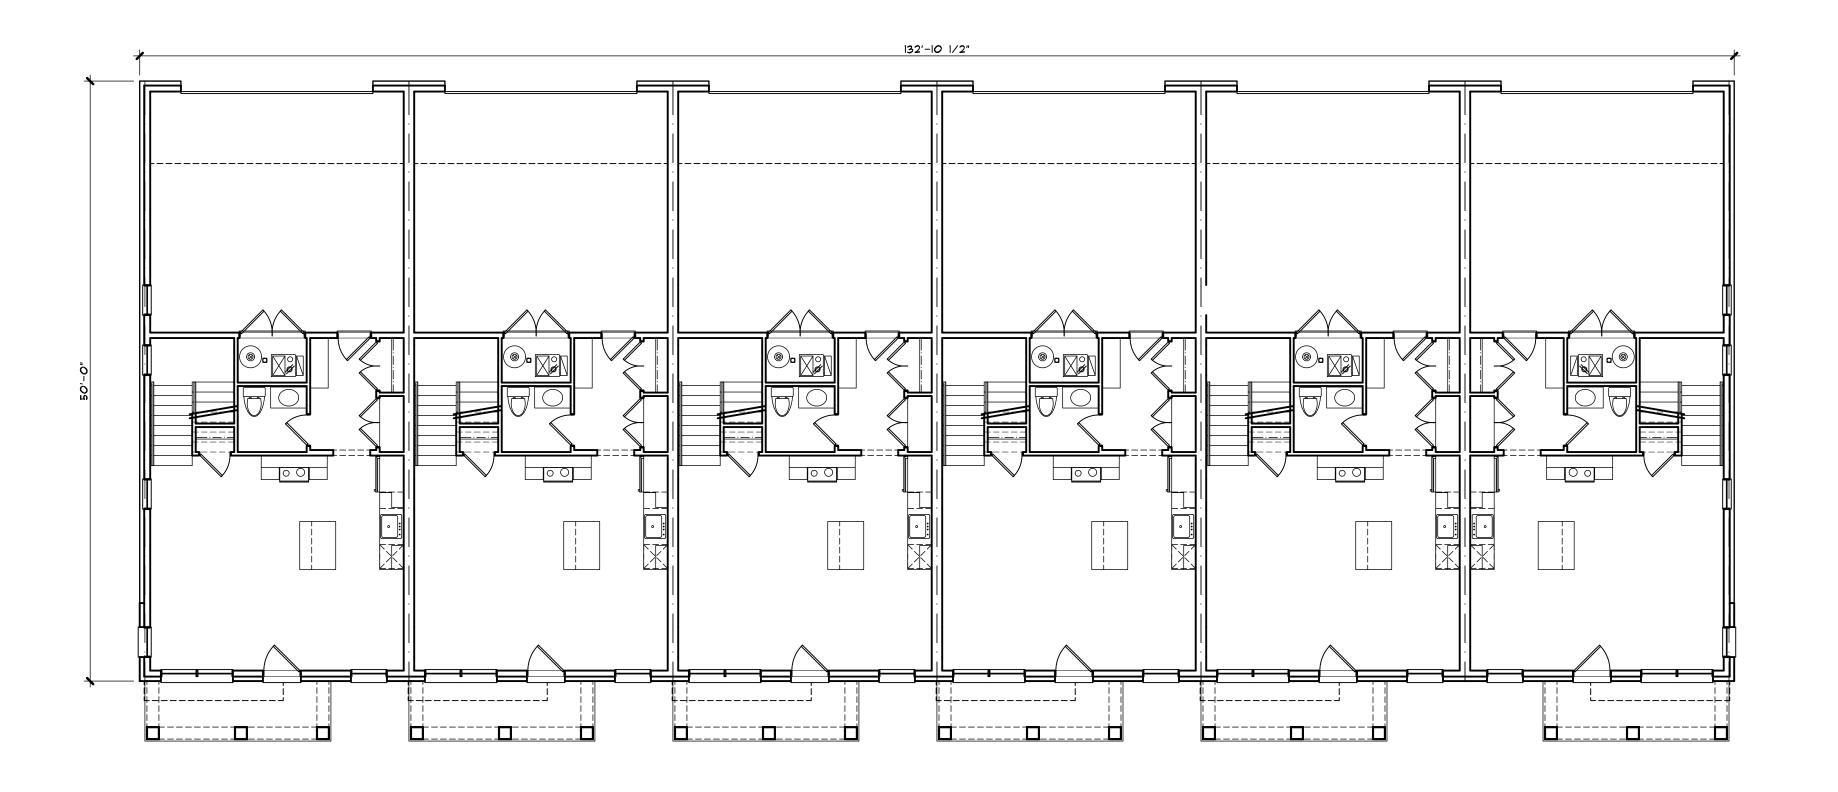2. NOT LESS THAN 40 PERCENT AND NOT MORE THAN 50 PERCENT OF THE REQUIRED VENTILATING AREA IS PROVIDED BY VENTILATORS LOCATED IN THE UPPER PORTION OF THE ATTIC OR RAFTER SPACE. UPPER VENTILATORS SHALL BE LOCATED NOT MORE THAN 3 FEET BELOW THE RIDGE OR HIGHEST POINT OF THE SPACE, MEASURED VERTICALLY. THE BALANCE OF THE REQUIRED VENTILATION PROVIDED SHALL BE LOCATED IN THE BOTTOM ONE-THIRD OF THE ATTIC SPACE. WHERE THE LOCATION OF WALL OR ROOF FRAMING MEMBERS CONFLICTS WITH THE INSTALLATION OF UPPER VENTILATORS, INSTALLATION MORE THAN 3 FEET BELOW THE RIDGE OR HIGHEST POINT OF THE SPACE SHALL BE PERMITTED.

OVERHANGS & DRAINAGE

PROVIDE GUTTERS & DOWNSPOUTS FOR DRAINAGE OF ROOF WATER. DOWNSPOUTS ARE TO BE CONNECTED TO STORM WATER COLLECTION SYSTEM. SEE CIVIL ENGINEER DWGs FOR CONNECTION DETAILS/LOCATIONS. DOWNSPOUT LOCATIONS ARE TO BE DETERMINED BY THE

UNLESS NOTED OTHERWISE OVERHANG DIMENSIONS ARE 12" FROM SHEATHING. RAKE DIMENSIONS ARE 4" AT BRICK AND 6" AT SIDING.

ROOF VENTING CALCULATIONS:

PROPOSED VENT AREA PER UNIT VENT AREA RATIO 1:150 ATTIC AREA = 966 SQ.FT. (1/300) VENT AREA = 3.22 SQ.FT. x 144 = 464 SQ.IN. 55% SOFFIT = 255 SQ.IN. EACH 45% RIDGE = <u>209</u> SQ.IN. EACH

VENT AREA PROVIDED ® RIDGE

CONT. RIDGE TYPE 9 18 SQ.IN. PER FT. = 12 LIN.FT. TOTAL VENTING AT RIDGE = 216 SQ.IN.

VENT AREA PROVIDED & SOFFIT 16"x 8" SOFFIT VENT 9 <u>50</u> SQ.IN. PER UNIT = <u>6</u> UNITS TOTAL VENTING AT SOFFIT = 300 SQ.IN.

PROPOSED VENT AREA PER UNIT ® LOWER GARAGE

VENT AREA RATIO 1:150 ATTIC AREA = 143 SQ.FT. (1/150)


VENT AREA = <u>0.95</u> SQ.FT. x 144 = <u>137</u> SQ.IN. 50% SOFFIT AND 50% RIDGE = _68.5 SQ.IN. EACH

VENT AREA PROVIDED * RIDGE OMNI-WALL VENT ® 9 SQ.IN. PER FT. = 8 LIN.FT.

VENT AREA PROVIDED * SOFFIT

TOTAL VENTING AT RIDGE = 12 SQ.IN.

CONTINUOUS SOFFIT TYPE 0 9 SQ.IN. PER FT. = 8 LIN.FT. TOTAL VENTING AT SOFFIT = 12 SQ.IN.

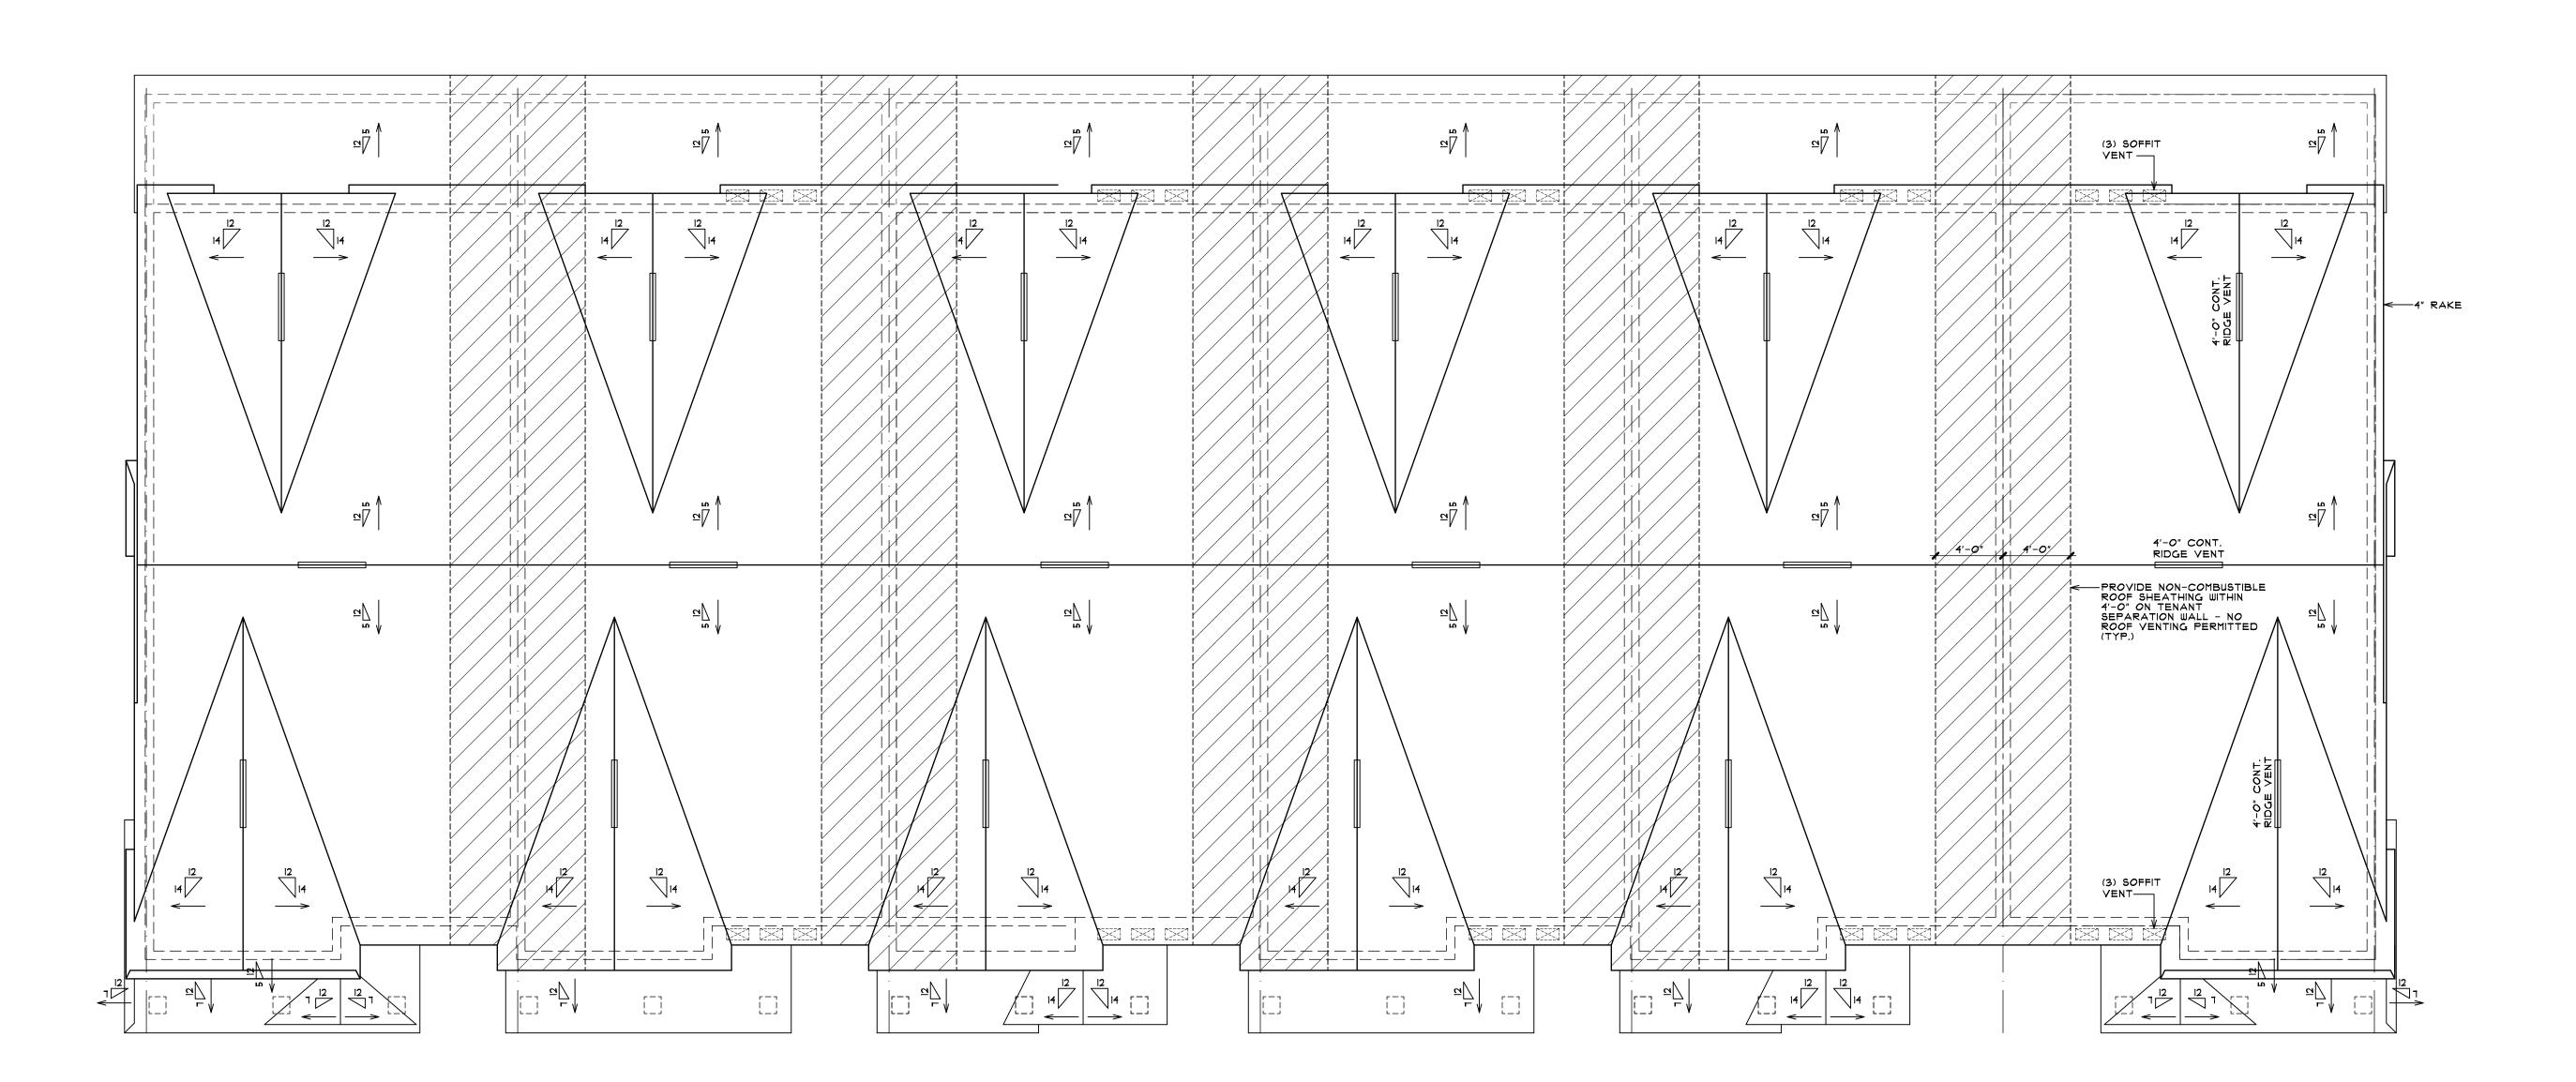

ROOF - BUILDING TYPE 'A'


6 - UNIT SCALE: 3/16" = 1'-0"





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BRIANNEEPER.COM
248, 259, 1784

O.A. BUILDING ELEVATIO BUILDING TYPE 'A' 5-UN

JOHN R TOWNHOME DEV.
BUILDING TYPE 'A'
TROY MICHIGAN

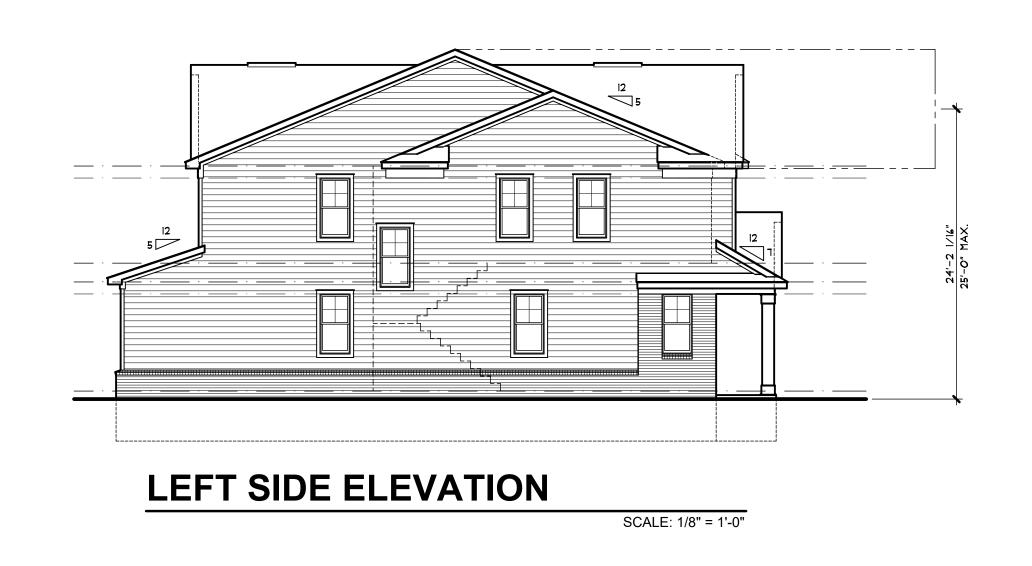PRELIMINARY
03-27-24

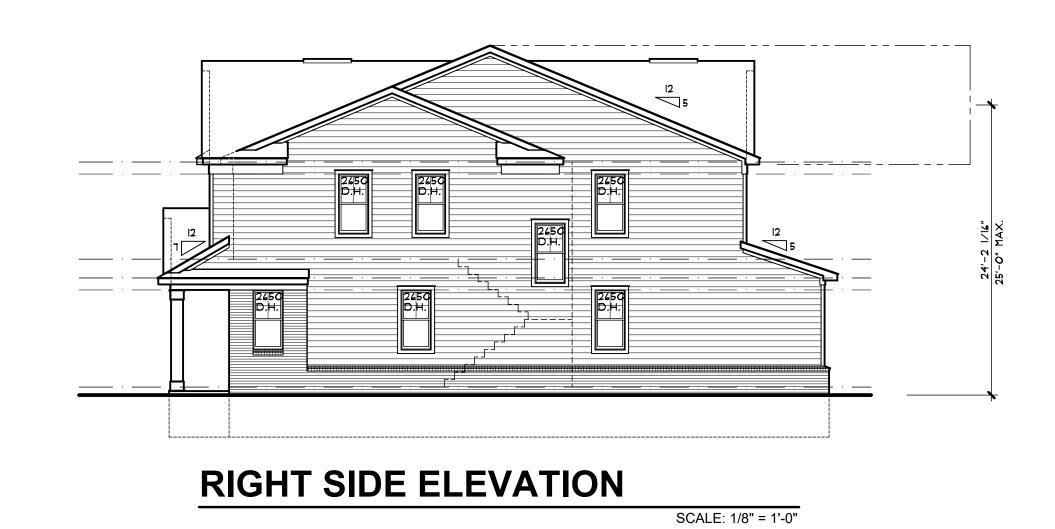BIDS

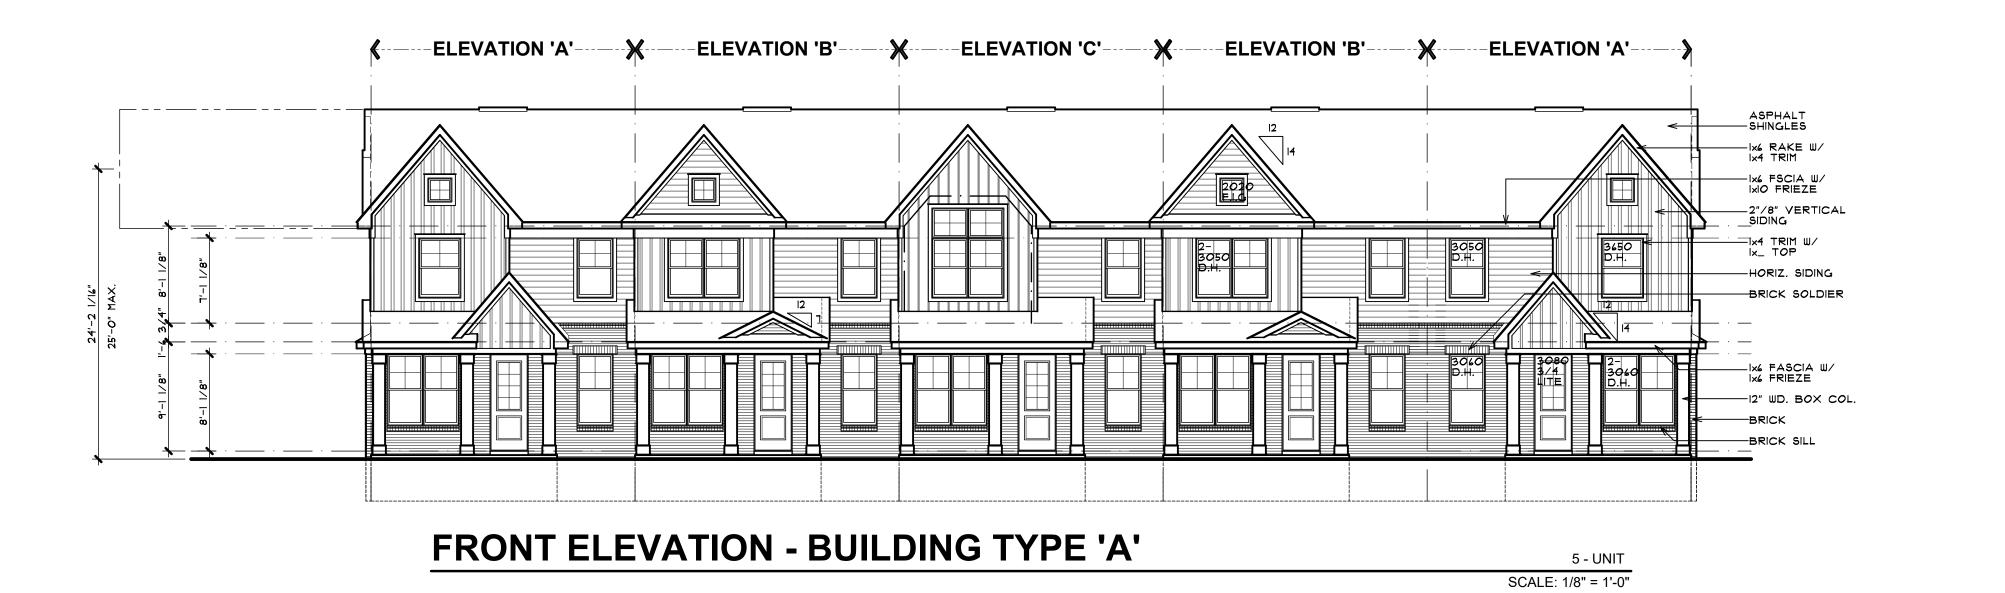PERMITS

FINAL

REVISIONS
07-10-24


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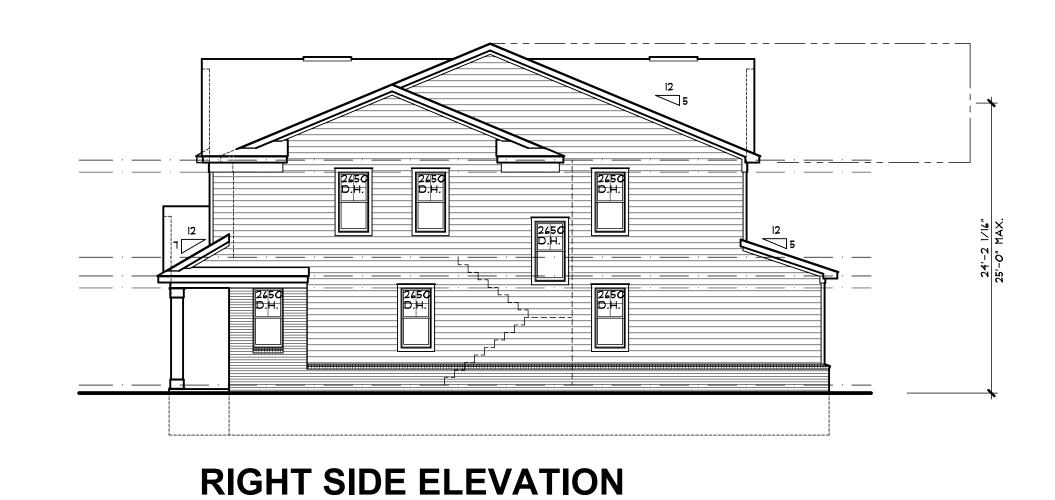
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SCALE: 1/8" = 1'-0"



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BIRMINGHAM, MICHIGAN
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O.A. BUILDING ELEYATIO BUILDING TYPE 'A' 6-UN

JOHN R TOWNHOME DEV BUILDING TYPE 'A'

PRELIMINARY
03-27-24
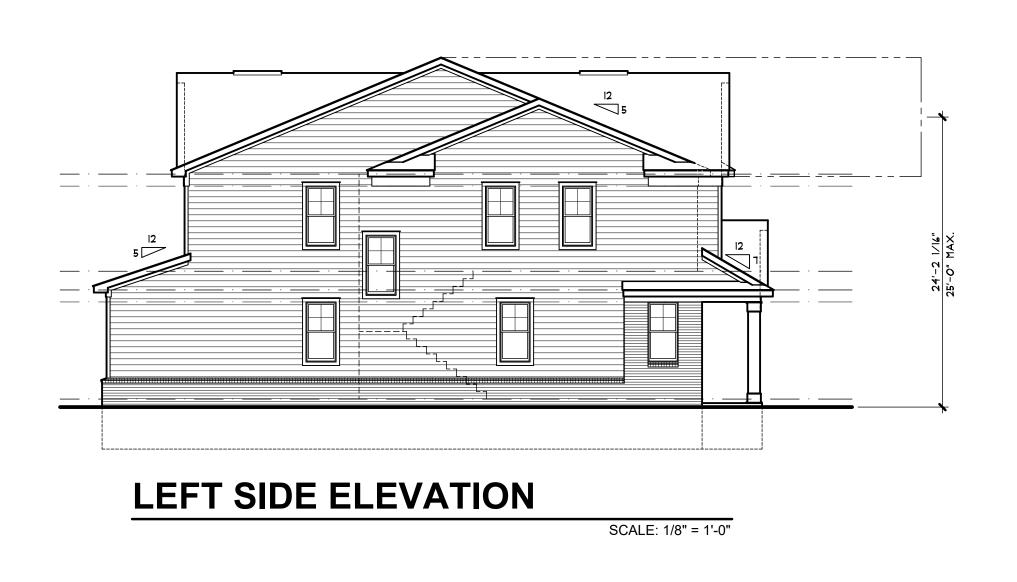
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07-10-24

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STRUCTURAL NOTES:

(2) 2x8 HEADERS TO BEAR ON (I) ONE JACK STUD UNLESS NOTED OTHERWISE.

(2) 2x10 & LARGER HEADERS TO BEAR ON (2) TWO JACK STUDS UNLESS NOTED OTHERWISE.

ALL PRE-ENGINEERED HEADERS FRAMED PERPENDICULAR TO WALL LINE SHALL BEAR ON REQUIRED NUMBER OF STUDS TO MATCH WIDTH OF HEADER MATERIAL.

OF HEADER MATERIAL.

ALL PRE-ENGINEERED HEADERS FRAMED PARALLEL TO WALL LINE SHALL BEAR ON A MINIMUM (2) TWO JACK STUDS UNLESS NOTED OTHERWISE.

ALL PRE-ENGINEERED LUMBER HEADERS SHALL BE BUILT-UP FROM THE NUMBER OF HEADERS INDICATED ON DRAWINGS. ALL MEMBERS SHALL BE SECURED WITH NAILS OR BOLTS AS SPECIFIED BY THE MANUFACTURER FOR SIZES INDICATED.

ALL GIRDER TRUSSES TO BEAR ON (2) TWO STUDS MINIMUM OR AS REQUIRED TO MATCH NUMBER OF TRUSS PLYS, WHICH EVER IS GREATER.

TRUSS FABRICATOR/CONTRACTOR TO PROVIDE ALL HANGERS W/MODEL No. CLEARLY STAMPED & LAYOUT DRAWINGS CLEARLY INDICATING LOCATION OF VARIOUS HANGERS REQUIRED.

CARPENTER CONTRACTOR TO INSTALL NAIL SIZES & NUMBER REQ'D. AS SPECIFIED FOR EACH TYPE OF HANGER.

LVL DESIGN VALUES FOR MODULUS OF ELASTICITY (E) SHALL BE 2,000,000 PSI (2.0 E)

WALL DIMENSION NOTE:

ALL WALL DIMENSIONS ARE TO THE ROUGH. INTERIOR PARTITIONS ARE 3 1/2" (2x4) UNLESS NOTED OR DIMENSIONED OTHERWISE. EXTERIOR FRAME WALLS INCLUDE 1/2" NOMINAL DIMENSION FOR EXTERIOR SHEATHING. EXTERIOR FRAME WALLS ARE 6" (2x6) UNLESS NOTED OR DIMENSIONED OTHERWISE. "BRICK LEDGE" BRICK OR STONE EXTERIOR WITH AIR SPACE IS 4 1/2" UNLESS NOTED OR DIMENSIONED OTHERWISE.

TRUSS NOTES:

FLOOR TRUSS MANUFACTURER TO DESIGN FOR ADDITIONAL DEAD LOAD OF NON-BEARING DOUBLE STUD WALL(S) AND STAGGER STUD WALL(S) CONSTRUCTION.

PROVIDE VERTICAL BLOCKING ® TRUSS WEB AREA IF THERE IS SOLID BLOCKING ON THE FLOOR ABOVE.

ALL STRUCTURAL MEMBERS WHICH ARE REQUIRED TO HAVE A FIRERESISTANCE RATING AND WHICH SUPPORT MORE THAN TWO FLOORS OR ONE FLOOR AND ROOF, OR SUPPORT A LOADBEARING WALL OR A NONLOADBEARING WALL MORE THAN TWO STORIES IN HEIGHT, SHALL BE INDIVIDUALLY PROTECTED ON ALL SIDES FOR THE FULL LENGTH OR HEIGHT WITH MATERIALS HAVING THE REQUIRED FIRERESISTANCE RATING.

ELECTRICAL NOTES:

ALL RECESSED LIGHT ARE TO BE IC (INSULATION CONTACT) RATED.

ALL RECESSED FIXTURES ARE TO BE SEALED TO LIMIT AIR
LEAKAGE BETWEEN CONDITIONED AND UNCONDITIONED SPACES

PROVIDE GROUND-FAULT CIRCUIT-INTERRUPTER PROTECTION FOR
ALL 125-VOLT, SINGLE-PHASE, 15- AND 20-AMPERE RECEPTACLES
INSTALLED IN GARAGES AND UNFINISHED BASEMENTS AREAS
EXCEPT THOSE FOR FIRE OR BURGLAR ALARM SYSTEMS.

A MINIMUM OF 15% OF ALL PERMANENTLY INSTALLED LIGHTING FIXTURES MUST USE CFL BULBS OR OTHER HIGH EFFICIENCY LAMPS ALL INTERIOR TREADS AND LANDINGS MUST BE ILLUMINATED WITH NOT LESS THAN I FOOT CANDLE.


EXTERIOR STAIRWAYS SHALL BE PROVIDED WITH AN ARTIFICIAL LIGHT SOURCE LOCATED AT THE TOP OF THE LANDING.


MICHIGAN UNIFORM ENERGY CODE BUILDERS OPTIONS FOR COMPLIANCE: CLIMATE ZONE 5A

PROVIDE INSULATION AND PERFORMANCE VALUES AS PRESCRIBED IN SECTION 302 (PRESCRIPTIVE) 2009 M.U.E.C.

EXTERIOR ENCLOS	URE VALUE	
WALL ASSEMBLIES	R-20	
ROOF / CEILING	R-38	
SLAB ON GRADE	R-IO	
CRAWL SPACE WALL (CONT	INUOUS) R-IO	
CRAWL SPACE WALL (CAVI	TY) R-13	
BASEMENT WALL (CONTINUO	DUS) R-IO	
BASEMENT WALL (CAVITY)	R-13	
FENESTRATION / OPENINGS	6 U- <i>O.</i> 35	
(AREA WEIGHTED AVERAGE	E OF THE R-2.85	
TOTAL AREA OF FENESTR	ATION UNITS)	
* SEE TABLE 402.I.I FOR F	OOTNOTES	

B) PROVIDE A SIMULATED ENERGY PERFORMANCE ANALYSIS
(BY OTHERS) AS PRESCRIBED IN SECTION 405 (PERFORMANCE)
PROVIDE INSULATION AND FENESTRATION VALUES AS REQUIRED.

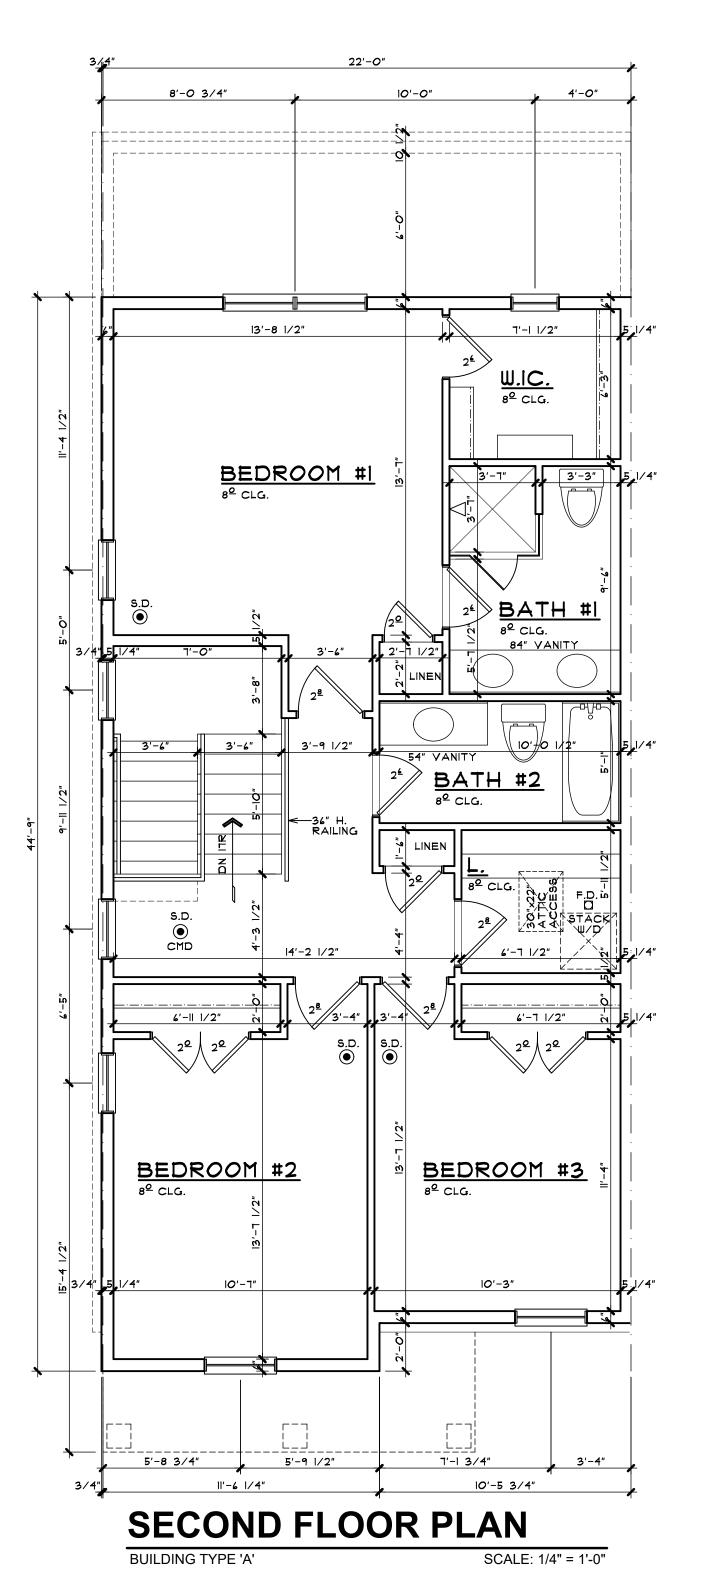

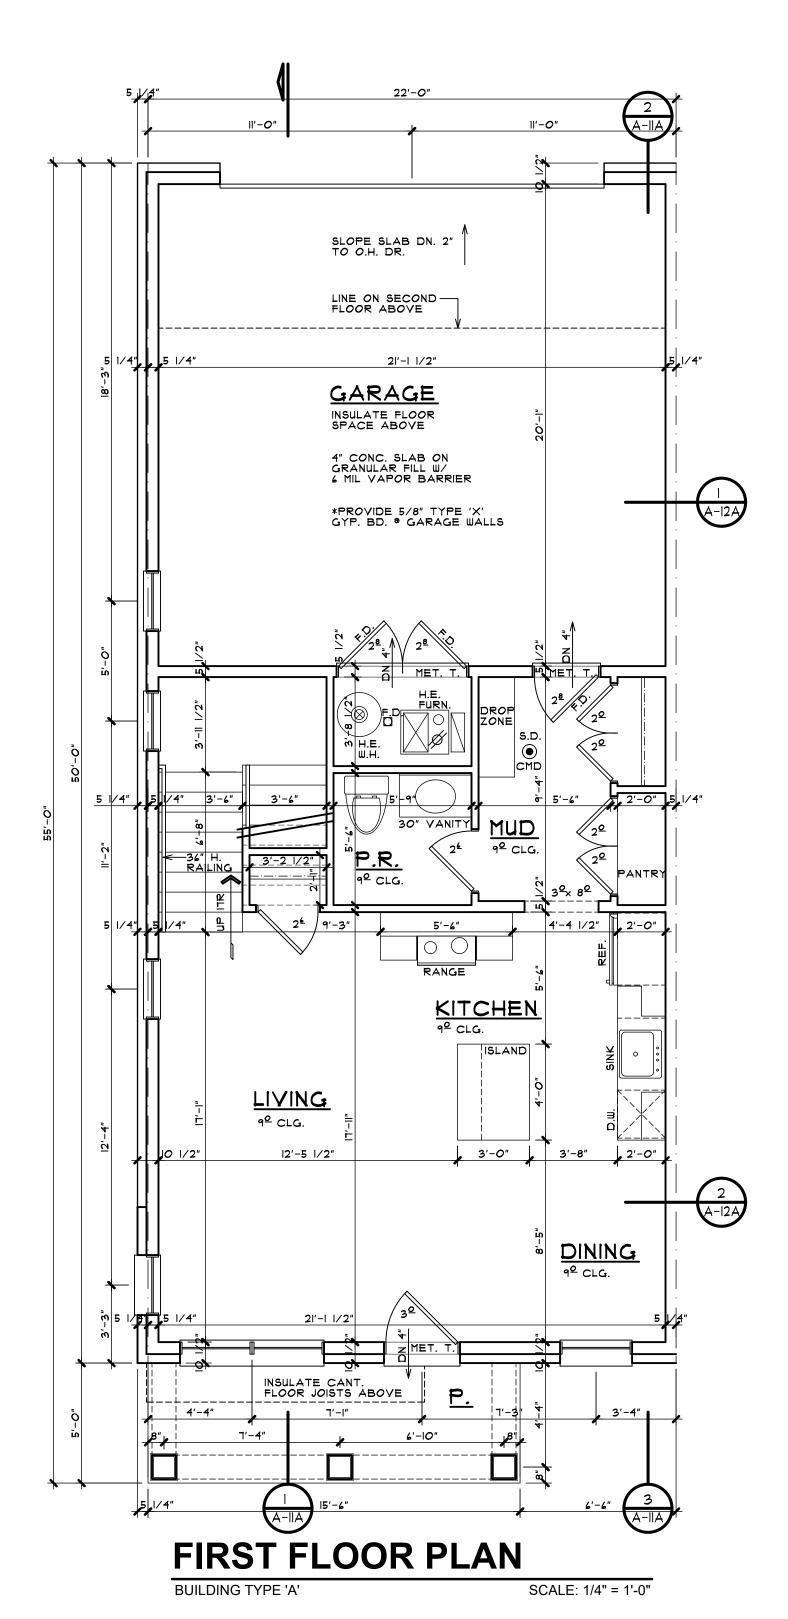

SQUARE FOOTAGE

581 SQ FT


964 SQ FT

1,545 SQ FT

IST FLOOR

2ND FLOOR

TOTAL

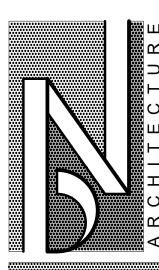

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DWELLING UNIT PLANS

JOHN R TOWNHOME DEV
BUILDING TYPE 'A'
TROY, MICHIGAN

PRELIMINARY
03-27-24

BIDS

PERMITS

FINAL

REVISIONS
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A-9A

IN DUELLING UNITS, WHERE THE OPENING OF AN OPERABLE WINDOW IS LOCATED MORE THAN 12" ABOVE FINISHED GRADE OR SURFACE BELOW, THE LOWEST PART OF THE CLEAR OPENING OF THE WINDOW SHALL BE A MINIMUM OF 24 INCHES ABOVE THE FINISHED FLOOR OF THE ROOM IN WHICH THE WINDOW IS LOCATED. GLAZING BETWEEN THE FLOOR AND 24" SHALL BE FIXED OR HAVE OPENINGS THROUGH WHICH A 4 INCH DIAMETER SPHERE CANNOT PASS. EXCEPTIONS: 1. WINDOWS WHOSE OPENINGS WILL NOT ALLOW A 4" DIA. SPHERE TO PASS THROUGH THE OPENING WHERE THE OPENING IS IN ITS LARGEST OPENED POSITION. 2. OPENINGS THAT ARE PROVIDED WITH WINDOW GUARDS THAT COMPLY WITH ASTM F 2006 OR F 2090.

OVERHANGS & DRAINAGE

PROVIDE GUTTERS & DOWNSPOUTS FOR DRAINAGE OF
ROOF WATER. DOWNSPOUTS ARE TO BE CONNECTED TO
STORM WATER COLLECTION SYSTEM. SEE CIVIL ENGINEER
DWG. FOR CONNECTION DETAILS/LOCATIONS. DOWNSPOUT
LOCATIONS ARE TO BE DETERMINED BY THE BUILDER.


UNLESS NOTED OTHERWISE OVERHANG DIMENSIONS ARE
12" FROM SHEATHING. RAKE DIMENSIONS ARE 4" AT BRICK
AND 6" AT SIDING.


STEEL LINTEL SCHEDULE LOOSE STEEL LINTELS FOR MASONRY - EXTERIOR ANGLES FOR BRICK OR STONE (NO FLOOR LOAD) MAX. CLEAR SPAN 5'-O" OR LESS 3 1/2" x 3 1/2" x 5/16" 7'-O" OR LESS 4" x 3 1/2" x 5/16" 8'-O" OR LESS 5" x 3 1/2" x 5/16" 9'-O" OR LESS 5" x 3 1/2" x 3/8" 10'-O" OR LESS 6" x 3 1/2" x 3/8"

NOTE: THIS SCHEDULE APPLIES UNLESS NOTED OTHERWISE ON THE PLANS AND/OR ELEVATIONS.

NOTE: STEEL ANGLE LINTELS REQUIRE A SHOP COAT OF RUST-INHIBITIVE PAINT EXCEPT FOR LINTELS MADE OF CORROSION-RESISTANT STEEL.

TYP. WINDOW DESIGNATION

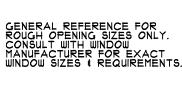

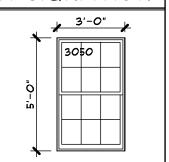


EVERY SLEEPING ROOM SHALL HAVE AT LEAST ONE OPERABLE WINDOW OR EXTERIOR DOOR APPROVED FOR EMERGENCY EGRESS OR RESCUE. THE UNIT(S) MUST BE OPERABLE FROM THE INSIDE TO A FULL CLEAR OPENING WITHOUT THE USE OF SEPARATE TOOLS. WHERE WINDOWS ARE PROVIDED AS A MEANS OF EGRESS, OR RESCUE, THEY SHALL HAVE SILL HEIGHT OF NOT MORE THAN 44 INCHES ABOVE THE FLOOR. ALL EGRESS OR RESCUE WINDOWS FROM SLEEPING ROOMS MUST HAVE A MINIMUM NET CLEAR OPENING HEIGHT DIMENSION SHALL BE 24 INCHES AND WIDTH OF 20 INCHES.

GENERAL NOTES

1. BEFORE CONSTRUCTION OBTAIN WINDOW & DOOR ROUGH OPENING SIZES FROM WINDOW/DOOR SUPPLIER
2. TRUSS DESIGNER/FABRICATOR SEE SHEET N-2 FOR ADDITIONAL NOTES & INFORMATION
3. DO NOT SCALE THESE DRAWINGS. USE CALCULATED DIMENSIONS. IF VARIATIONS OCCUR CONTACT ARCHITECT FOR CLARIFICATION.


5. SEE CIVIL ENGINEERS'S DWGs FOR ALL FINAL A/C UNIT, ELECTRICAL METER & GAS METER LOCATIONS.

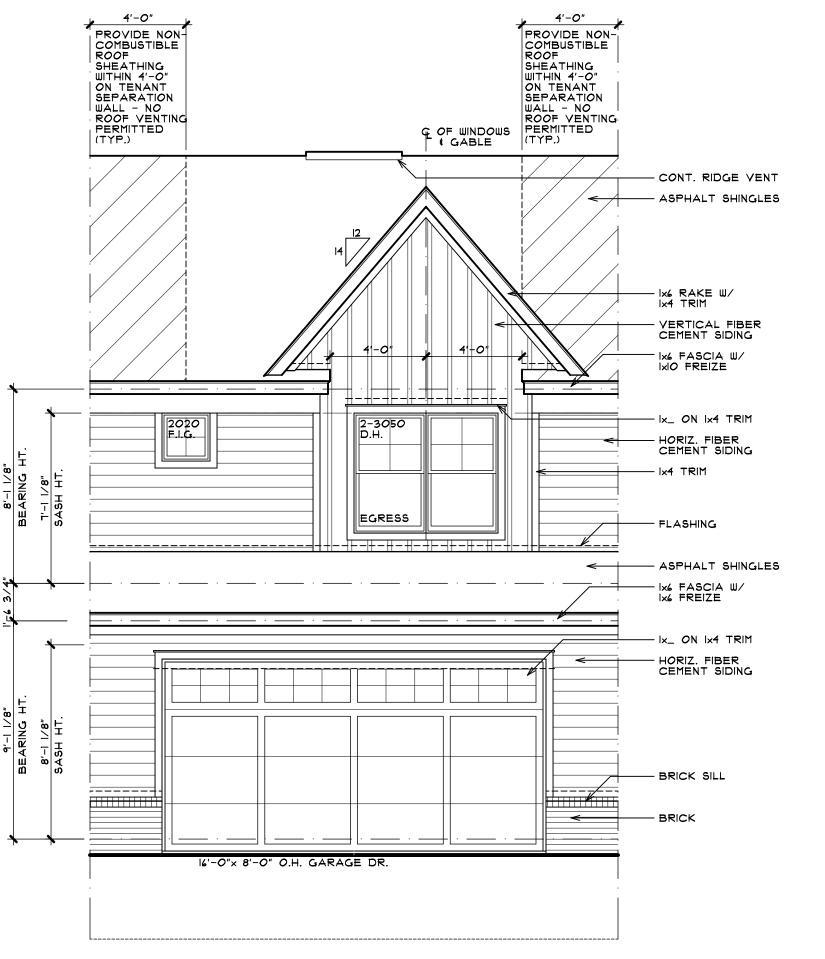

ELEVATION 'C'

REAR ELEVATION LEFT SIDE ELEVATION

SCALE: 1/4" = 1'-0"

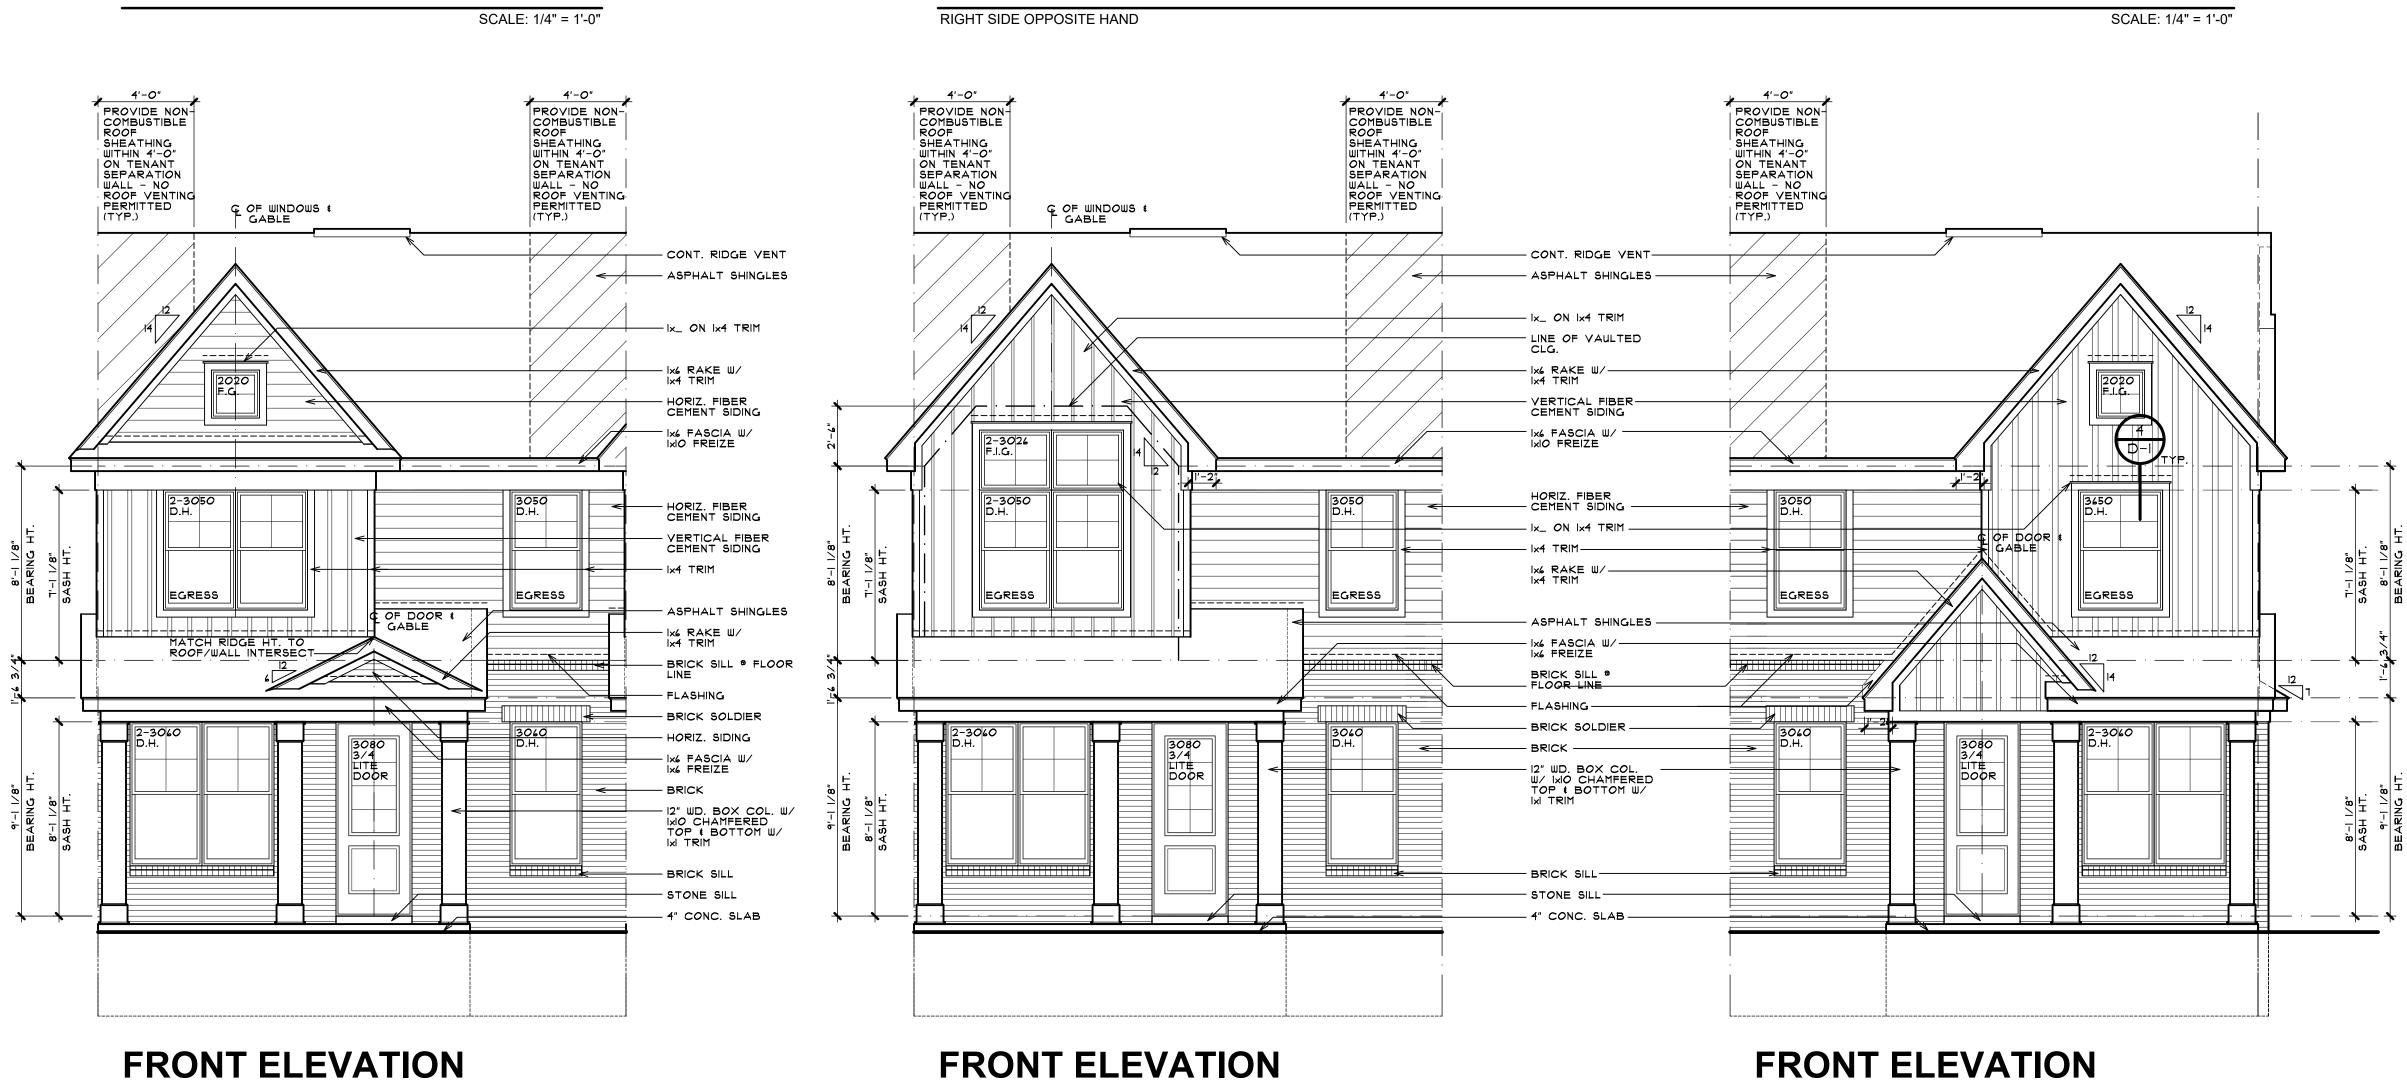


SCALE: 1/4" = 1'-0"

ELEVATION 'B'

CONT. RIDGE VENT -

ASPHALT SHINGLES-

Ix6 RAKE W/---Ix4 TRIM

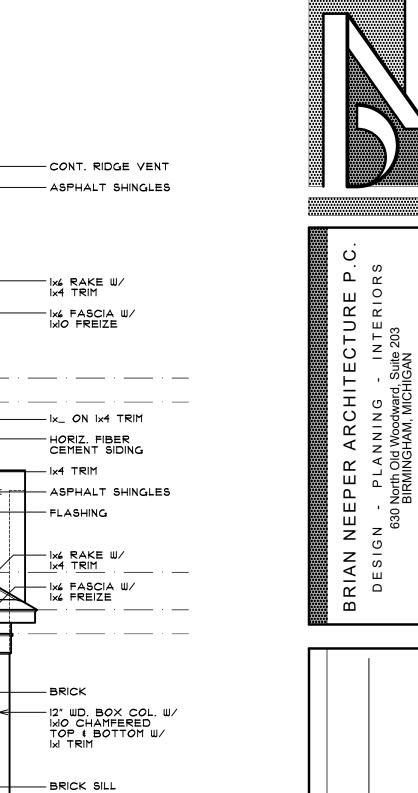

- 4" CONC. SLAB

T'-O"

6" RAKE-

-4" RAKE

, 3'-2 1/2" <u>j.</u> 3'-2 1/2"

ELEVATION 'A'


SCALE: 1/4" = 1'-0"


UNIT ELEVATIONS
BUILDING TYPE 'A'
PRELIMINARY


JOHN R TOWNHOME DEV.


BUILDING TYPE 'A'


TROY, MICHIGAN

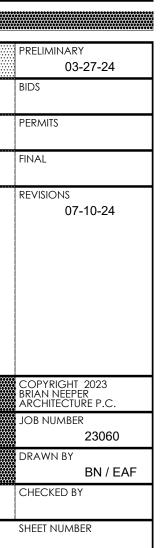

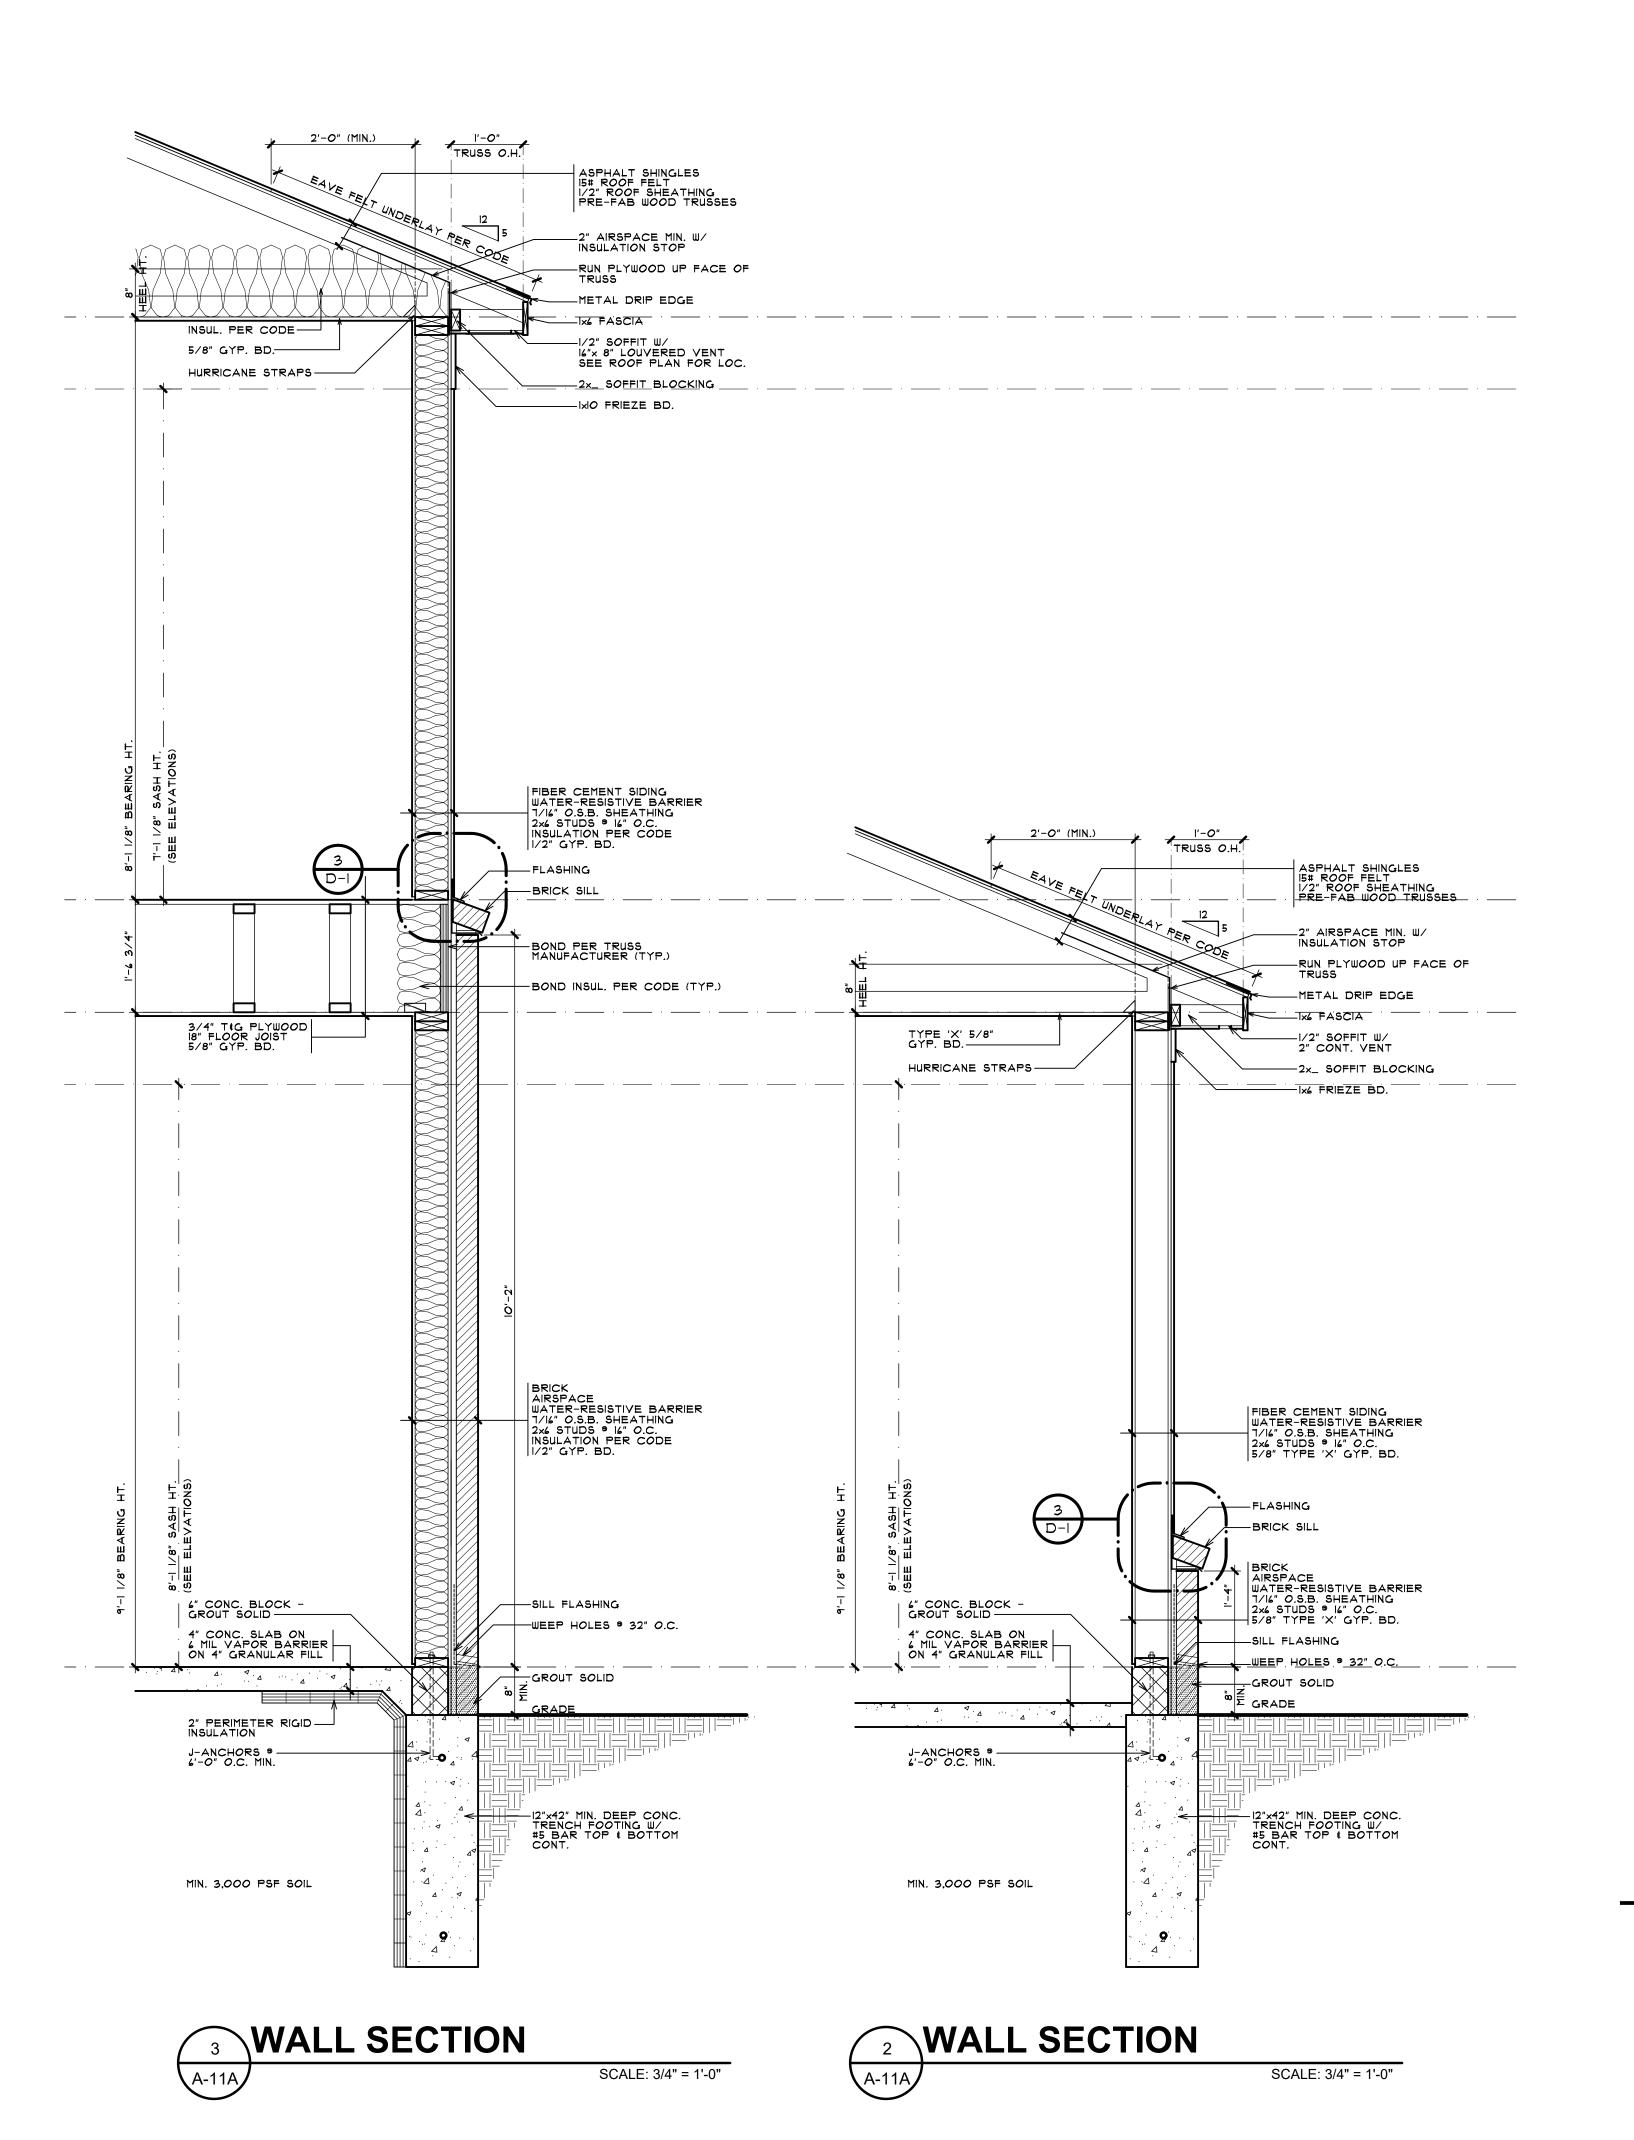

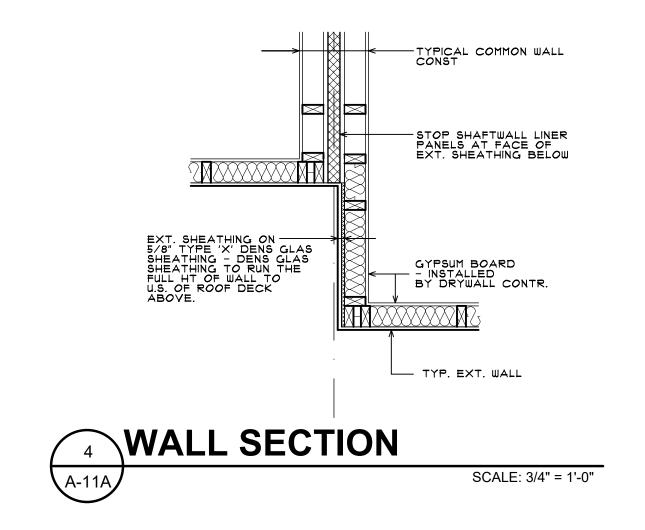

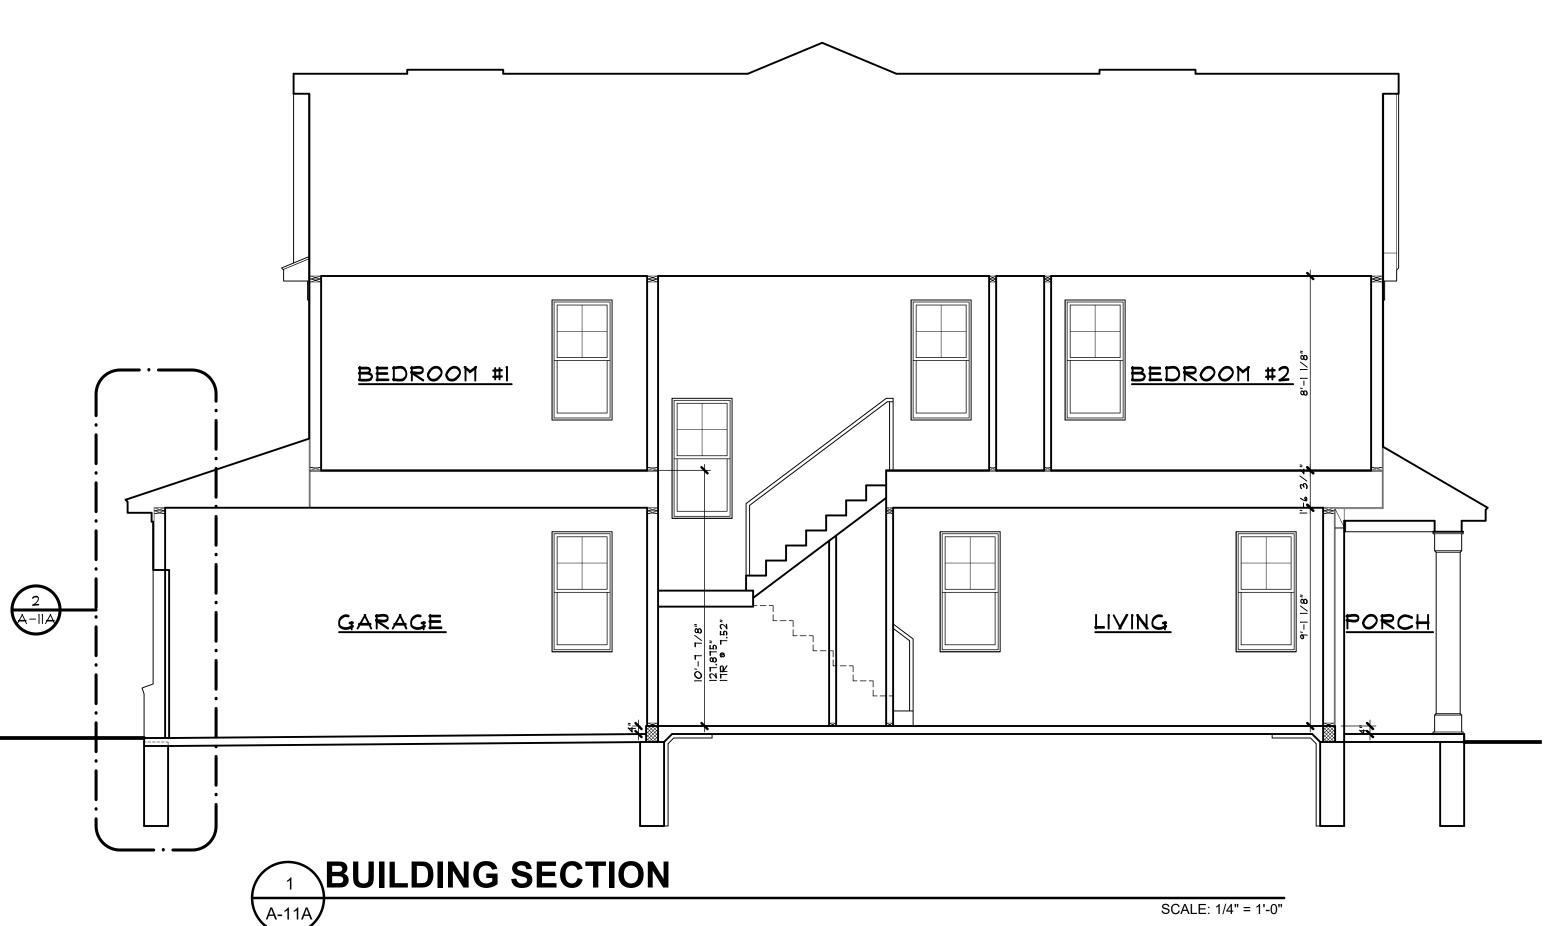

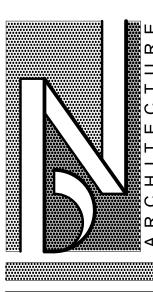

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BUILDING # WALLS SECTIONS
BUILDING TYPE 'A'

BUS BUILDING TYPE 'A'

BUILDING TYPE 'A'

TROY, MICHIGAN

PRELIMINARY
03-27-24

BIDS

PERMITS


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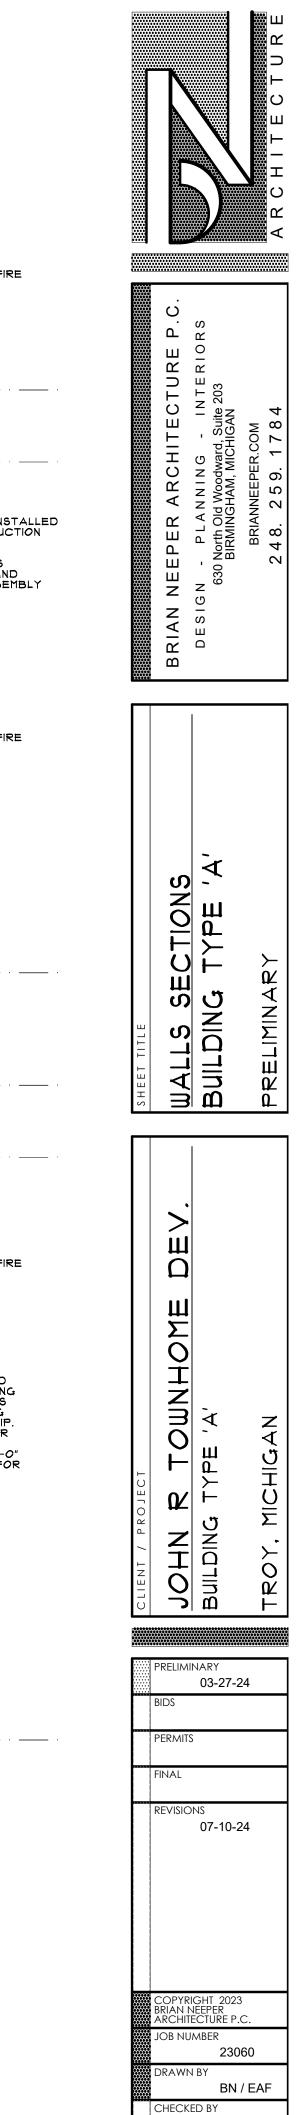
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SHEET NUMBER



FRONT ELEVATION - BUILDING TYPE 'A'

5 - UNIT

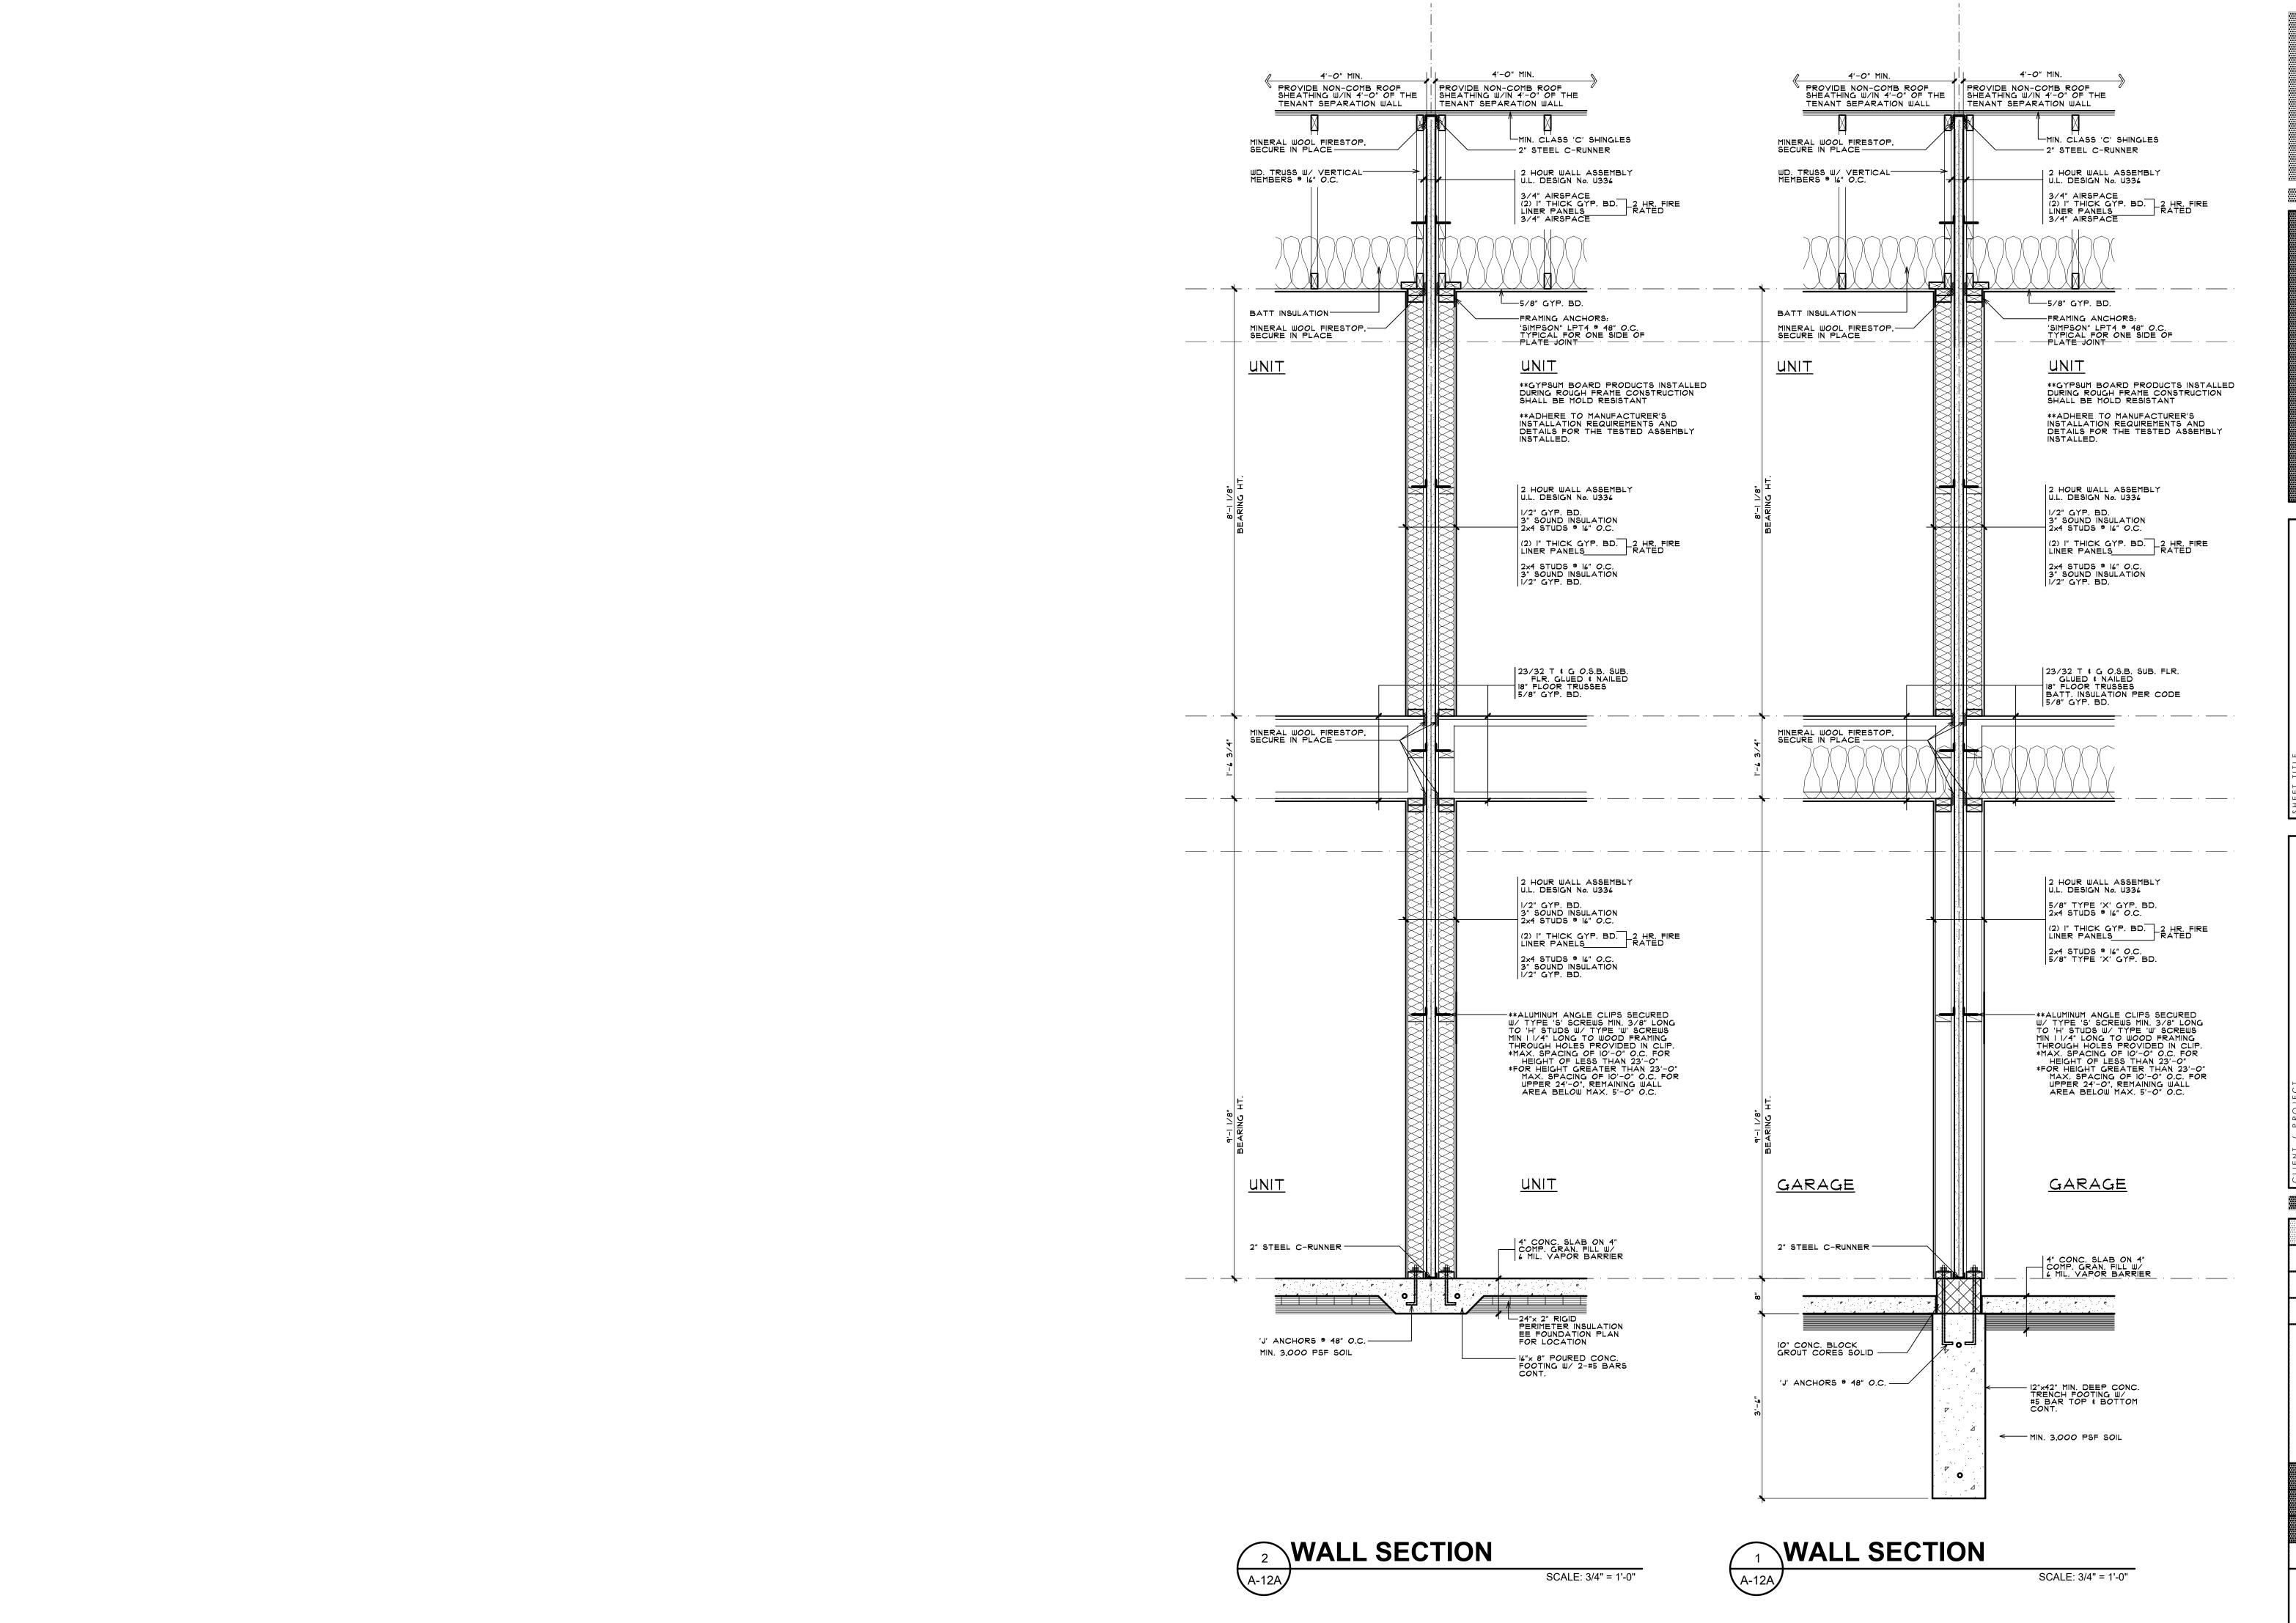

FRONT ELEVATION - BUILDING TYPE 'A'

6 - UNIT SCALE: 3/16" = 1'-0"

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RENDERED FRONT BUILDING ELEVATIONS BUILDING TYPE 'A' PRELIMINARY

OHN R TOWNHOME DE

PRELIMINARY
03-27-24
BIDS

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JOHN R. TOWNHOME DEVELOPMENT

BUILDING TYPE 'B'

TROY, MICHIGAN

CODE SUMMARY


CODE:
2015 MICHIGAN RESIDENTIAL CODE: TOWNHOUSE OPTION


TENANT SEPARATION: I HOUR REQUIRED
2 HOUR PROVIDED


FIRE SUPPRESSION: N/A

TYPE 'A' DWELLING UNITS: N/A

TYPE 'B' DWELLING UNITS: N/A (MULTI-STORY DWELLING UNITS)

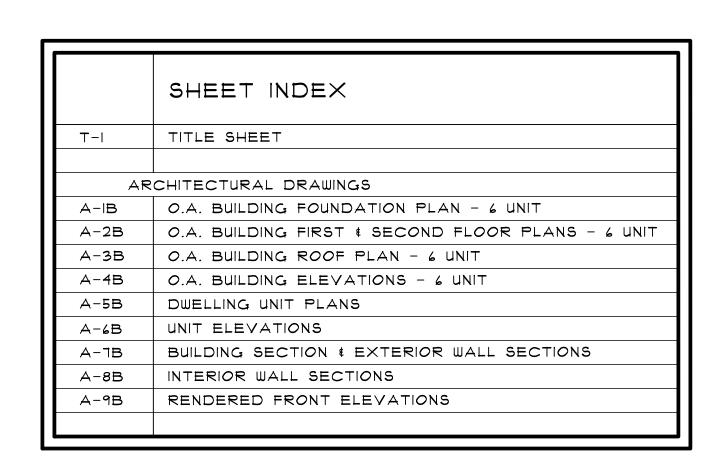

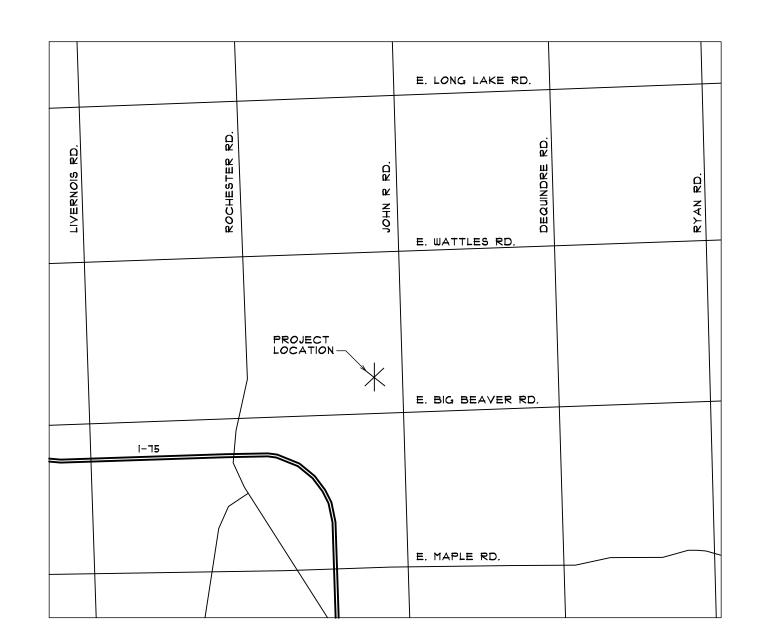

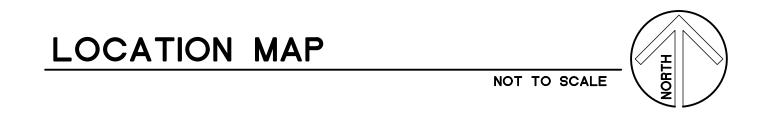


ARCHITECT:

BRIAN NEEPER ARCHITECTURE P.C. 630 N. OLD WOODWARD, SUITE 203

BIRMINGHAM, MICHIGAN 48009 248. 259. 1784

Brian•BrianNeeper.com

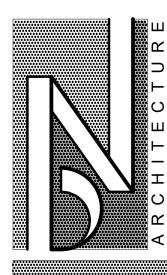

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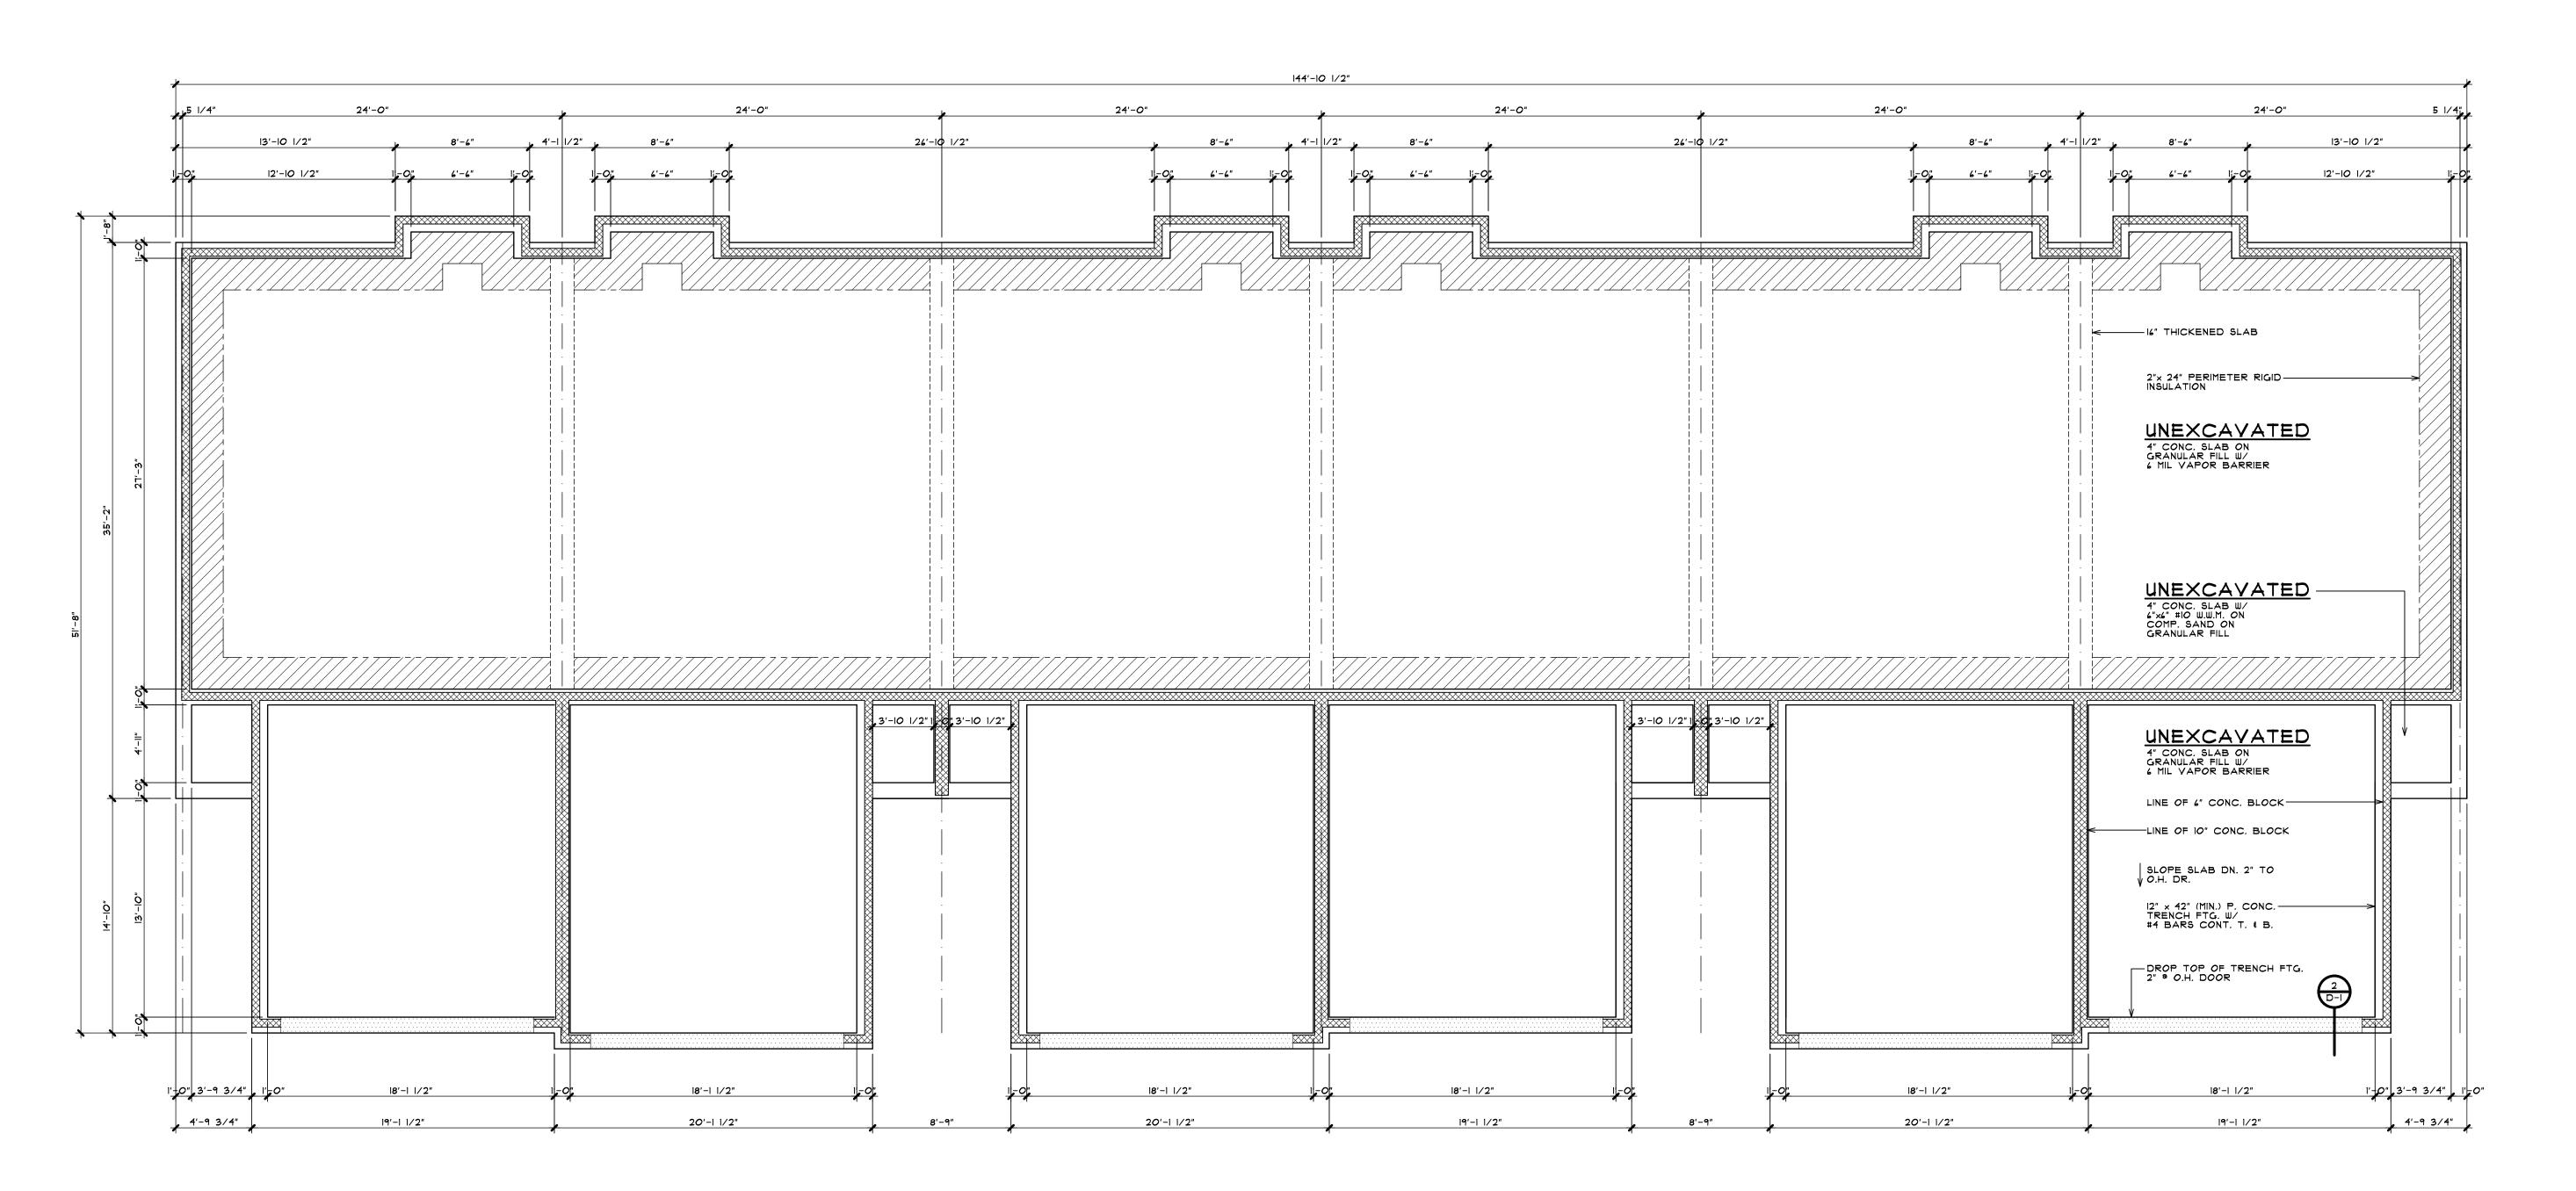
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FOUNDATION PLAN - BUILDING TYPE 'B'

6 - UNIT SCALE: 3/16" = 1'-0"

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FOUNDATION PLAN
BLDG, TYPE 'B'-6 UNI

JOHN R TOWNHOME DE BUILDING TYPE 'B'
TROY MICHIGAN

PRELIMINARY
03-27-24

BIDS

PERMITS


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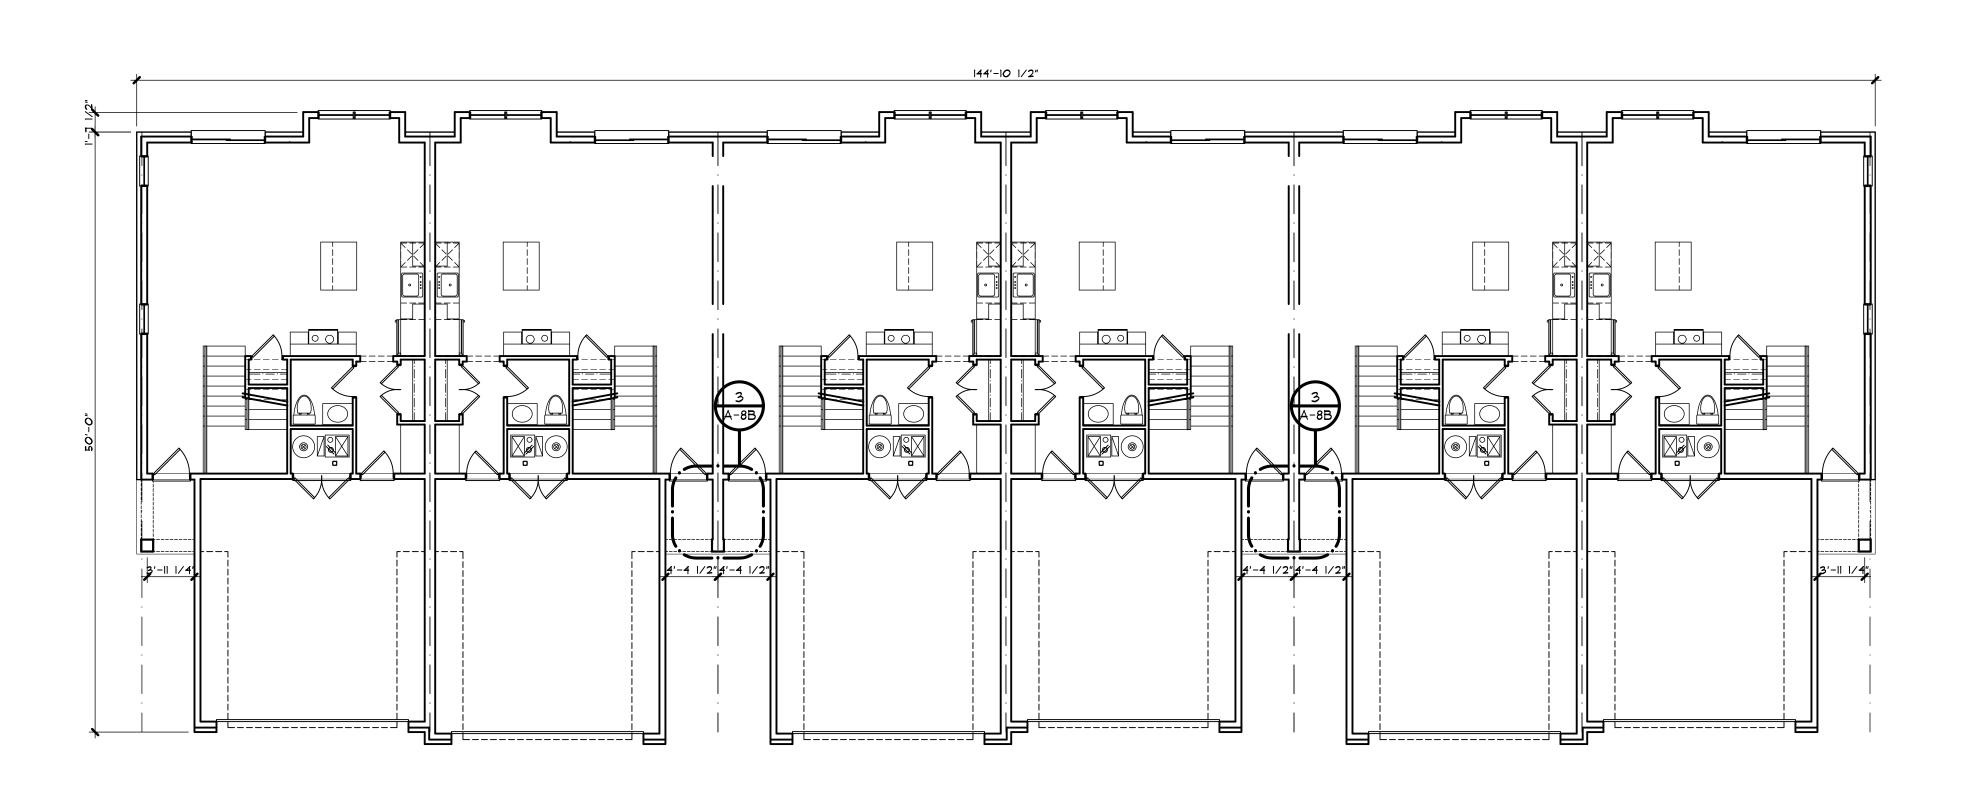
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A-1B




SECOND FLOOR PLAN - BUILDING TYPE 'B'

FIRST FLOOR PLAN - BUILDING TYPE 'B'

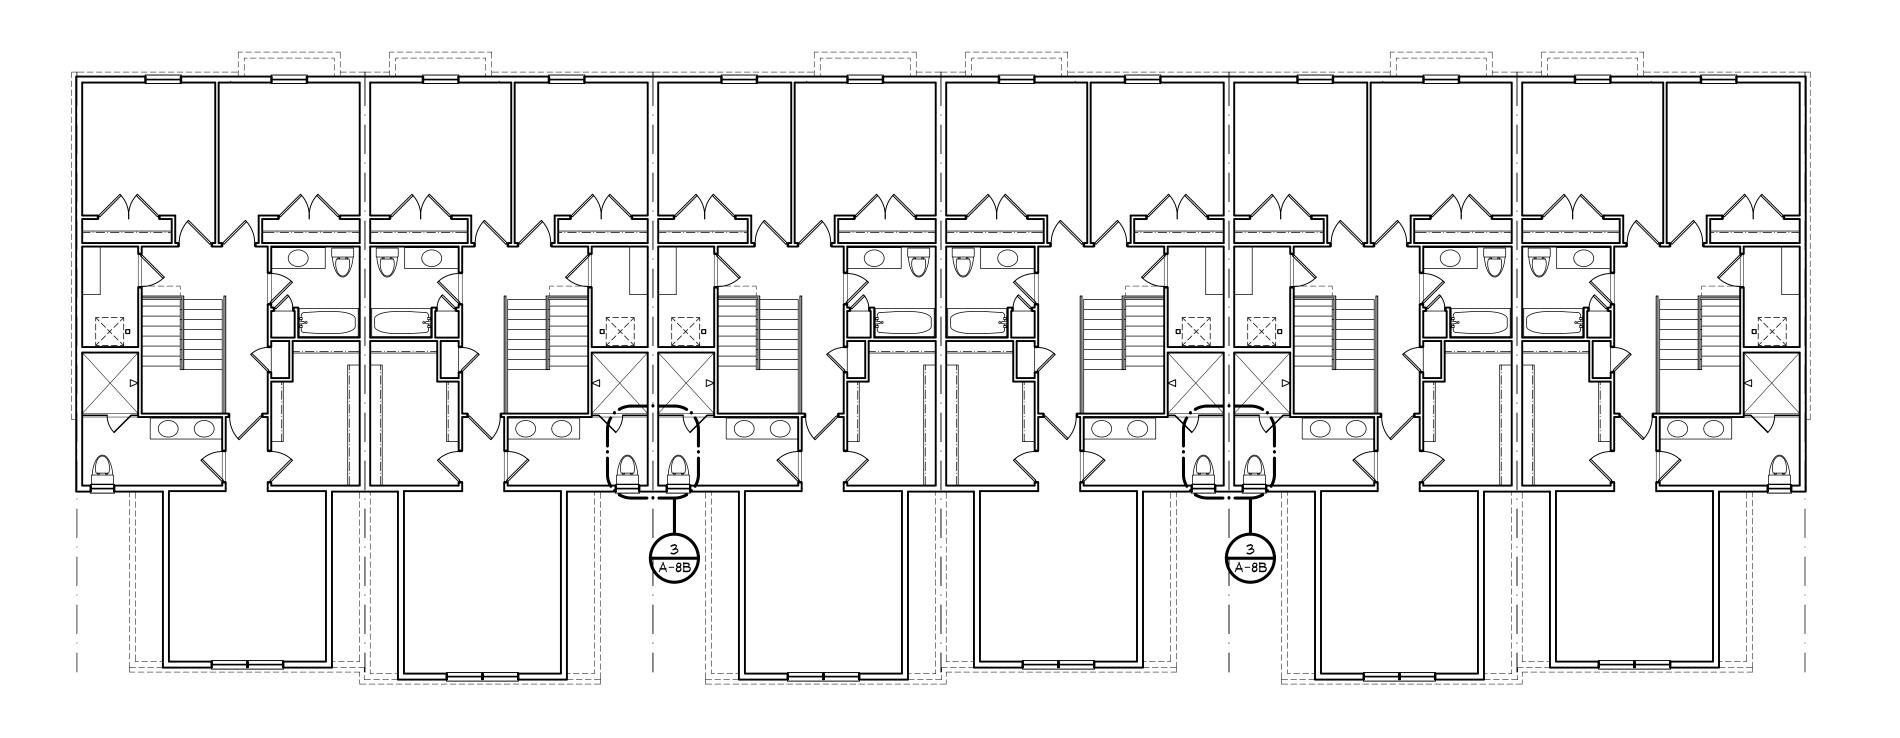

6 - UNIT SCALE: 1/8" = 1'-0"

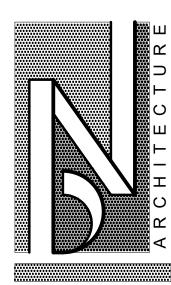

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St & 2nd FLOOR PLA

JOHN R TOWNHOME DEN BUILDING TYPE 'B'

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PERMITS
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PROPOSED VENT AREA PER UNIT VENT AREA RATIO 1:150

ATTIC AREA = <u>1,039</u> SQ.FT. (1/150) VENT AREA = <u>6.9</u> SQ.FT. x 144 = <u>994</u> SQ.IN. 50% SOFFIT AND 50% RIDGE = 497 SQ.IN. EACH

<u>VENT AREA PROVIDED ® RIDGE</u> CONT. RIDGE TYPE ® <u>18</u> SQ.IN. PER FT. = <u>36</u> LIN.FT. TOTAL VENTING AT RIDGE = <u>648</u> SQ.IN.

VENT AREA PROVIDED ® SOFFIT

16"x 8" SOFFIT VENT 0 50 SQ.IN. PER UNIT = 10 UNITS TOTAL VENTING AT SOFFIT = _500 SQ.IN.

PROPOSED VENT AREA PER UNIT @ LOWER ROOF (DINING)

VENT AREA RATIO 1:150 ATTIC AREA = 17 SQ.FT. (1/150)

VENT AREA = <u>O.II</u> SQ.FT. x 144 = <u>16</u> SQ.IN. 50% SOFFIT AND 50% RIDGE = 8 SQ.IN. EACH

VENT AREA PROVIDED ® RIDGE

OMNI-WALL VENT 9 9 SQ.IN. PER FT. = 2 LIN.FT. TOTAL VENTING AT RIDGE = 18 SQ.IN.


VENT AREA PROVIDED 9 SOFFIT

CONTINUOUS SOFFIT TYPE 9 9 SQ.IN. PER FT. = 2 LIN.FT. TOTAL VENTING AT SOFFIT = 18 SQ.IN.

OVERHANGS & DRAINAGE

PROVIDE GUTTERS & DOWNSPOUTS FOR DRAINAGE OF ROOF WATER. DOWNSPOUTS ARE TO BE CONNECTED TO STORM WATER COLLECTION SYSTEM. SEE CIVIL ENGINEER DWGS FOR CONNECTION DETAILS/LOCATIONS. DOWNSPOUT LOCATIONS ARE TO BE DETERMINED BY THE

UNLESS NOTED OTHERWISE OVERHANG DIMENSIONS ARE 12" FROM SHEATHING. RAKE DIMENSIONS ARE 4" AT BRICK AND 6" AT SIDING.

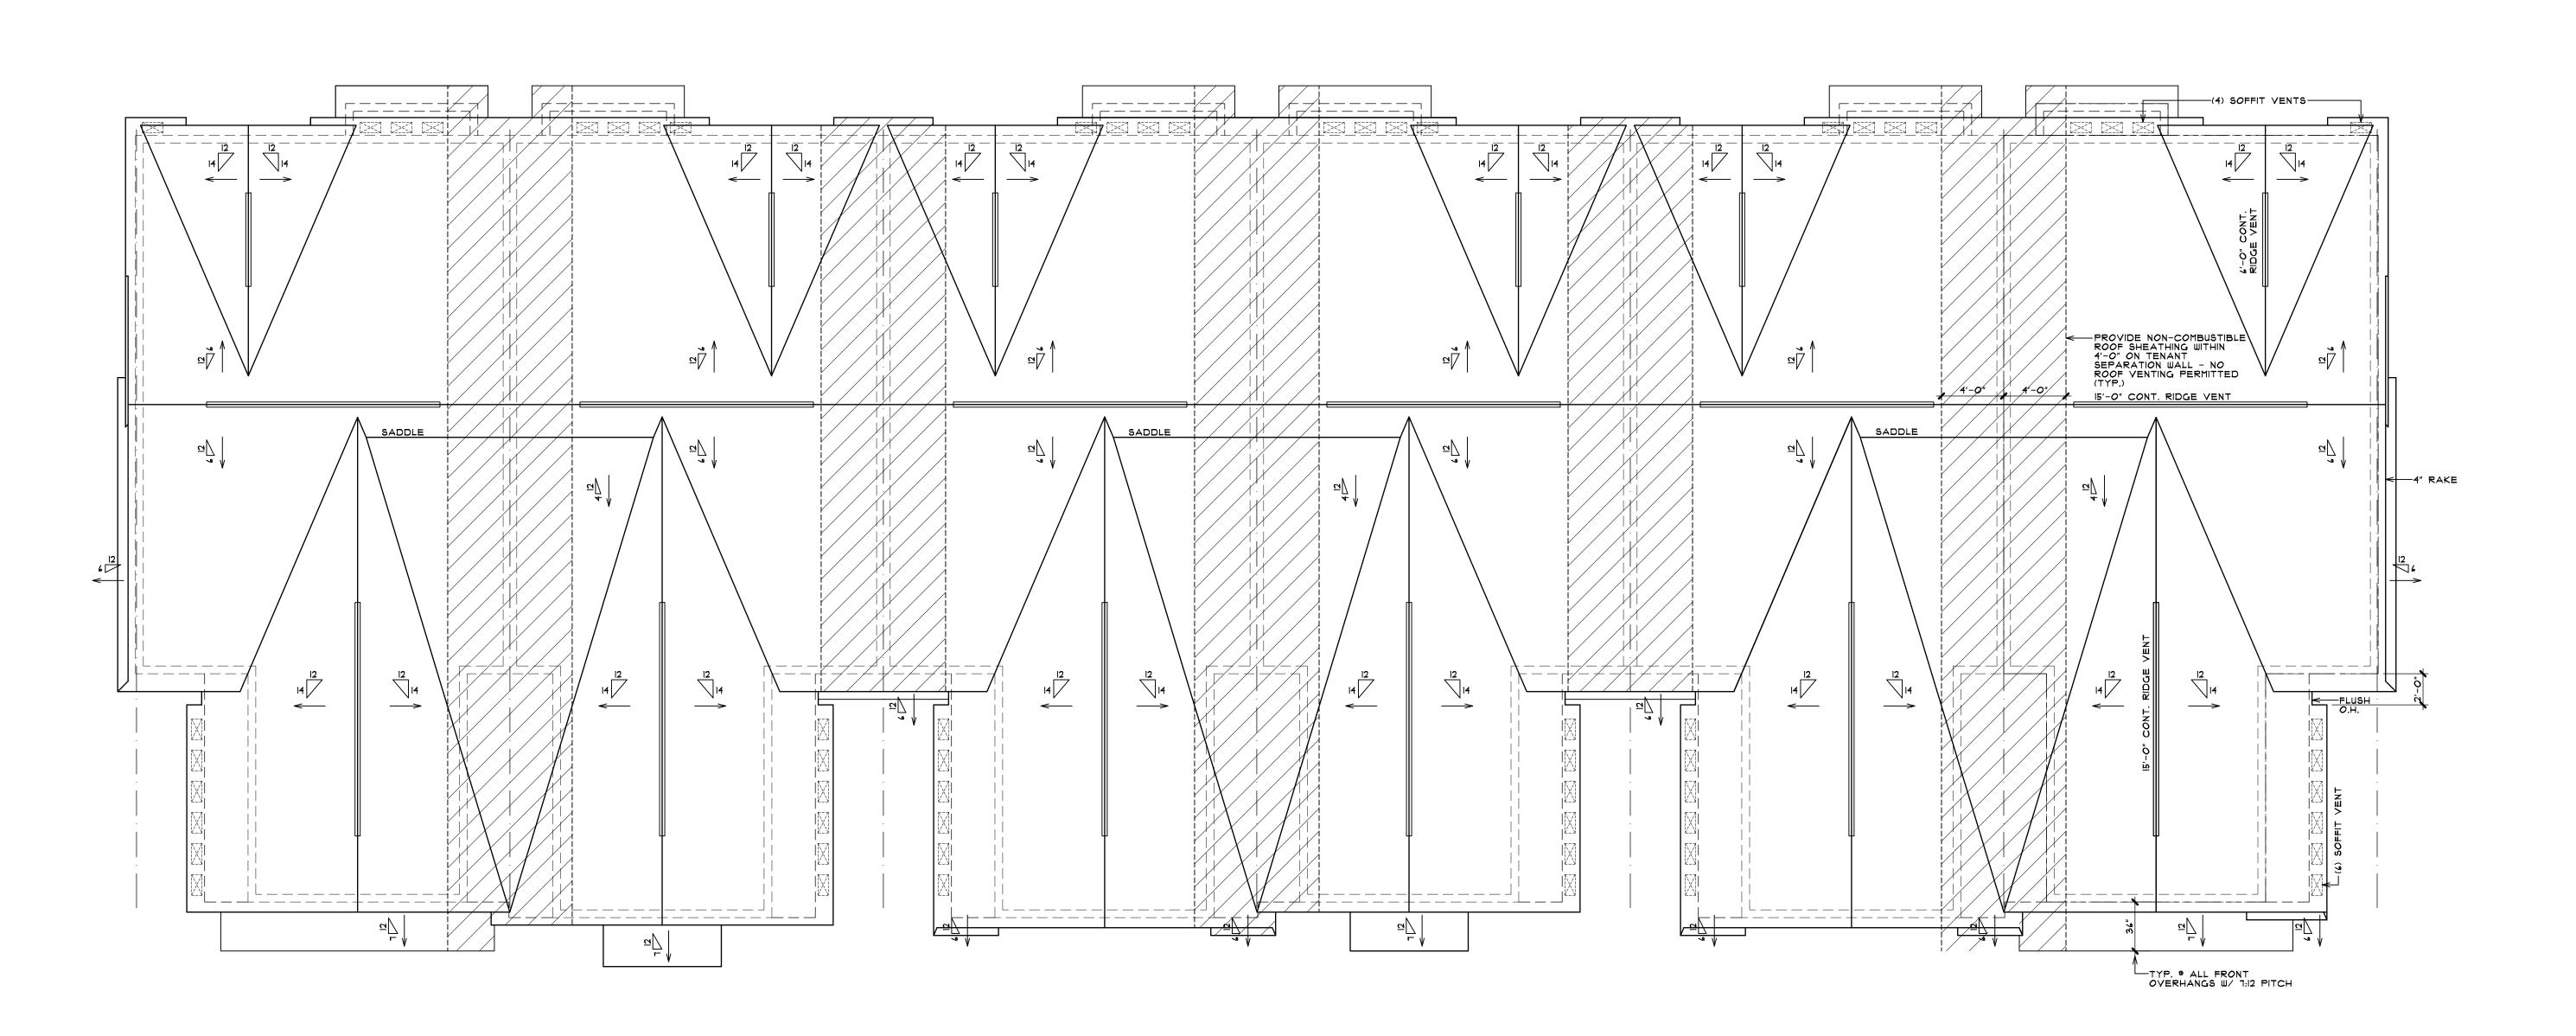

ROOF PLAN - BUILDING TYPE 'B'

6 - UNIT

SCALE: 3/16" = 1'-0"

BRIAN N

m 립 ROOF BLDG.


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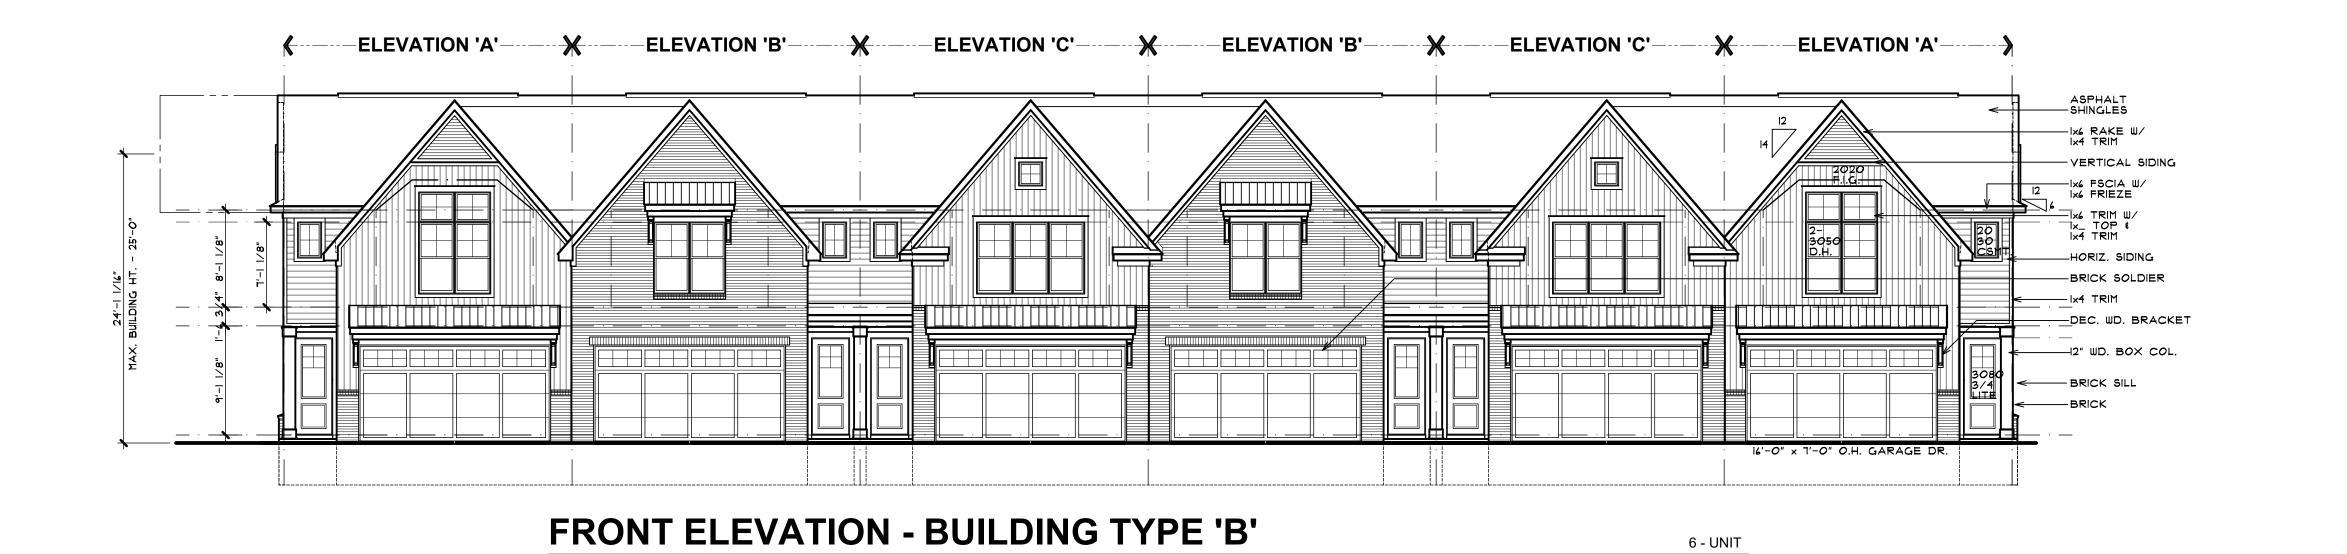
A-3B





SCALE: 1/8" = 1'-0"

SCALE: 1/8" = 1'-0"

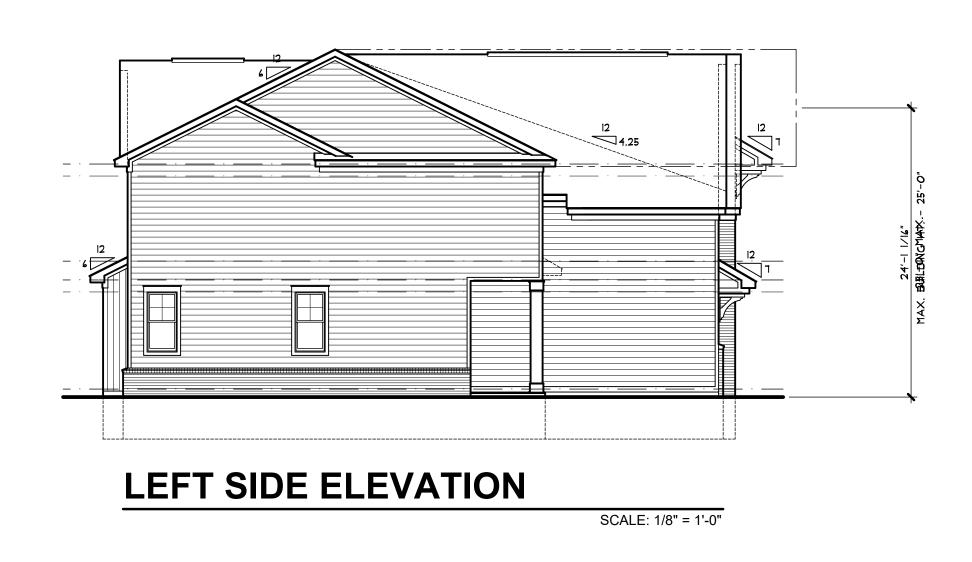

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TOWNHOME

O.A. BUILDING ELEVATIONS
BUILDING TYPE 'B' 6-UNIT
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STRUCTURAL NOTES:

(2) 2x8 HEADERS TO BEAR ON (I) ONE JACK STUD UNLESS NOTED OTHERWISE. (2) $2\times |O|$ & LARGER HEADERS TO BEAR ON (2) TWO JACK STUDS UNLESS NOTED OTHERWISE.

ALL PRE-ENGINEERED HEADERS FRAMED PERPENDICULAR TO WALL LINE SHALL BEAR ON REQUIRED NUMBER OF STUDS TO MATCH WIDTH OF HEADER MATERIAL.

ALL PRE-ENGINEERED HEADERS FRAMED PARALLEL TO WALL LINE SHALL BEAR ON A MINIMUM (2) TWO JACK STUDS UNLESS NOTED OTHERWISE.

ALL PRE-ENGINEERED LUMBER HEADERS SHALL BE BUILT-UP FROM THE NUMBER OF HEADERS INDICATED ON DRAWINGS. ALL MEMBERS SHALL BE SECURED WITH NAILS OR BOLTS AS SPECIFIED BY THE MANUFACTURER FOR SIZES INDICATED.

ALL GIRDER TRUSSES TO BEAR ON (2) TWO STUDS MINIMUM OR AS REQUIRED TO MATCH NUMBER OF TRUSS PLYS, WHICH EVER IS GREATER.

TRUSS FABRICATOR/CONTRACTOR TO PROVIDE ALL HANGERS W/MODEL No. CLEARLY STAMPED & LAYOUT DRAWINGS CLEARLY INDICATING LOCATION OF VARIOUS HANGERS REQUIRED.

CARPENTER CONTRACTOR TO INSTALL NAIL SIZES & NUMBER REQ'D. AS SPECIFIED FOR EACH TYPE OF HANGER.

LVL DESIGN VALUES FOR MODULUS OF ELASTICITY (E) SHALL BE 2,000,000 PSI (2.0 E)

WALL DIMENSION NOTE:

ALL WALL DIMENSIONS ARE TO THE ROUGH. INTERIOR PARTITIONS ARE 3 1/2" (2x4) UNLESS NOTED OR DIMENSIONED OTHERWISE. EXTERIOR FRAME WALLS INCLUDE 1/2" NOMINAL DIMENSION FOR EXTERIOR SHEATHING. EXTERIOR FRAME WALLS ARE 6" (2x6) UNLESS NOTED OR DIMENSIONED OTHERWISE. "BRICK LEDGE" BRICK OR STONE EXTERIOR WITH AIR SPACE IS 4 1/2" UNLESS NOTED OR DIMENSIONED OTHERWISE.

TRUSS NOTES:

FLOOR TRUSS MANUFACTURER TO DESIGN FOR ADDITIONAL DEAD LOAD OF NON-BEARING DOUBLE STUD WALL(S) AND STAGGER STUD WALL(S) CONSTRUCTION.

PROVIDE VERTICAL BLOCKING ** TRUSS WEB AREA IF THERE IS SOLID BLOCKING ON THE FLOOR ABOVE.

ALL STRUCTURAL MEMBERS WHICH ARE REQUIRED TO HAVE A FIRERESISTANCE RATING AND WHICH SUPPORT MORE THAN TWO FLOORS OR ONE FLOOR AND ROOF, OR SUPPORT A LOADBEARING WALL OR A NONLOADBEARING WALL MORE THAN TWO STORIES IN HEIGHT, SHALL BE INDIVIDUALLY PROTECTED ON ALL SIDES FOR THE FULL LENGTH OR HEIGHT WITH MATERIALS HAVING THE REQUIRED FIRERESISTANCE RATING.

ELECTRICAL NOTES:

ALL RECESSED LIGHT ARE TO BE IC (INSULATION CONTACT) RATED. ALL RECESSED FIXTURES ARE TO BE SEALED TO LIMIT AIR LEAKAGE BETWEEN CONDITIONED AND UNCONDITIONED SPACES PROVIDE GROUND-FAULT CIRCUIT-INTERRUPTER PROTECTION FOR ALL 125-VOLT, SINGLE-PHASE, 15- AND 20-AMPERE RECEPTACLES INSTALLED IN GARAGES AND UNFINISHED BASEMENTS AREAS EXCEPT THOSE FOR FIRE OR BURGLAR ALARM SYSTEMS.

A MINIMUM OF 15% OF ALL PERMANENTLY INSTALLED LIGHTING FIXTURES MUST USE CFL BULBS OR OTHER HIGH EFFICIENCY LAMPS ALL INTERIOR TREADS AND LANDINGS MUST BE ILLUMINATED WITH NOT LESS THAN I FOOT CANDLE.


EXTERIOR STAIRWAYS SHALL BE PROVIDED WITH AN ARTIFICIAL LIGHT SOURCE LOCATED AT THE TOP OF THE LANDING.

MICHIGAN UNIFORM ENERGY CODE BUILDERS OPTIONS FOR COMPLIANCE: CLIMATE ZONE 5A

PROVIDE INSULATION AND PERFORMANCE VALUES AS PRESCRIBED IN SECTION 302 (PRESCRIPTIVE) 2009 M.U.E.C.

EXTERIOR ENCLOSURE	VALUE
WALL ASSEMBLIES	R-20
ROOF / CEILING	R-38
SLAB ON GRADE	R-IO
CRAWL SPACE WALL (CONTINUOUS)	R-IO
CRAWL SPACE WALL (CAVITY)	R-13
BASEMENT WALL (CONTINUOUS)	R-IO
BASEMENT WALL (CAVITY)	R-13
FENESTRATION / OPENINGS	U-0.35
(AREA WEIGHTED AVERAGE OF THE	R-2.85
TOTAL AREA OF FENESTRATION UNITS)	
* SEE TABLE 402.1.1 FOR FOOTNOTES	

B) PROVIDE A SIMULATED ENERGY PERFORMANCE ANALYSIS (BY OTHERS) AS PRESCRIBED IN SECTION 405 (PERFORMANCE) PROVIDE INSULATION AND FENESTRATION VALUES AS REQUIRED.

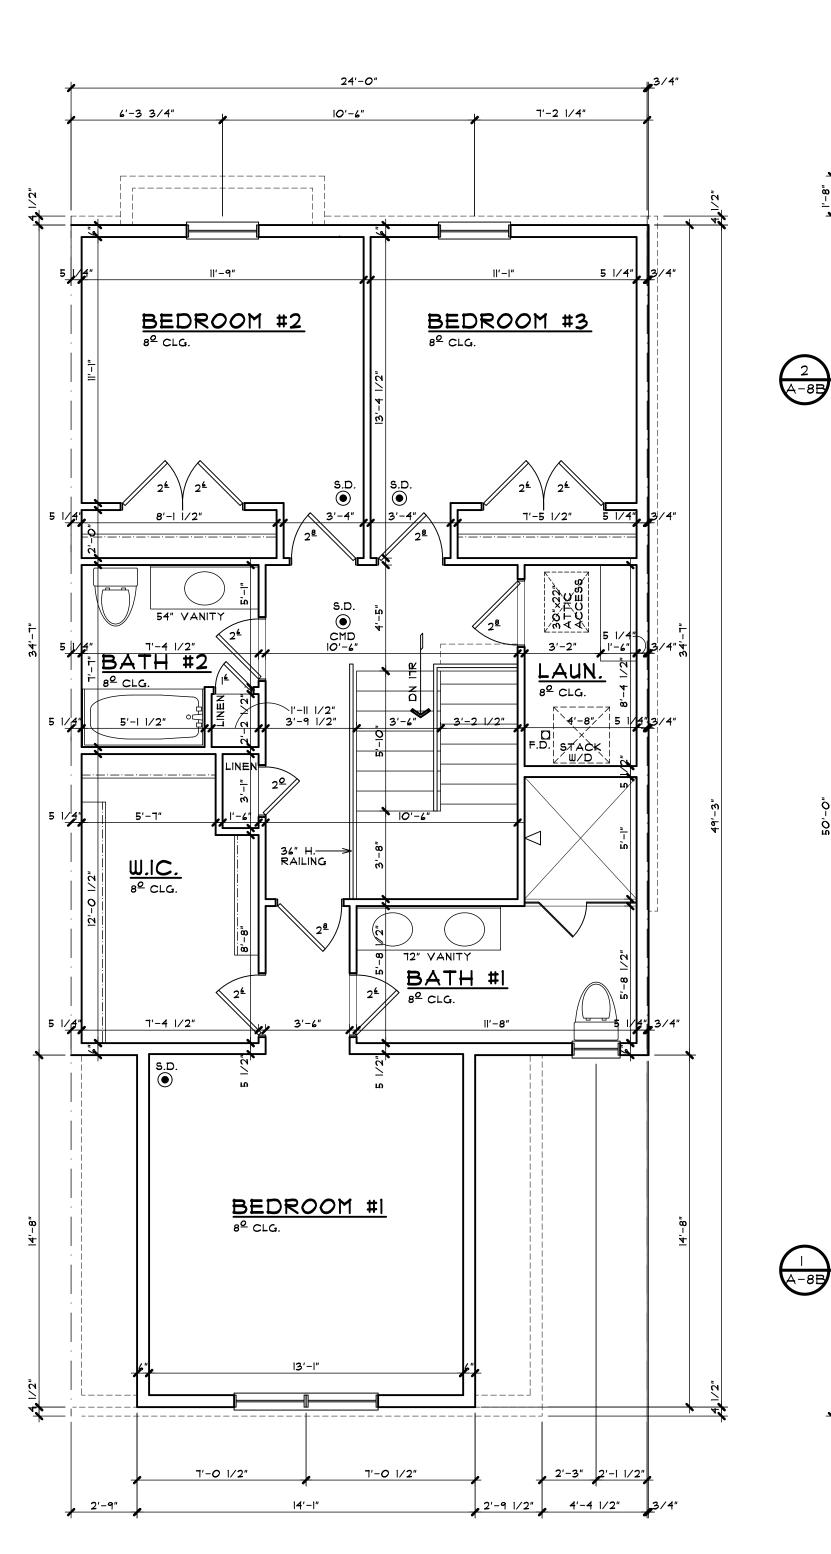

SECOND FLOOR PLAN BUILDING TYPE 'B'

SCALE: 1/4" = 1'-0"

FIRST FLOOR PLAN

19'-7 1/2"

18'-8 1/4"

GARAGE

INSULATE FLOOR SPACE ABOVE

SLOPE SLAB DN. 2" TO O.H. DR.

*PROVIDE 5/8" TYPE 'X'
GYP. BD. © GARAGE WALLS

4" CONC. SLAB ON GRANULAR FILL W/ 6 MIL VAPOR BARRIER

BUILDING TYPE 'B'

9'-9 1/2"

DINING

KITCHEN

9⁰ CLG.

9⁰ CLG.

TOROP


3'-6"

SEE OA.
BUILDING
PLAN FOR
COLUMN
LOCATION

4'-4 1/2"

SCALE: 1/4" = 1'-0"

SQUARE FOOTAGE 650 SQ FT IST FLOOR 2ND FLOOR 1,037 SQ FT 1,687 SQ FT TOTAL

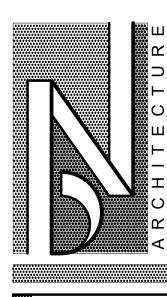

LINE OF UNIT COMMON WALL SHARED ENTRIES


OWNHOME 'B'

03-27-24

07-10-24

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A-5B

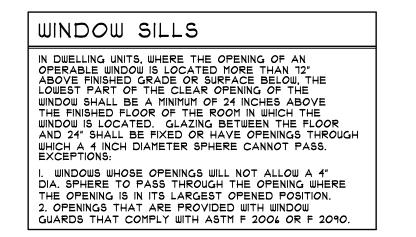


PROVIDE GUTTERS & DOWNSPOUTS FOR DRAINAGE OF ROOF WATER. DOWNSPOUTS ARE TO BE CONNECTED TO STORM WATER COLLECTION SYSTEM. SEE CIVIL ENGINEER DWGs FOR CONNECTION DETAILS/LOCATIONS. DOWNSPOUT LOCATIONS ARE TO BE DETERMINED BY THE BUILDER.

UNLESS NOTED OTHERWISE OVERHANG DIMENSIONS ARE 12" FROM SHEATHING. RAKE DIMENSIONS ARE 4" AT BRICK AND 6" AT SIDING.

STEEL LINTEL SCHEDULE LOOSE STEEL LINTELS FOR MASONRY - EXTERIOR ANGLES FOR BRICK OR STONE (NO FLOOR LOAD) MAX. CLEAR SPAN 5'-O" OR LESS 3 1/2" x 3 1/2" x 5/16" 7'-O" OR LESS 5" x 3 1/2" x 5/16" 8'-O" OR LESS 5" x 3 1/2" x 5/16" 9'-O" OR LESS 5" x 3 1/2" x 3/8" NOTE: THIS SCHEDULE APPLIES UNLESS NOTED OTHERWISE ON THE PLANS AND/OR ELEVATIONS.

NOTE: STEEL ANGLE LINTELS REQUIRE A SHOP COAT OF RUST-INHIBITIVE PAINT EXCEPT FOR LINTELS MADE OF CORROSION-RESISTANT STEEL.

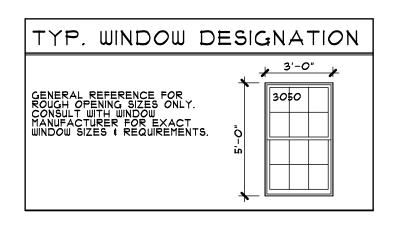


EGRESS WINDOW
EVERY SLEEPING ROOM SHALL HAVE AT LEAST ONE OPERABLE WINDOW OR EXTERIOR DOOR APPROVED FOR EMERGENCY EGRESS OR RESCUE. THE UNIT(S) MUST BE OPERABLE FROM THE INSIDE TO A FULL CLEAR OPENING WITHOUT THE USE OF SEPARATE TOOLS. WHERE WINDOWS ARE PROVIDED AS A MEANS OF EGRESS, OR RESCUE, THEY SHALL HAVE SILL HEIGHT OF NOT MORE THAN 44 INCHES ABOVE THE FLOOR. ALL EGRESS OR RESCUE WINDOWS FROM SLEEPING ROOMS MUST HAVE A MINIMUM NET CLEAR OPENING HEIGHT DIMENSION SHALL BE 24 INCHES AND WIDTH OF 20 INCHES.

I. BEFORE CONSTRUCTION OBTAIN WINDOW & DOOR ROUGH OPENING SIZES FROM WINDOW/DOOR SUPPLIER

2. TRUSS DESIGNER/FABRICATOR SEE SHEET N-2 FOR ADDITIONAL NOTES & INFORMATION


3. DO NOT SCALE THESE DRAWINGS. USE CALCULATED DIMENSIONS. IF VARIATIONS OCCUR CONTACT ARCHITECT FOR CLARIFICATION.


4. SEE CIVIL ENGINEERS'S DWGs FOR ALL FINAL A/C UNIT, ELECTRICAL METER & GAS METER LOCATIONS.

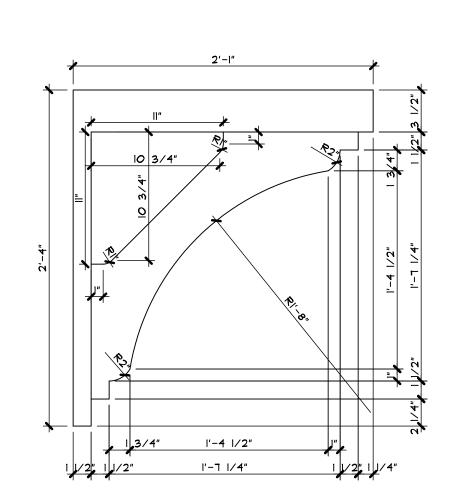


BRACKET DETAIL

SCALE: 1 1/2" = 1'-0"

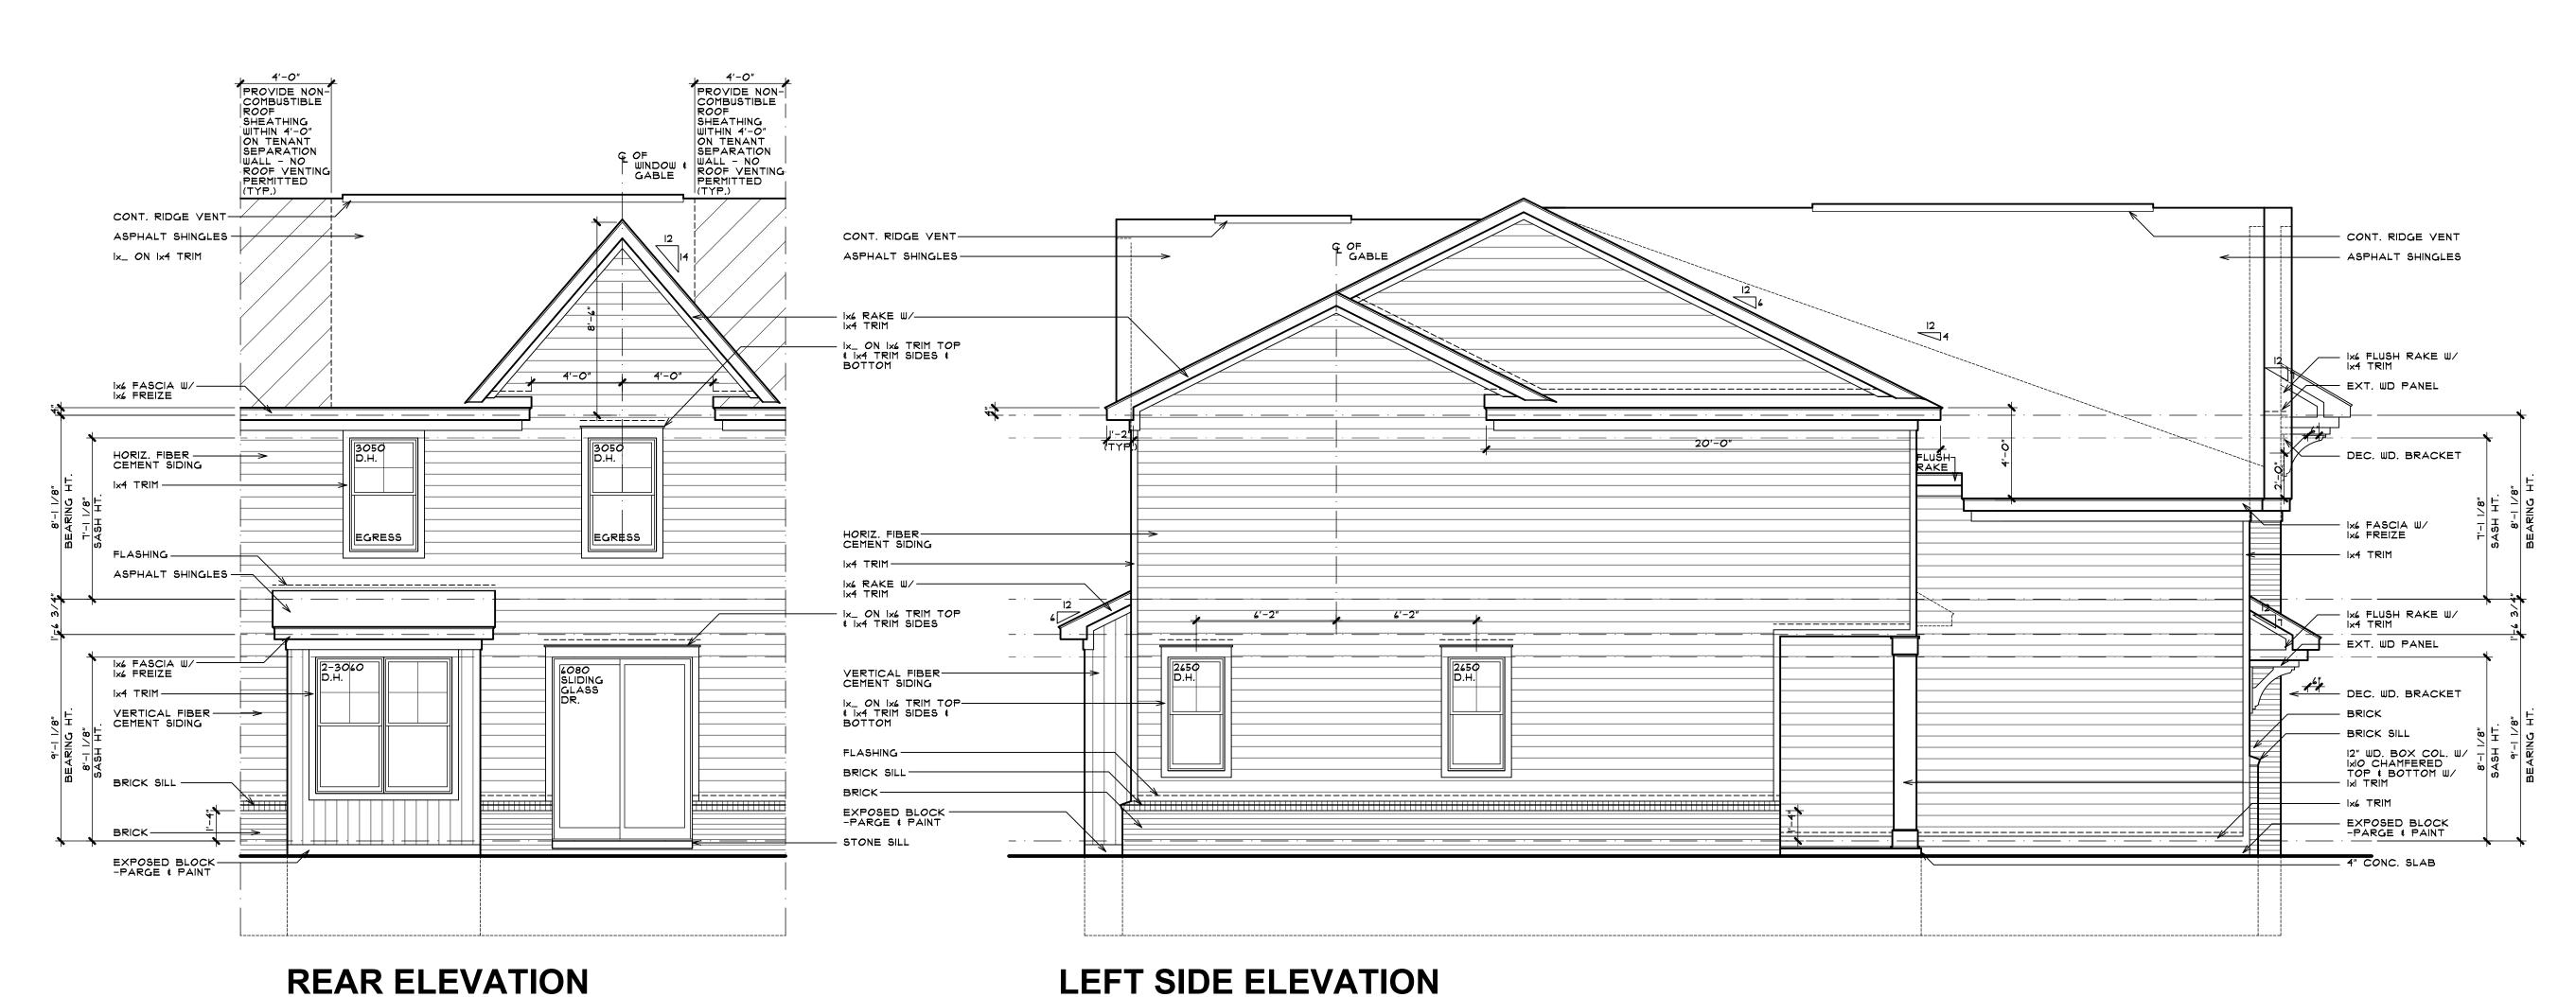

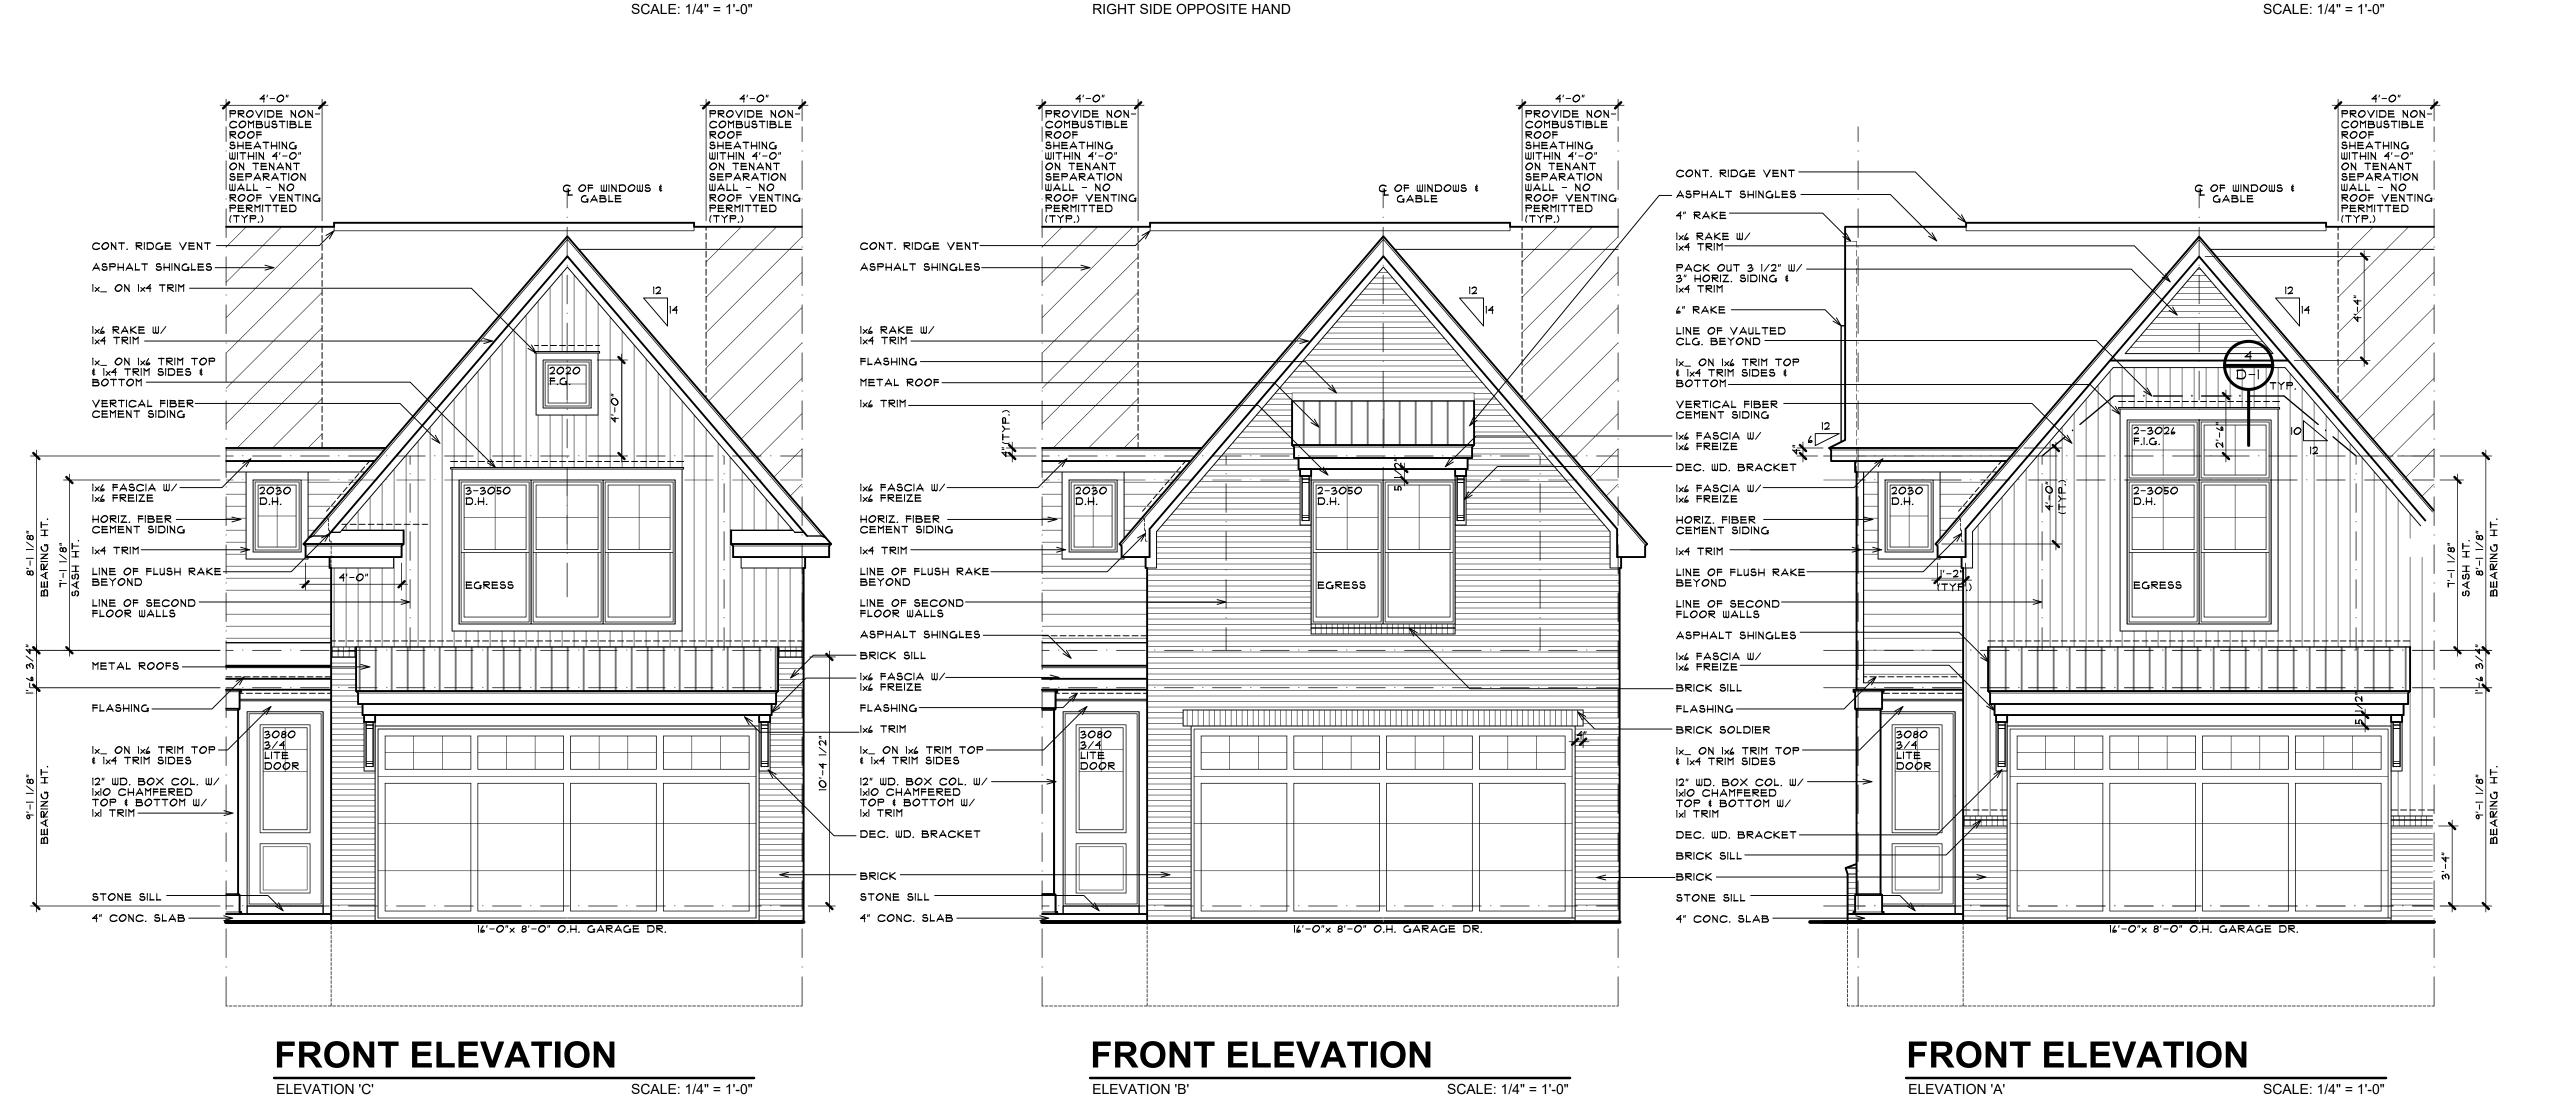

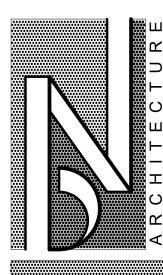


BRIAN NEEPER ARCHITECTURE P.C.


DESIGN - PLANNING - INTERIORS
630 North Old Woodward, Suite 203
BIRMINGHAM, MICHIGAN
BRIANNEEPER.COM

UNIT ELEVATIONS BUILDING TYPE 'B' 6-UN

BUILDING TYPE 'B'

TROY, MICHIGAN

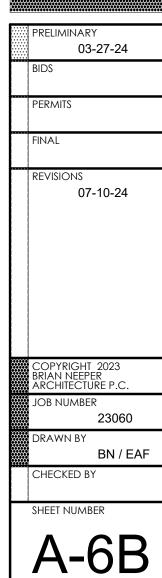

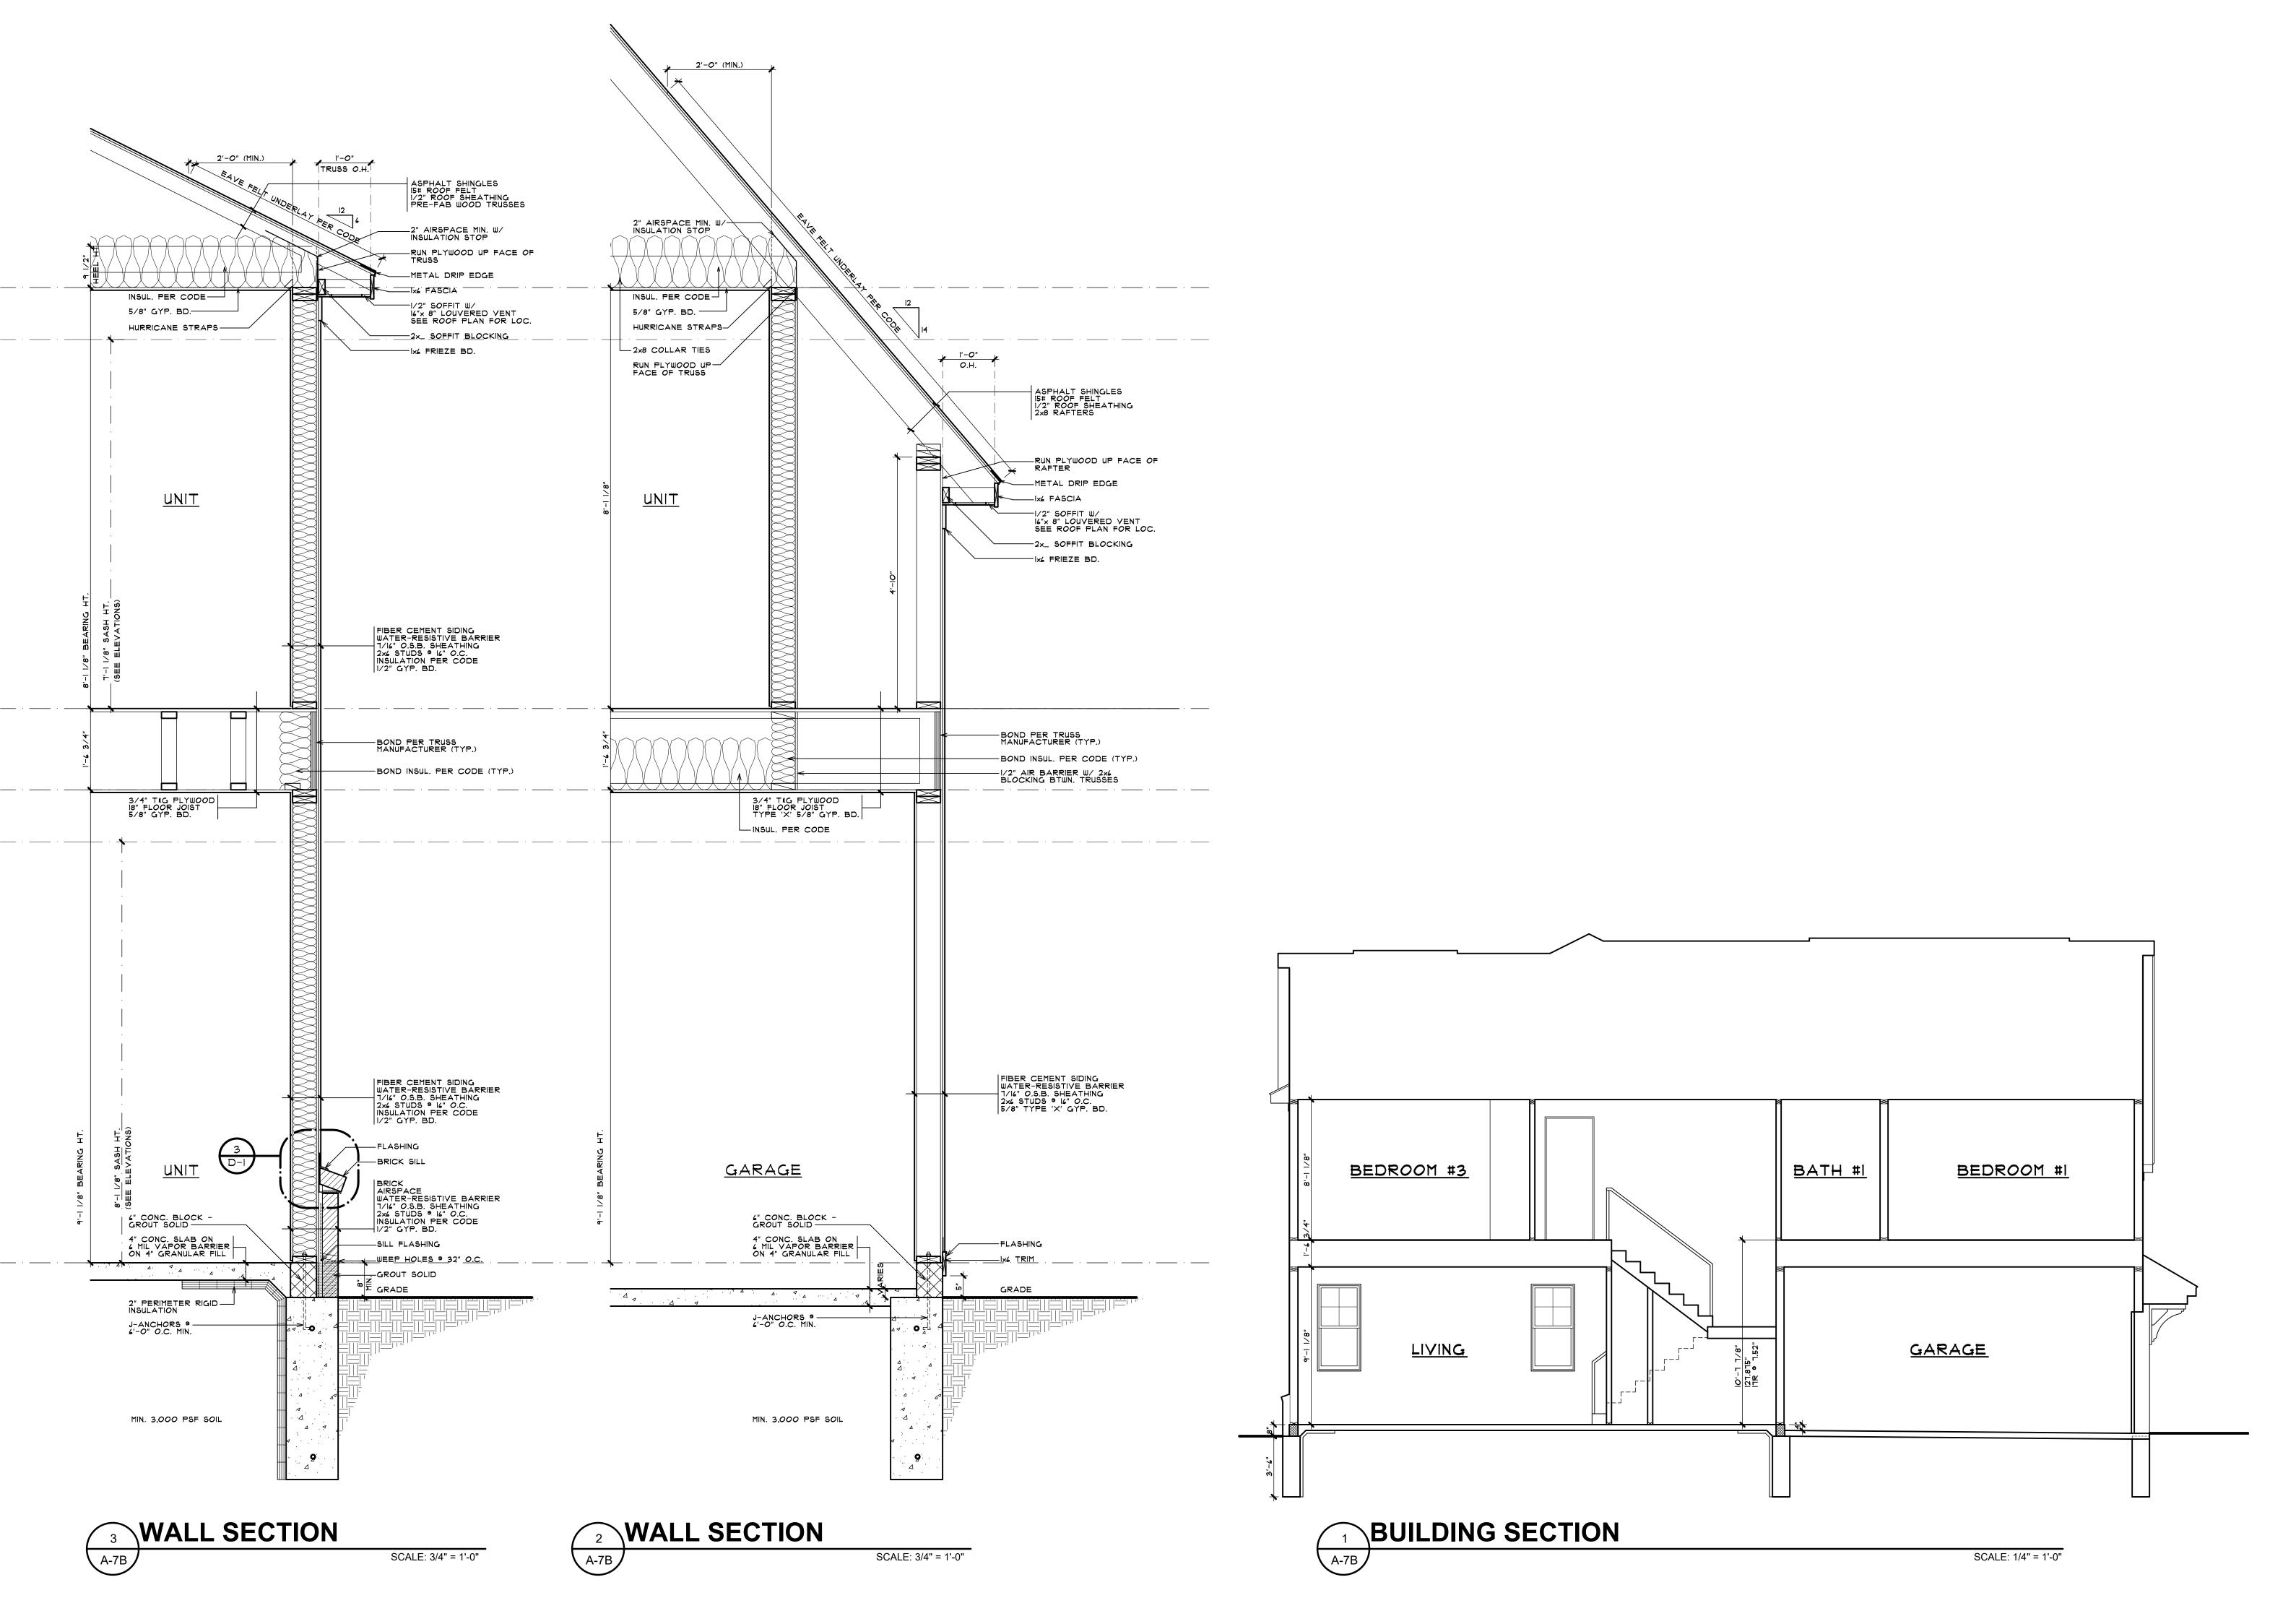

ARCHIFCTIRE

BRIAN NEEPER ARCHITECTURE P.C.

DESIGN - PLANNING - INTERIORS
630 North Old Woodward, Suite 203
BIRMINGHAM, MICHIGAN
BRIANNEEPER.COM
248, 259, 1784

BUILDING # WALL SECTIONS
BUILDING TYPE 'B' 6-UNIT

JOHN R TOWNHOME DEV.

BUILDING TYPE 'B'

TROY, MICHIGAN

PRELIMINARY
03-27-24

BIDS

PERMITS

FINAL

REVISIONS
07-10-24

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BRIAN NEEPER
ARCHITECTURE P.C.


JOB NUMBER
23060

DRAWN BY
BN / EAF

CHECKED BY

SHEET NUMBER

A-7B

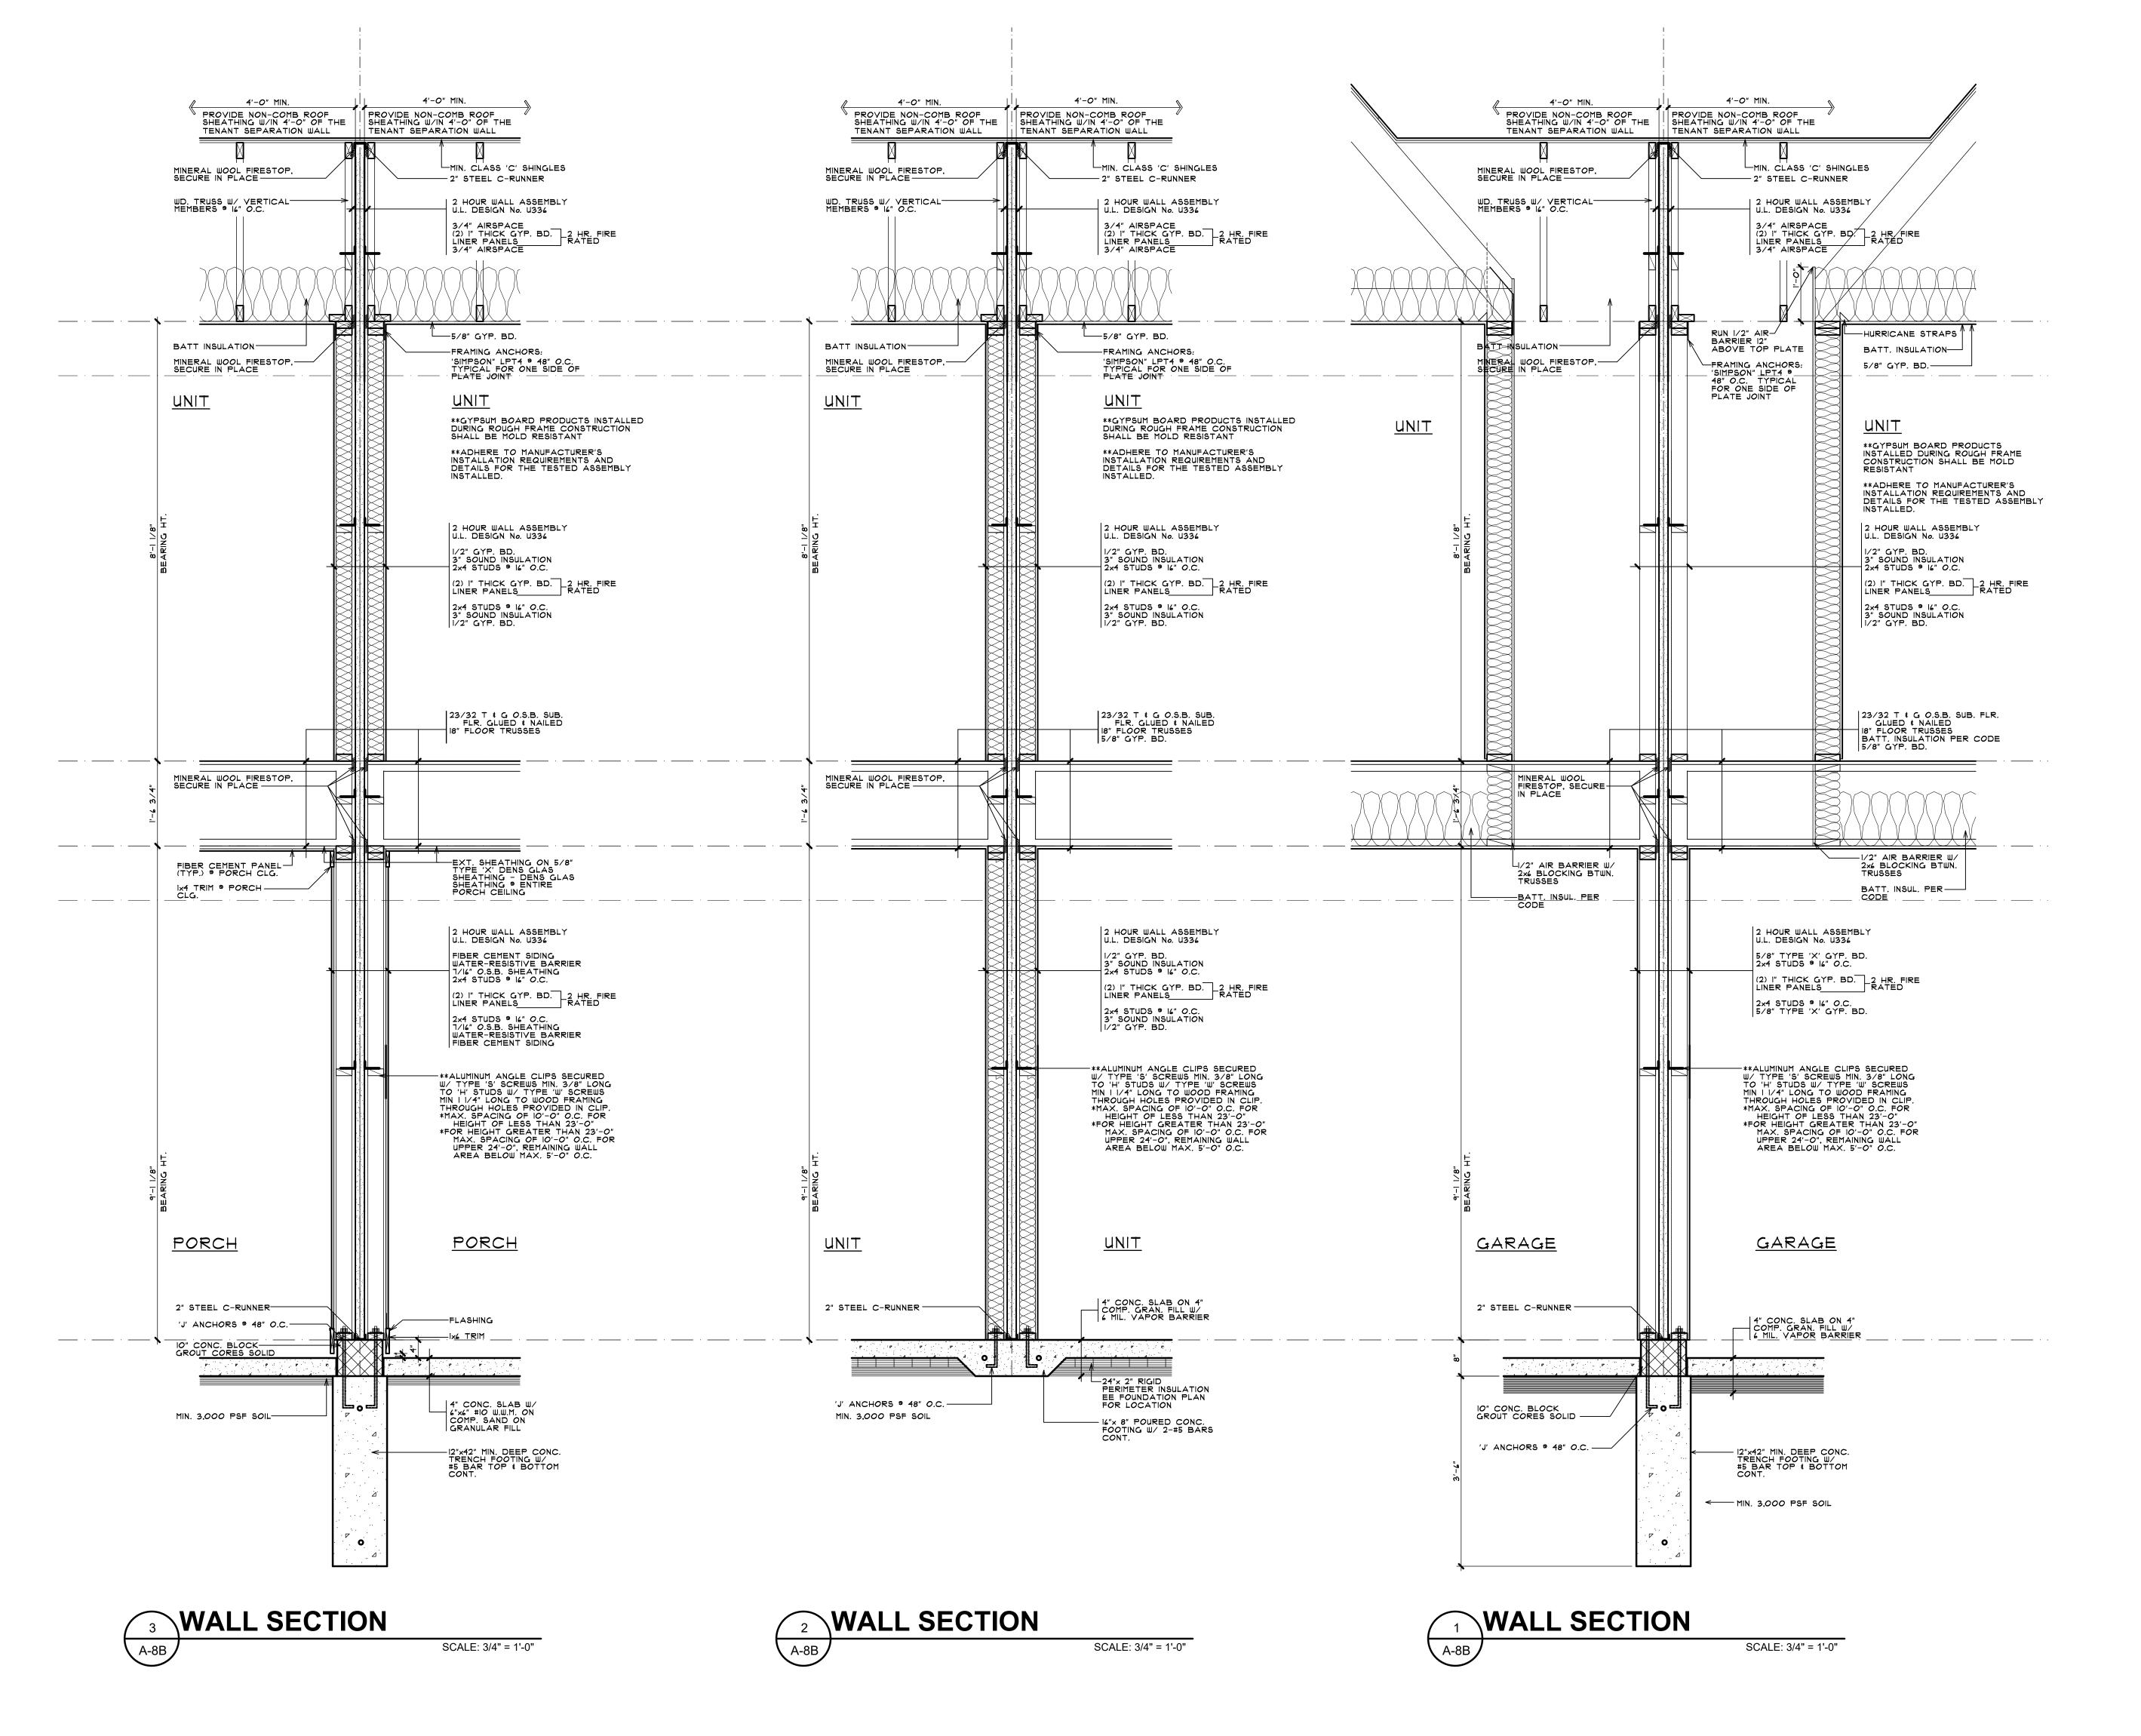

BRIAN NEEPER ARCHITECTURE P.C

DESIGN - PLANNING - INTERIORS
630 North Old Woodward, Suite 203
BIRMINGHAM, MICHIGAN
BRIANNEEPER.COM

N N

~

TYPE

DIN S

I R TOWNHOME DEV.

IG TYPE 'B'

MICHIGAN

PRELIMINARY
03-27-24

BIDS

PERMITS

FINAL

REVISIONS
07-10-24

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ARCHITECTURE P.C.

JOB NUMBER
23060

DRAWN BY
BN / EAF

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A-8B

SHEET NUMBER




FRONT ELEVATION - BUILDING TYPE 'B'

6 - UNIT



FRONT ELEVATION - BUILDING TYPE 'B'

6 - UNIT SCALE: 3/16" = 1'-0"

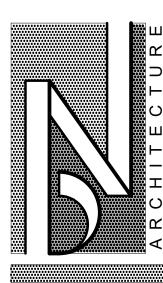

BRIAN NEEPER ARCHITECTURE P.C.

DESIGN - PLANNING - INTERIORS
630 North Old Woodward, Suite 203
BIRMINGHAM, MICHIGAN
BRIANNEEPER.COM

RENDERED FRONT
ELEVATIONS
BUILDING TYPE 'B' 6-UNIT
PRELIMINARY

JOHN R TOWNHOME DE BUILDING TYPE 'B'

TROY, MICHIGAN

PRELIMINARY
03-27-24
BIDS

FINAL

REVISIONS 07-10-24

COPYRIGHT 2023
BRIAN NEEPER
ARCHITECTURE P.C.
JOB NUMBER
23060
DRAWN BY

CHECKED BY

A OR













 From:
 Marcia Bossenberger

 To:
 Planning

 Subject:
 John R Commons

 Date:
 Tuesday, January 23, 2024 1:34:53 PM

Date: Tuesday, January 23, 2024 1:34:53 PM

[You don't often get email from mkboss131@gmail.com. Learn why this is important at https://aka.ms/LearnAboutSenderIdentification]

CAUTION: This email did not originate from within the City of Troy. Do not click links or open attachments unless you recognize the sender and know the content is safe

I reviewed the new plans for John R Commons. In the original presentation there was a lot of discussion about the shared entrance and exit with the plaza and the Kroger parking lot and cutting through the back of the Troy Sport Center. I don't see any solutions presented. It's the exact same.

The daily calculated number of trips generated for the John R Commons is 832! What is the calculated number of cars that enter the shared entry to get to Kroger plaza? I have been to that Kroger a few times and it is a busy parking lot. I know it has a street name, Nancy Bostick Drive, technically it's an entrance not really a street. It's no different than turning into the entrance to Lowe's and Meijers off Rochester Road. How many of the 832 cars are going to cut through the back of the Troy Sports Center to get to Big Beaver? How many cars are going to take a short cut from Big Beaver when traffic is backed up at John R?

This complex will probably have a lot of children of all ages. It would be nice to see some sort of play structures for families to meet up with neighborhood residents. Clubhouse to hang out to play board games, exercise equipment or rent for parties would be a great addition.

Thank you for volunteering and taking the time to make our city a wonderful place to live.

Sincerely,

Marcia Bossenberger 369 Ottawa Drive



- 3. Enhance the character, environment and safety for pedestrians and motorists.
 - a. Provide elements that define the street and the pedestrian realm.
 - b. Create a connection between the public right of way and ground floor activities.
 - c. Create a safe environment by employing design features to reduce vehicular and pedestrian conflict, while not sacrificing design excellence.
 - d. Enhance the pedestrian realm by framing the sidewalk area with trees, awnings, and other features.
 - e. Improve safety for pedestrians through site design measures.

Sent from my iPad

From: <u>Fabrice Smieliauskas</u>

To: Planning

Subject: comments for May 14, 2024 Planning Commission meeting

Date: Sunday, May 12, 2024 4:44:24 PM

You don't often get email from fab.smieliauskas@gmail.com. Learn why this is important

CAUTION: This email did not originate from within the City of Troy. Do not click links or open attachments unless you recognize the sender and know the content is safe.

Dear Planning Commission,

Some comments on two items on the agenda this week.

I support the proposed Motor City Church addition, which is near my home in the Merihill Acres sub North of Wattles here. Please ensure they extend the sidewalk on the South side of Wattles (which runs West to Coolidge from here) across the property to make the entire street more walkable - ultimately, one may hope, it could extend all the way to Crooks. Most importantly, the context is very important here. Approval will allow Motor City Church to vacate its vastly underpopulated property at Livernois near Walsh College and allow sale of a quarter-mile stretch of mostly open land to a developer - one of the largest tracts of sparsely used land in Troy. 500 or more housing units could easily be built here after rezoning to fill a crucial need for affordable homes walkable to the Big Beaver corridor and Civic Center, and within short walking distance of Wattles Elementary School, which has lost nearly 100 students in the past 5 years.

I also support the Preliminary Site Approval for John R. Commons Townhome Development to add 118 townhomes with walkability to retail, restaurants, Baker Middle School (which has also lost 100 students in the past 5 years), and International Academy East high school (part of a school network, International Academy, which was ranked the eighth best high school in the country (!!) this year (https://www.usnews.com/education/best-high-schools/michigan/districts/oakland-schools/international-academy-9741). The applicants have addressed the comments provided by the Commission and they deserve approval, especially considering the value of more multi-family residential housing in this location.

Fabrice Smieliauskas 4607 Lehigh Drive Troy, MI 7. PRELIMINARY SITE PLAN APPROVAL (JPLN2023-0031) —. Proposed Wattles Square Apartments, South side of Wattles and east of John R (PIN 88-20-24-100-039), Section 24, Zoned NN (Neighborhood Node "F") Zoning District

DATE: July 12, 2024

TO: Planning Commission

FROM: R. Brent Savidant, Community Development Director

SUBJECT: PRELIMINARY SITE PLAN APPROVAL (JPLN2023-0031) -. Proposed Wattles

Square Apartments, South side of Wattles and east of John R (PIN 88-20-24-100-

039), Section 24, Zoned NN (Neighborhood Node "F") Zoning District.

The petitioner Atto Construction submitted the above referenced Preliminary Site Plan application for a 54-unit townhome development. The property is currently zoned NN (Neighborhood Node "F") Zoning District. Multi-family residential is permitted by right in this district, subject to height and setback limitations as well as transparency requirements. The Planning Commission is responsible for granting Preliminary Site Plan approval for this item.

The Planning Commission considered this item on April 23, 2024 and May 28, 2024 (minutes attached).

The attached report prepared by Carlisle/Wortman Associates, Inc. (CWA), the City's Planning Consultant, summarizes the project. CWA prepared the report with input from various City departments including Planning, Engineering, Public Works and Fire. City Management supports the findings of fact contained in the report and the recommendations included therein.

Attachments:

- 1. Maps
- 2. Minutes from April 23, 2024 Planning Commission Regular meeting.
- 3. Minutes from May 28, 2024 Planning Commission Regular meeting.
- 4. Report prepared by Carlisle/Wortman Associates, Inc.
- 5. Preliminary site plan

G:\SITE PLANS\SP JPLN2023-0031 WATTLES SQUARE APARTMENTS\PC Memo 2024 07 23.docx

PROPOSED RESOLUTION

<u>PRELIMINARY SITE PLAN APPROVAL (JPLN2023-0031)</u> –. Proposed Wattles Square Apartments, South side of Wattles and east of John R (PIN 88-20-24-100-039), Section 24, Zoned NN (Neighborhood Node "F") Zoning District.

Resolution # PC-2024-07- Moved by: Seconded by:	
RESOLVED , That Preliminary Site Plan Approval, pursuant to Article 8 of Ordinance, as requested for the proposed Wattles Square Apartments, located or side of Wattles, east of John R, Section 24, Zoned NN (Neighborhood Node District, be granted, subject to applicant the following:	the South
) c	or
(denied, for the following reasons:) o	or
(postponed, for the following reasons:)	
Yes: No:	

MOTION CARRIED/FAILED



GIS Online



577 0 288 577Feet



Note: The information provided by this application has been compiled from recorded deeds, plats, tax maps, surveys, and other public records and data. It is not a legally recorded map survey. Users of this data are hereby notified that the source information represented should be consulted for verification.

MICHIGAN

GIS Online



577 0 288 577Feet



Note: The information provided by this application has been compiled from recorded deeds, plats, tax maps, surveys, and other public records and data. It is not a legally recorded map survey. Users of this data are hereby notified that the source information represented should be consulted for verification.

Chair Perakis called the Regular meeting of the Troy City Planning Commission to order at 7:00 p.m. on April 23, 2024, in the Council Chamber of the Troy City Hall. Chair Perakis and Vice Chair Malalahalli presented opening remarks relative to the role of the Planning Commission and procedure of tonight's meeting.

1. ROLL CALL

Present:

Toby Buechner
Carlton M. Faison
Tyler Fox
Michael W. Hutson
Tom Krent
David Lambert
Lakshmi Malalahalli
Marianna Perakis
John J. Tagle

Also Present:

R. Brent Savidant, Community Development Director Salim Huerta Jr., Commercial Project Collaborator Julie Quinlan Dufrane, Assistant City Attorney Kathy L. Czarnecki, Recording Secretary

2. <u>APPROVAL OF AGENDA</u>

Resolution # PC-2024-04-019

Moved by: Faison Support by: Fox

RESOLVED, To approve the as prepared.

Yes: All present (9)

MOTION CARRIED

3. <u>APPROVAL OF MINUTES</u> – April 9, 2024

Resolution # PC-2024-04-020

Moved by: Buechner Support by: Lambert

RESOLVED, To approve the minutes of April 9, 2024 Regular meeting as submitted.

Yes: All present (9)

MOTION CARRIED

4. <u>PUBLIC COMMENT</u> – For Items Not on the Agenda

There was no one present who wished to speak.

PRELIMINARY SITE PLAN

5. <u>PRELIMINARY SITE PLAN APPROVAL (JPLN2023-0031)</u> – Proposed Wattles Square Apartments, South side of Wattles and East of John R (PIN 88-20-24-100-039), Section 24, Zoned NN (Neighborhood Node "F") Zoning District

Mr. Savidant provided background information on the Preliminary Site Plan application for Wattles Square Apartments. He addressed the intent of the Neighborhood Node "F" zoning district, how the application relates to the Master Plan and specific site design and building design attributes. Mr. Savidant said the application proposes a first true 'garden style' building concept where a portion of the ground floor is below grade. He said there was extensive dialogue between the administration and the applicant on building height, what constitutes a story and the Zoning Ordinance definition of a basement.

Mr. Savidant asked to go on record with an apology to the Planning Commission and to the applicant for some errors in the Planning Consultant report dated April 12, 2024. He stated the application itself is more compliant than what the report narrates. Mr. Savidant noted the application meets all parking requirements with an exception of adding a bicycle rack. He reported the parking lot island trees and tree replacement are compliant. Mr. Savidant noted the one row of landscaping proposed on the north side of the site would have to be removed for future right of way purposes.

Mr. Savidant reported the application does not meet the transparency requirements on the Wattles frontage and east and south facades. He noted though transparency requirements relate more to commercial use than residential use. He said the applicant is seeking Planning Commission approval to incorporate transparency alternatives, and the Planning Commission has the authority to grant flexibility of the transparency requirements. Mr. Savidant also reported there are safety concerns with the head-clearance of the first floor balconies and the lower level units below grade.

Mr. Savidant asked the Planning Commission to consider in its deliberations the following:

- Does the Planning Commission support the proposed transparency alternatives?
- Does the proposed garden level apartment style meet the Neighborhood Node design requirements?
- Does the Planning Commission support the proposed floor plans (including the community building), elevations and balcony clearance?

In summary, Mr. Savidant asked any approval to be subject to the applicant providing the required bicycle rack and to confirm transparency requirements (30%) on the south and east sides of the buildings. He said the Planning Commission may approve the transparency alternatives for the north elevation.

Some of the comments during discussion among the administration related to:

- Transparency requirements on all facades.
- Design and transparency requirements of front elevation in relation to right of way.
- Horizontal mixed use complies with the Neighborhood Node zoning district.
- Neighborhood Node zoning requirements with future adoption of the Master Plan.
- Safety concerns of balcony head-clearance and lower level units below grade.
- Confirmation that a flat roof is proposed for both buildings.
- Compliance of landscape requirements on north side with removal of landscaping along right of way.

Chair Perakis called a recess at 7:30 p.m. to allow the Information Technology department to resolve audio issues. Chair Perakis called the meeting back in session at 7:40 p.m.

Richard Atto, property owner of subject site and Rite Aid property to the west, introduced family members in the audience and project team members business partner Brian Najor, Landscape Architect Stacee Hadeed and Project Engineer Greg Bono. Mr. Atto gave a brief history of his family background and real estate/development career. He identified several design aspects he feels would be desirous of a potential resident that are incorporated in the development.

Mr. Atto said his short-term goal is to obtain a tenant for the vacant Rite Aid store and a long-term goal would be to potentially expand the development given any future changes in the Neighborhood Node zoning district.

Ms. Hadeed distributed handouts to the Planning Commission and gave a brief history of her career path. She addressed in detail the proposed development as relates to living units, building height and stories, landscaping, parking, traffic circulation, three dimensional views from several directional perspectives, roof design, elevations, outdoor amenities, transparency calculations, site design attributes, building materials and color scheme.

There was discussion, some comments related to:

- Parking, as relates to Rite Aid existing spaces, designated spaces for residents, walking distance to residential units.
- Proposed garden style units as relates to creativity, urban look, massing, unique design, low profile.
- Examples of similar apartment styles in the City with below grade lower level units.
- Community center amenities, as relates to arrangement of work-out area and social gathering space.
- Options to mitigate safety concerns of below grade lower level units and head-clearance of balconies.
- Transparency requirements; measures applicant could apply to meet requirements, consideration of alternative options.

- Approval of application would be conditioned on applicant combining the parcels, as noted on the site plan.
- Nonconforming status of vacant Rite Aid building as relates to Neighborhood Node zoning district if demolished and/or renovated.

Mr. Hutson stated he does not support the application because of the proposed below grade lower level units and floor plans.

Chair Perakis opened the floor for public comment.

 Susan Kuhn, 2172 E Wattles; addressed existing swampy land near Wayfarer Street connection to new homes on John R, parking, management of apartment complex.

Chair Perakis closed the floor for public comment.

Discussion continued among Board members on options applicant could take to mitigate safety concerns of the balconies, to mitigate safety concerns and install egress windows on below grade lower level units, to reconfigure floor space in the community center and to meet transparency requirements.

Mr. Najor said finding a good tenant to lease the Rite Aid property is a step in the right direction. He addressed the subjectivity of transparency requirements for residential use compared to commercial use. Mr. Najor said they will work with the City to mitigate any concerns discussed this evening and meet all code requirements for the egress windows and balconies to assure compliance.

Resolution # PC-2024-04-021

Moved by: Lambert Seconded by: Faison

RESOLVED, That Preliminary Site Plan Approval, pursuant to Article 8 of the Zoning Ordinance, as requested for the proposed Wattles Square Apartments, located on the South side of Wattles, East of John R, Section 24, Zoned NN (Neighborhood Node "F") Zoning District be postponed, for the following reasons:

- 1. To increase transparency on all sides of the units.
- 2. To address appropriate concerns on the first level balconies and lower level egress areas.
- 3. Add a bicycle rack.

Yes: All present (9)

MOTION CARRIED

Mr. Savidant informed the applicant of the specific transparency requirements for each elevation.

OTHER ITEMS

6. PUBLIC COMMENT – For Items on the Agenda

There was no one present who wished to speak.

7. PLANNING COMMISSION COMMENT

There were general Planning Commission comments, some comments related to:

- Master Plan focus; parking, neighborhood node districts, North Troy zoning district.
- Potential future development of former K-Mart Headquarters site.
- Availability of Commissioners to attend May 28, 2024 Regular meeting.

8. ADJOURN

The Regular meeting of the Planning Commission adjourned at 9:25 p.m.

Respectfully submitted,

Marianna J. Perakis, Chair

Kathy L. Czarnecki, Recording Secretary

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Chair Perakis called the Regular meeting of the Troy City Planning Commission to order at 7:08 (7:06) p.m. on May 28, 2024, in the Council Chamber of the Troy City Hall. Chair Perakis and Vice Chair Malalahalli presented opening remarks relative to the role of the Planning Commission and procedure of tonight's meeting.

1. ROLL CALL

Present:

Toby Buechner
Carlton M. Faison
Tyler Fox
Michael W. Hutson
Tom Krent
David Lambert
Lakshmi Malalahalli

Marianna Perakis

Absent:

John J. Tagle

Also Present:

R. Brent Savidant, Community Development Director Salim Huerta Jr., Commercial Project Collaborator Allan Motzny, Assistant City Attorney Kathy L. Czarnecki, Recording Secretary

2. APPROVAL OF AGENDA

Resolution # PC-2024-05-027

Moved by: Faison Support by: Fox

RESOLVED, To approve the agenda as prepared.

Yes: All present (8)

Absent: Tagle

MOTION CARRIED

3. <u>APPROVAL OF MINUTES</u> – May 14, 2024

Resolution # PC-2024-05-028

Moved by: Fox Support by: Faison

RESOLVED, To approve the minutes of May 14, 2024 Regular meeting as amended.

Vote on the motion on the floor.

Yes: Buechner, Faison, Fox, Krent, Malalahalli, Perakis

No: Hutson, Lambert

Absent: Tagle

MOTION CARRIED

PRELIMINARY SITE PLAN APPROVAL

6. PRELIMINARY SITE PLAN APPROVAL (JPLN2023-0031) — Proposed Wattles Square Apartments, South side of Wattles and East of John R (PIN 88-20-24-100-039), Section 24, Zoned NN (Neighborhood Node "F") Zoning District

Mr. Savidant presented a brief background on the Wattles Square Apartments application and addressed the revisions to the site plan since last considered by the Planning Commission at their April 23, 2024 meeting. He said the applicant has provided transparency calculations that meet the requirements, reconfigured the first level balconies and lower level egress windows to address concerns of safety and aesthetics, and added a bicycle rack on the southwest corner of the north building.

Mr. Savidant asked the Planning Commission to consider in its deliberations the following:

- Compliance with Site Plan Review Design Standards set forth in Section 8.06.
- Evaluation of the revised balcony and egress window design.
- How well the proposed project meets the overall site and building design standards of the Neighborhood Node district.

Some of the comments during discussion among the administration related to:

- Egress window, compliance with Building Code, facilitation of exit in emergencies.
- Dimensions of the lower level walkout area and egress window.
- Stormwater management on site; engineering review during final site plan approval.
- Elevations as relates to ground level and basement.

Present were Richard Atto and Landscape Architect Stacee Hadeed.

Mr. Atto addressed dimensions of the egress window and walkout area, compliance with building codes, and the use of a concrete step and fence gate to facilitate an exit should there be an emergency. He said he is quite comfortable with the safety features provided in case of emergencies. Mr. Atto explained there is drain tile around the whole building and stone and/or pea gravel to facilitate the management of stormwater to the underground parking lot.

There was discussion, some comments related to:

- Number of apartment units required to be compliant with American Disabilities Act (ADA).
- Building Code requirements for bedrooms located in basement/lower level of home.
- Dimensions of walkout area, egress window, step, and fencing.
- Landscape screening/buffering in relation to adjacent single family homes.

A count was taken to determine the number of persons in the audience who were in support or in opposition of the proposed site plan application. There were 61 in opposition; none in support.

Chair Perakis opened the floor for public comment.

The following residents spoke in opposition to the proposed site plan application. The majority of concerns expressed related to: not a fit for the neighborhood; safety, particularly school children; intent of the Zoning Ordinance; traffic congestion; noise and light pollution; loss of privacy; mail delivery; trash removal; walkability and lack of sidewalks; tree preservation; connection to adjacent residential homes; desire for single family homes; transiency of apartment residents; safety of emergency exits; lack of green space.

- Peter Wilkins, 3905 Wayfarer; submitted signed petition.
- Susan Kuhn, 2172 E. Wattles.
- Colleen Helmick, 4151 Washington Crescent.
- Fred Przybysz, 3842 Wayfarer.
- Paul Leitheiser, 3897 Wayfarer.
- Padmanabhan Karatha, 2042 Applewood.
- Thiago Podolsky, 3885 Sandpiper.
- Anuratha Battula, 3930 Macaw Drive.
- Sonny Quan, 3922 Macaw Drive.
- Karen Beard, 2034 Applewood.
- Mahesh Patil, 3931 Macaw Drive.
- Katharine Mitropoulos, 3912 Anvil.
- Raja Durairajan, 3911 Macaw Drive.
- Ravi Bhamidipati, 3886 Sandpiper; submitted signed petition.
- Jeff Zaleski, 3791 Wayfarer.
- Theresa Drauch, 4097 Colonial.
- Sushma Guduguntla, 3914 Macaw Drive.
- Jason Zhang, 3953 Wayfarer.
- James Sharland, 3921 Wayfarer.

Chair Perakis closed the floor for public comment.

Mr. Savidant stated the proposed development is permitted by right. He said neither State nor local law requires notification to the public of a proposed by-right development.

Mr. Fox again shared the data of the U.S. Census survey relating to property values and home sales in communities with a mix of single family and multi-family homes. He said it is a false perception that multi-family developments attract crime and unsafe conditions.

Discussion continued on:

- Stormwater management.
- Traffic concerns, consideration to provide a traffic study.
- Connectivity to adjacent single family homes.
- Compliance with Site Plan Review Design Standards; Section 8.06.
- Concerns with transiency of apartment residents.
- Public amenities.
- Intent of Neighborhood Node zoning district.
- By-right development.
- Compliance with photometric plan.

Resolution # PC-2024-05-030

Moved by: Fox Seconded by: Faison

RESOLVED, That Preliminary Site Plan Approval, pursuant to Article 8 of the Zoning Ordinance, as requested for the proposed Wattles Square Apartments, located on the South side of Wattles, East of John R, Section 24, Zoned NN (Neighborhood Node "F") Zoning District, be granted, subject to the following:

1. The applicant providing a six (6) foot high privacy fence along the south and east property lines.

Discussion on the motion on the floor.

Section 8.06, 1, b. of the Site Plan Review Design Standards, Street fronts shall provide a variety of architectural expression that is appropriate in its context and prevents monotony, was discussed.

Vote on the motion on the floor.

Yes: Faison, Fox, Lambert, Perakis

No: Buechner, Hutson, Krent, Malalahalli

Absent: Tagle

MOTION FAILED

Resolution # PC-2024-05-031

Moved by: Fox

Seconded by: Malalahalli

RESOLVED, That Preliminary Site Plan Approval, pursuant to Article 8 of the Zoning Ordinance, as requested for the proposed Wattles Square Apartments, located on the South side of Wattles, East of John R, Section 24, Zoned NN (Neighborhood Node "F") Zoning District, be postponed, for a full board in attendance.

Yes: Buechner, Faison, Fox, Krent, Lambert, Malalahalli, Perakis

No: Hutson Absent: Tagle

MOTION CARRIED

The Board members encouraged the applicant to provide a privacy fence on the south and east property lines, a general traffic study, a variety of architectural expression for the units that front Wattles, and a colored rendering.

Chair Perakis called for a recess at 9:45 p.m. The meeting reconvened at 9:58 p.m.

SPECIAL USE APPROVAL

7. PUBLIC HEARING - SPECIAL USE APPROVAL AND PRELIMINARY SITE PLAN REVIEW (SU JPLN2024-0006) – Proposed Jax Kar Wash, South side of Long Lake, East of Livernois (102 East Long Lake Road), Section 15, Currently Zoned NN (Neighborhood Node "M") Zoning District

Mr. Lambert disclosed that his daughter is employed at the day care center east of the subject site. The Board members agreed there is no conflict of interest.

Mr. Savidant reviewed the Special Use Approval and Preliminary Site Plan application for a Jax Kar Wash. He addressed the number of vacuum spaces and stacking spaces, the proliferation of car washes in the City and the use of a water reclamation/recycling system.

Mr. Savidant referenced the applicant's responses on the proposed number of vacuum stations, the use of a water reclamation/recycling system, and the proliferation of car washes in the City. He read into the record the applicant's responses as cited on pages 5, 7 and 9 of the Planning Consultant Report dated May 21, 2024.

Mr. Savidant stated that while the subject property is still in the Neighborhood Node (NN) zoning district, the future land use for this site was removed from the Neighborhood Nodes in the newly adopted version of the Master Plan, and underlying zoning of those Neighborhood Nodes are to be determined.

Mr. Savidant asked the Planning Commission to consider in its deliberations the proposed use, consumer demand, and to consider any testimony heard at the public hearing. In summary, Mr. Savidant asked the Planning Commission to consider if the application is compliant with the Special Use and Site Plan Review Design Standards and to ask the applicant's consideration to use a water reclamation/recycling system.

Vote on the motion on the floor.

Yes:

Buechner, Faison, Hutson, Krent, Lambert, Perakis

No:

Fox, Malalahalli

Absent:

Tagle

MOTION CARRIED

OTHER ITEMS

PUBLIC COMMENT – For Items on the Agenda

Deborah Louzecky, 6327 Donaldson, spoke on Agenda Item #5, The Village of Hastings PUD. She addressed a desire that the proposed development created more of a village-like or downtown environment.

9. PLANNING COMMISSION COMMENT

There were general Planning Commission comments, some comments related to:

- Planning Commission access to public comment.
- Progress on hotel development at I-75 and Rochester Road.
- Compaction of trash in multi-family residential development.
- Proposed development at former K-Mart Headquarters property; informal presentation by applicant in June.

Mr. Savidant announced that the City Council adopted the Master Plan at their May 20, 2024 meeting. He shared information on a Michigan Association of Planners (MAP) meetup site visit at Palmer Park and a nearby LGBTQ community in Detroit.

10. <u>ADJOURN</u>

The Regular meeting of the Planning Commission adjourned at 11:26 p.m.

Respectfully submitted,

Marianna J. Perakis, Chair

Kathy L. Czarnecki, Recording Secretary

G:\PLANNING COMMISSION MINUTES\2024 PC MINUTES\FINAL\2024 05 28 FINAL.docx



117 NORTH FIRST STREET SUITE 70 ANN ARBOR, MI 48104 734.662.2200 734.662.1935 FAX

Date: November 1, 2023

Revised: February 7, 2024 April 12, 2024

May 14, 2024

July 15, 2024

Preliminary Site Plan For City of Troy, Michigan

Applicant: Atto Construction

Project Name: Wattles Square Apartment

Plan Date: June 3, 2024

Location: South side of Wattles, east of John R.

Zoning: NN, Neighborhood Node, Site Type B

Action Requested: Preliminary Site Plan Approval

PROJECT AND SITE DESCRIPTION

An application has been submitted for a proposed multiple family stacked flat project along the south side of Wattles, east of John R. The site is approximately 2 acres in area and is currently vacant but encumbered with tree cover. The site is directly east of an existing RiteAid and abuts residential uses on its north, east, and south sides.

The applicant proposes a total of 57 units, divided into two (2) buildings. The first building is directly adjacent to Wattles and the second building is set behind the first. The buildings are stacked flats totaling three (3) stories, but we note that the applicant has lowered the grade of the site so the first story is below grade. The level below grade (noted as "garden level") and the level above (noted as "first floor") are one unit. The third level (noted as "second floor") is a separate unit.

The proposed development is heavily intertwined with the RiteAid site to the east. The applicant is utilizing a portion of the existing RiteAid site for sidewalks, open space, five (5) parking spaces, and a shared dumpster/recycling enclosure. Furthermore, the applicant proposes to convert a 500 sq/ft section of the existing RiteAid building into a community building for tenants. The existing RiteAid site is owned by the same owner and they will combine the lots to make them one zoning lot.

The site is zoned NN, Neighborhood Node. The proposed multiple family residential use is permitted in the NN, Neighborhood Node, Site Type B.

Location of subject site:

South side of Wattles, east of John R.



Location and Aerial Image of Subject Site

Size of subject site:

The property is approximately 2 acres in area.

Proposed use of subject site:

The proposed use is for 56 apartment units.

Current use of subject site:

The property is currently vacant.

Current Zoning:

The property is currently zoned NN, Neighborhood Node, Site Type B.

Surrounding Property Details:

Direction	Zoning	Use
North	NN, Neighborhood Node	Attached Residential
South	R1-C, One Family Residential District	Single Family Residential
East	R1-C, One Family Residential District	Single Family Residential
West	NN, Neighborhood Node	RiteAid

PREVIOUS PLANNING COMMISSION REVIEWS

The items was first last by the Planning Commission on May 28, 2024. The item was postponed to have a full board in attendance. In addition, the Board members encouraged the applicant to provide a privacy fence on the south and east property line, a general traffic study, a variety of architectural expression for the units that front on Wattles, and a colored rendering.

CHANGES SINCE PLANNING COMMISSION REVIEW

Since the last meeting the applicant has provided the following:

- Fence detail: The applicant has provided a six-foot tall stockade wood fence. The fence is proposed along the eastern and southern property lines.
- Traffic memo: a traffic memo was completed by OHM. A summary of the memo:

The table below provides the calculated number of trips generated for the Wattles Square site, based on the ITE Trip Generation Manual, 11th Edition, for Multifamily Housing (Low-Rise) (ITE Land Use Code #220).

Table 1. Trips Generated

		AM Peak			PM Peak	
Dwelling Units	In	Out	Total	In	Out	Total
54	10	30	40	28	16	44

During the morning (AM) peak hour, the Wattles Square site generates 40 vehicle trips: 10 inbound (entering the site), and 30 outbound (exiting the site). During the evening (PM) peak hour, the site generates 44 vehicle trips: 28 inbound (entering the site), and 16 outbound (exiting the site).

Overall, the amount of traffic generated from this proposed site will not provide significant impacts to Wattles Road, John R Road, or the surrounding roadway network.

 Revised elevations and colored rendering: The applicant has revised the front elevations (fronting Wattles) to provide more architectural variety and increase transparency. In addition, the applicant has provided a set of colored renderings.



July Elevations

SITE PLAN REVIEW STANDARDS

<u>Section 8.06 outlines Site Plan Review Design Standards.</u>

- 1. Development shall ensure compatibility to existing commercial districts and provide a transition between land uses.
 - a. Building design shall enhance the character of the surrounding area in relation to building and parking placement, landscape and streetscape features, and architectural design.
 - b. Street fronts shall provide a variety of architectural expression that is appropriate in its context and prevents monotony.
 - c. Building design shall achieve a compatible transition between areas with different height, massing, scale, and architectural style.
- 2. Development shall incorporate the recognized best architectural building design practices.
 - a. Foster a lasting impact on the community through the provision of high quality design, construction, and detailing.
 - b. Provide high quality, durable materials, such as but not limited to stone, brick, glass, and metal. E.I.F.S. or material equivalent shall only be used as an accent material.
 - c. Develop buildings with creativity that includes balanced compositions and forms.

- d. Design roofs that are appropriate to the architectural style of the building and create an appropriate visual exterior mass of the building given the context of the site.
- e. For commercial buildings, incorporate clearly defined, highly visible customer entrances using features such as canopies, porticos, arcades, arches, wing walls, ground plane elements, and/or landscape planters.
- f. Include community amenities that add value to the development such as patio/ seating areas, water features, art work or sculpture, clock towers, pedestrian plazas with park benches or other features located in areas accessible to the public.
- 3. Enhance the character, environment and safety for pedestrians and motorists.
 - a. Provide elements that define the street and the pedestrian realm.
 - b. Create a connection between the public right of way and ground floor activities.
 - c. Create a safe environment by employing design features to reduce vehicular and pedestrian conflict, while not sacrificing design excellence.
 - d. Enhance the pedestrian realm by framing the sidewalk area with trees, awnings, and other features.
 - e. Improve safety for pedestrians through site design measures.

SUMMARY

The Planning Commission should consider compliance with the Site Plan Review standards set forth in Section 8.06.

Sincerely,

CARLISLE/WORTMAN ASSOC., INC. Benjamin R. Carlisle, AICP, LEED AP

President

CARLISLE/WORTMAN ASSOC., INC.

Shana Kot

Community Planner



memorandum

Date: April 11, 2024

To: Scott Finlay, PE

From: Stephen Dearing, PE, PTOE & Lauren Hull, EIT

Re: Proposed John R Commons Townhome Development


Site Plan Review

We have reviewed the site plan for the proposed John R Commons Townhome development in Troy, Michigan. The plans were prepared by PEA Group and are dated March 1, 2024.

OHM's comments are as follows:


1. Site Plan:

a. Align the aisles and provide pedestrian access between sites. The dog park can be relocated to the northeast corner of the site instead.

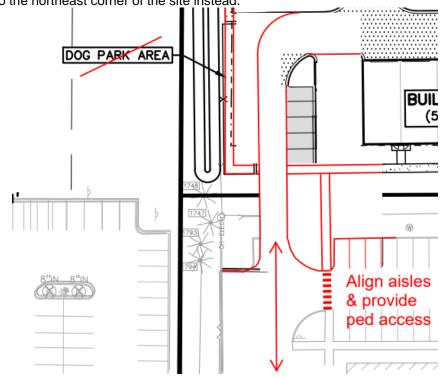




b. Provide a sidewalk connection to Floyd as a school walking route to the neighborhood elementary school.

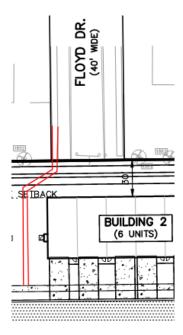

c. Provide a sidewalk connection as shown below.

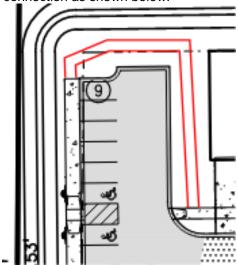


- d. Sidewalk should be dimensioned. Additionally, any sidewalk adjacent to parking spaces needs to be at least 7 feet wide since there is the possibility of vehicle overhang.
- e. The east driveway needs to be dimensioned.
- f. Provide sidewalk along Nancy Bostick Drive connecting to the existing sidewalk along John R Road. Included with this, add a crosswalk across the east driveway.
- g. The west driveway seems to eliminate several parking spaces for the adjacent site. Has this been agreed upon/coordinated with the adjacent site?

July 23, 2024 Troy PC meeting Wattles Square Apartments

East Wattles & John R. Road, Troy MI



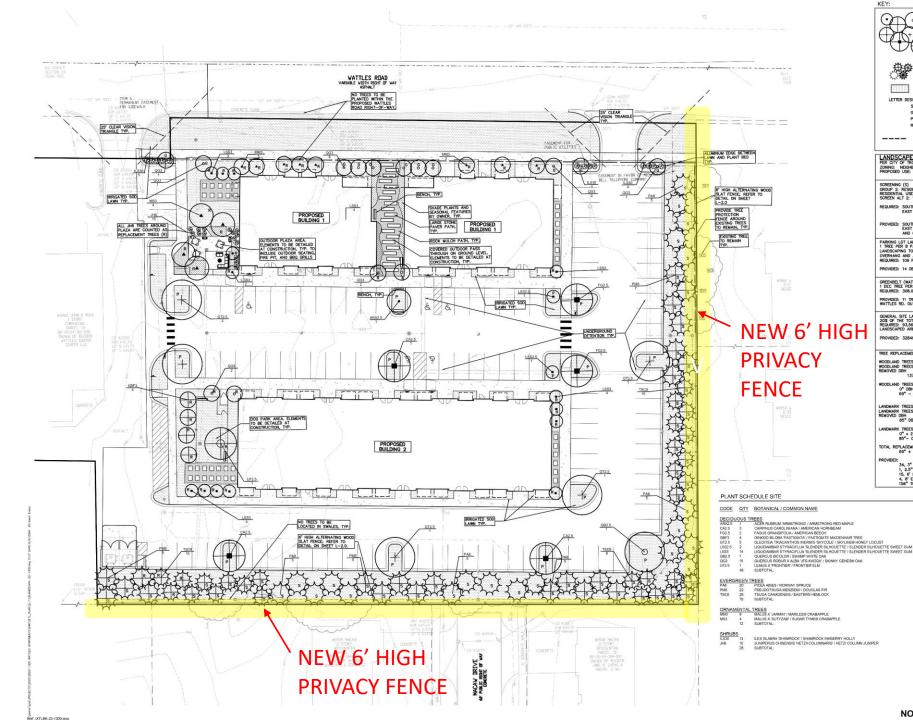





= PROPOSED EVERGREEN TREES



= IRRIGATED SOD LAWN



- S = SCREENING LANDSCAPING
- = GREENBELT TREES P = PARKING LOT TREES
- R = REPLACEMENT TREES

= TREE PROTECTION FENCE

SCREENING (S)
GROUP 2: RESIDENTIAL/LODGING USES ABUT GROUP 1:
RESIDENTIAL USES. SCREEN ALT 1 OR 2 REQUIRED.
SCREEN ALT 2: 1 LARGE EVG TREE PER 10LF

PROVIDED: SOUTH BOUNDARY: 38 EVG TREES EAST BOUNDARY: 28 EVG TREES AND 6' HT OPAQUE SCREEN FENCE

PARKING LOT LANDSCAPE (P)
1 TREE PER 8 PARKING SPACES
LANDSCAPING TO BE 5' FROM CURB WHERE THERE IS VEHICLE
OVERHANG AND 3' WHERE THERE IS NOT.
REQUIRED: 109 PARKING SPACES / 8 — 14 DEC TREES

PROVIDED: 14 DEC TREES

GREENBELT (WATTLES RD) (G)
1 DEC TREE PER 30 LF OF FRONTAGE ABUTTING A PUBLIC ROW
REQUIRED: 308.01 LF / 30 = 11 TREES

GENERAL SITE LANDSCAPE
20% OF THE TOTAL SITE AREA IS TO BE LANDSCAPED
REQUIRED: 93,561 SF SITE AREA X 20% = 18,712.2 SF
LANDSCAPED AREA

PROVIDED: 32849.6 SF LANDSCAPED AREA (35%)

WOODLAND TREES:
WOODLAND TREES REMOVED (12 TREES): REPLACE AT 50% OF REMOVED DBH
137" DBH X .5 = 69" REPLACEMENT

WOODLAND TREES SAVED (0 TREES): CREDIT OF 2X DBH 0" DBH X 2 = 0" CREDIT 69" - 0"= 69" REPLACEMENT REQUIRED

LANDMARK TREES: LANDMARK TREES REMOVED (4 TREES): REPLACE AT 100% OF REMOVED DBH 85" DBH X 1 = 85" REPLACEMENT

ANDMARK TREES SAVED (0 TREES): CREDIT OF 2X DBH

0" x 2 = 0" CREDIT

85"- 0" = -85" REPLACEMENT REQUIRED

TOTAL REPLACEMENT TREES: 69" + 85" = 154" DBH REPLACEMENT REQUIRED

34, 3" DEC TREES = 34 X 3" DBH = 102" DBH 1, 2.5" DEC TREE = 1 X 2.5" DBH = 2.5" BH 15, 6' EVG TREES = 15 X 2.5" DBH = 37.5" DBH 4, 8' EVG TREES = 4 X 3.5" DBH = 14" DBH 158" TOTAL DBH PROVIDED

ΛEG GROUP

t 844.813.2949 www.peagroup.com











CLIENT ATTO CONSTRUCTION, INC.

PROJECT TITLE

WATTLES SQUARE APARTMENTS

REVISIONS	
CITY COMMENTS	11/15/23
SITE PLAN APPROVAL	12/5/23
CITY COMMENTS	3/6/24
CITY COMMENTS	6/3/24
ORIGINAL ISSUE DATE:	1
SEPTEMBER 22, 2023	
DRAWING TITLE	

PRELIMINARY LANDSCAPE PLAN

PEA JOB NO.	22-1309
P.M.	GMB
DN.	BGG
DES.	JLE
DRAWING NUMBER	

PER PLAN PER PLAN PER PLAN






REVISED NORTH ELEVATION AND EAST ELEVATION TO INCREASE TRANPARENCY



REVISED NORTH ELEVATION AND EAST ELEVATION TO INCREASE TRANPARENCY

The material palette of the architectural design is varied, including:

- 2 brick types
- burnished block
- Stone veneer
- 2 types of metal siding.

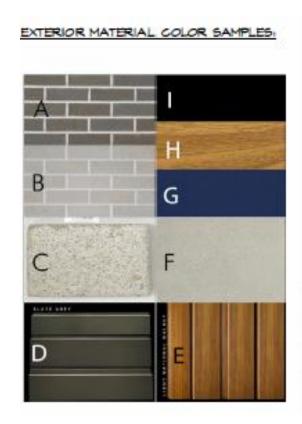


EXTERIOR BLDG, MATERIAL LEGEND:

- A. 12' W. X 4' H. BRICK VENEER MEDIUM GRAY COLOR
- B. 12' W. X 4' BRICK VENEER VERY LIGHT GRAY COLOR
- Ié" N. X 8" H. BURNISHED SMOOTH CONCRETE BLOCK LIGHT CREAM COLOR.
- D. 6" H. HORIZONTAL METAL SIDING MEDIUM CHARCOAL MOOD GRAIN
- E. 6' H. VERTICAL METAL SIDING LIGHT WALNUT WOOD GRAIN
- F. 2'-6' W. X IO SV4" H. STONE VENEER. LIGHT GRAY COLOR
- G. COMMERCIAL GRADE CANVAS ANNING MARINE BLUE COLOR
- RESIDENCE ENTRY DOORS LIGHT WALNUT WOOD GRAIN
- BLACK COLOR; WINDON & DOOR FRAMES METAL BALCONY & RAILINGS METAL CANOPY AT 2ND FLR STAIR ENTRY METAL PARAPET COPING
- J 2ND FLOOR HVAC GRILLE COLOR TO MATCH ADJACENT WALL MATERIAL COLOR



The street front facade has a variety of architectural expression, with a façade that steps in and out and transitions materially both horizontally and vertically, causing unique shadow lines, color contrast, and texture changes.

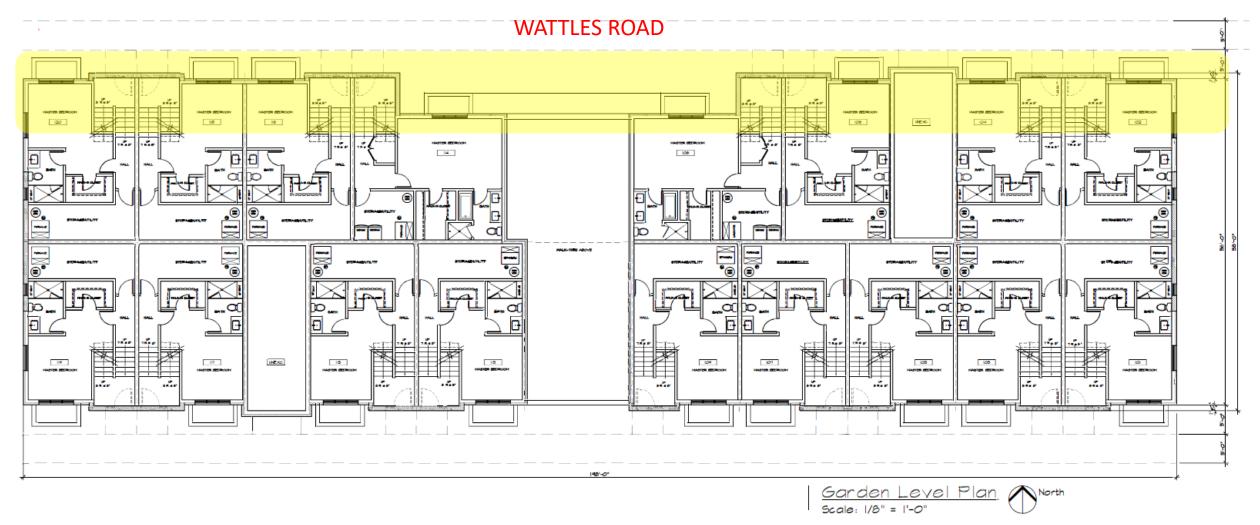






"MASTER PLAN"


We sincerely believe that we meet the intended purpose of the neighborhood node category.

Multifamily apartment buildings inherently support social neighborhoods through increased density. This increased density creates a robust and livable community. For our site, being surrounded by single family homes, this results in a more diverse community. Additionally, our neighborhood node is a site, that will be combined with the neighboring commercial retail site (formerly Rite Aid). It is a mixed use project.

We are providing gathering places for residents and their guests with the community patio, and the dog park, and the "pass through" garden space which will include landscaping and benches, in the center of Building 1.

Basic living needs for residents will be provided through the apartment building and site, while also generous outdoor areas and on site parking will also be provided for residents. Residents will have access to multiple services provided on site necessary for daily living. Furthermore, the project location lends itself to easy and walkable access to nearby retail and has close proximity to services provided by the City of Troy.

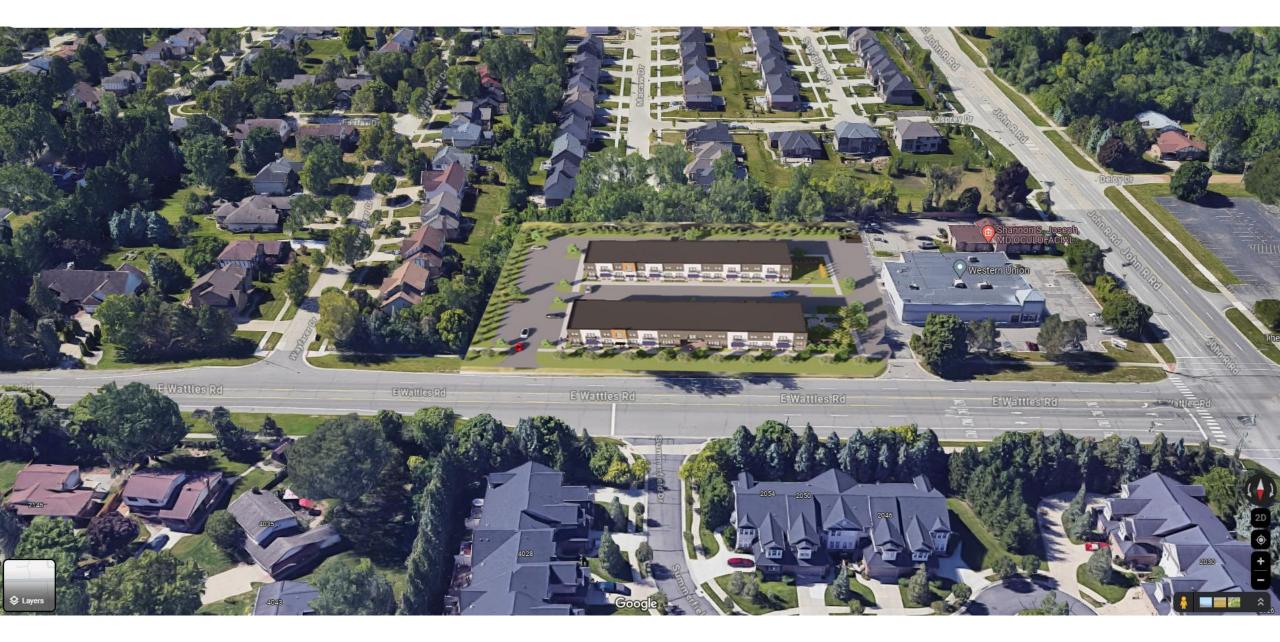


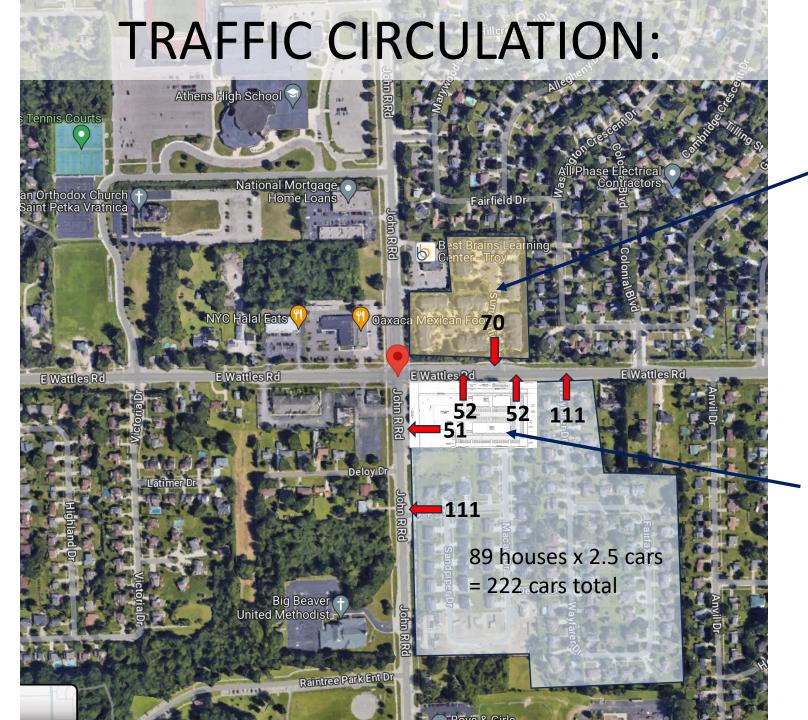

35 units x 2 cars = 70 cars total

PROPOSED: 155 spaces. (52+52+51) Max 155 cars The Community Building space, which will include a minimum of 500-600 SF, will be a vibrant and welcoming gathering place for residents to meet and mingle. It can support health and wellness activities, fitness equipment, a lounge space for television viewing, and more. It will be flexible and adaptable to support the various needs of the resident community.



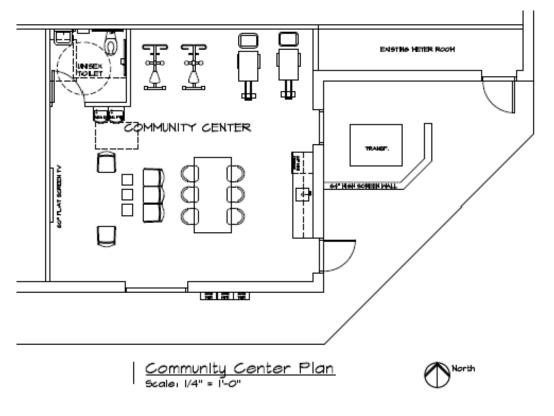


THANK YOU! QUESTIONS?

WATTLES SQUARE APARTMENTS

E. WATTLES ROAD & JOHN R. ROAD CITY OF TROY, OAKLAND COUNTY, MICHIGAN

DATE SUBMITTED DATE APPROVED PERMIT / APPROVAL

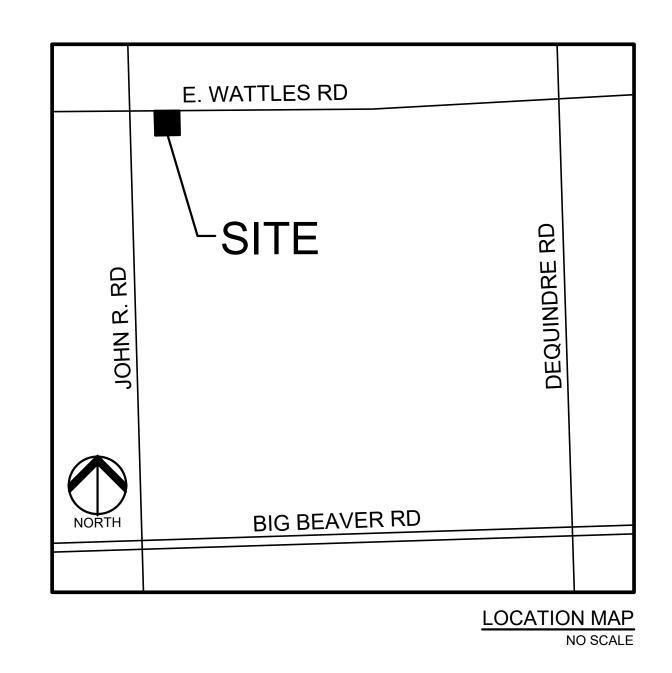

INDEX OF DRAWINGS NUMBER TITLE **COVER SHEET TOPOGRAPHIC SURVEY** OVERALL SITE PLAN PRELIMINARY SITE PLAN PRELIMINARY GRADING PLAN PRELIMINARY UTILITY PLAN **NOTES AND DETAILS** PRELIMINARY LANDSCAPE PLAN LANDSCAPE DETAILS TREE PLAN TREE LIST PHOTOMETRIC PLAN ARCHITECTURAL PLANS **BUILDING 1 NORTH EXTERIOR ELEVATION** TWO LEVEL UNIT FLOOR PLANS - BUILDING ' TWO LEVEL UNIT FLOOR PLANS - BUILDING 2 2ND FLOOD SINGLE LEVEL UNITS - BUILDINGS 1 & 2 **BUILDING 1 EXTERIOR ELEVATIONS** A2.1 **BUILDING 2 EXTERIOR ELEVATIONS** COMMUNITY CENTER PLAN

DESIGN TEAM

DEVELOPER

ATTO CONSTRUCTION
2150 FRANKLIN ROAD
BLOOMFIELD HILLS, MI 48302
CONTACT: RICHIE ATTO
EMAIL: ATTONATION@MSN.COM

ARCHITECT

HARRY SWIHART ARCHITYPE
21643 SHIAWASSEE DR.
CASSAPOLIS, MI 49031
CONTACT: HARRY SWIHART
PHONE: 312.758.7037
EMAIL: HSARCHITYPE@COMCAST.NET


CIVIL ENGINEER

PEA GROUP
1849 POND RUN
AUBURN HILLS, MI 48326
CONTACT: GREG BONO, PE
PHONE: 844.813.2949
EMAIL: GBONO@PEAGROUP.COM


LANDSCAPE ARCHITECT

PEA GROUP
7927 NEMCO WAY, STE. 115
BRIGHTON, MI 48116
CONTACT: JANET EVANS, PLA
PHONE: 844.813.2949
EMAIL: JEVANS@PEAGROUP.COM

PENA GROUP

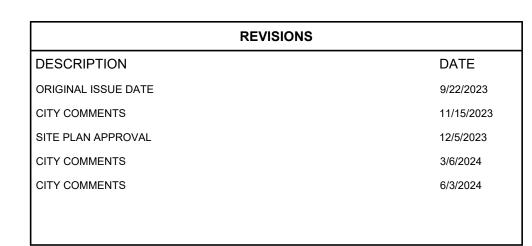




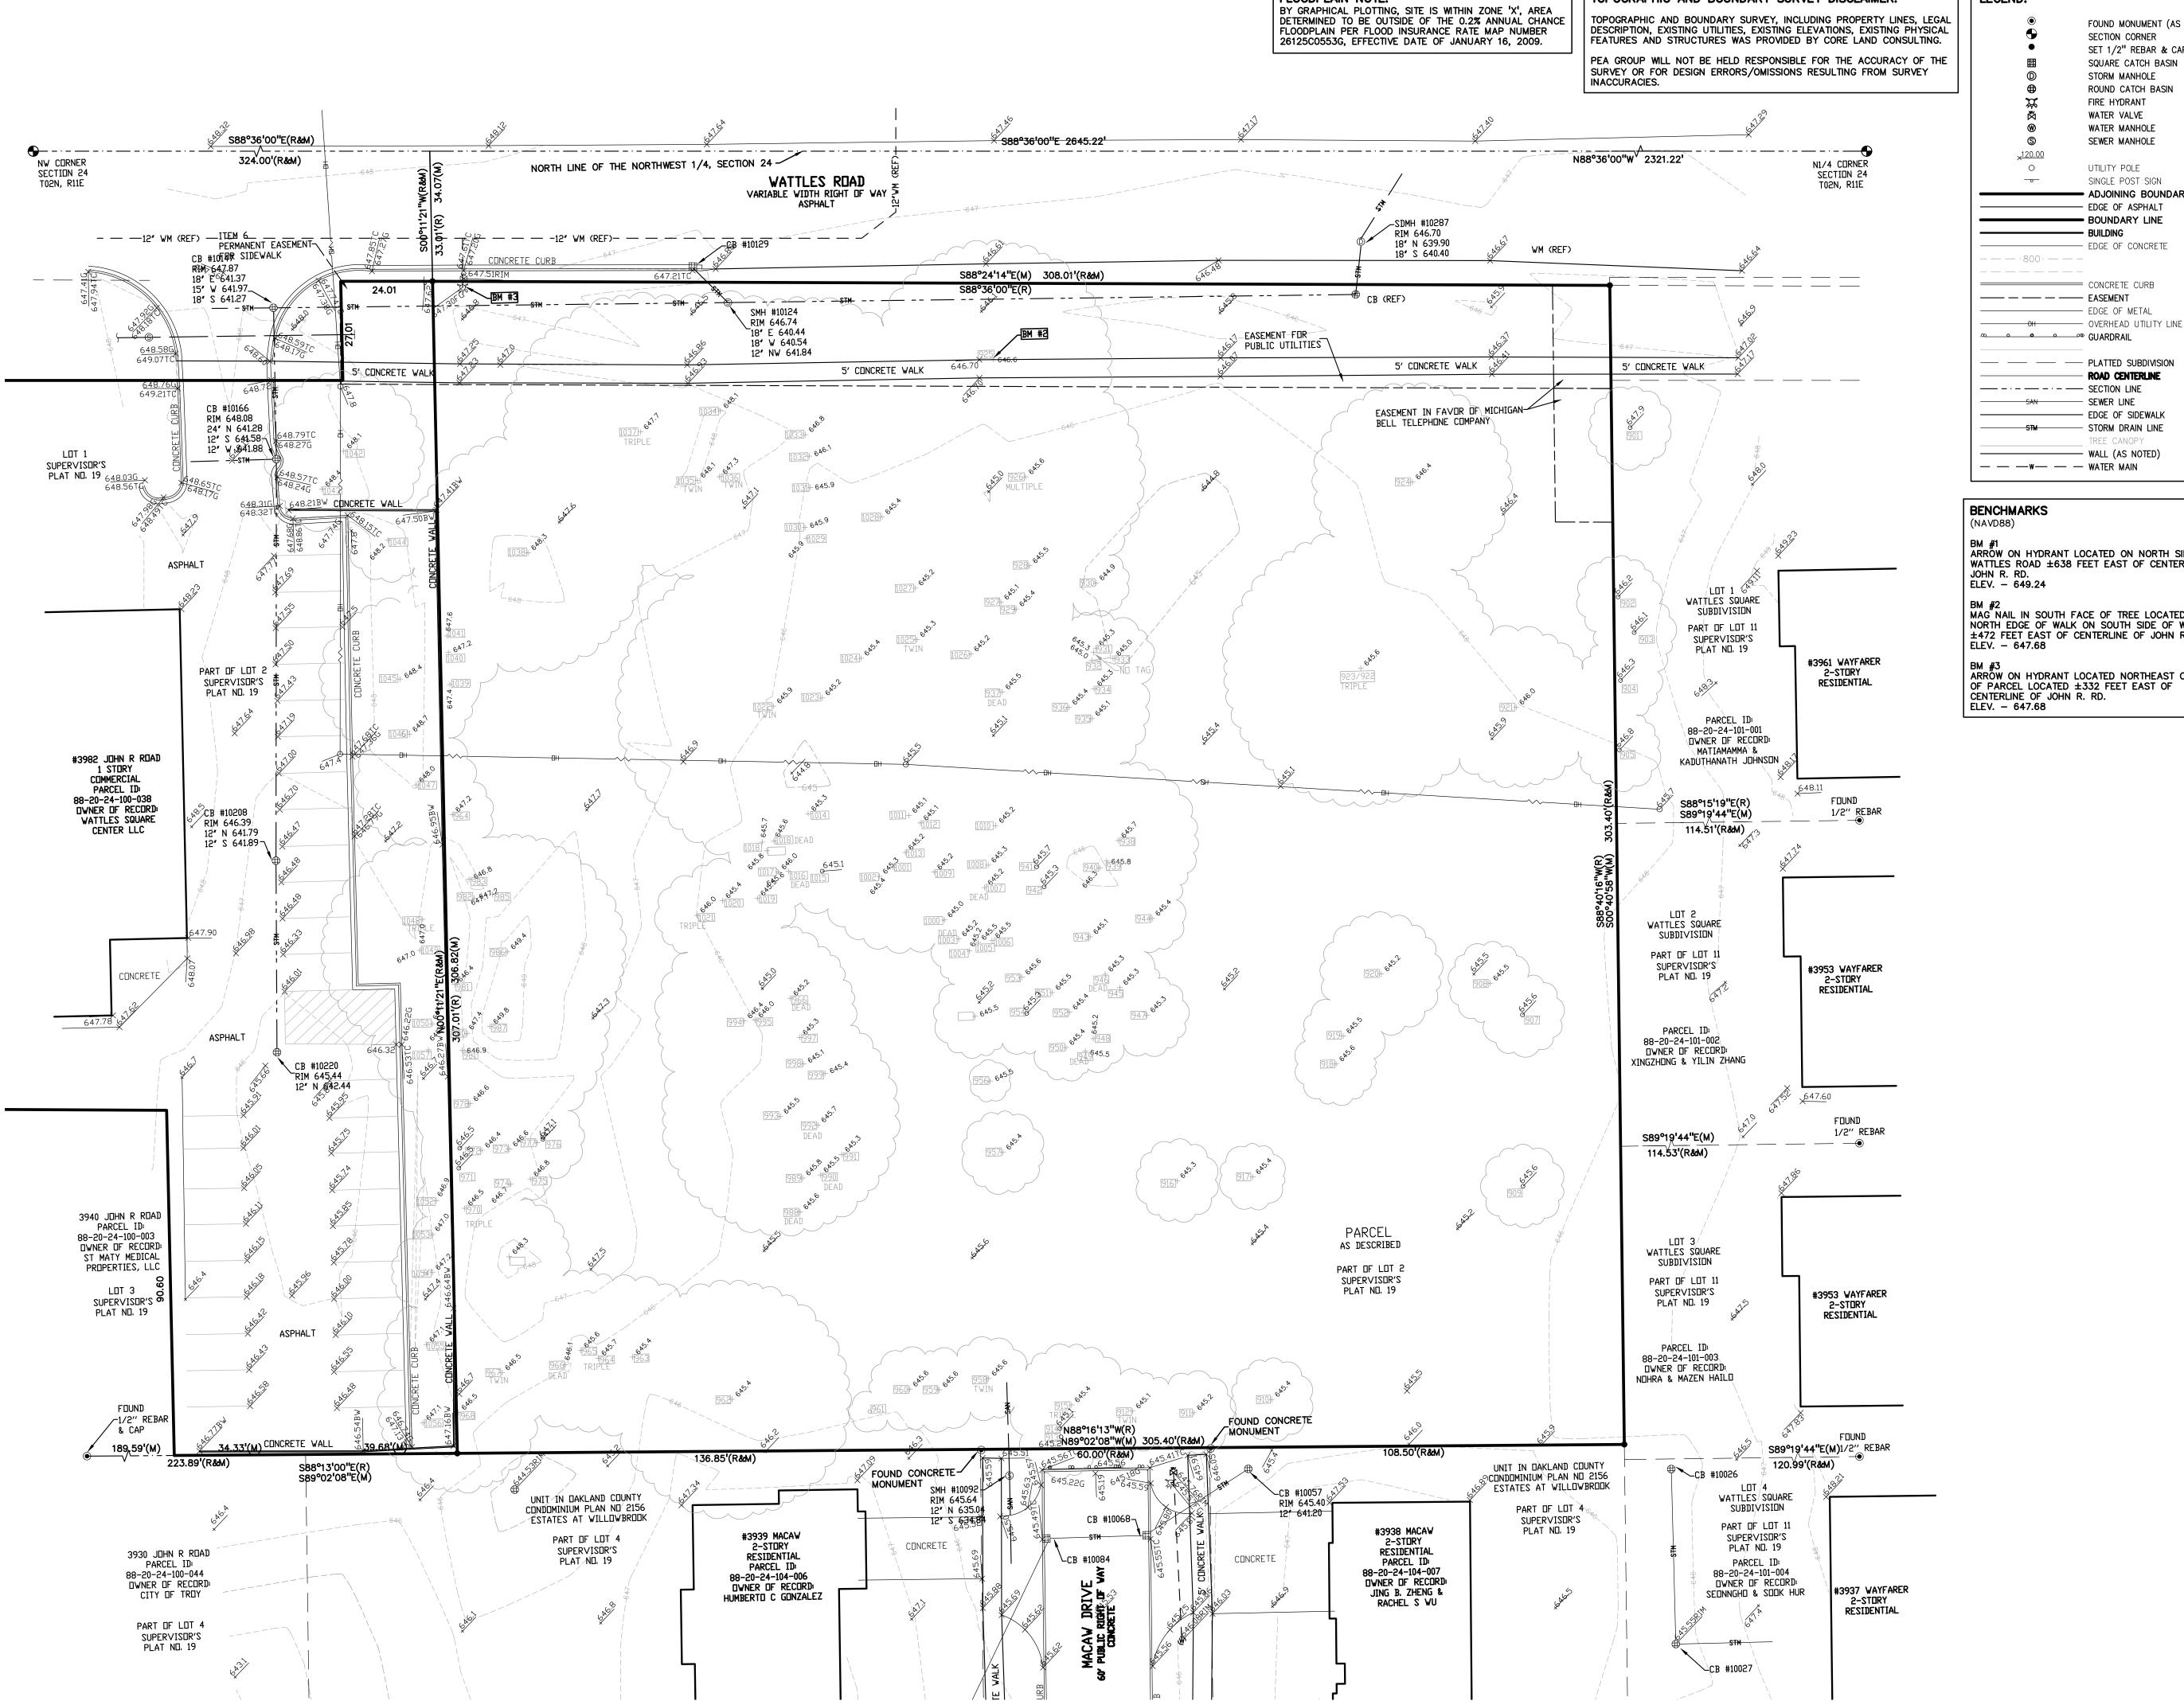


FLOODPLAIN NOTE:

GROUP t: 844.813.2949 www.peagroup.com



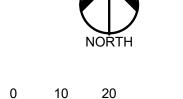

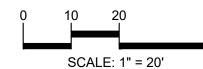

BENCHMARKS (NAVD88)

LEGEND:

×120.00

FOUND MONUMENT (AS NOTED)

SECTION CORNER

STORM MANHOLE

WATER MANHOLE

SEWER MANHOLE

SINGLE POST SIGN

- EDGE OF ASPHALT

BOUNDARY LINE

— EDGE OF CONCRETE

CONCRETE CURB

— EDGE OF METAL

ROAD CENTERLINE

— EDGE OF SIDEWALK

TREE CANOPY

---- WALL (AS NOTED)

- BUILDING

ADJOINING BOUNDARY LINE

UTILITY POLE

SET 1/2" REBAR & CAP

SQUARE CATCH BASIN

ROUND CATCH BASIN FIRE HYDRANT WATER VALVE

TOPOGRAPHIC AND BOUNDARY SURVEY DISCLAIMER:

ARROW ON HYDRANT LOCATED ON NORTH SIDE OF WATTLES ROAD ±638 FEET EAST OF CENTERLINE OF JOHN R. RD. ELEV. – 649.24

STORM DRAIN LINE

MAG NAIL IN SOUTH FACE OF TREE LOCATED ON NORTH EDGE OF WALK ON SOUTH SIDE OF WATTLES ±472 FEET EAST OF CENTERLINE OF JOHN R. RD. ELEV. — 647.68

BM #3
ARROW ON HYDRANT LOCATED NORTHEAST CORNER
OF PARCEL LOCATED ±332 FEET EAST OF
CENTERLINE OF JOHN R. RD.
ELEV. – 647.68

CAUTION!! THE LOCATIONS AND ELEVATIONS OF EXISTING UND JTILITIES AS SHOWN ON THIS DRAWING ARE ONLY UTILLITIES AS SHOWN ON THIS DRAWING ARE ONLY APPROXIMATE. NO GUARANTEE IS EITHER EXPRESSED OR IMPLIED AS TO THE COMPLETENESS OR ACCURACY THEREOF. THE CONTRACTOR SHALL BE EXCLUSIVELY RESPONSIBLE FOR DETERMINING THE EXACT UTILITY LOCATIONS AND ELEVATIONS PRIOR TO THE START OF CONSTRUCTION. LOCATION MAP

LSITE

CLIENT

CONSTRUCTION, INC. 2150 FRANKLIN ROAD BLOOMFIELD HILLS, MI 48302

PROJECT TITLE


WATTLES SQUARE APARTMENTS E. WATTLES RD. & JOHN R. RD. TROY, MI 48083

REVISIONS	
CITY COMMENTS	11/15/23
SITE PLAN APPROVAL	12/5/23
CITY COMMENTS	3/6/24
CITY COMMENTS	6/3/24
ORIGINAL ISSUE DATE:	
SEPTEMBER 22, 2023	

DRAWING TITLE **TOPOGRAPHIC**

SURVEY

PEA JOB NO.	22-1309
P.M.	GMB
DN.	KRD
DES.	KRD
DRAWING NUMBER:	

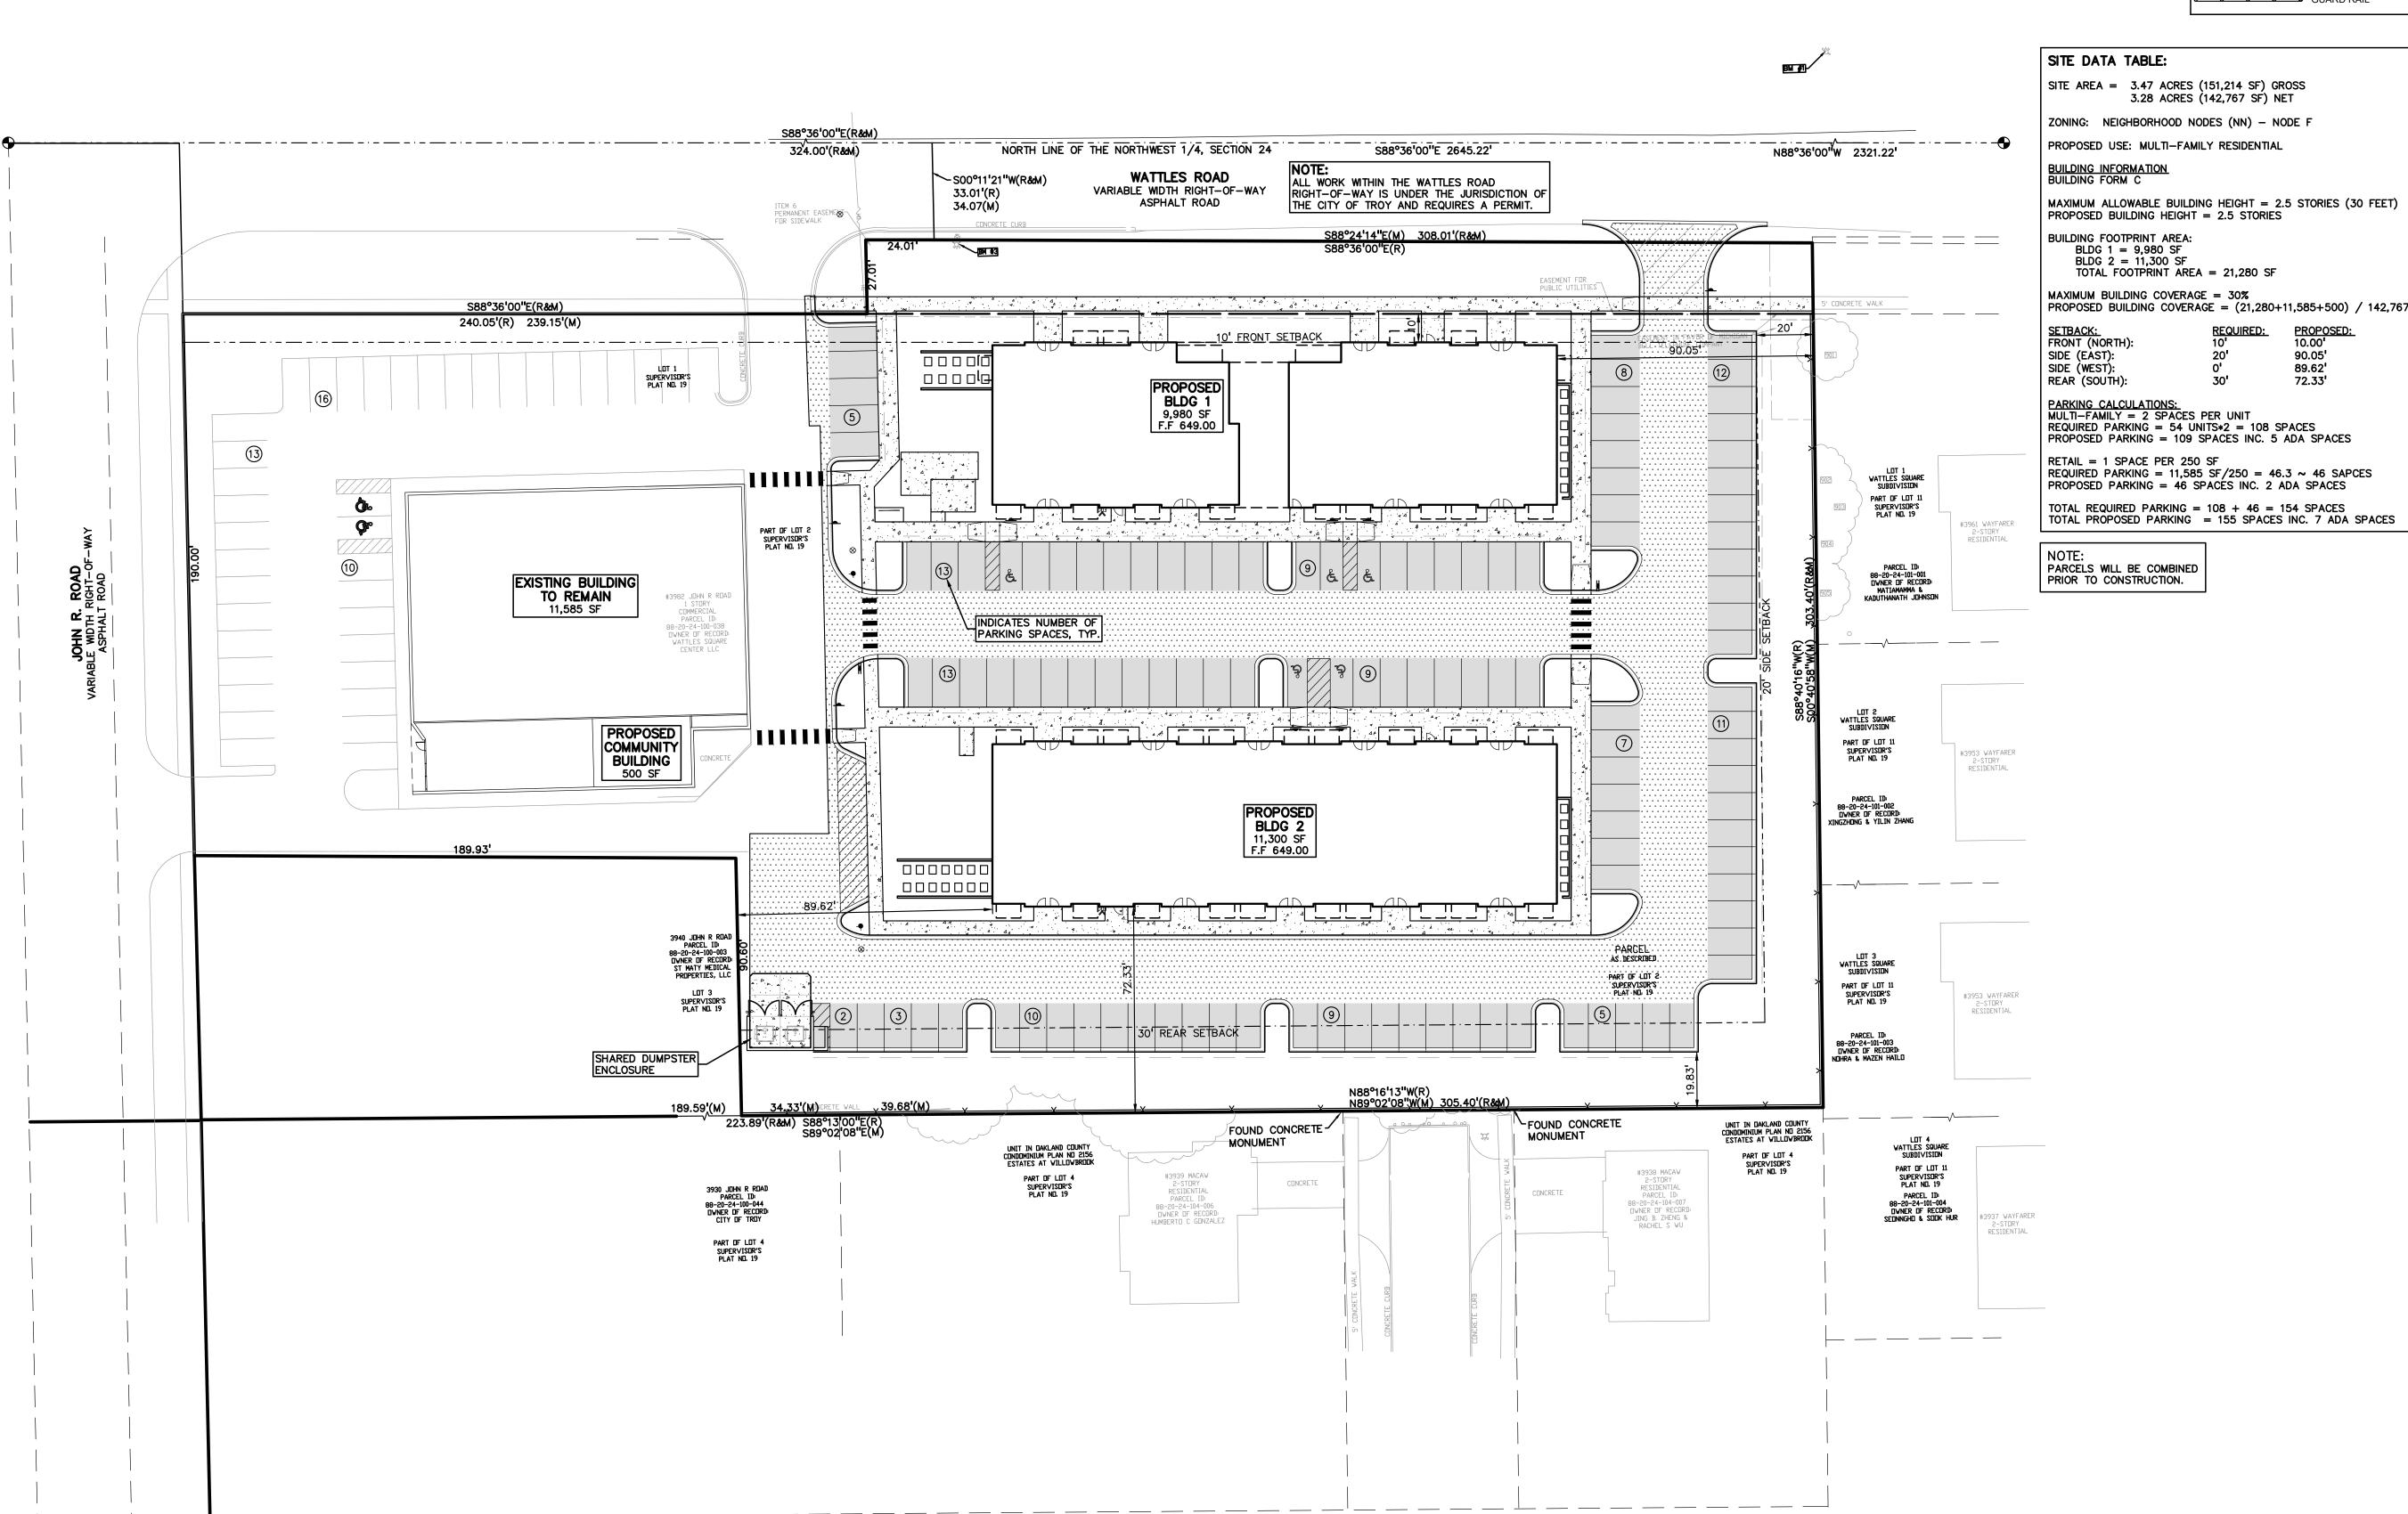

LEGEND: CONCRETE PAVEMENT STD HEAVY DEEP DUTY DUTY STRENGTH GRAVEL ™ ™ ™ WETLAND CONCRETE CURB AND GUTTER REVERSE GUTTER PAN — - · - — - · - — SETBACK LINE LIGHTPOLE —————— FENCE GUARD RAIL

MICHAEL

GROUP

t: 844.813.2949 www.peagroup.com

SCALE: 1" = 30'

MAXIMUM BUILDING COVERAGE = 30% PROPOSED BUILDING COVERAGE = (21,280+11,585+500) / 142,767 = 23.4%

90.05 89.62'

72.33' PARKING CALCULATIONS:
MULTI-FAMILY = 2 SPACES PER UNIT
REQUIRED PARKING = 54 UNITS*2 = 108 SPACES
PROPOSED PARKING = 109 SPACES INC. 5 ADA SPACES

RETAIL = 1 SPACE PER 250 SF REQUIRED PARKING = 11,585 SF/250 = 46.3 ~ 46 SAPCES PROPOSED PARKING = 46 SPACES INC. 2 ADA SPACES

CAUTION!! THE LOCATIONS AND ELEVATIONS OF EXISTING UNDERGROUND UTILITIES AS SHOWN ON THIS DRAWING ARE ONLY APPROXIMATE. NO GUARANTEE IS EITHER EXPRESSED OR IMPLIED AS TO THE COMPLETENESS OR ACCURACY THEREOF. THE CONTRACTOR SHALL BE EXCLUSIVELY RESPONSIBLE FOR DETERMINION THE EXACT UTILITY LOCATIONS AND ELEVATIONS PRIOR TO THE START OF CONSTRUCTION.

LOCATION MAP **L**SITE

CLIENT

CONSTRUCTION, INC. 2150 FRANKLIN ROAD BLOOMFIELD HILLS, MI 48302

PROJECT TITLE

WATTLES SQUARE APARTMENTS E. WATTLES RD. & JOHN R. RD.


REVISIONS CITY COMMENTS 12/5/23 SITE PLAN APPROVAL CITY COMMENTS 3/6/24 CITY COMMENTS

SEPTEMBER 22, 2023 DRAWING TITLE

ORIGINAL ISSUE DATE:


OVERALL SITE PLAN

22-1309 PEA JOB NO. GMB KRD KRD DRAWING NUMBER:

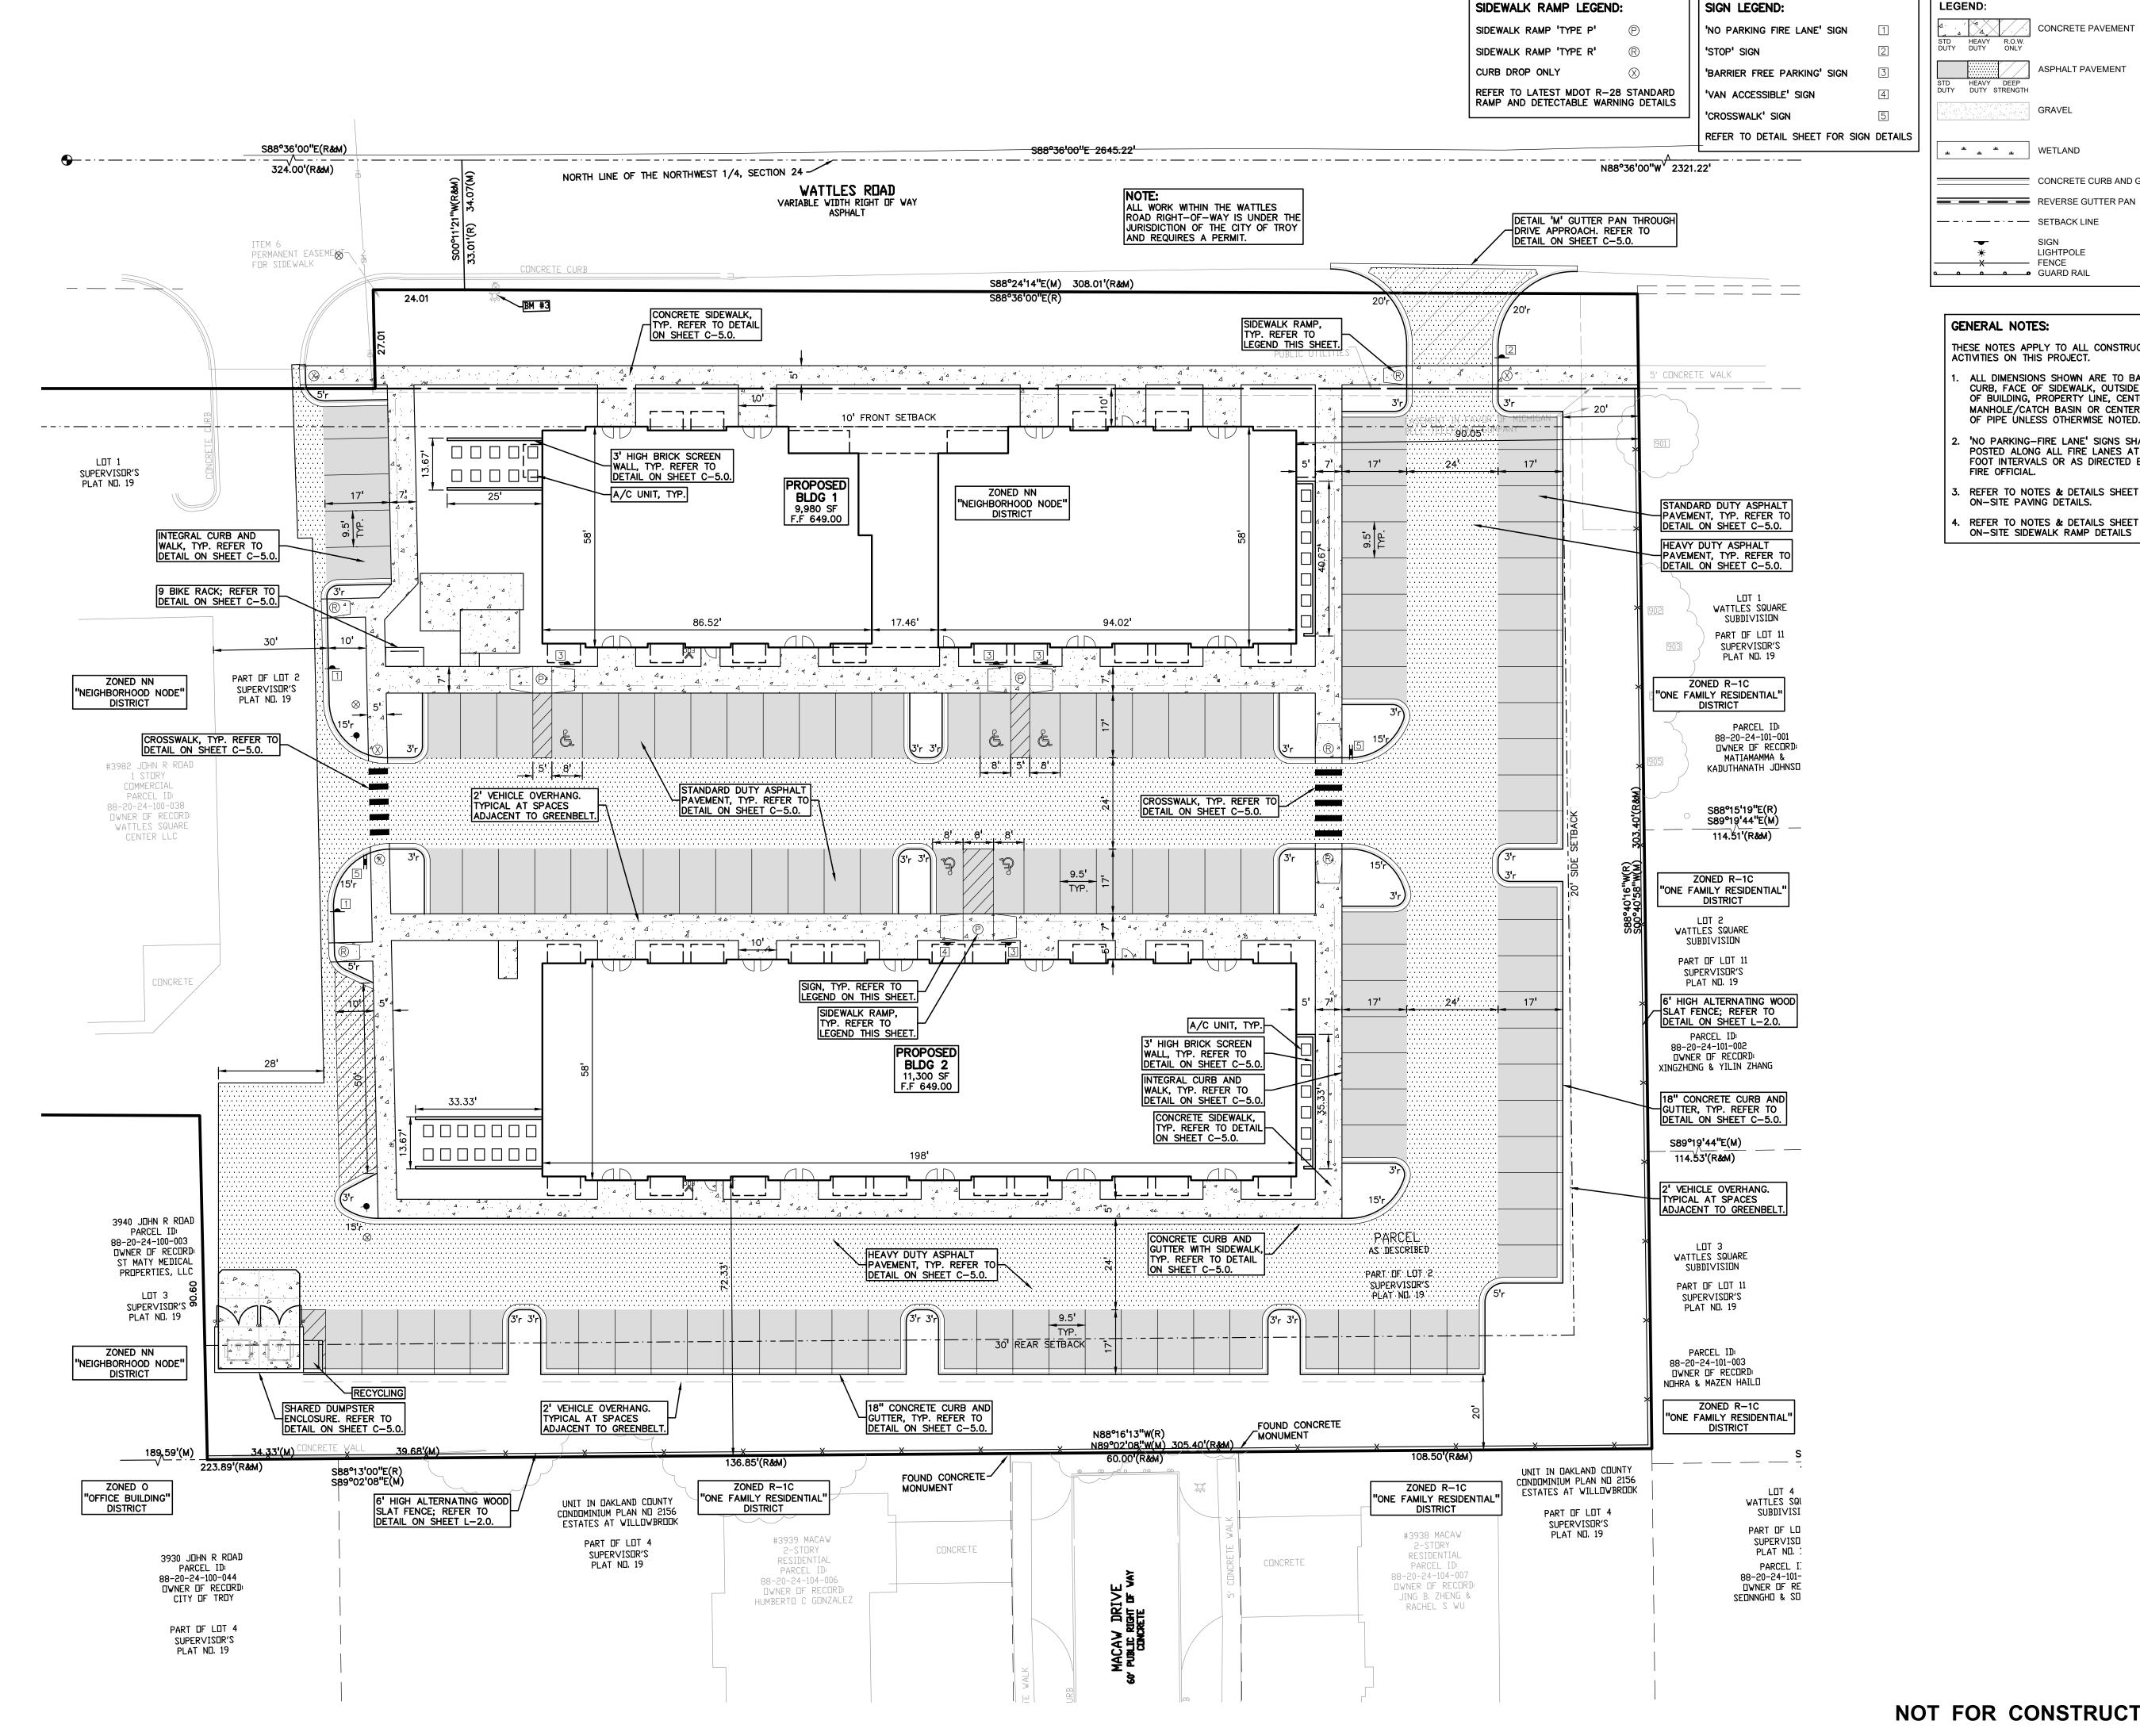

CONCRETE PAVEMENT ASPHALT PAVEMENT STD HEAVY DEEP DUTY DUTY STRENGTH **GRAVEL** t: 844.813.2949 www.peagroup.com



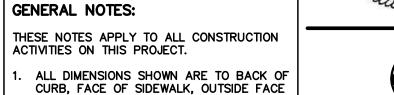

OF PIPE UNLESS OTHERWISE NOTED. 2. 'NO PARKING-FIRE LANE' SIGNS SHALL BE POSTED ALONG ALL FIRE LANES AT 100 FOOT INTERVALS OR AS DIRECTED BY THE

FIRE OFFICIAL. . REFER TO NOTES & DETAILS SHEET FOR ON-SITE PAVING DETAILS.

w w w w WETLAND

—————— FENCE

CONCRETE CURB AND GUTTER

LIGHTPOLE

OF BUILDING, PROPERTY LINE, CENTER OF MANHOLE/CATCH BASIN OR CENTERLINE

. REFER TO NOTES & DETAILS SHEET FOR ON-SITE SIDEWALK RAMP DETAILS




SCALE: 1" = 20'



CAUTION!!

OTHER AS SHOWN ON THIS DRAWING ARE ONLY
APPROXIMATE. NO GUARANTEE IS EITHER EXPRESSED OR
IMPLIED AS TO THE COMPLETENESS OR ACCURACY THEREOF.
THE CONTRACTOR SHALL BE EXCLUSIVELY RESPONSIBLE FOR DETERMINING THE EXACT UTILITY LOCATIONS AND ELEVATIONS PRIOR TO THE START OF CONSTRUCTION. LOCATION MAP **L**SITE

THE LOCATIONS AND ELEVATIONS OF EXISTING UNDERGROUND UTILITIES AS SHOWN ON THIS DRAWING ARE ONLY

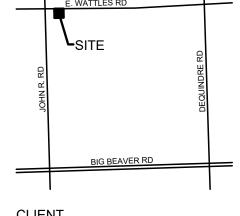

CLIENT CONSTRUCTION, INC.

2150 FRANKLIN ROAD BLOOMFIELD HILLS, MI 48302

PROJECT TITLE

WATTLES SQUARE APARTMENTS E. WATTLES RD. & JOHN R. RD. TROY, MI 48083


REVISIONS	
CITY COMMENTS	11/15/23
SITE PLAN APPROVAL	12/5/23
CITY COMMENTS	3/6/24
CITY COMMENTS	6/3/24
ORIGINAL ISSUE DATE:	
SEPTEMBER 22, 2023	
DRAWING TITLE	

PEA JOB NO. 22-1309

PRELIMINARY

SITE PLAN

GMB KRD DES. KRD DRAWING NUMBER:

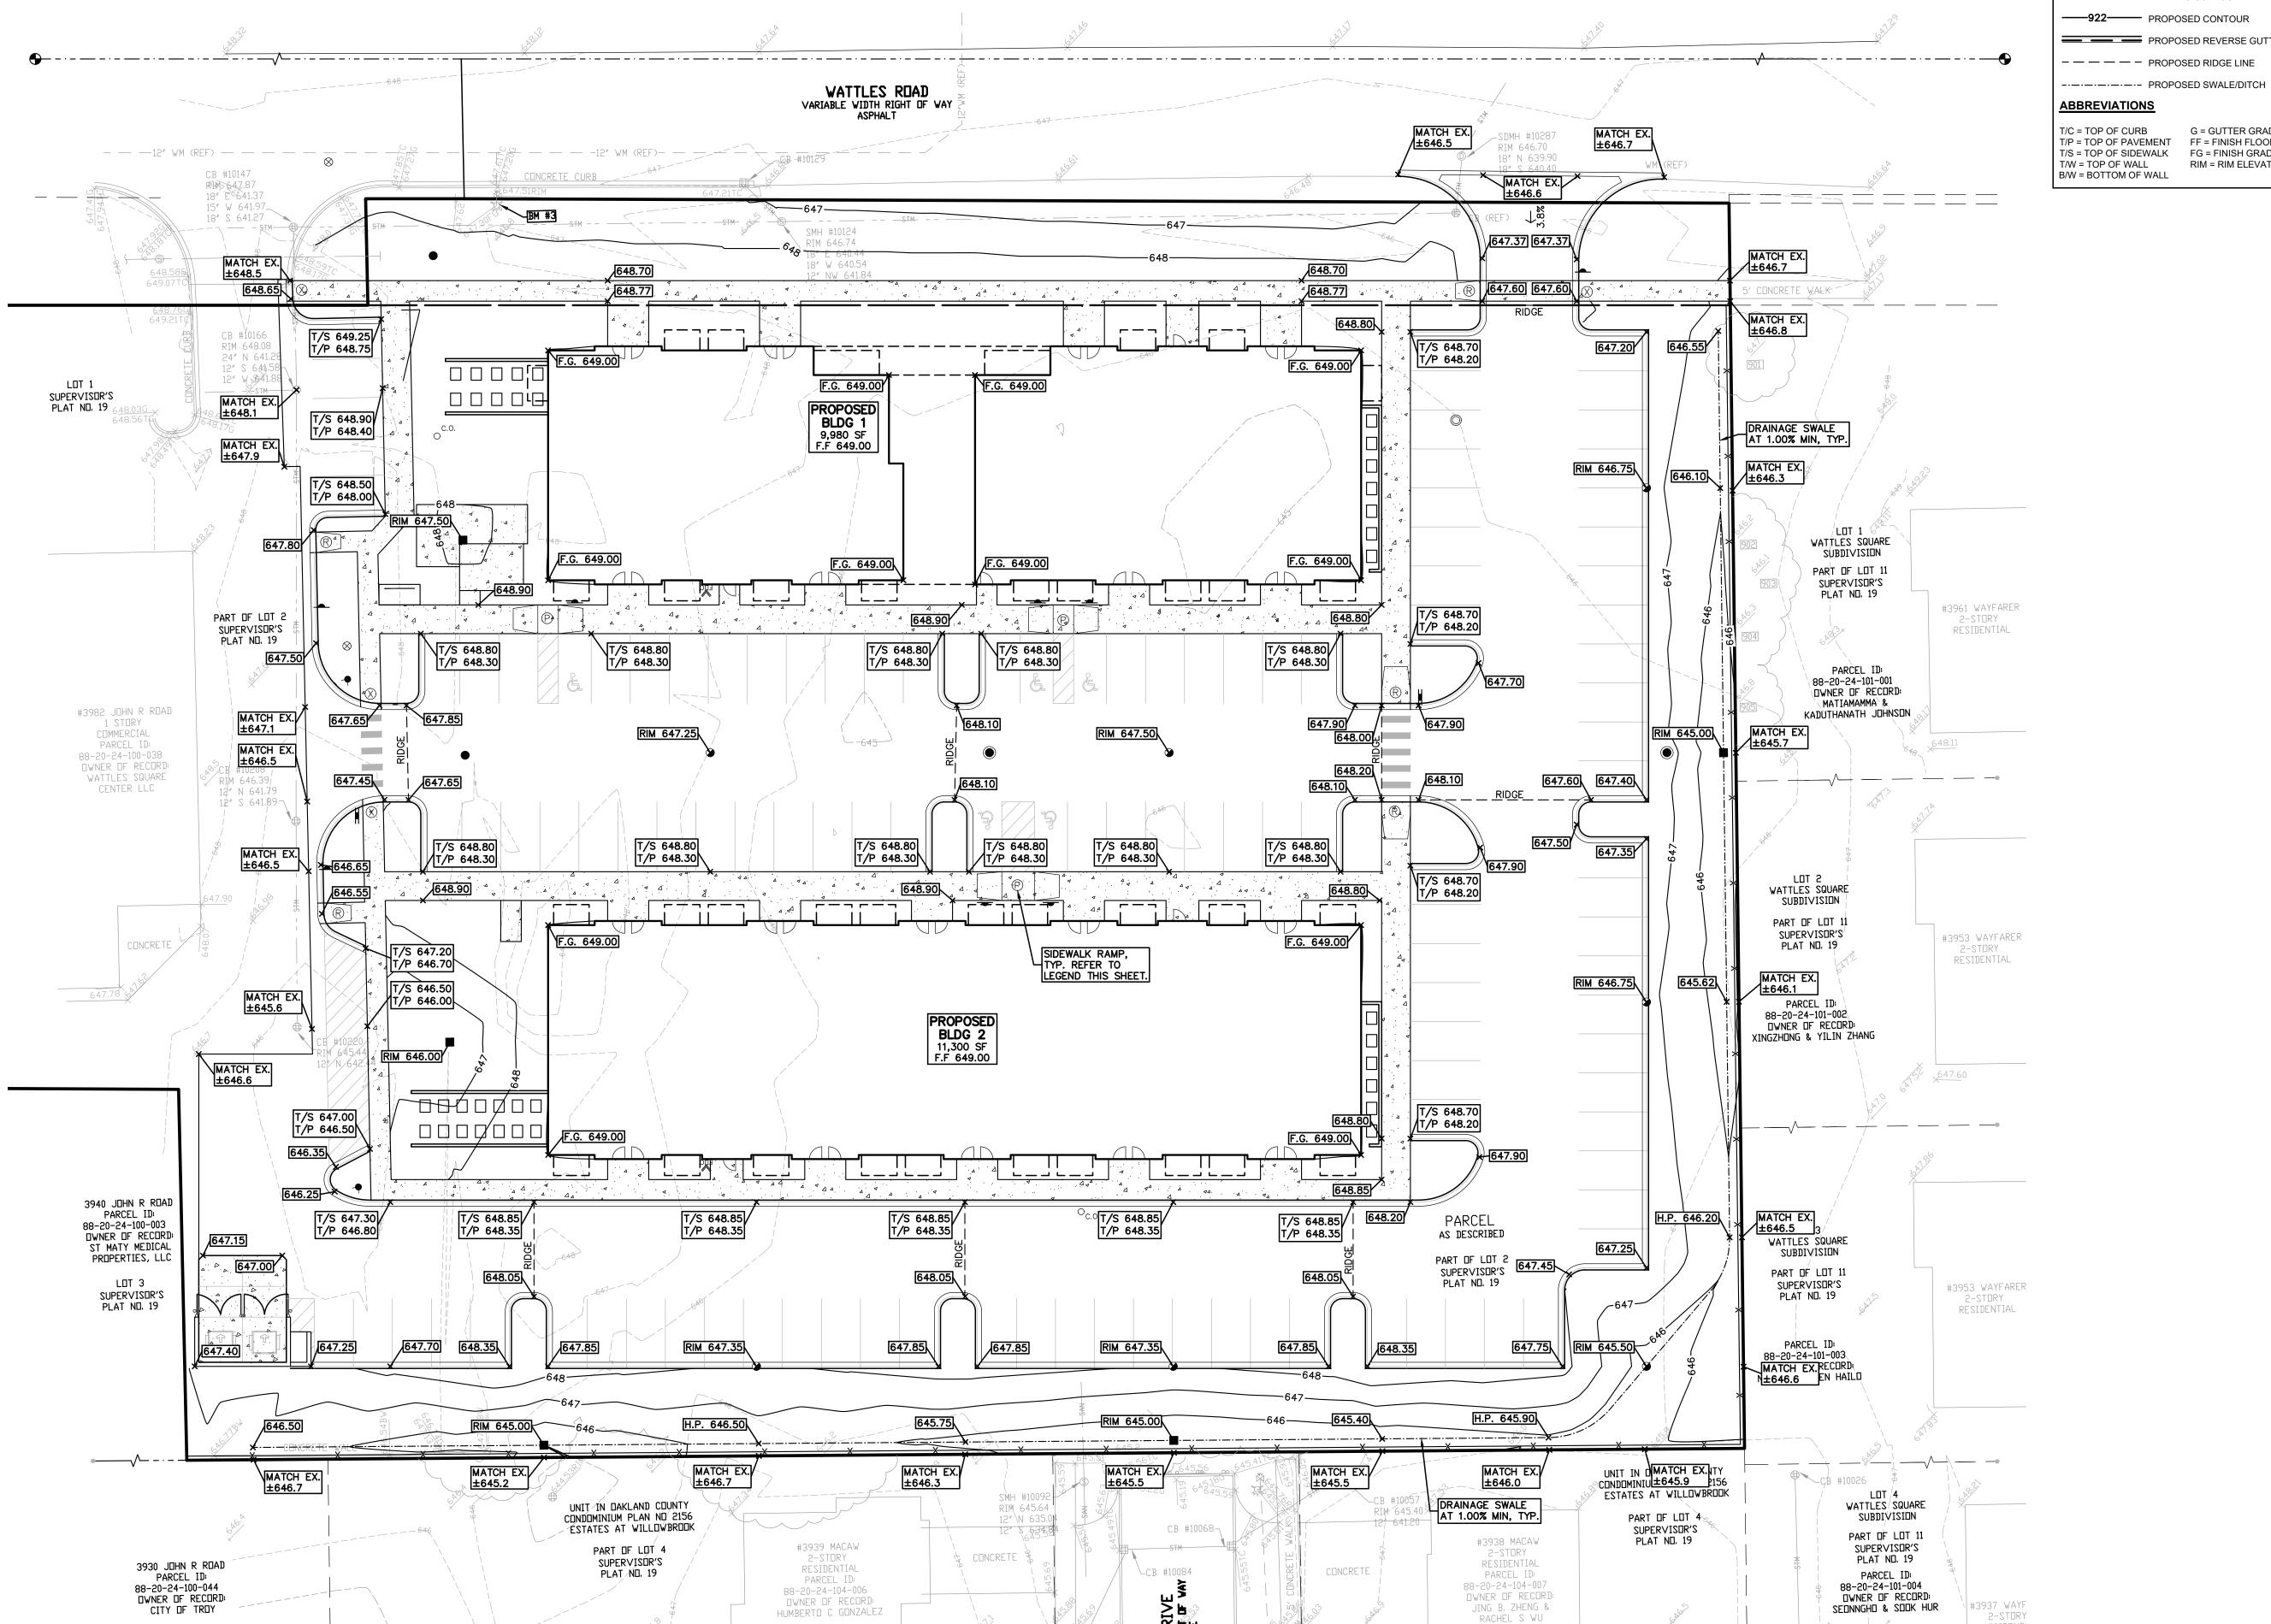

GRADING LEGEND:

EXISTING SPOT ELEVATION PROPOSED SPOT ELEVATION: TYPICALLY TOP OF PAVEMENT IN PAVED AREAS, GUTTER GRADE

IN CURB LINES. EXISTING CONTOUR ——922—— PROPOSED CONTOUR

PROPOSED REVERSE GUTTER PAI ---- PROPOSED RIDGE LINE

ABBREVIATIONS


T/C = TOP OF CURB G = GUTTER GRADE T/P = TOP OF PAVEMENT FF = FINISH FLOOR T/S = TOP OF SIDEWALK FG = FINISH GRADE T/W = TOP OF WALL RIM = RIM ELEVATION B/W = BOTTOM OF WALL

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LOCATION MAP **L**SITE

CONSTRUCTION, INC.

CLIENT

2150 FRANKLIN ROAD

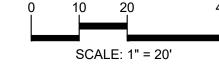BLOOMFIELD HILLS, MI 48302

PROJECT TITLE


WATTLES SQUARE APARTMENTS E. WATTLES RD. & JOHN R. RD. TROY, MI 48083

REVISIONS	
CITY COMMENTS	11/
SITE PLAN APPROVAL	1:
CITY COMMENTS	;
CITY COMMENTS	(
ORIGINAL ISSUE DATE:	
SEPTEMBER 22, 2023	

DRAWING TITLE **PRELIMINARY GRADING PLAN**

PEA JOB NO.	22-1309
P.M.	GMB
DN.	KRD
DES.	KRD
DRAWING NUMBER:	

RESIDENT:

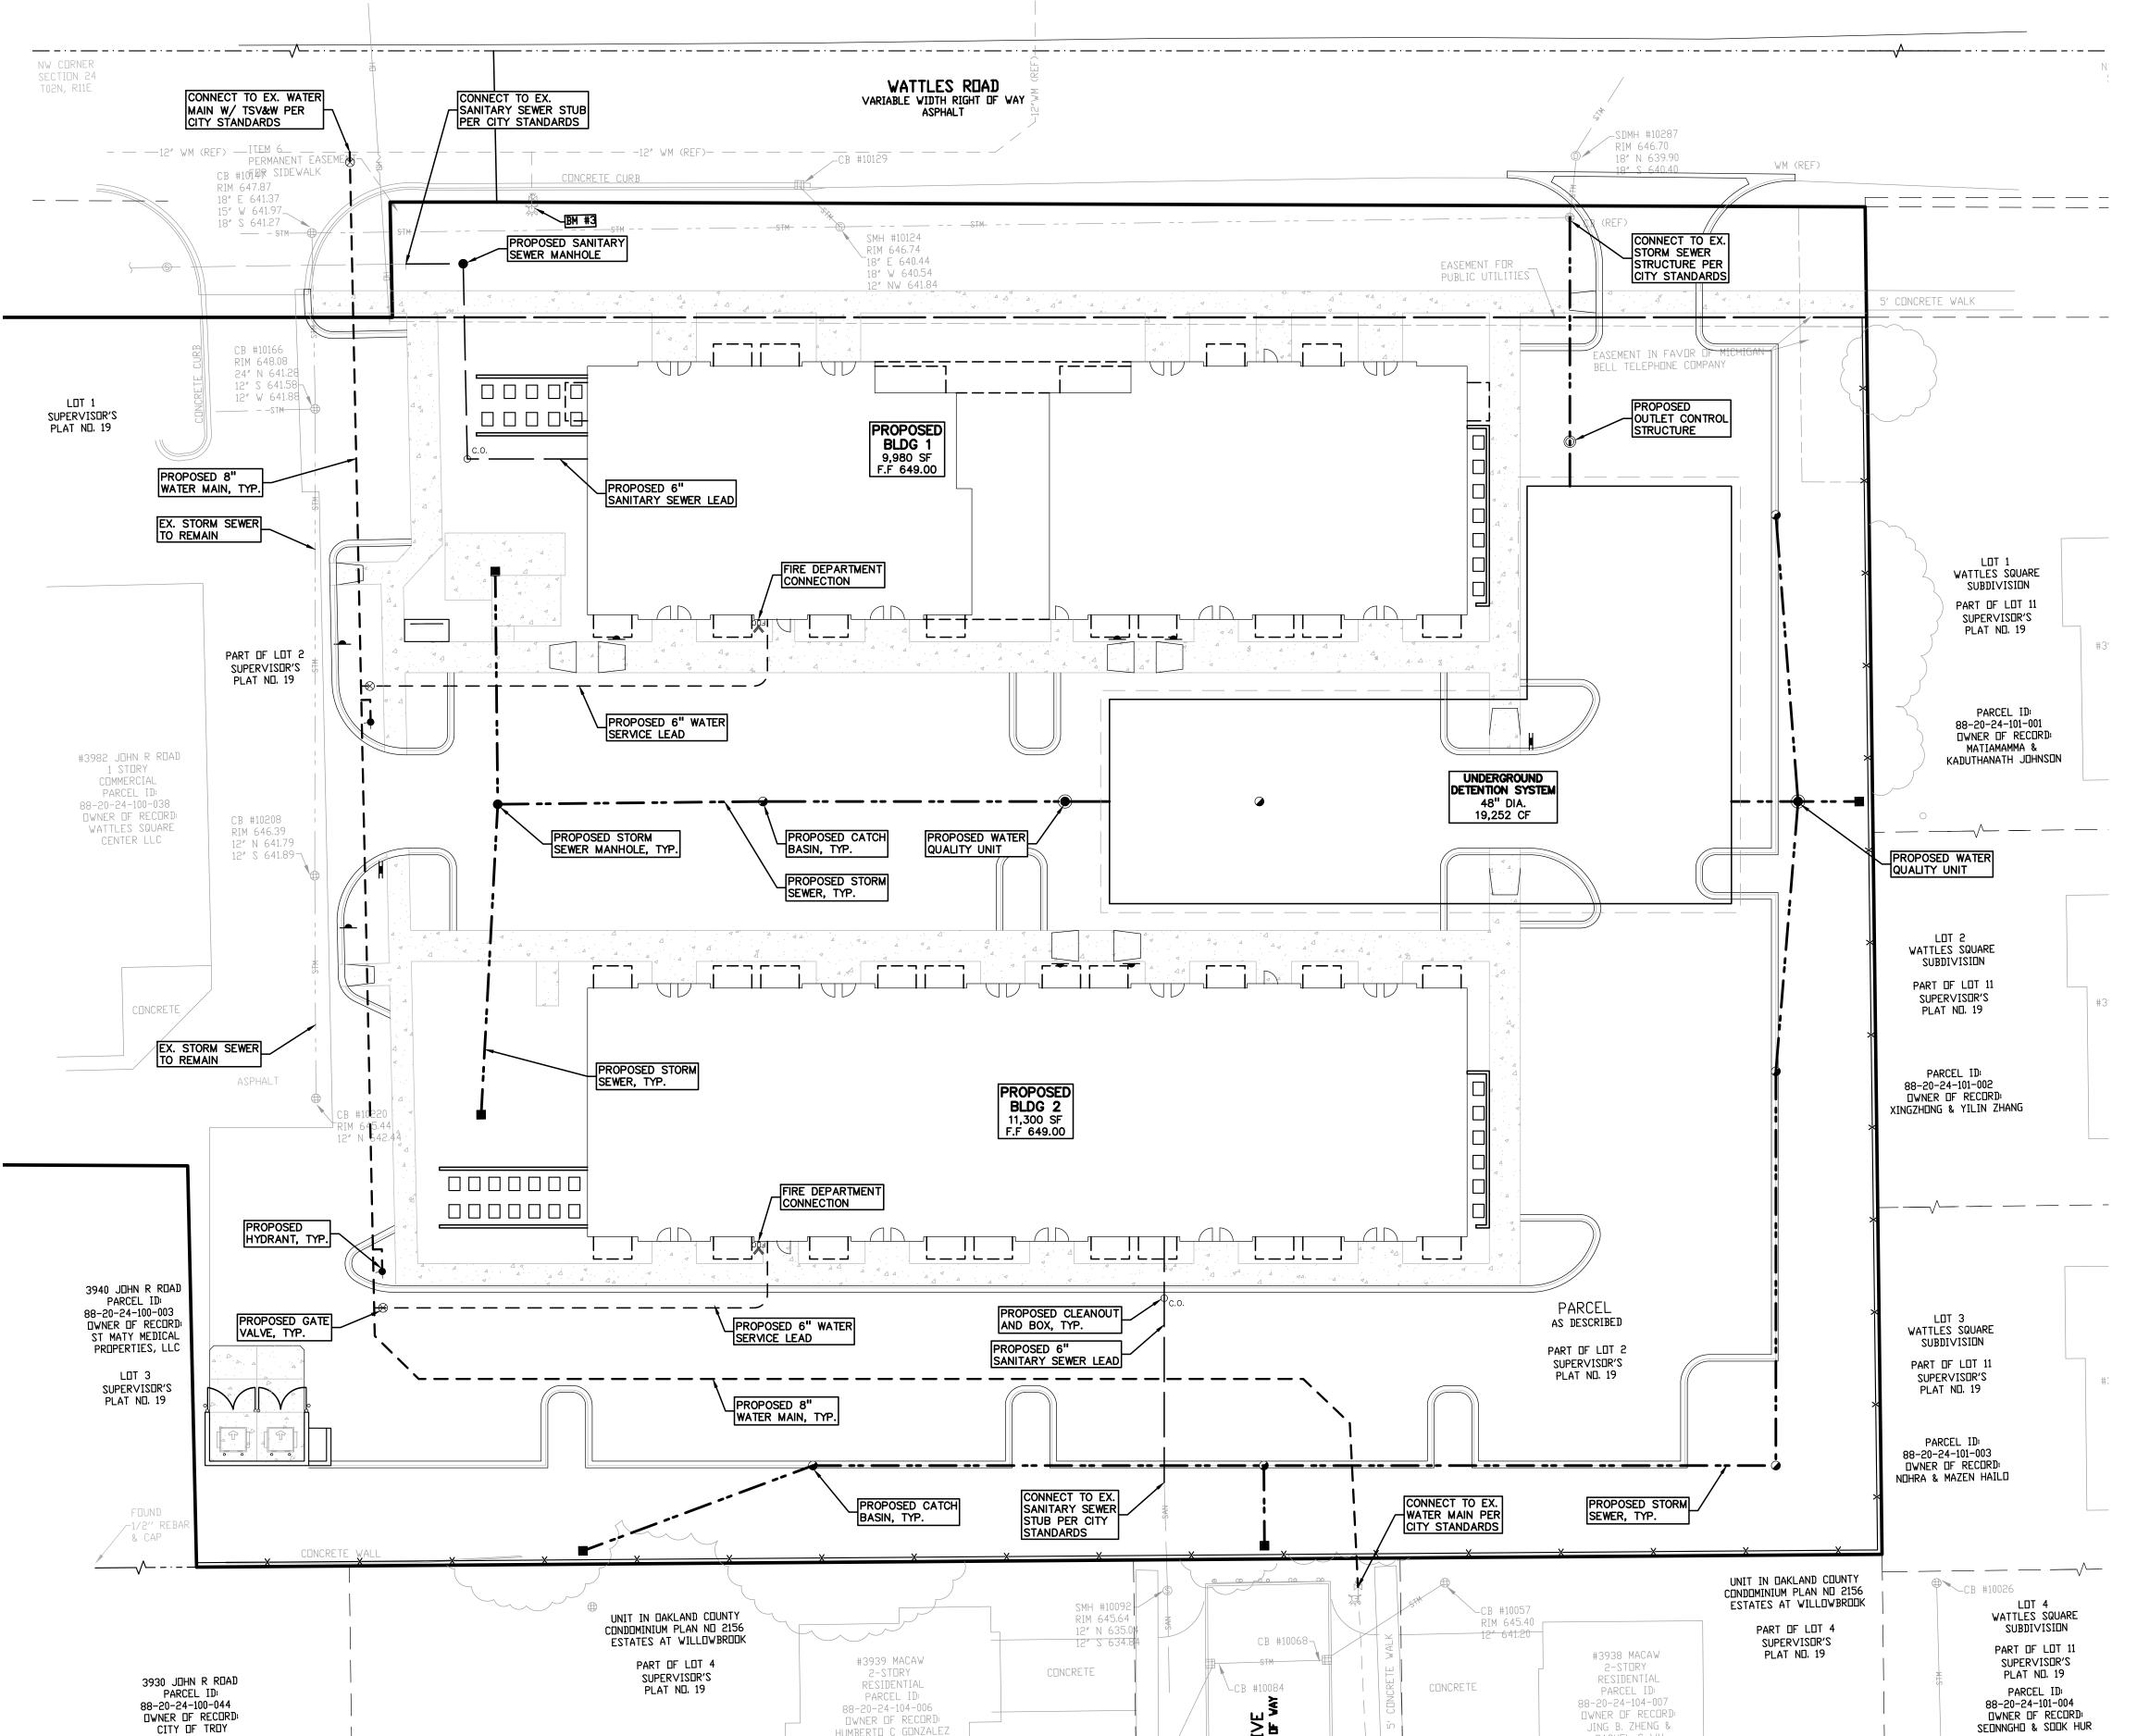

RACHEL S WU

HUMBERTO C GONZALEZ

UTILITY LEGEND:

OH-ELEC-W-O- EX. OH. ELEC, POLE & GUY WIRE UG-CATV-TV-EX. U.G. CABLE TV & PEDESTAL UG-COMM---⊠-T- EX. U.G. COMMUNICATION LINE, PEDESTAL & MANHOL UG-ELEC-®®EX. U.G. ELEC,MANHOLE, METER & HANDHOLE — – — – EX. GAS LINE © GAS EX. GAS VALVE & GAS LINE MARKER EX. TRANSFORMER & IRRIGATION VALVE EX. WATER MAIN EX. HYDRANT, GATE VALVE & POST INDICATOR VALVE EX. WATER VALVE BOX & SHUTOFF EX. SANITARY SEWER EX. COMBINED SEWER MANHOLE ---- EX. STORM SEWER EX. CLEANOUT & MANHOLE EX. SQUARE, ROUND, & BEEHIVE CATCH BASIN EX. YARD DRAIN & ROOF DRAIN

EX. UNIDENTIFIED STRUCTURE

PROPOSED HYDRANT AND GATE VALVE

PROPOSED POST INDICATOR VALVE

O^{C.O.} ● PROPOSED SANITARY CLEANOUT & MANHOLE

PROPOSED CATCH BASIN, INLET & YARD DRAIN

PROPOSED TAPPING SLEEVE, VALVE & WELL

PROPOSED STORM SEWER CLEANOUT & MANHOLE

PROPOSED WATER MAIN

PROPOSED SANITARY SEWER

PROPOSED STORM SEWER



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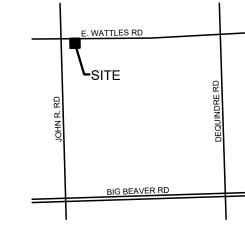






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LOCATION MAP



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CONSTRUCTION, INC. 2150 FRANKLIN ROAD BLOOMFIELD HILLS, MI 48302

PROJECT TITLE


WATTLES SQUARE **APARTMENTS** E. WATTLES RD. & JOHN R. RD. TROY, MI 48083

REVISIONS	
CITY COMMENTS	11/15/23
SITE PLAN APPROVAL	12/5/23
CITY COMMENTS	3/6/24
CITY COMMENTS	6/3/24
	•

ORIGINAL ISSUE DATE: **SEPTEMBER 22, 2023** DRAWING TITLE

PRELIMINARY UTILITY PLAN

PEA JOB NO.	22-1309
P.M.	GMB
DN.	KRD
DES.	KRD
DRAWING NUMBER:	

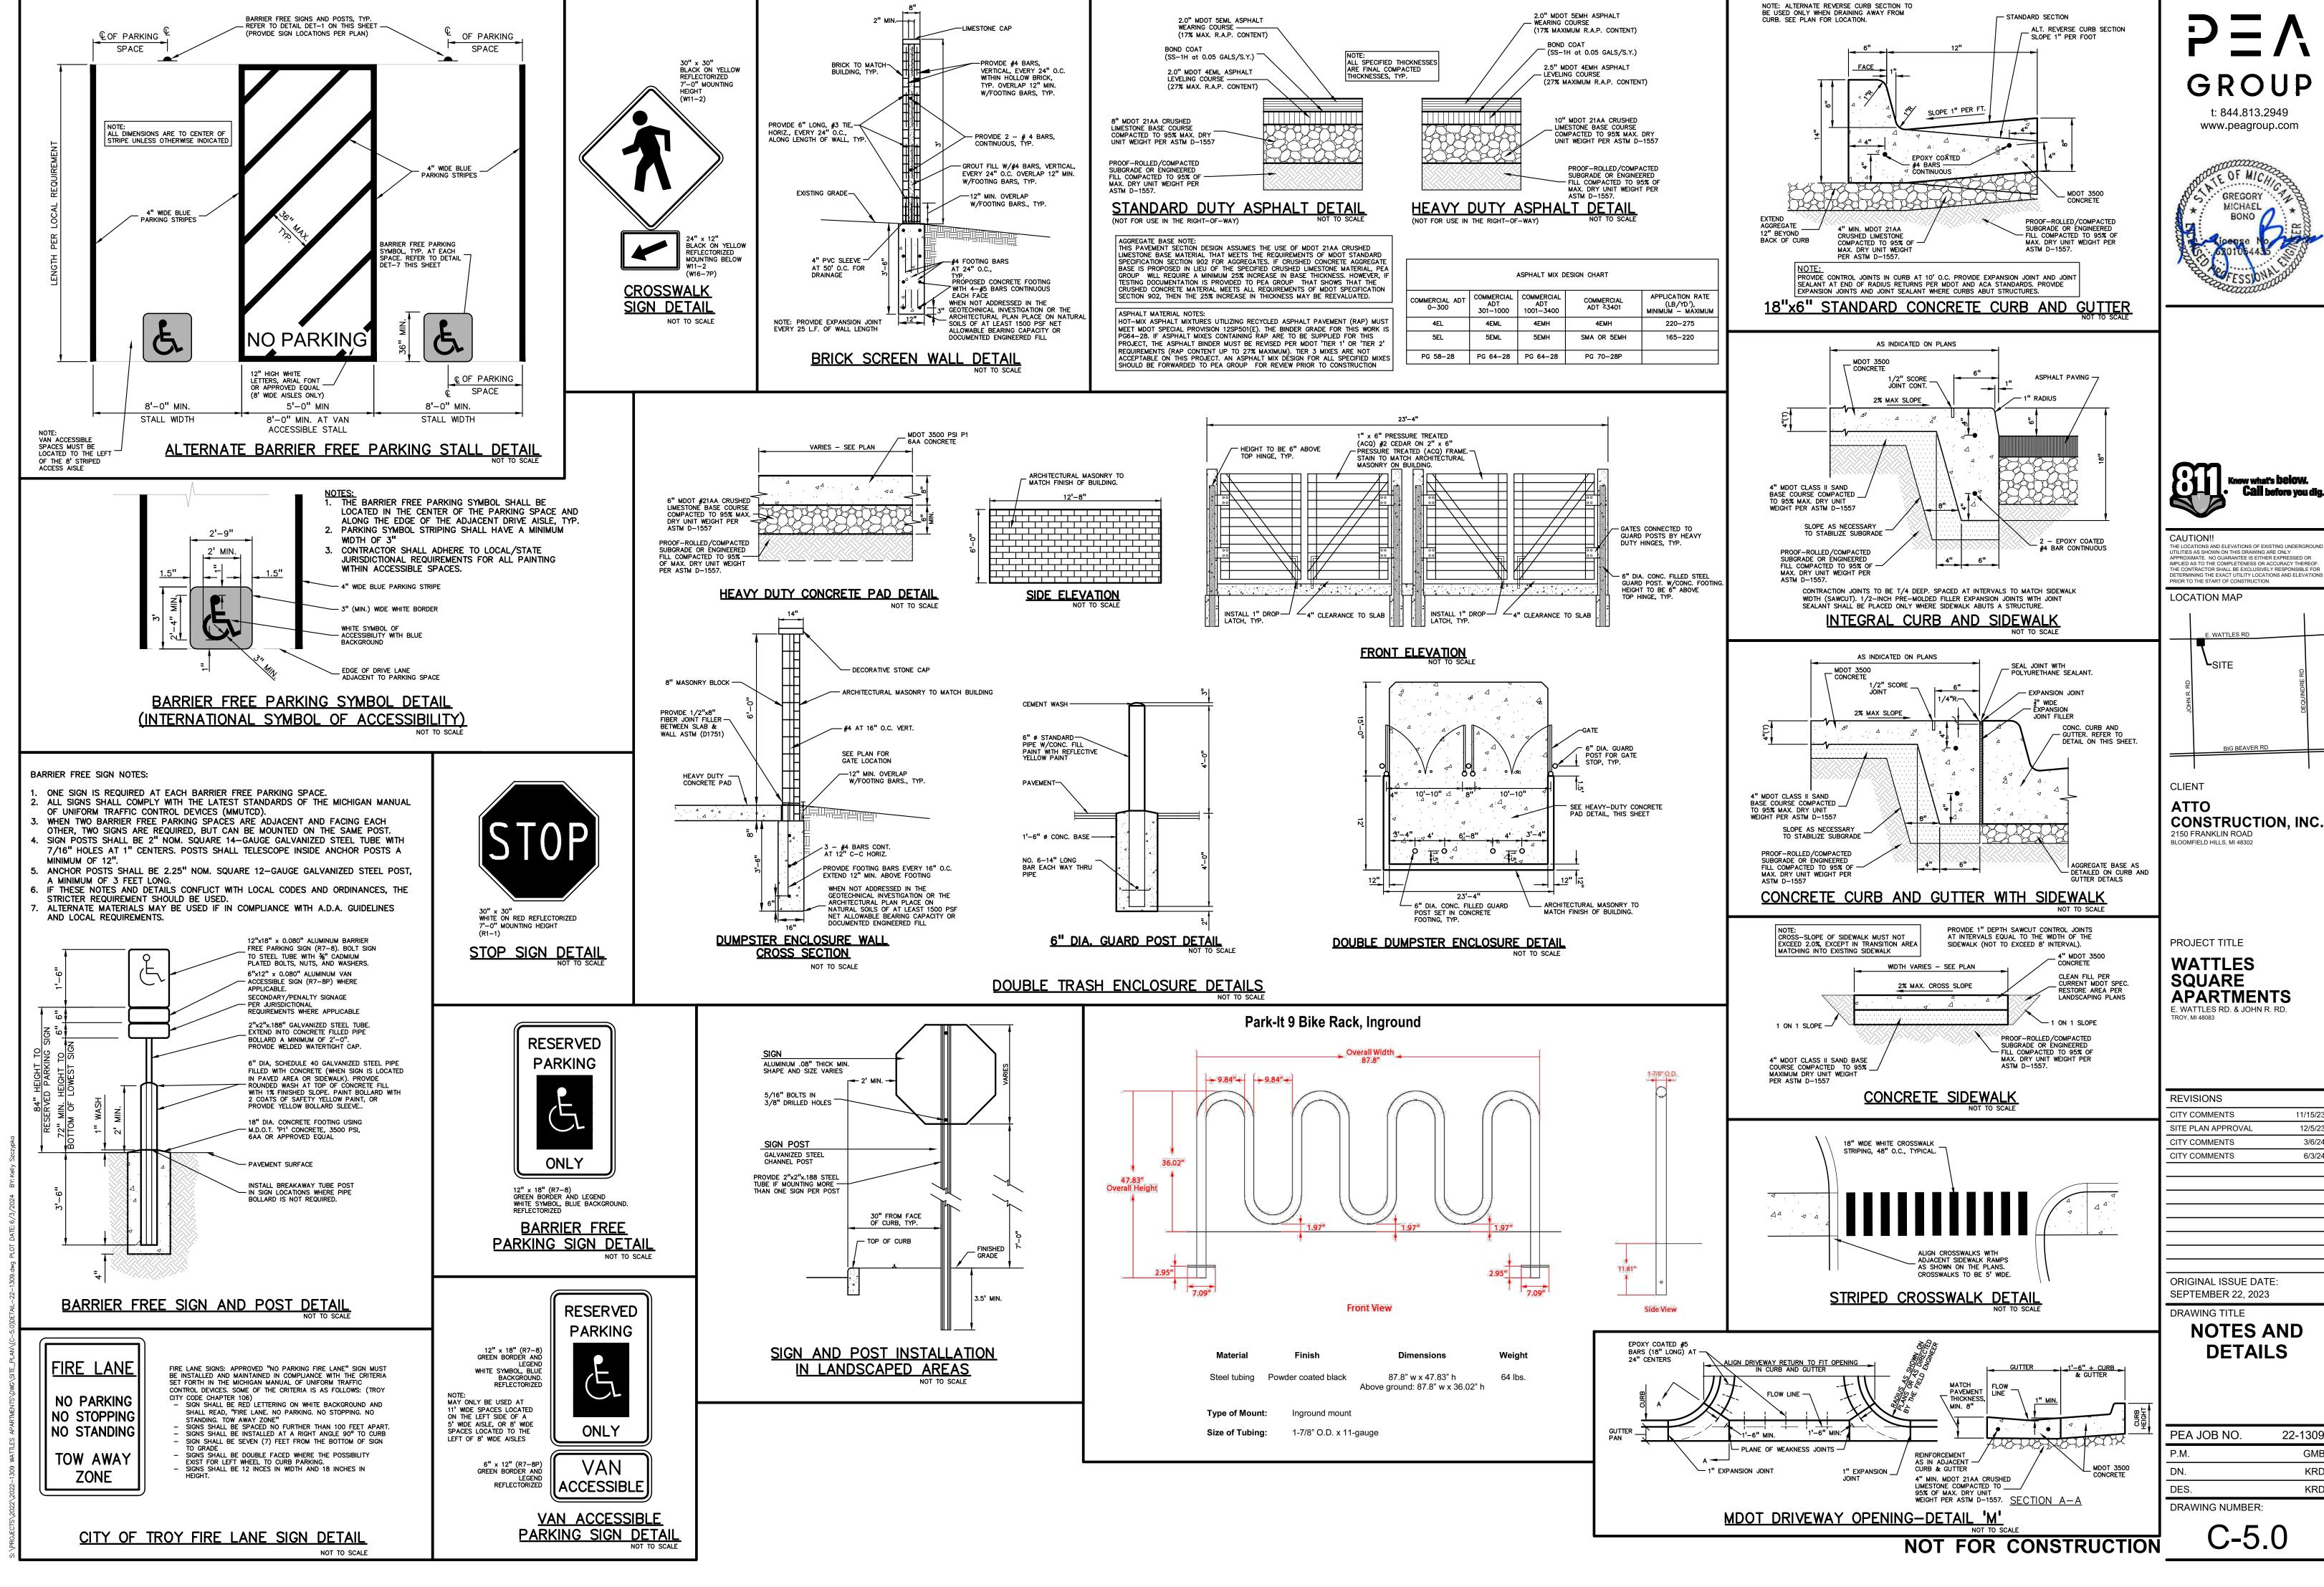







MPLIED AS TO THE COMPLETENESS OR ACCURACY THEREO ETERMINING THE EXACT UTILITY LOCATIONS AND ELEVATION



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CITY COMMENTS	3/6/24
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ORIGINAL ISSUE DATE:	

PEA JOB NO.	22-1309	
P.M.	GMB	
DN.	KRD	
DES.	KRD	
DRAWING NUMBER:		

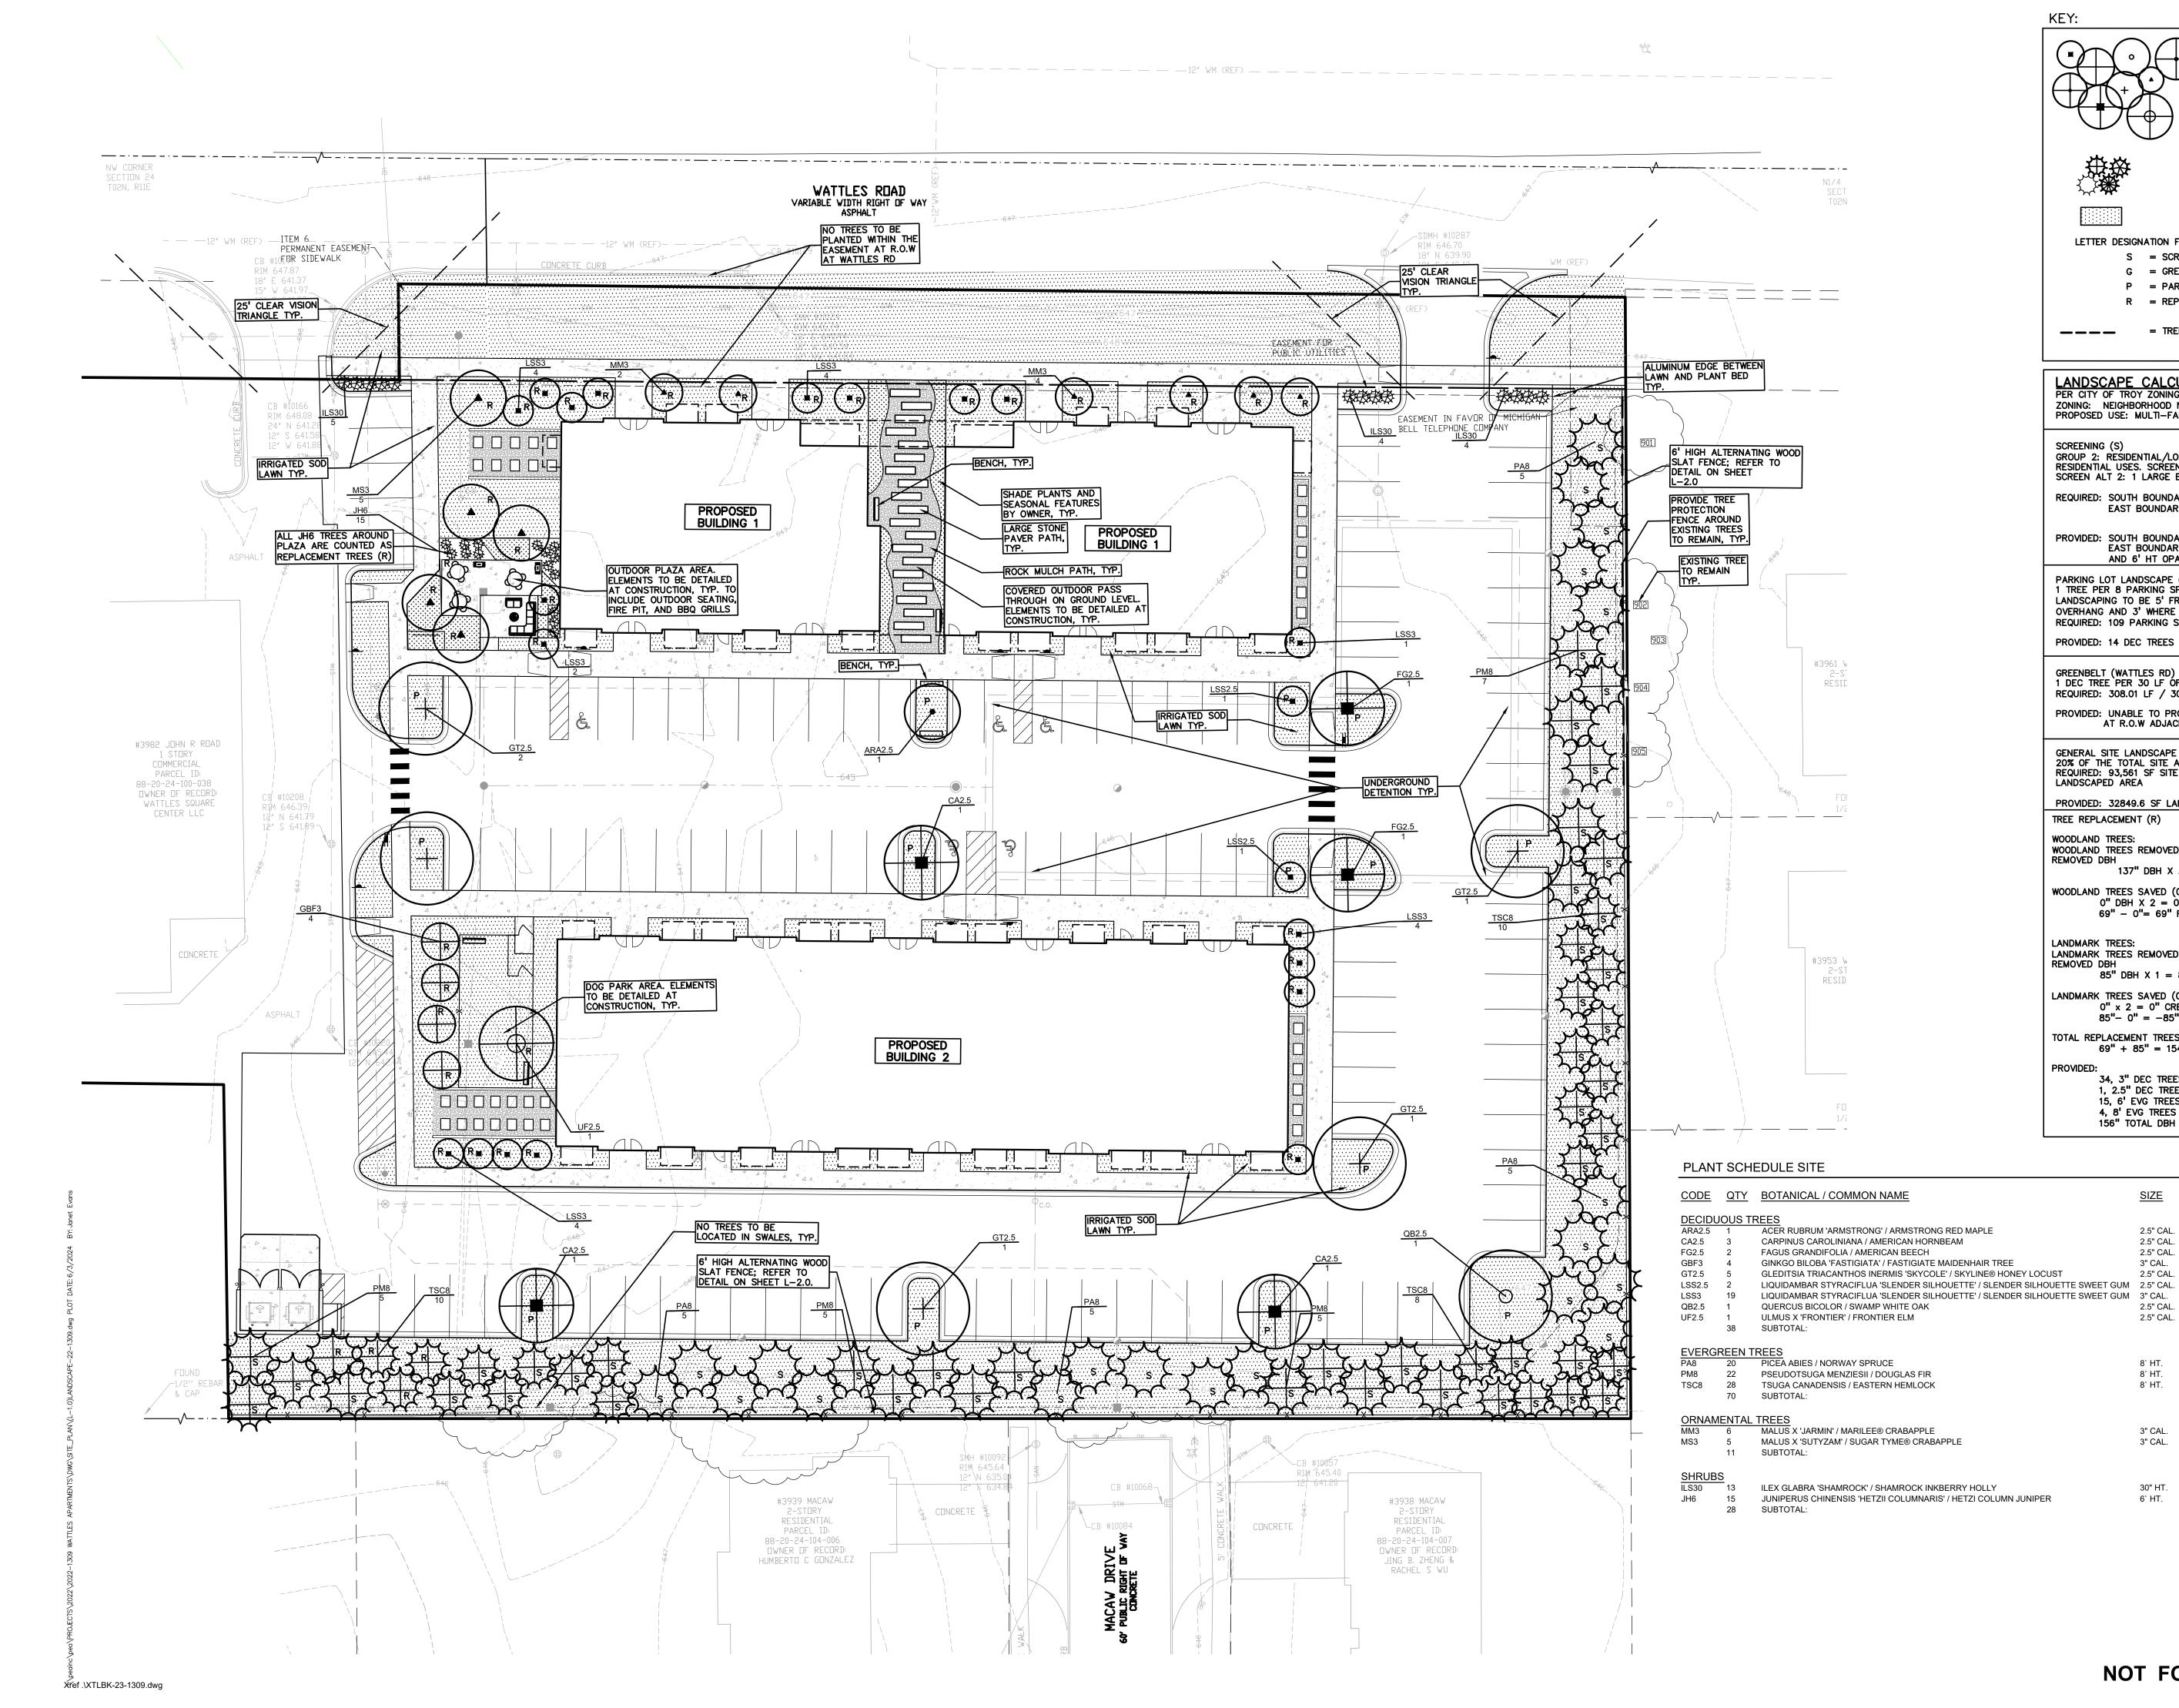

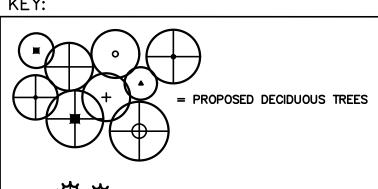



= PROPOSED EVERGREEN TREES



= IRRIGATED SOD LAWN

S = SCREENING LANDSCAPING G = GREENBELT TREES P = PARKING LOT TREES

R = REPLACEMENT TREES

PROPOSED USE: MULTI-FAMILY RESIDENTIAL

SCREENING (S) GROUP 2: RESIDENTIAL/LODGING USES ABUT GROUP 1: RESIDENTIAL USES. SCREEN ALT 1 OR 2 REQUIRED. SCREEN ALT 2: 1 LARGE EVG TREE PER 10LF

REQUIRED: SOUTH BOUNDARY: 379.4 LF / 10 = 38 EVG TREES EAST BOUNDARY: 278LF / 10 = 28 EVG TREE

PROVIDED: SOUTH BOUNDARY: 38 EVG TREES EAST BOUNDARY: 28 EVG TREES

PARKING LOT LANDSCAPE (P)
1 TREE PER 8 PARKING SPACES

LANDSCAPING TO BE 5' FROM CURB WHERE THERE IS VEHICLE OVERHANG AND 3' WHERE THERE IS NOT. REQUIRED: 109 PARKING SPACES / 8 = 14 DEC TREES

REQUIRED: 308.01 LF / 30 = 11 TREES

AT R.O.W ADJACENT TO WATTLES RD.

REQUIRED: 93,561 SF SITE AREA X 20% = 18,712.2 SF

PROVIDED: 32849.6 SF LANDSCAPED AREA (35%)

TREE REPLACEMENT (R) WOODLAND TREES:

> 0" DBH X 2 = 0" CREDIT 69" - 0"= 69" REPLACEMENT REQUIRED

85" DBH X 1 = 85" REPLACEMENT

85''-0'' = -85'' REPLACEMENT REQUIRED TOTAL REPLACEMENT TREES:

1, 2.5" DEC TREE = 1 X 2.5" DBH = 2.5" BH 4, 8' EVG TREES = 4 X 3.5" DBH = 14" DBH

B&B

B&B

B&B

B&B

B&B

B&B

CONT.

B&B



LETTER DESIGNATION FOR ORDINANCE REQUIRED MATERIAL

= TREE PROTECTION FENCE

LANDSCAPE CALCULATIONS: PER CITY OF TROY ZONING ORDINANCE: ZONING: NEIGHBORHOOD NODES (NN) - NODE F

AND 6' HT OPAQUE SCREEN FENCE

PROVIDED: 14 DEC TREES

GREENBELT (WATTLES RD) (G)
1 DEC TREE PER 30 LF OF FRONTAGE ABUTTING A PUBLIC ROW

PROVIDED: UNABLE TO PROVIDE TREES WITHIN THE EASEMENT

GENERAL SITE LANDSCAPE 20% OF THE TOTAL SITE AREA IS TO BE LANDSCAPED

WOODLAND TREES REMOVED (12 TREES): REPLACE AT 50% OF REMOVED DBH 137" DBH X .5 = 69" REPLACEMENT

WOODLAND TREES SAVED (0 TREES): CREDIT OF 2X DBH

LANDMARK TREES: LANDMARK TREES REMOVED (4 TREES): REPLACE AT 100% OF REMOVED DBH

LANDMARK TREES SAVED (0 TREES): CREDIT OF 2X DBH $0" \times 2 = 0" CREDIT$

69" + 85" = 154" DBH REPLACEMENT REQUIRED

2.5" CAL.

8` HT.

8` HT.

8` HT.

3" CAL.

3" CAL.

30" HT.

6` HT.

2.5" CAL. B&B

2.5" CAL. B&B

34, 3" DEC TREES = 34 X 3" DBH = 102" DBH 15, 6' EVG TREES = 15 X 2.5" DBH = 37.5" DBH 156" TOTAL DBH PROVIDED

SIZE CONTAINER SPACING

PER PLAN

4` O.C.


36"O.C.


PER PLAN

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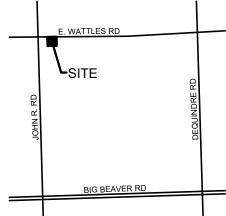




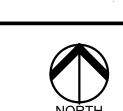

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LOCATION MAP

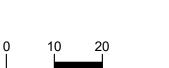

CLIENT

CONSTRUCTION, INC. 2150 FRANKLIN ROAD BLOOMFIELD HILLS, MI 48302

TROY, MI 48083

PROJECT TITLE **WATTLES SQUARE APARTMENTS** E. WATTLES RD. & JOHN R. RD.

REVISIONS	
CITY COMMENTS	11/
SITE PLAN APPROVAL	12
CITY COMMENTS	3
CITY COMMENTS	(
ORIGINAL ISSUE DATE:	
CEDTEMPED 33, 3033	

SEPTEMBER 22, 2023 DRAWING TITLE **PRELIMINARY LANDSCAPE**


PLAN


PEA JOB NO.	22-1309
P.M.	GMB
DN.	BGG
DES.	JLE
DRAWING NUMBER:	

GENERAL PLANTING NOTES:

SPECIFICATIONS.

- . LANDSCAPE CONTRACTOR SHALL VISIT SITE, INSPECT EXISTING SITE CONDITIONS AND REVIEW PROPOSED PLANTING AND RELATED WORK. IN CASE OF DISCREPANCY BETWEEN PLAN AND PLANT LIST, PLAN SHALL GOVERN QUANTITIES. CONTACT LANDSCAPE ARCHITECT WITH ANY CONCERNS.
- 2. CONTRACTOR SHALL VERIFY LOCATIONS OF ALL ON SITE UTILITIES PRIOR TO BEGINNING CONSTRUCTION ON HIS/HER PHASE OF WORK. ELECTRIC, GAS, TELEPHONE, CABLE TELEVISION MAY BE LOCATED BY CALLING MISS DIG 1-800-482-7171. ANY DAMAGE OR INTERRUPTION OF SERVICES SHALL BE THE RESPONSIBILITY OF CONTRACTOR. CONTRACTOR SHALL COORDINATE ALL RELATED ACTIVITIES WITH OTHER TRADES ON THE JOB AND SHALL REPORT ANY UNACCEPTABLE JOB CONDITIONS TO OWNER'S REPRESENTATIVE PRIOR TO
- 3. ALL PLANT MATERIAL TO BE PREMIUM GRADE NURSERY STOCK AND SHALL SATISFY AMERICAN ASSOCIATION OF NURSERYMEN STANDARD FOR NURSERY STOCK. ALL LANDSCAPE MATERIAL SHALL BE NORTHERN GROWN, NO.
- . CONTRACTOR IS RESPONSIBLE FOR VERIFYING ALL QUANTITIES SHOWN ON LANDSCAPE PLAN PRIOR TO PRICING
- 5. THE OWNER'S REPRESENTATIVE RESERVES THE RIGHT TO REJECT ANY PLANT MATERIAL NOT MEETING
- 6. ALL SINGLE STEM SHADE TREES TO HAVE STRAIGHT TRUNKS AND SYMMETRICAL CROWNS.
- 7. ALL SINGLE TRUNK SHADE TREES TO HAVE A CENTRAL LEADER; TREES WITH FORKED OR IRREGULAR TRUNKS WILL NOT BE ACCEPTED.
- 8. ALL MULTI STEM TREES SHALL BE HEAVILY BRANCHED AND HAVE SYMMETRICAL CROWNS. ONE SIDED TREES OR THOSE WITH THIN OR OPEN CROWNS SHALL NOT BE ACCEPTED.
- 9. ALL EVERGREEN TREES SHALL BE HEAVILY BRANCHED AND FULL TO THE GROUND, SYMMETRICAL IN SHAPE AND NOT SHEARED FOR THE LAST FIVE GROWING SEASONS.
- 10. ALL TREES TO HAVE CLAY OR CLAY LOAM BALLS, TREES WITH SAND BALLS WILL BE REJECTED.
- 11. NO MACHINERY IS TO BE USED WITHIN THE DRIP LINE OF EXISTING TREES; HAND GRADE ALL LAWN AREAS WITHIN THE DRIP LINE OF EXISTING TREES.
- 12. ALL TREE LOCATIONS SHALL BE STAKED BY LANDSCAPE CONTRACTOR AND ARE SUBJECT TO THE APPROVAL OF THE LANDSCAPE ARCHITECT PRIOR TO INSTALLATION OF THE PLANT MATERIAL.
- 13. IT IS MANDATORY THAT POSITIVE DRAINAGE IS PROVIDED AWAY FROM ALL BUILDINGS.
- 14. ALL PLANTING BEDS SHALL RECEIVE 3" SHREDDED HARDWOOD BARK MULCH WITH PRE EMERGENT, SEE SPECIFICATIONS. SHREDDED PALETTE AND DYED MULCH WILL NOT BE ACCEPTED.
- 15. ALL LANDSCAPED AREAS SHALL RECEIVE 3" COMPACTED TOPSOIL.
- 16. SEE SPECIFICATIONS FOR ADDITIONAL COMMENTS, REQUIREMENTS, PLANTING PROCEDURES AND WARRANTY
- 17. FOR NON-LAWN SEED MIX AREAS, AS NOTED ON PLAN, BRUSH MOW ONCE SEASONALLY FOR INVASIVE SPECIES
- 18. CONTRACTOR SHALL NOT INSTALL PLANTS UNDER BUILDING OVERHANG AND SHALL NOTIFY LANDSCAPE ARCHITECT IF DRAWINGS CONFLICT WITH BUILDING OVERHANGS.
- 19. TREES SHALL NOT CONFLICT/ BLOCK PROPOSED REGULATORY/ DIRECTION SIGNAGE, MONUMENT SIGNS, ADDRESS OR LIGHT POLES. SHIFT TREES AS NECESSARY TYP.

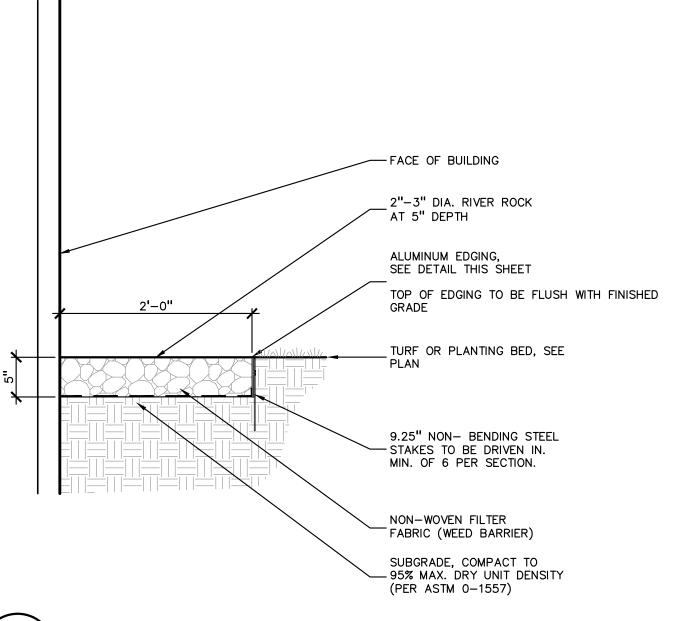

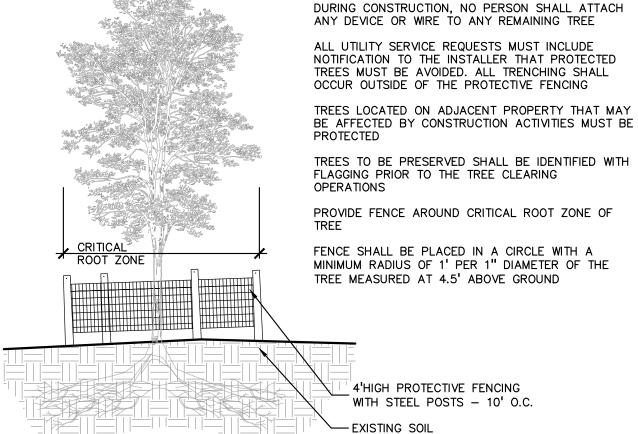

START OF CONSTRUCTION ACTIVITIES AND SHALL REMAIN IN PLACE UNTIL CONSTRUCTION IS COMPLETE NO PERSON MAY CONDUCT ANY ACTIVITY WITHIN THE DRIP LINE OF ANY TREE DESIGNATED TO REMAIN; INCLUDING, BUT NOT LIMITED TO PLACING SOLVENTS, BUILDING MATERIAL, CONSTRUCTION EQUIPMENT OR SOIL DEPOSITS WITHIN DRIP LINES

GRADE CHANGES MAY NOT OCCUR WITHIN THE DRIP

LINE OF PROTECTED TREES

TREE PROTECTION WILL BE ERECTED PRIOR TO

DURING CONSTRUCTION, NO PERSON SHALL ATTACH ANY DEVICE OR WIRE TO ANY REMAINING TREE

ALL UTILITY SERVICE REQUESTS MUST INCLUDE NOTIFICATION TO THE INSTALLER THAT PROTECTED TREES MUST BE AVOIDED. ALL TRENCHING SHALL OCCUR OUTSIDE OF THE PROTECTIVE FENCING

TREES LOCATED ON ADJACENT PROPERTY THAT MAY BE AFFECTED BY CONSTRUCTION ACTIVITIES MUST BE

FLAGGING PRIOR TO THE TREE CLEARING OPERATIONS PROVIDE FENCE AROUND CRITICAL ROOT ZONE OF

FENCE SHALL BE PLACED IN A CIRCLE WITH A MINIMUM RADIUS OF 1' PER 1" DIAMETER OF THE

TREE MEASURED AT 4.5' ABOVE GROUND 4'HIGH PROTECTIVE FENCING WITH STEEL POSTS - 10' O.C.



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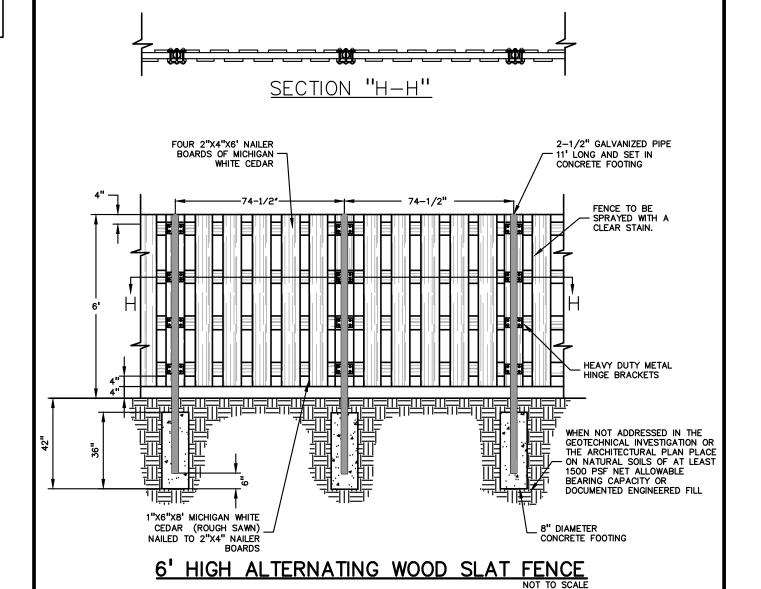
STONE MAINTENANCE STRIP SCALE: 1'' = 1'-0''

TREE PROTECTION DETAIL SCALE: 1'' = 3'-0''

SCALE: 1'' = 3'-0''



CAUTION!!




PERMALOC ALUMINUM EDGING OR APPROVED EQUAL WITH BLACK FINISH - BED MEDIA - COMPACTED SUBGRADE SPECIFICATIONS FOR LANDSCAPE BED EDGING: LANDSCAPE BED EDGING SHALL BE ALUMINUM AS MANUFACTURED BY PERMALOC 1.800.356.9660 8' OR 16' SECTIONS SHALL BE USED WITH ONE STAKE PER 38" OF EDGING SHALL BE 3" THICK X 4" DEPTH WHEN ADJ. TO MULCH AND 급" THICK X 5 ½" DEPTH WHEN ADJ. TO ROCK, FINISH: BLACK DURAFLEX MEETING AAMA 2603

STAKE SHALL SECURELY ENGAGE EDGING AND SHALL BE ENTIRELY BELOW TOP SURFACE OF EDGING EDGING SHALL HAVE A MINIMUM OF 2" OF INTERLOCKING OVERLAP BETWEEN SECTIONS

INSTALL AS PER MANUFACTURER'S SPECIFICATIONS WITH TOP OF EDGING 1"-1" ABOVE COMPACTED FINISH GRADE. FINISH GRADE TO BE COMPACTED ON BOTH SIDES OF EDGING TO MAINTAIN STABILITY

PLANT SO THAT THE TREE'S ROOT FLARE (TRUNK FLARE) IS FLUSH WITH GRADE OR 1-2" HIGHER IN POORLY DRAIN SOIL. STAKE JUST BELOW BRANCHES WITH 2"-3" STAKING/GUYING WIDE NYLON OR PLASTIC STRAPS. CONNECT <u>LOCATION</u> FROM TREE TO STAKE AND ALLOW FOR FLEXIBILITY. REMOVE AFTER (1) ONE YEAR. (DO NOT USE WIRE & HOSE) THREE 2"X2" HARDWOOD STAKES OR STEEL T-POSTS DRIVEN A MIN. OF 18" DEEP FIRMLY INTO SUBGRADE PRIOR TO BACKFILLING SHREDDED HARDWOOD BARK MULCH TO DRIPLINE. 3" DEEP AND LEAVE 3" CIRCLE OF BARE SOIL AROUND TREE TRUNK. DO NOT PLACE MULCH IN CONTACT WITH TREE TRUNK. FORM SAUCER WITH 4" HIGH CONTINUOUS RIM -FINISH GRADE SPECIFIED PLANTING MIX, WATER & TAMP TO - REMOVE AIR POCKETS, ÁMEND SOIL PER SITE CONDITIONS & TREE REQUIREMENTS EXPOSE ROOT FLARE OF TREE. CONTRACTOR MAY HAVE TO REMOVE EXCESS SOIL FROM TOP OF ROOTBALL. REMOVE ALL BURLAP FROM TOP 1 OF ROOTBALL. DISCARD ALL MIN. TYP. NON-BIODEGRADABLE MATERIAL OFF SITE PLACE ROOTBALL ON UNEXCAVATED OR EVERGREEN TREE PLANTING DETAIL

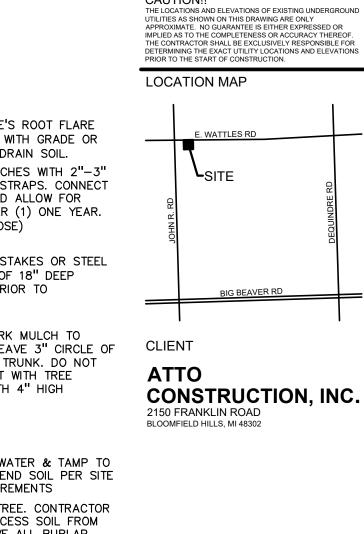

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TROY, MI 48083

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ALUMINUM EDGE DETAIL SCALE: 1/2'' = 1'-0''

SCALE: 1'' = 2'-0''

PLANT SO THAT TOP OF ROOT BALL IS FLUSH TO GRADE OR 1-2" HIGHER IF IN POORLY DRAINED SOILS DO NOT COVER TOP OF ROOTBALL WITH SOIL FORM SAUCER WITH 4" HIGH CONTINUOUS RIM SHREDDED HARDWOOD BARK MULCH 3" _DEEP AND LEAVE 3" CIRCLE OF BARE SOIL AROUND TRUNK. DO NOT PLACE MULCH IN CONTACT WITH TRUNK - FINISH GRADE SPECIFIED PLANTING MIX. WATER AND TAMP TO REMOVE AIR POCKETS REMOVE ALL BURLAP FROM TOP 1 OF -ROOTBALL DISCARD ALL NON-BIODEGRADABLE MATERIAL OFF SITE VARIES ON CONTAINER OR BALL SIZE _PLACE ROOTBALL ON UNEXCAVATED OR SHRUB PLANTING DETAIL

MIN. TYP. DECIDUOUS TREE PLANTING DETAIL SCALE: 1'' = 3'-0''

120°

<u>LOCATION</u>

PLANT SO THAT THE TREE'S ROOT FLARE (TRUNK FLARE) IS FLUSH WITH GRADE OR 1-2" HIGHER IN POORLY DRAIN SOIL. SECURE TREE WRAP WITH BIODEGRADABLE REVISIONS MATERIAL AT TOP & BOTTOM, REMOVE AFTER CITY COMMENTS FIRST WINTER SITE PLAN APPROVAL DO NOT PRUNE TERMINAL LEADER PRUNE ONLY DEAD, BROKEN BRANCHES AS DIRECTED BY LANDSCAPE ARCHITECT STAKE JUST BELOW BRANCHES WITH 2"-3" WIDE NYLON OR PLASTIC STRAPS. CONNECT - FROM TREE TO STAKE AND ALLOW FOR FLEXIBILITY. REMOVE AFTER (1) ONE YEAR. (DO NOT USE WIRE & HOSE) (3) THREE 2"X2" HARDWOOD STAKES DRIVEN A MIN. OF 18" DEEP FIRMLY INTO SUBGRADE PRIOR TO BACKFILLING SHREDDED HARDWOOD BARK MULCH TO DRIPLINE. 3" DEEP AND LEAVE 3" CIRCLE OF BARE SOIL AROUND TREE TRUNK. DO NOT STAKING/GUYING PLACE MULCH IN CONTACT WITH TREE TRUNK. FORM SAUCER WITH 4" HIGH CONTINUOUS RIM SPECIFIED PLANTING MIX, WATER & TAMP TO - REMOVE AIR POCKETS, AMEND SOIL PER SITE CONDITIONS & TREE REQUIREMENTS -FINISH GRADE EXPOSE ROOT FLARE OF TREE. CONTRACTOR MAY HAVE TO REMOVE EXCESS SOIL FROM - TOP OF ROOTBALL. REMOVE ALL BURLAP FROM TOP 3 OF ROOTBALL. DISCARD ALL P.M. NON-BIODEGRADABLE MATERIAL OFF SITE DN. PLACE ROOTBALL ON UNEXCAVATED OR


12/5/23 CITY COMMENTS 3/6/24 CITY COMMENTS 6/3/24 ORIGINAL ISSUE DATE: SEPTEMBER 22, 2023 DRAWING TITLE **LANDSCAPE DETAILS**

11/15/23

PEA JOB NO. 22-1309 GMB BGG DES. JLE DRAWING NUMBER:

NOT FOR CONSTRUCTION

L-2.0

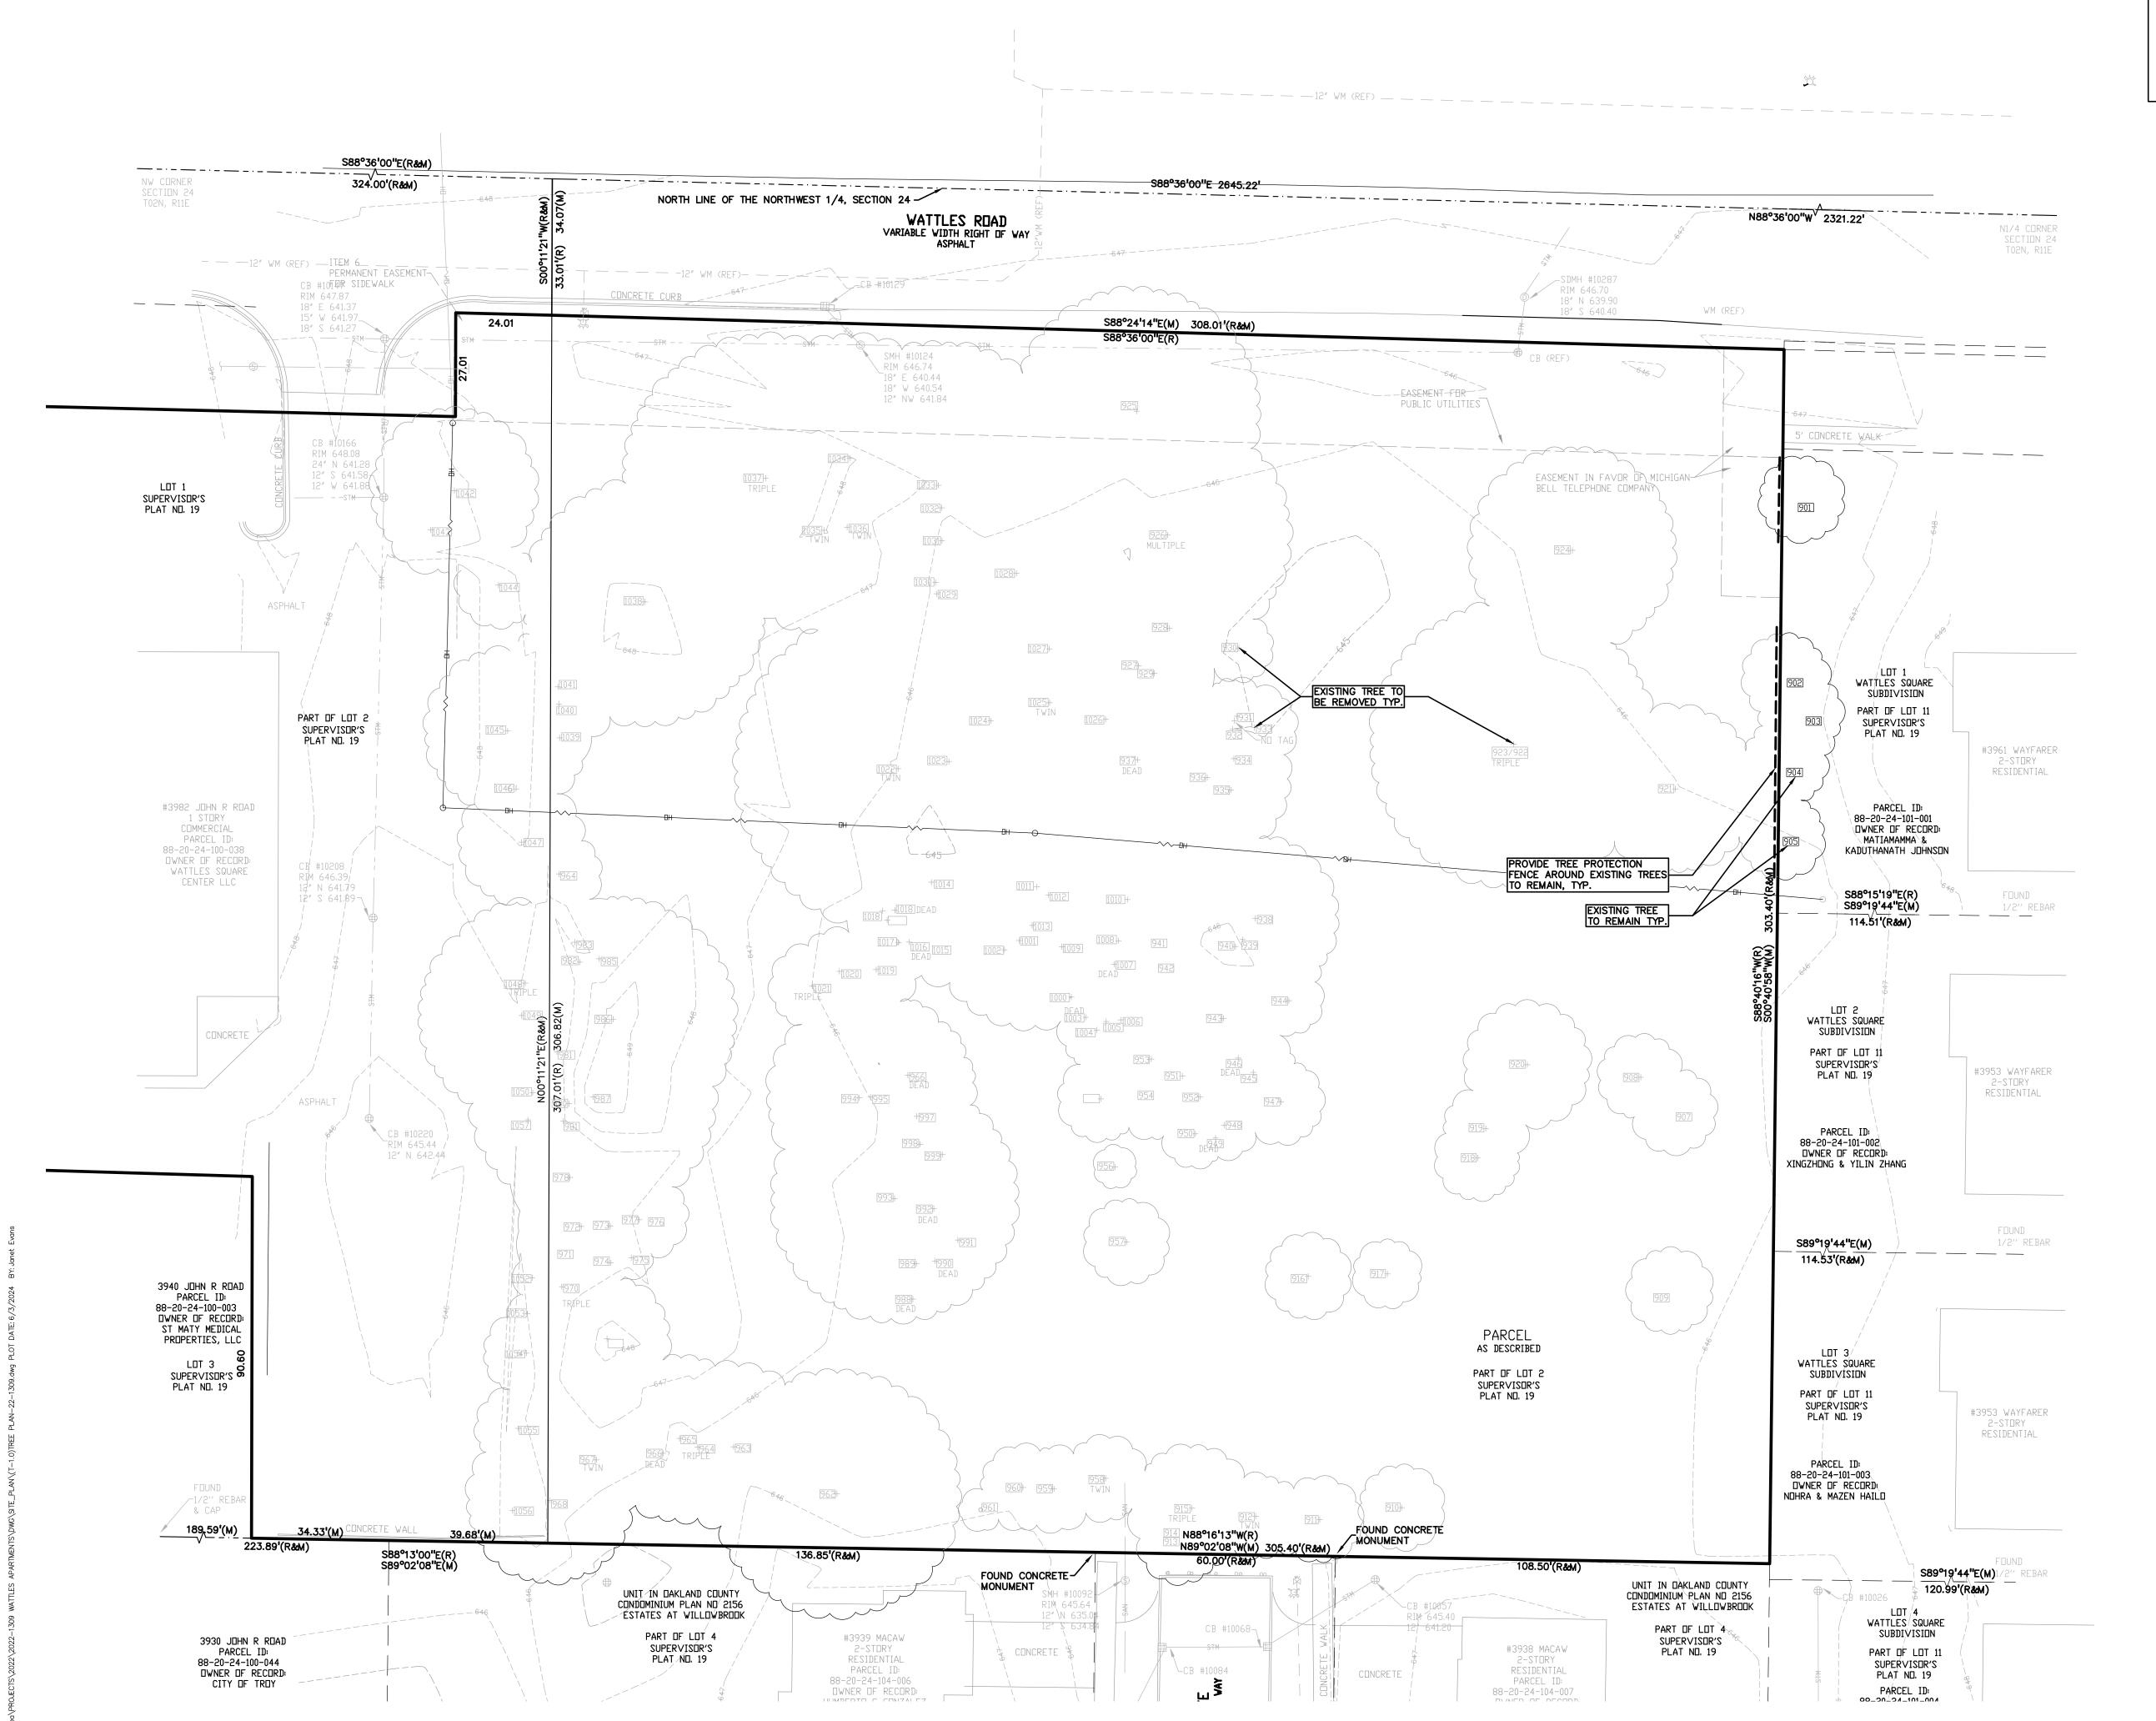


KEY:

= EXISTING TREE TO REMAIN ⁺[968] = EXISTING TREE TO BE REMOVED = TREE PROTECTION FENCING

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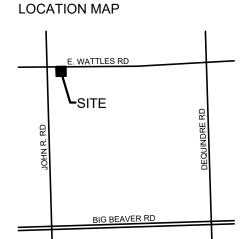






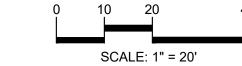

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CLIENT CONSTRUCTION, INC. 2150 FRANKLIN ROAD BLOOMFIELD HILLS, MI 48302

PROJECT TITLE WATTLES SQUARE APARTMENTS E. WATTLES RD. & JOHN R. RD.

TROY, MI 48083

REVISIONS	
CITY COMMENTS	11/15/23
SITE PLAN APPROVAL	12/5/23
CITY COMMENTS	3/6/24
CITY COMMENTS	6/3/24
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ORIGINAL ISSUE DATE: SEPTEMBER 22, 2023

DRAWING TITLE

TREE PLAN

PEA JOB NO.	22-1309
P.M.	GMB
DN.	BGG
DES.	JLE
DRAWING NUMBER:	

NOT FOR CONSTRUCTION

TAO	DDU		I ATINI NIABAT	COND	COMMENTO	01.400	OANE / DEMONE	ON OUTE	DEDI AGE
TAG	DBH	COMMON NAME	LATIN NAME	COND	COMMENTS	CLASS	SAVE / REMOVE		REPLACE
901	13"	Red Maple	Acer rubrum	Good		WOODLAND	S	N	-
902	17"	Austrian Pine	Pinus nigra	Poor	DL, M	WOODLAND	S	N	-
903	8"	White Pine	Pinus strobus	Fair/Poor	NC	WOODLAND	S	N	-
904	22"	Austrian Pine	Pinus nigra	Fair		LANDMARK	S	N	_
905	16"	Austrian Pine	Pinus nigra	Fair/Poor	DL	WOODLAND	S	N	_
906	3 <u>",11"</u>	Mulberry	Morus rubra	Poor	DL, VC (OrBit)	INVASIVE	R	¥	-
907	30"	Box Elder	Acer negundo	Very Poor	Grow ing horizontal to the ground	INVASIVE	R	¥	<u>-</u>
908	13"	Box Elder	Acer negundo	Very Poor	Topped, VC (Gr)	INVASIVE	R	¥	
909	7",8"	Box Elder	Acer negundo	Poor	Totally VC (Gr)	INVASIVE	₽	¥	-
910	22"	Silver Maple	Acer saccharinum	Fair		INVASIVE	R	¥	-
911	18"	Cottonw ood	Populus deltoides	Fair		INVASIVE	R	¥	-
912	11",17"	Cottonw ood	Populus deltoides	Fair		INVASIVE	R	¥	-
913	9"	Silver Maple	Acer saccharinum	Fair		INVASIVE	R	¥	-
914	10"	Cottonw ood	Populus deltoides	Poor	NC, VC (Gr)	INVASIVE	R	¥	-
915	10",16",18"	Cottonw ood	Populus deltoides	Fair		INVASIVE	R	¥	-
916	16"	Silver Maple	Acer saccharinum	Fair		INVASIVE	R	¥	_
917	12"	American Elm	Ulmus americana	Poor	NC, OS	INVASIVE	R	¥	-
918	13"	Silver Maple	Acer saccharinum	Fair	, ==	INVASIVE	R	¥	
919	11"	American Elm	Ulmus americana	Fair		INVASIVE	R	¥	
920	16"	Box Elder	Acer negundo	Poor	Totally VC (Gr)	INVASIVE	R	¥	
921	15",18"	Box Elder	Acer negundo	Poor	Maj. L., DL.,	INVASIVE	R	¥	
921	18",22",24"	Cottonw ood	Populus deltoides	Fair	1 11(a). ∟, ⊅∟,	INVASIVE INVASIVE	R	¥	<u>-</u>
			·						
923	13",15" 30"	Silver Maple	Acer saccharinum	Fair	BD, BR, OS	INVASIVE	R B	¥ ¥	-
924	39"	Willow	Salix sp.	Poor	BD, BR, OS	INVASIVE	R		<u>-</u>
925	35"	Cottonw ood	Populus deltoides	Fair		INVASIVE	R	¥	-
926	20",42"	Willow	Salix sp.	Very Poor	Maj. BD, Many DL	INVASIVE	R _	¥	-
927	16"	Cottonw ood	Populus deltoides	Fair		INVASIVE	R	¥	-
928	19"	Cottonw ood	Populus deltoides	Fair		INVASIVE	R	¥	-
929	21"	Cottonw ood	Populus deltoides	Fair		INVASIVE	R	¥	-
930	18"	Cottonw ood	Populus deltoides	Poor	DL, OS, VC (PI)	INVASIVE	R	¥	-
931	5",16"	Cottonw ood	Populus deltoides	Poor	5" stem very poor, OS	INVASIVE	R	¥	<u>-</u>
932	11",19"	Cottonw ood	Populus deltoides	Fair/Poor	O S	INVASIVE	R	¥	_
933	12"	Silver Maple	Acer saccharinum	Fair/Poor	os	INVASIVE	R	¥	-
934	18"	Cottonw ood	Populus deltoides	Fair/Poor	os	INVASIVE	R	¥	_
935	11"	Cottonw ood	Populus deltoides	Poor	M, OS	INVASIVE	₽	¥	<u>-</u>
936	25 "	Cottonw ood	Populus deltoides	Fair		INVASIVE	R	¥	<u>-</u>
937	25 "	Cottonw ood	Populus deltoides	Dead		INVASIVE	R	¥	-
938	10",23"	Cottonw ood	Populus deltoides	Poor	10" stem VC (PI), OS, VC (PI)	INVASIVE	R	¥	-
939	23"	Cottonw ood	Populus deltoides	Poor	OS, VC (PI)	INVASIVE	R	¥	-
940	12"	Cottonw ood	Populus deltoides	Poor	M, OS	INVASIVE	R	¥	-
941	21"	Cottonw ood	Populus deltoides	Fair		INVASIVE	R	¥	
942	23"	Cottonw ood	Populus deltoides	Poor	Maj. DL, OS	INVASIVE	R	¥	
943	13"	Cottonw ood	Populus deltoides	Fair	,	INVASIVE	R	¥	
944	<u>9"</u>	Silver Maple	Acer saccharinum	Poor	NC, Vines (Gr)	INVASIVE	R	¥	<u>-</u>
945		Cottonw ood	Populus deltoides	Poor	Topped, M	INVASIVE	R	¥	 _
946	9 <u>",21"</u>	Cottonw ood	Populus deltoides	Fair	Toppou, IN	INVASIVE	R	¥	
946	9 ,2 i 24 <u>"</u>		·	Fair/Poor	OS			¥	
		Cottonwood	Populus deltoides			INVASIVE	R		-
948	19"	Cottonw ood	Populus deltoides	Poor	SI. L, M, OS	INVASIVE	R	¥	<u>-</u> I
949	17"	Cottonwood	Populus deltoides	Poor Fair/Poor	DL, OS	INVASIVE	R B	¥	<u>-</u> I
950	16"	Cottonw ood	Populus deltoides	Fair/Poor	F	INVASIVE	R	¥	-
951	16"	Cottonw ood	Populus deltoides	Poor	DL, OS	INVASIVE	R _	¥	-
	15"	Cottonw ood	Populus deltoides	Fair/Poor	SI. L	INVASIVE	R	¥	<u>-</u>
952			Acer saccharinum	Fair		INVASIVE	R	¥	-
952 953	18"	Silver Maple	Acci Saconarinam						
		Silver Maple Cottonwood	Populus deltoides	Poor	DL, N C	INVASIVE	R	¥	-
953	18"	·		Poor Fair	DL, NC	WOODLAND	R R	Ż Ż	- REPLACE
953 954	18" 15"	Cottonw ood	Populus deltoides		ĐL, NC				
953 954 955	18" 15" 9"	Cottonw ood Red Oak	Populus deltoides Quercus rubra	Fair	DL, NC Vines (Gr)	WOODLAND	R	¥	REPLACE
953 954 955 956	18" 15" 9" 7"	Cottonw ood Red Oak Red Oak	Populus deltoides Quercus rubra Quercus rubra	Fair Good		WOODLAND WOODLAND	R R	¥ ¥	REPLACE REPLACE

960	23"	Cottonw ood	Populus deltoides	Fair		INVASIVE	R	¥	-
961	11"	Silver Maple	Acer saccharinum	Fair/Poor	OS	INVASIVE	R	¥	-
962	22"	Cottonw ood	Populus deltoides	Fair	Some vines (PI)	INVASIVE	R	¥	-
963 964	6",11",13"	Silver Maple Box Elder	Acer saccharinum Acer negundo	Fair Very Poor	6" stem dead. BD. DL	INVASIVE INVASIVE	R R	¥	
965	16"	Box Elder	Acer negundo	Poor	DL, L, Fungus	INVASIVE	R	¥	-
966	15"	Box Elder	Acer negundo	Very Poor	Maj. BD, DL	INVASIVE	R	¥	-
967	3",10",10",12"	Box Elder	Acer negundo	Very Poor	Many DL, M	INVASIVE	R R	¥ ¥	-
968 969	19" 18"	Cottonw ood Norw ay Maple	Populus deltoides Acer platanoides	Fair Very Poor	Mai. BD	INVASIVE INVASIVE	∺ 	¥	<u> </u>
970	8",11",13 <u>"</u>	Cottonw ood	Populus deltoides	Fair	.	INVASIVE	R	¥	-
971	12"	Cottonw ood	Populus deltoides	Fair		INVASIVE	R	¥	_
972	10"	Cottonw ood	Populus deltoides	Poor	NC, OS	INVASIVE	R	¥	-
973 974	11" 13"	Cottonw ood Cottonw ood	Populus deltoides Populus deltoides	Very Poor Fair/Poor	DL, VC (Gr) NC	INVASIVE INVASIVE	R	¥ ¥	<u> </u>
975	11"	Cottonw ood	Populus deltoides	Poor	DL, NC	INVASIVE	R	¥	-
976	9"	Cottonw ood	Populus deltoides	Fair		INVASIVE	R	¥	-
977 978	11" 17"	Cottonw ood	Populus deltoides Populus deltoides	Fair Fair		INVASIVE INVASIVE	R R	¥	-
979	13"	Cottonw ood	Populus deltoides	Fair		INVASIVE	R	¥	
980	13"	Cottonw ood	Populus deltoides	Poor	DL, L, OS	INVASIVE	R	¥	-
981	10"	Box Elder	Acer negundo	Poor	DL, L	INVASIVE	R	¥	-
982 983	9 <u>"</u>	Box Elder Box Elder	Acer negundo Acer negundo	Fair/Poor Poor	Maj. DL DL. L	INVASIVE INVASIVE	R R	¥	-
984	8 <u>",10"</u>	Box Elder	Acer negundo	Fair/Poor	DL	INVASIVE	R	¥	
985	14"	Box Elder	Acer negundo	Very Poor	Maj. BD, DL, L	INVASIVE	R	¥	-
986	17"	Norw ay Maple	Acer platanoides	Fair/Poor	Exposed roots	INVASIVE	R	¥	-
987 988	16" 28"	Norw ay Maple Cottonw ood	Acer platanoides Populus deltoides	Fair/Poor Dead	Exposed roots	INVASIVE INVASIVE	R R	¥	<u>-</u> -
989	7"	Red Oak	Quercus rubra	Good		WOODLAND	R	¥	REPLACE
990	26"	Cottonw ood	Populus deltoides	Dead		INVASIVE	R	¥	-
991	12"	Bur Oak	Quercus macrocarpa	Fair		WOODLAND	R	¥	REPLACE
9 92 9 93	20" 23"	Cottonw ood Cottonw ood	Populus deltoides Populus deltoides	Dead Fair/Poor	ÐL	INVASIVE INVASIVE	R R	¥ ¥	-
994	12"	Mulberry	Morus rubra	Poor	OS, Vines (Gr)	INVASIVE	R	¥	-
995	26"	Cottonw ood	Populus deltoides	Fair		INVASIVE	R	¥	-
996	19"	Cottonw ood	Populus deltoides	Dead	DI NO	INVASIVE	R	¥	-
997 998	21" 15"	Cottonw ood Cottonw ood	Populus deltoides Populus deltoides	Poor Poor	DL, NC L, OS, Vines (Gr)	INVASIVE INVASIVE	R 	¥ ¥	<u>-</u>
999	19"	Cottonw ood	Populus deltoides	Fair/Poor	OS OS	INVASIVE	R	¥	-
1000	17"	Cottonw ood	Populus deltoides	Poor	DL, OS	INVASIVE	R	¥	_
1001	16" 16"	Cottonwood	Populus deltoides	Poor Fair/Paar	DL, NC	INVASIVE	R R	¥	-
1002 1003	13"	Cottonw ood Cottonw ood	Populus deltoides Populus deltoides	Fair/Poor	OS DL, OS	INVASIVE INVASIVE	R	¥	<u>-</u> -
1004	7"	Cottonw ood	Populus deltoides	Dead	,,	INVASIVE	R	¥	-
1005	18"	Cottonw ood	Populus deltoides	Poor	Maj. DL, N C	INVASIVE	R	¥	-
1006 1007	22 <u>"</u> 19"	Cottonw ood Cottonw ood	Populus deltoides Populus deltoides	Fair Poor	DL. NG	INVASIVE INVASIVE	R R	¥	-
1008	18"	Cottonw ood	Populus deltoides	Poor	DL, NC	INVASIVE	R	¥	-
1009	16"	Cottonw ood	Populus deltoides	Fair		INVASIVE	R	¥	-
1010	10"	Silver Maple	Acer saccharinum	Fair		INVASIVE	R	¥	-
1011 1012	23 <u>"</u> 7",9"	Cottonw ood Silver Maple	Populus deltoides Acer saccharinum	Dead Fair		INVASIVE INVASIVE	R R	¥ ¥	<u> </u>
1013	15 <u>"</u>	Cottonw ood	Populus deltoides	Fair		INVASIVE	R	¥	-
1014	25 <u>"</u>	Cottonw ood	Populus deltoides	Poor	Many DL	INVASIVE	R	¥	-
1015 1016	21" 16"	Cottonw ood Cottonw ood	Populus deltoides Populus deltoides	Poor Fair/Poor	<u>₩, O\$</u> ————————————————————————————————————	INVASIVE INVASIVE	R R	¥ ¥	-
1017	16",16",18"	Cottonw cod	Populus deltoides	Poor	(1) 16" stem dead, DL, NC	INVASIVE	R	¥	<u> </u>
1018	16",18",26"	Cottonw ood	Populus deltoides	Poor	26" stem dead	INVASIVE	R	¥	-
1019	14"	Cottonw ood	Populus deltoides	Poor	DL, NC	INVASIVE	R	¥	-
1020 1021	17" 10",12",16"	Cottonw ood Cottonw ood	Populus deltoides Populus deltoides	Fair Poor	L 10" stem dead, L, NC	INVASIVE INVASIVE	R R	¥	<u>-</u>
1022	16",22",28"	Willow-	Salix sp.	Very Poor	16" stem dead, Many DL	INVASIVE	R	¥	-
1023	25"	Cottonw ood	Populus deltoides	Fair		INVASIVE	R	¥	-
1024	14"	Cottonw ood	Populus deltoides	Poor	L, NC	INVASIVE	R	¥	-
1025 1026	12",19" 20"	Cottonw ood Cottonw ood	Populus deltoides Populus deltoides	Fair Poor	DL, NC	INVASIVE INVASIVE	R R	¥	<u> </u>
1027	24 <u>"</u>	Cottonw ood	Populus deltoides	Fair	, .	INVASIVE	R	¥	<u> </u>
1028	16"	Cottonw ood	Populus deltoides	Poor	DL. NC	INVASIVE	R	¥	-
1029 1030	28" 32"	Cottonw ood	Populus deltoides Populus deltoides	Poor Fair	Maj. DL, Sl. L, OS	INVASIVE INVASIVE	R R	¥ ¥	<u>-</u>
1030	32" 13"	Cottonw ood	Populus deltoides	Poor	SI. L, M, NC	INVASIVE	R	¥	<u>-</u> -
1032	17"	Cottonw ood	Populus deltoides	Poor	Maj. DL, OS	INVASIVE	R	¥	-
1033	32"	Cottonw ood	Populus deltoides	Very Poor	(3) Maj. DL, OS	INVASIVE	R	¥	-
1034 1035	18" 10",12"	Siberian Elm Box Elder	Ulmus pumila Acer negundo	Very Poor Poor	Maj. BD, Many DL DL, L	INVASIVE INVASIVE	R R	¥ ¥	<u>-</u> -
1036	8",11"	Box Elder	Acer negundo	Poor	DL, M, SS	INVASIVE	R	¥	-
1037	13",16",18"	Box Elder	Acer negundo	Very Poor	Maj. BD, DL, L	INVASIVE	R	¥	-
1038	16 <u>"</u>	Norw ay Maple	Acer platanoides	Fair		INVASIVE	R	¥	-
1039 1040	14" 6"	Cottonw ood Cottonw ood	Populus deltoides Populus deltoides	Fair/Poor	BD	INVASIVE INVASIVE	R	¥ ¥	-
1041	18"	Cottonw ood	Populus deltoides	Fair	· -	INVASIVE	R	¥	<u>-</u>
1042	16"	Austrian Pine	Pinus nigra	Fair		WOODLAND	R	¥	REPLACE
1043 1044	18" 20"	Austrian Pine	Pinus nigra Picea abies	Fair Good		LANDMARK LANDMARK	R R	¥	REPLACE REPLACE
1044	20" 23"	Norw ay Spruce Norw ay Spruce	Picea abies	Good		LANDWARK	R	¥ ¥	REPLACE
1046	13"	Spruce	Picea sp.	Fair/Poor	ÐL	WOODLAND	R	¥	REPLACE
1047	15"	Spruce	Picea sp.	Fair/Poor	DL M : DD DI	WOODLAND	R	¥	REPLACE
1048 1049	3",5",5",7",9" 24"	Amur Maple Austrian Pine	Acer ginnala Pinus Nnigra	Very Poor Fair	Maj. BD. DL	INVASIVE LANDMARK	R R	¥ ¥	- REPLACE
1050	8 <u>"</u>	Spruce	Picea sp.	Very Poor	Central leader poor, OS	WOODLAND	R	¥	
1051	12"	Spruce	Picea sp.	Fair		WOODLAND	R	¥	REPLACE
1052 1953	10" 10"	Spruce Spruce	Picea sp.	Fair Very Poor	Central leader page DD 00	WOODLAND WOODLAND	R R	¥ ¥	REPLACE -
1953 1954	10" 11"	Spruce Spruce	Picea sp. Picea sp.	Very Poor Fair/Poor	Central leader poor, BD, OS DL	WOODLAND	R	¥	- REPLACE
			Pinus nigra	Fair/Poor	ÐL	WOODLAND	R	¥	
1055 1056	15" 10"	Austrian Pine Austrian Pine	Pinus nigra	Fair/Poor	ÐL	WOODLAND	R	¥	REPLACE REPLACE

TREE INVENTORY/PRESERVATION CALCULATIONS

EXEMPT TREES ON SITE:

TOTAL SAVED TREES 6" AND ABOVE ON SITE:

TOTAL TREE CREDITS 0 -----TREE CREDITS

WOODLAND TREES		
WOODLAND TREES REMOVED:	12	(REPLACE AT 50% OF REMOVED DBH)
137" DBH x 0.5 =		69" REPLACEMENT
WOODLAND TREES SAVED:	0	(CREDIT OF 2X DBH)
" DBH x 2 =		" CREDIT
68.5 -	0	= 68.5
69" DBH REQUIRED FOR W	OODL	AND REPLACEMENT
LANDMARK TREES		
LANDMARK TREES REMOVED:	4	(REPLACE AT 100% OF REMOVED DBH)
85'' DBH x 1 =		85" REPLACEMENT
LANDMARK TREES SAVED:	0	(CREDIT OF 2X DBH)
" DBH x 2 =		" CREDIT
85 -	0	= 85
154" TOTAL DBH REQUIRED	FOR I	REPLACEMENT
EXEMPT TREES		
(NO REPLACEMENT REQUIRED F	OR EX	(EMPT TREES)
SAVED EXEMPT TREES:	0	Trees

62 **Trees**

Trees



GROUP



CAUTION!!

THE LOCATIONS AND ELEVATIONS OF EXISTING UNDERGROUND UTILITIES AS SHOWN ON THIS DRAWING ARE ONLY APPROXIMATE. NO GUARANTEE IS EITHER EXPRESSED OR IMPLIED AS TO THE COMPLETENESS OR ACCURACY THEREOF. THE CONTRACTOR SHALL BE EXCLUSIVELY RESPONSIBLE FOR DETERMINING THE EXACT UTILITY LOCATIONS AND ELEVATIONS PRIOR TO THE START OF CONSTRUCTION.

LOCATION MAP

E. WATTLES RD

SITE

OF OUNDRE RD

BIG BEAVER RD

ATTO
CONSTRUCTION, INC.
2150 FRANKLIN ROAD
BLOOMFIELD HILLS, MI 48302

PROJECT TITLE

WATTLES SQUARE APARTMENTS E. WATTLES RD. & JOHN R. RD. TROY, MI 48083


REVISIONS	
CITY COMMENTS	11/15/
SITE PLAN APPROVAL	12/5/
CITY COMMENTS	3/6/
CITY COMMENTS	6/3/
ORIGINAL ISSUE DATE:	


SEPTEMBER 22, 2023

DRAWING TITLE

TREE LIST

PEA JOB NO.	22-1309
P.M.	GMB
DN.	BGG
DES.	JLE
DRAWING NUMBER:	·

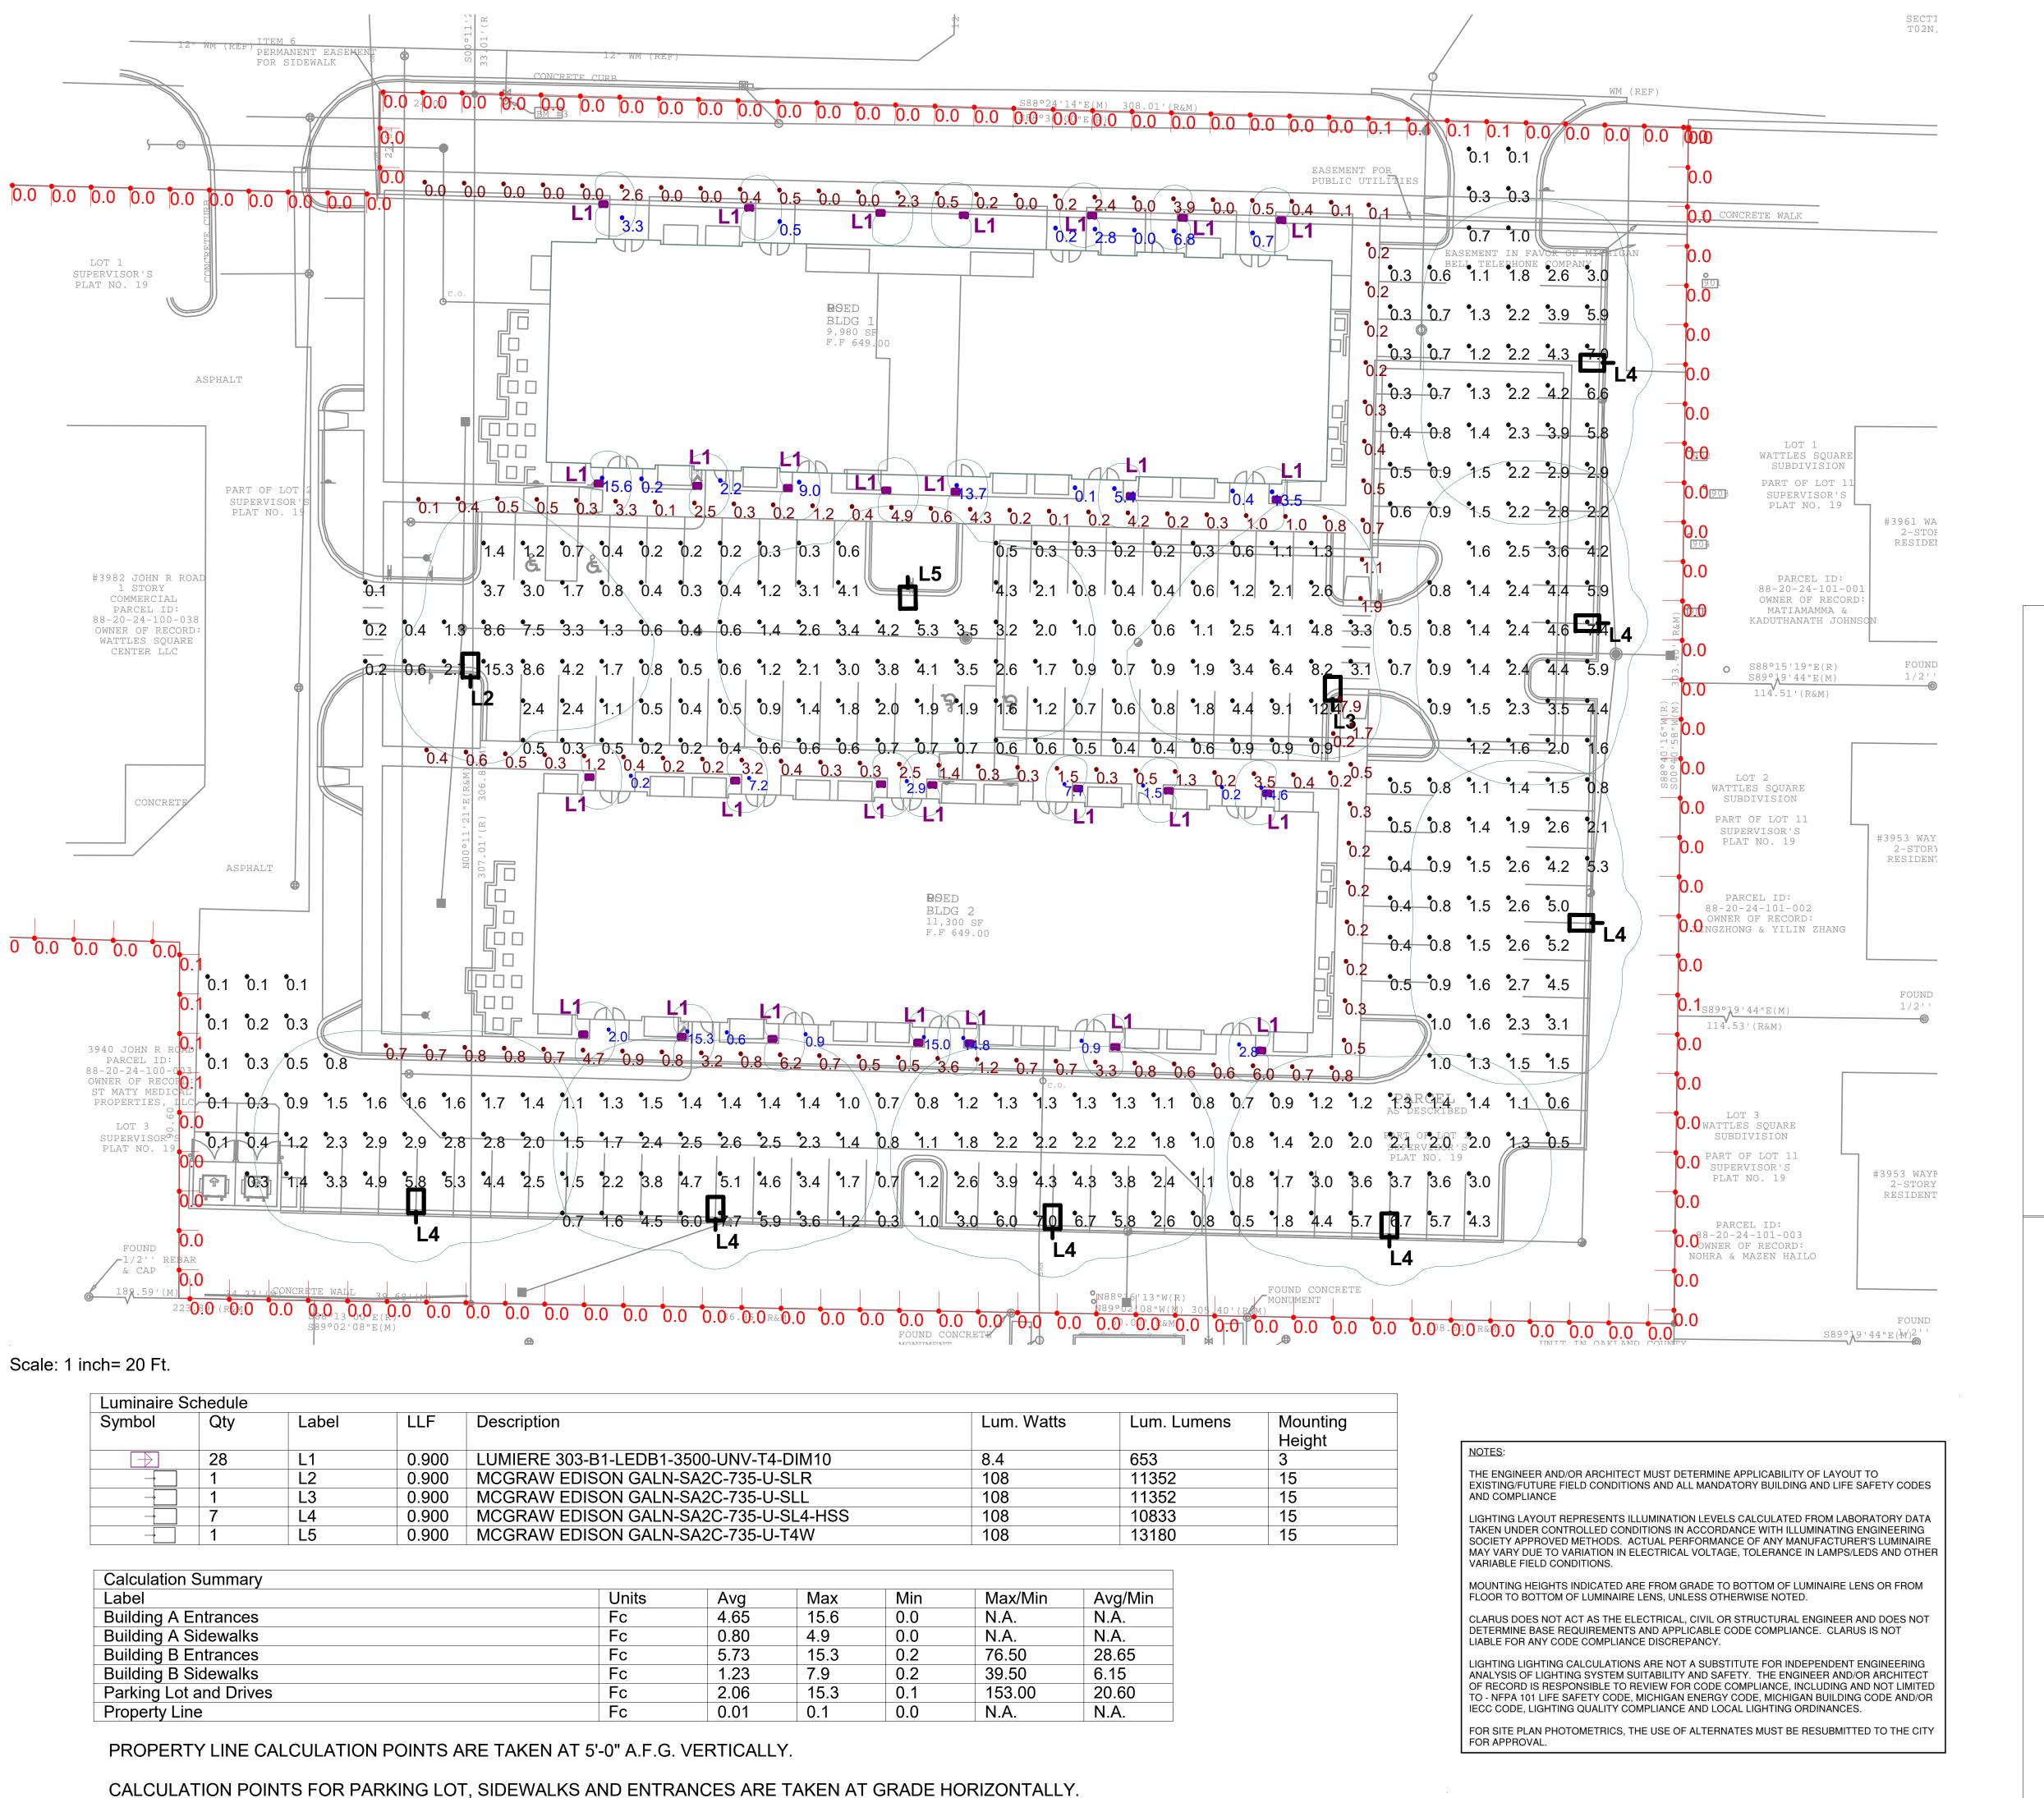

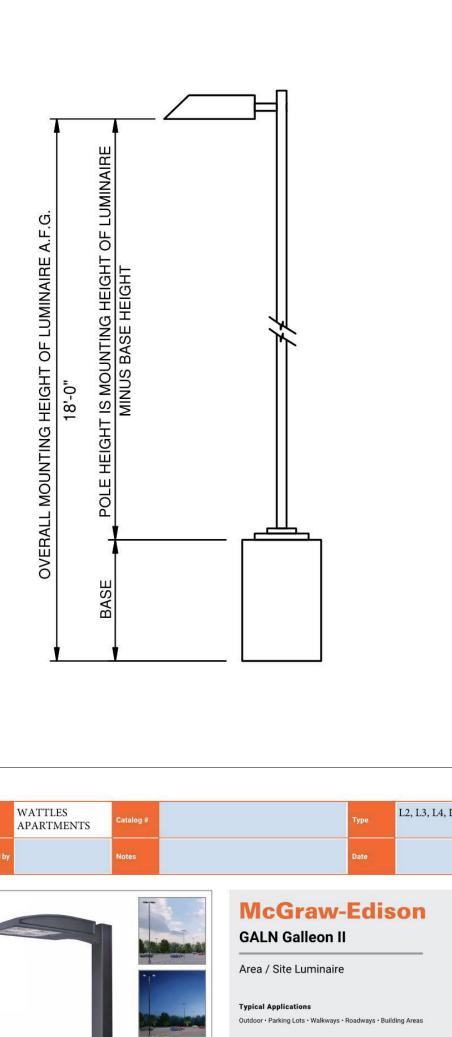



Under side profile view

O COOPER

SHEET TITLE

PROJECT TITLE

WATTLES APARTMENTS

SITE

DATE
11-15-23
PROJECT No.
CLC23-110227
SHEET No.

L201

TECHNICAL DATA 50°C Maximum Temperature Rating External Supply Wiring 90°C Minimum

> PS526023EN page 1 March 29, 2022 3 04 PM

From: <u>Fabrice Smieliauskas</u>

To: Planning

Subject: comments on Wattles Square Apartments proposal

Date: Tuesday, April 23, 2024 11:47:24 AM

You don't often get email from fab.smieliauskas@gmail.com. Learn why this is important

CAUTION: This email did not originate from within the City of Troy. Do not click links or open attachments unless you recognize the sender and know the content is safe.

Dear Planning Commission,

As you consider the proposal in front of you tonight, a few comments:

I fully support a rental, residential only project here as permitted under the current NN zoning, as serving an important need for a more affordable housing rent/price point in the city.

Please do not reject this on the grounds that the "style" of garden apartments does not suit your architectural tastes. You are not the style police -- this is not your own home. Allow the market to decide what is an attractive style for renters, which may include a value/aesthetic tradeoff that renters are willing to make to save a couple of hundred dollars on rent.

I like the repurposing of part of the vacant Rite-Aid as a community center! I have a hard time believing that the owners will be able to find another pharmacy to replace the Rite-Aid, at a time of retrenchment in the pharmacy sector. The project plan showing that the corner facing retail space will remain a pharmacy may be misleading - another use there is likely to emerge. Nonetheless, repurposing of existing buildings -- like the office-to-residential conversions occurring in our city - reduces the carbon emissions associated with new development and is environmentally sound. Applicant should receive credit for this.

Fabrice Smieliauskas

From: <u>Doriscell Drake</u>
To: <u>Planning</u>

Subject: Opposition to Proposed Apartment Complex - Zoned NN:B

Date: Tuesday, May 28, 2024 4:26:08 PM

You don't often get email from doriscell.drake@youngrembrandts.com. Learn why this is important

CAUTION: This email did not originate from within the City of Troy. Do not click links or open attachments unless you recognize the sender and know the content is safe.

To Whom It May Concern.

I am a resident of The Enclave Condominiums in Troy. I strongly oppose the building of an apartment complex in our neighborhood. It is my opinion that the existence of an apartment building would negatively impact property value as well as stabilization of our beautiful neighborhood.

Please advise if you need additional information regarding my opposition.

Doriscell Drake

2047 Applewood Drive Troy, MI 48085 From: <u>Laura Wilkins</u>
To: <u>Planning</u>

Subject: Wattles Square Apartment Complex Date: Friday, June 7, 2024 12:13:32 AM

You don't often get email from leduc.laura.24@gmail.com. Learn why this is important

CAUTION: This email did not originate from within the City of Troy. Do not click links or open attachments unless you recognize the sender and know the content is safe.

Dear Troy Planning Commission Members,

My name is Laura Wilkins and I reside in the Wattle Square Neighborhood. I am writing to you because of my strong opposition to the development of the Wattles Square Apartment Complex.

I moved into this subdivision with my husband almost ten years ago. We recently renovated our home and welcomed our two children into our family. We made the decision to stay in our current home and renovate because we absolutely love this city. We love how diverse it is, the fantastic schools, and most importantly, we love our neighbors. I often joke around to my friends that our neighborhood reminds me of an old movie where everyone knows each other and always stops to say hello. It's a neighborhood that I am extremely excited to see my children grow up in.

When I found out the news about the apartment complex, my first thought was how will this change our surrounding neighborhoods, especially our neighborhood? We are completely open to building our community and allowing others the opportunity to be able to enjoy what this great city has to offer. However, I would like it to be done in a manner that continues to build on the beauty of our surrounding neighborhoods. We took the time to research what the neighborhood nodes should consist of, and this project simply does not meet the standards that were put into the nodes plans. The neighborhood nodes were created to help build the community and bring others together. I want to know how a closed off, modern apartment complex, helps the surrounding neighborhoods and makes the community stronger?

So here's my list of questions that I have for you, that I am begging that you consider when making your final decision on this project.

Take a moment to look at the designs of this project, and think to yourself, does this truly match the character of the surrounding neighborhoods? Many of these homes were built in the 80s, so is it a good look to throw in an apartment building that looks like a shopping strip mall? According to the neighborhood nodes, the development should share common characteristics with the surrounding area and should NOT be so extreme that it overpowers the surrounding residential areas.

- There are multiple homes who will have a parking lot in their backyard. Is that a great way to meet new neighbors by watching them get in and out of their cars while hanging out in your backyard enjoying some time with your family? Would you want this in your yard? Even if you put a fence up, once again, how is that drawing in the surrounding communities? How does that respect the adjacent neighborhoods?
- The developer mentioned that there will be green spaces, but I want to quote what he said at the May 28th meeting. "There will be green spaces for the residents to use." He made mention of a community center that the "residents" will be able to use. A grill that the "residents" can use. I would like to add that this "community center" that he mentioned is the storage room of an existing hair salon that has been abandoned for ten years and will only have maybe two forms of exercise equipment for 54 units. According to the neighborhood node district, the developments are supposed to take on a social role, and be a "go to" kind of place for everyone. How does closing off the surrounding neighbors, and not providing amenities to the surrounding neighborhoods provide this as a way to build the community? Where is the common green space area for everyone, to make it a "go to" place? I could see some potential if they were going to make the commercial area a place to gather, such as a coffee shop or places to eat, but instead, they plan on leaving a super aged abandoned Rite Aid in hopes that someone will lease it. Again, how does that bring the community together?

Finally, I am an elementary teacher, so I tend to provide a lot of visuals for my students. Sometimes it can be an eye opener when you see something for yourself. I highly encourage you to get your own visual. I encourage you to try to go Southbound on John R during peak traffic hours (morning commute/5:00 pm). I already struggle to get out of our subdivision, so I will be honest, I use the neighborhood behind me to get out because of how backed up the left hand turn lane gets at Wattles and John R. Can you picture how congested that left lane will get once there are 100+ cars added into the area trying to leave for work?

In conclusion, I completely understand the need for multifamily housing and allowing others the opportunity to seek Troy as their home, but I strongly believe that this land could be developed into something that has greater potential and respects the surrounding neighborhoods.. The city shouldn't settle for something that is being thrown together and not respecting the intent of the neighborhood nodes.

Thank you so much for your time and consideration. Laura Wilkins

From: chris touma
To: Planning

Subject: Subject: Concerns regarding the proposal of Wattles Square Apartments, South side of Wattles and east of John

R (PIN 88-20-24-100-039)

Date: Tuesday, June 11, 2024 9:31:49 PM

You don't often get email from ctouma1127@yahoo.com. Learn why this is important

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Dear Members of the Troy City Planning Commission,

I am writing as a concerned resident to express my strong opposition to the planned construction of an apartment complex near my home. I urge the Planning Commission to seriously reconsider this project.

Here are my primary concerns:

- 1. **Traffic Congestion and Safety:** The proposed apartment complex will significantly increase traffic in our area. The local roads, especially at the intersection of John R Road and Wattles, are not designed to handle such an influx. This will pose safety risks to residents, particularly children who walk or bike to school and parks. The likelihood of accidents will also increase, endangering both residents and commuters.
- 2. **Privacy and Safety:** The close proximity of the proposed buildings raises significant privacy and safety issues. The increased density and height of the apartments could lead to a loss of privacy, as residents may have direct views into our homes and yards.
- 3. **Environmental Concerns:** The proposed development site includes green spaces and mature trees that are vital to the ecological health and aesthetic appeal of our neighborhood. Construction would likely lead to the loss of

these green areas, negatively impacting local wildlife and the overall environment.

- 4. **Community Character and Quality of Life:** Our neighborhood is defined by its single-family homes and a close-knit community atmosphere. The introduction of a large apartment complex is inconsistent with this character and could disrupt the sense of community that we value.
- 5. **Strain on Infrastructure and Services:** The addition of numerous new residents could strain existing infrastructure and public services, including water, sewage, and emergency services. There is concern that the current infrastructure may not support such a significant increase in population, leading to reduced service quality and longer emergency response times.

While I support responsible development within Troy, I believe this project is not suitable for the location adjacent to our neighborhood. I respectfully request that the Planning Commission reconsider the approval of this project.

Sincerely,

Chris Touma

From: paul leitheiser
To: Planning

Subject: 54 units proposed at Wattles and John R **Date:** Tuesday, June 11, 2024 5:52:49 PM

You don't often get email from pleitheiser1@att.net. Learn why this is important

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I oppose the current plan to stuffing 54 units into an Area that is 1/8 the size of my adjoining subdivision "Wattles Square" with less occupancy. I am not opposed to a more reasonable approach - less units with garages and a townhouse look or traditional houses.

Specifically I oppose current approach for these reasons

- 1. No garages theft, noise and light pollution
- 2. No setback from Wattles will look like strip mall
- 3. Garden style first floor unit split between upstairs and basement no senior would be interested in that (also all basements leak)
- 4. Flat roof not pitch like rest of housing in area
- 5. Negative Impact of increased traffic
- 6. Increased crime from a transient population

Paul Leitheiser 3897 Wayfarer Dr Troy, Mich. 48083

Pleitheiser1@att.net

Sent from AT&T Yahoo Mail for iPhone

From: COLLEEN HELMICK

To: Planning

 Cc:
 maleonard50@gmail.com;
 Paul Leonard

 Subject:
 Constructing Apartments Wattles/John R

 Date:
 Saturday, June 22, 2024 11:36:08 AM

[You don't often get email from cmhelmick@aol.com. Learn why this is important at https://aka.ms/LearnAboutSenderIdentification]

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Troy Planning Commission:

As residents of the Mt Vernon Estates subdivision, we are totally opposed to the plan to build apartments on the corner of Wattles and John R. The plan is to build 54 apartments, two 3 story buildings with 108 parking spaces, on a small 2.8 acre lot. The residents who live in the area were not made aware of this plan and have major concerns. Making this a dense residential corner, it will have a negative impact on the surrounding neighborhoods' property values, schools, traffic, and safety. It is an unsightly design, which will be sandwiched between two well designed residential neighborhoods. The nearby homeowners will be looking at a massive unsightly parking lot with no garages, trash dumpsters, and two functional buildings. There is no room for a natural fire break, and embers can travel a short distance to adjacent subdivisions. Traffic will be impossible with drivers making left turns in and out of the complex. Even if no left turn signs are installed, it won't be adhered to or enforced. It is difficult enough on that corner with Athen's High School so close.

Troy has recently built new apartments that are crammed in on most corners:

Square Lk/Dequindre
Wattles/Livernois
Big Beaver/John R
Livernois/Square Lk
Long Lk next to Ace Hardware
Currently building a large complex on Long Lk between Livernois & Rochester.

All these developments are functional complexes at best. They look unsightly, create traffic congestion, and are a negative reflection on the city. We also understand the Kelly Service building will be turned into flats, as well as, other commercial office buildings on Big Beaver. This begs the question as to why so many multi family dwellings are needed. However, the rendering of the Kelly Service building included some green space unlike all the other apartment complexes. Since the corner of Wattles/John R is a small space, why not have a small amount of condos be built around a cul-de-sac that is less dense, has greenery with landscaping, and is more appealing.

Instead of the old City of Troy motto being "The city tomorrow today," it should read "The city of unsightly apartments." The surveys conducted in recent years have shown residents want more green spaces in the city. Why do you not represent this view point. Maybe it is time to elect city officials who listen to those that they are suppose to represent.

Sincerely,

Colleen Helmick Michelle Leonard Paul Leonard From: Pete Wilkins
To: Planning

Subject: May 28th meeting follow-up

Date: Wednesday, May 29, 2024 10:27:08 PM

Attachments: image.png

image.png

Petition Cover Letter.pdf

You don't often get email from pete.wilkins.umich@gmail.com. Learn why this is important

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Hello Planning Council members,

My name is Pete Wilkins. I was the first to speak at last night's meeting regarding opposition to the proposed Wattles Square Apartments.

First, let me say thank you for giving me and my neighbor's the opportunity to speak last night. I've attached a copy of the cover letter that I handed to council member Marianna Perakis after speaking.

Also, I want to express that people's statements made in that meeting are their own. The points presented in this document is what was shared when we asked for signatures from the neighborhood. The use of the word "transient" should not be taken negatively, but only as it is defined in the dictionary, "lasting only a short time; existing briefly; temporary." I want to be clear that the statements made in this document are not discriminatory against renters but merely pointing out the role each plays in a community. Ownership means commitment whereas renting means involvement. A good parallel is marriage vs. dating.

References to safety in this document are referring to the high density of people driving in and out of such a small area. There is nothing really within walking distance, so these 100+ vehicles will be coming and going constantly. We worry about the safety of drivers and pedestrians, especially our children. To put it in perspective, the entire neighboring Wattles Square subdivision is 54 households, and we are proposing to squeeze that many households into such a small plot of land.



Speaking now for just myself, not on behalf of the residents who signed the petition, I'd like to offer a view of what I believe "good" looks like and what better matches the intent of the Neighborhood Node zoning ordinance.

I put this together rather quickly using satellite imagery of existing developments in the area.



Something like this

- Offers a good mix of building variation
- Promotes the improvement of the existing commercial space
- Lowers the density
- Allows for safe Southbound egress
- Offers good transitions to surrounding neighborhoods
- Respects privacy of abutting neighbors
- Offers attractive public space
- Preserves mature trees
- A. Multifamily residential housing (taken from The Enclave across Wattles) with a tree buffer separating neighboring residents.
- B. Higher density rental housing (taken from The Phoenix apartments at Big Beaver and John R).
- C. The existing commercial building which could be rebuilt to offer more attractive windowed shops/restaurants with the option to add more rental units above.
- D. Preserved mature greenspace with some public amenities like a pavilion and playground that could be shared by both existing and new members to the community.

We can do better than what is proposed and we can/should work together to realize the vision of what the Neighborhood Nodes were created for.

Thank you for time and consideration, Pete Wilkins 3905 Wayfarer Dr. From: Chandru Boopalam

To: <u>Planning</u>

Subject: Comments/Concerns

Date: Tuesday, May 28, 2024 6:27:31 PM

You don't often get email from boopalam@gmail.com. Learn why this is important

CAUTION: This email did not originate from within the City of Troy. Do not click links or open attachments unless you recognize the sender and know the content is safe.

To: Planning Commission - City of Troy

Subject: Concerns regarding the proposal of Wattles Square Apartments, South side of Wattles and east of John R (PIN 88-20-24-100-039)

Dear Members of Troy City Planning Commission,

I hope this letter finds you well. I am writing to express my concerns regarding the proposed development of new apartments adjacent to our neighborhood. I, along with many of our fellow neighborhood residents, have reservations about the potential impact this development could have on our community regarding privacy, safety and other areas.

I kindly request the planning commission board for a formal hearing to express my concerns.

Thank you for your attention to this urgent matter and look forward to a quick response.

Sincerely,

C.Boopalam 3894 Sandpiper Dr Troy,MI 48083 From: <u>drlemu.misc@gmail.com</u>

To: Planning

Subject: RE: Apartment Complex Planned for Wattles at John R

Date: Tuesday, May 28, 2024 7:22:51 PM

You don't often get email from drlemu.misc@gmail.com. Learn why this is important

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Greetings,

I have just become aware of planned apartment complex at Wattles and John R. I live directly across from the proposed complex (the Enclave of Troy) and would be very concerned about traffic (with such high resident density for small area) and the detrimental effect of a large Apartment complex in an established area of single-family dwellings/condos. A traffic signal would be needed at our exit (Summerfield Dr) onto Wattles – and this is a large pickup spot for school children. Please stick to the original plans of homes/condos for this site (much reduced traffic), apartments do not fit/enhance the area in anyway. Please vote AGAINST this proposal.

Thank you,
David Lemieux
2051 Applewood Dr

From: Kelly Martin
To: Planning

Subject: Kelly Martin - resident on Fairfax, Wattles Square

Date: Tuesday, May 28, 2024 4:35:36 PM

You don't often get email from carcone@gmail.com. Learn why this is important

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Dear Planning Commission:

I regret I cannot be there in person tonight, but I would like to email my thoughts to you regarding the Neighborhood Node at Wattles and John R. I've looked over the packet on the city of Troy website and I'm very much against this development. Not against the Nodes in general, but this one does not fit the criteria in any way.

Definition from the Troy Website: Neighborhood nodes are major intersections with shopping, housing, and services for nearby neighborhoods.

There is nothing in the plans of developing shopping, services, and social meeting areas within the intersection. **This is a plan for a developer to simply build apartments.** As a matter of fact, there's a plaza that sits right in front of the development that sits empty.

In addition, our traffic is already heavy trying to attempt a left out of the neighborhood, I would love to see a traffic study conducted on John R as well as Wattles, as we could have another complex built just north of Kroger.

Appreciate your time, Kelly Martin

From: Leonard Stesney
To: Planning

Subject: Apartment complex at Wattles and John Road

Date: Monday, May 27, 2024 8:42:38 PM

You don't often get email from leonardstesney@yahoo.com. Learn why this is important

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We oppose the proposed complex at Wattles and John R. There is so much traffic during the morning and afternoon that it makes it very difficult to leave the Mt Vernon sub. We are also concerned about the developers interest in the empty rite aide bldg. Leonard and Cheryl Stesney 4089 Colonial Blvd 2492406284

Sent from Yahoo Mail for iPh

From: Estates of Willowbrook HOA

To: Planning

Subject: Concerns Over "Wattles Square Apartments" Proposal

Date: Monday, May 27, 2024 6:25:32 PM

Attachments: Letter to City of Troy Planning Commission.pdf

signatures.pdf

You don't often get email from ewbhoa2020@gmail.com. Learn why this is important

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Hello there,

Some of us represented on the open agenda on 05/14 expressing our concerns regarding the proposed Wattles Square Apartments South side of Wattles and east of John R (PIN 88-20-24-100-039).

Please find the attached formal submission of concerns/issues w.r.t the proposal and the signatures of all the residents of the community who unanimously reject the proposal. Please provide us an opportunity to discuss this and call for public hearing on this matter before it is too late.

Thank you for your attention to this matter

Estates of Willowbrook HOA

From: <u>JS Sharland</u>
To: <u>Planning</u>

Subject: Proposed Apartment Complex at Wattles & John R

Date: Friday, May 24, 2024 6:44:46 PM

You don't often get email from jssharland001@gmail.com. Learn why this is important

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Dear Commissioners.....

My wife & I have lived @ 3921 Wayfarer Drive for the past 35 years. We survived (under protest) your decision to allow Mondrian Properties to literally 'clear cut' the wooded lots between John R and Wayfarer Drive and construct a 'Site Condo Development' (the Estates of Willowbrook) featuring 3000 ft2 homes that are 30 feet apart with 40 foot backyards, one of which abuts my property. That said, they are well built, higher end properties that will ultimately enhance the value of our home....so we took one for the team.

(note: we're also enduring significantly more traffic on Wayfarer Drive as you approved providing access to Wayfarer Drive from Macaw Drive in the Estates of Willowbrook development. FYI...most EoW residents cut thru the Wattle Square Sub rather than go thru the traffic light on Wattles & John R)

You are now considering approval of a plan to (again) clear cut a small wooded parcel very near my home and shoehorn a 54 unit apartment complex between Wattles Square Sub and the recently closed RITE AID. The notion that this site/property is zoned NN:B and/or the developer could argue that this proposed complex meets/exceeds any of the rather lofty Neighborhood Nodes District zoning goals delineated in the 2008 City of Troy Master Plan (e.g. serve the basic needs of the community, acts as a 21st century village center, protect & cultivate a high quality of life, will not visually overpower transitional or residential areas etc.etc) is self-serving rhetoric of the highest order. It simply doesn't. Further, it will negatively impact the current/future value(s) of the adjoining properties in both the Wattles Square and Estates of Willowbrook Subs.

PLEASE REJECT THIS PROPOSED DEVELOPMENT!

In closing, I have lived half of my life in my current home here in Troy. It's a great city. Our City leadership has been outstanding thru the years. I support the City and our leadership's vision(s) for our future.

That said, IF the Planning Commission feels compelled to accept/approve this proposal, I will (grudgingly..LoL) support your decision with one caveat that I feel BETTER SERVES our citizenry & Troy's future:

Please mandate that the proposed development be apartments for SENIORS ONLY (as in 55+).

At present, there is woefully inadequate access to housing in Troy for this growing, voting and tax paying social demographic (aka Baby Boomers like us!)

As always....thanks in advance for your support and consideration.

James & Susan Sharland 3921 Wayfarer Drive, Troy, MI 48083

email: jssharland001@gmail.com

From: Brenda Lewis
To: Planning

Subject: Proposed apartment complex, Wattles and John R Rd

Date: Monday, May 27, 2024 5:12:40 PM

[You don't often get email from brenda.lewis97@yahoo.com. Learn why this is important at https://aka.ms/LearnAboutSenderIdentification]

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Dear planning department,

I live in Troy at the Enclave of Troy at Wattles and John R.

I've been informed through people in my immediate neighborhood that two buildings with a total of 54 apartments may be built in the area of the former Rite Aid at Wattles and John R.

I can't imagine that many residences in such a small space. The traffic would be pretty horrendous if it achieved full occupancy. The traffic is already very heavy on John R and people like me with the back of our condo next to John R hear heavy, noisy traffic all day long. I already avoid sitting on my deck during morning and evening rush-hour because of the fumes and noise. If I sit out there with friends during that time, we have to shout to make ourselves heard!

Please consider how squeezing so many people in such a small space will negatively affect the quality of life in that area of Troy. I'm extremely disappointed to hear what might happen here and I plan to continue to do everything I can to stop it from negatively changing our little neighborhood.

Thank you for listening and for your service on the planning commission. Please consider my thoughts on this matter.

Sincerely, Brenda Lewis

Sent from my iPhone

From: Fred Przybysz
To: Planning

Subject: Wattles and John R proposed development

Date: Friday, May 24, 2024 8:50:56 PM

You don't often get email from przybyszfred@gmail.com. Learn why this is important

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Dear planning commission,

My name is Fred Przybysz and I would like to express my opinion on a proposed development at Wattles and John R.

I believe the proposed building of 54 apartment units on just a little over 2 acres is totally inappropriate. Originally there was a proposal to build 6 family single homes on this parcel. Going from 6 family homes to 54 apartment units will only cause overcrowding, noise, and egress problems.

When I moved to Troy 35 years ago it was claimed to be the place for families to move to.

It seems we have gotten away from that scenario in recent years.

This property could definitely have single family homes built upon.

Companies like Mondrian have certainly shown that capability.

I urge you to vote no on this proposal.

Furthermore, my neighbors and I will be attending the commission meeting on Tuesday, May 28.

Sincerely, Fred Przybysz 3842 Wayfarer Dr, Troy, MI 48083 From: <u>Yelder-Beard, Karen</u>

To: Planning

Subject: Proposed apartment complex at Wattles and John R

Date: Tuesday, May 28, 2024 10:54:19 AM

Attachments: Outlook-ji5ahazt.png

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Troy Planning Committee<

I am expressing my opposition to the proposed apartment complex at Wattles and John R. Among many concerns, the development does not respect the adjacent neighborhoods or protect and cultivate a high quality of life in Troy. I am also very concerned about traffic congestion, privacy and safety of our community.

I thank you for your consideration.

Karen Beard Agency Owner

Karen Yelder-Beard Insurance Agency 901 E Auburn Rd Rochester Hills, mi 48307 248-853-7005

kgbeard@acg.aaa.com



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From: Krystal Abiaad
To: Planning

Subject: Concerns regarding the proposal of Wattles Square Apartments, South side of Wattles and east of John R (PIN

88-20-24-100-039)

Date: Friday, June 21, 2024 11:28:47 PM

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Dear Planning Commission,

I hope this message finds you well. I am writing to express my deep concern and strong opposition to the proposed development of a new apartment complex behind my home on Wattles Road. This project, if approved, will have significant negative impacts on the local community and environment, which I believe have not been fully considered.

Firstly, the removal of the green space and mature trees that have been a part of this area for many years is deeply troubling. These trees provide essential shade and privacy, contributing to the quality of life and natural beauty of our neighborhood. Their destruction would not only diminish the aesthetic and environmental value of our community but also impact the local wildlife that depends on this habitat.

Secondly, Wattles Road is already a heavily congested one-lane road in each direction. Introducing a large apartment complex will exacerbate the traffic situation, leading to severe congestion and potential safety hazards for both residents and commuters. The existing infrastructure is not equipped to handle the increased traffic volume that this development will inevitably bring.

Moreover, the privacy of the adjacent neighborhoods is at serious risk. The proposed development would lead to a significant invasion of privacy for the current residents, disrupting the peaceful and secluded nature of our community. The planning commission's decision appears to overlook the adverse effects on the surrounding neighborhoods, focusing solely on the immediate benefits of the development.

In light of these concerns, I urge the planning commission to reconsider the approval of this apartment complex. It is crucial to take into account the long-term impacts on traffic, privacy, and environmental sustainability. I respectfully request that alternative solutions be explored that would better serve the interests of the entire community without compromising our quality of life.

Thank you for your attention to this matter. I look forward to your response and hope that our concerns will be given the consideration they deserve.

Sincerely,

Krystal Touma 2026 Osprey Dr Troy, MI 48083



ESTATES OF WILLOWBROOK SUBDIVISION OWNERS' ASSOCIATION (EWB)

2008 OSPREY

TROY MI 48083

To: Planning Commission - City of Troy

Subject: Concerns regarding the proposal of Wattles Square Apartments, South side of Wattles and east of John R (PIN 88-20-24-100-039)

Dear Members of Troy City Planning Commission,

We are writing on behalf of the Estates of Willowbrook Homeowners Association to express our collective opposition to the proposed construction of an apartment complex adjacent to our subdivision. Our community, consisting of 28 homes, has serious concerns regarding this development, and we urge the City Council/ City Planning Commission to reconsider the approval of this project.

Our primary concerns are as follows:

Traffic Congestion and Safety: The introduction of a high-density apartment complex will significantly increase traffic in our area. The roads surrounding the Estates of Willowbrook, particularly the intersection of John R Road and Wattles, are not designed to handle the additional volume of vehicles. This increase in traffic poses a safety risk to our residents, especially children

who walk or bike to the nearby schools and parks. Additionally, the higher traffic volume increases the likelihood of accidents, which could endanger both residents and commuters.

Impact on Property Values: The construction of an apartment complex adjacent to our subdivision could negatively affect property values. Our residents have invested significantly in their homes, and the presence of an apartment complex may deter potential buyers who prefer a quieter, low-density neighborhood.

Privacy and Safety: The proximity of the proposed apartment complex to our homes raises significant privacy and safety concerns. The increased density and the height of the apartment buildings could lead to a loss of privacy for our residents, as apartment dwellers may have direct lines of sight into our homes and yards. Moreover, the influx of a large number of new residents, some of whom may not be familiar with our community, could potentially increase the risk of crime and other safety issues. Maintaining the privacy and security of our neighborhood is paramount for our residents. Additionally, the safety of our children is a major concern, as the increased population and traffic could pose greater risks to their well-being while playing outside or commuting to school.

Environmental Concerns: The proposed development site is home to several green spaces and mature trees that contribute to the ecological health and aesthetic appeal of our community. The construction of the apartment complex would likely result in the loss of these green spaces, negatively impacting local wildlife and the overall environment.

Community Character and Quality of Life: Our neighborhood is characterized by its single-family homes and close-knit community atmosphere. The introduction of a large apartment complex is inconsistent with the existing character of our neighborhood and could disrupt the sense of community that our residents value highly

Potential Strain on Infrastructure and Services: The addition of a large number of new residents may strain the existing infrastructure and public services, including water, sewage, and emergency services. There is concern that our current infrastructure may not be equipped to support such a significant increase in population, which could lead to reduced service quality and increased response times for emergency services.

We understand the need for housing development and support responsible growth within Troy. However, we believe that this particular project is not suitable for the proposed location adjacent to the Estates of Willowbrook.

We appreciate your attention to our concerns and hope that the Planning Commission/City Council will take them into account when making a decision on this matter. We are willing to engage in further discussions and provide any additional information that may be required.

As stakeholders in our community, it is vital that our voices are heard, and our concerns are taken into account during the decision-making process. We request the Planning Commission/City Council board for a formal hearing to express our concerns.

Thank you for your time and consideration.

Sincerely,

ESTATE OF WILLOWBROOK OWNERS ASSOCIATION

ewbhoa2020@gmail.com

Address	Name	Signature
2018 Osprey Drive	Ton: martinovski	Fri Moth
2026 Osprey Drive	krystal Touma	Lamoni
2034 Osprey Drive	DAVID A. HOPEROH	Dula Hageross
3923 Macaw Drive	VINOD R NATLA	N. lligheddy
3931 Macaw Drive	Mahesh Patil	ACI
3939 Macaw Drive	HUMBERIO GONZALEZ	Jed.
3938 Macaw Drive	PRACHEL WU	+3m
3930 Macaw Drive	Amuradha Battula	NA
3922 Macaw Drive	ESTHER QUAN	for
3914 Macaw Drive	LIRISHNA GUDUGUM	n Krul
3906 Macaw Drive	Arun Parthusanty	Amfathratty
3898 Macaw Drive	MANJUNATH CHIKKAWNA	J.
3890 Macaw Drive	Lei Zhang	Ju Zy
3879 Macaw Drive	Keerthi Grandhapmeti	Case Car.

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Address	Name	Signature
3887 Macaw Drive	Gautham Seshadi	Goe
3895 Macaw Drive	MANISH CHANDRA	William
3903 Macaw Drive	Maheshwar Kashamoug	AMzeddy.
3911 Macaw Drive	RAJAGIOPAGAN DURAN RAJAN	X.E
3910 Sandpiper Drive	Carlos	Ala
3902 Sandpiper Drive	Saleem, Silal Liaz, Sara	Tara
3894 Sandpiper Drive	Chandrashekar Boopalam	Ololla
3886 Sandpiper Drive	RAUI BHAMIDIPATI	Bh. Rai Sow.
3878 Sandpiper Drive	Tejas Varunjikar	Tejas V
3877 Sandpiper Drive	Kalpana	9
3885 Sandpiper Drive	Kalpana Pandey Thiago, Pablsky _	Sith
3893 Sandpiper Drive	ANHONY O HAMAME	1411
3901 Sandpiper Drive	Mohit Wadhwa	Stapes
3909 Sandpiper Drive	Mary Mary	

Address	Name	Signature
2018 Osprey Drive	Toni martinovski	In Make
2026 Osprey Drive	Chris Touma	Mudde
2034 Osprey Drive	KARIN 1. HUPCROFT	Kannel Hoperofs
3923 Macaw Drive	SRIVIDYA BELLIDIGA	godyn
3931 Macaw Drive	S. R. famer Barne	SRBon
3939 Macaw Drive		
3938 Macaw Drive	Jing B zheng	Jug B Zhueg
3930 Macaw Drive	HARIBABU BATTULA	B-Hairles
3922 Macaw Drive	SONNY QUAN	Saylon
3914 Macaw Drive	SUSHMA GUDUGUNTLA	Sushma Gudagunt
3906 Macaw Drive	Manasallday	Manasa.ll
3898 Macaw Drive	Karya Chalarah	100
3890 Macaw Drive	Brendan Pan.	Brenden Pan
3879 Macaw Drive	Sandeep Puligadda	tm.

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Address	Name	Signature
3887 Macaw Drive	vidaya.	
3895 Macaw Drive	Manisha Sharan	Cha
3903 Macaw Drive	Kiranmaye Aluru	AKJ.
3911 Macaw Drive	SINDHURI KESAVA	Inthi
3910 Sandpiper Drive	Caryson Ville	
3902 Sandpiper Drive	Zaria Saleom	Zaria
3894 Sandpiper Drive	Vasudha Boopalam	VasielleB
3886 Sandpiper Drive	Udaya Bhamidipati	facilli
3878 Sandpiper Drive	Aditi Andurka	Aditi A:
3877 Sandpiper Drive	AMIT PANDEY	Algorialist,
3885 Sandpiper Drive	FABRICA Podoslay	Ju.
3893 Sandpiper Drive	MATACIE VOEEB	4/1/
3901 Sandpiper Drive	Gurnour Kaur	AN
3909 Sandpiper Drive		

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