

BUILDING CODE BOARD OF APPEALS REGULAR MEETING AGENDA

500 W. Big Beaver Troy, MI 48084 (248) 524-3344 www.troymi.gov planning@troymi.gov

Gary Abitheira, Chair, Teresa Brooks Matthew Dziurman, Sande Frisen, Chris Wilson

October 1, 2025 3:00 PM Council Chambers

- 1. ROLL CALL
- 2. <u>APPROVAL OF MINUTES</u> September 3, 2025
- 3. HEARING OF CASES:
 - A. <u>VARIANCE REQUEST</u>, 1611-1613 Livernois, Chris Corradi for Aver Signs Petitioner requests a variance to install a 50 square foot ground sign, on private property, within the planned Livernois Road right of way. Table 85.02.05 requires the sign be placed outside the planned Livernois Road right of way. The City of Troy Master Plan Thoroughfare Plan calls for 120 feet wide Livernois Road planned right of way. This means the future ½ right of way on the subject property's side would begin at the recorded Livernois Road centerline and extending 60 feet west. The survey filed with the application indicates the proposed sign will be 45 feet west of the Livernois Road centerline. This represents a 15 feet variance request. In order to grant a variance, the Board must find that all five appeals criteria of Chapter 85 Signs, Section 85.01.08, B, 1, are met.

CHAPTER 85 Signs, Table 85.02.05, NN Zoning District

B. VARIANCE REQUEST, 5027 Shady Creek, Ashley Narayanan - This property consists of a corner lot. According to the City of Troy Zoning Ordinance, it qualifies as a corner lot with front lot lines along both Shady Creek and E. Long Lake. The property is located within the R-1B zoning district which requires a front yard setback of 40 feet, along both Shady Creek and E. Long Lake, where the zoning ordinance limits fence height in the front yard to 30 inches (2.5 feet). The petitioner is seeking a fence height variance for the installation of a 6 feet high, vinyl, privacy fence. The fence is proposed to run 72 feet along E. Long Lake, outside of the 15 feet greenbelt easement, and return 31.5 feet to the south face of the house for a total variance length of 6 feet high vinyl privacy fence of 103.5 feet in the E. Long Lake designated front yard. Of the total 173.8 feet of fence requested, 70.3 feet of the fence complies with zoning regulations and does not require a variance.

CHAPTER 83 FENCE CODE

C. <u>VARIANCE REQUEST</u>, 3800 Nash, Kimberly Lappin - This property consists of a corner lot. According to the City of Troy Zoning Ordinance, it qualifies as a corner lot with front lot lines along both Nash and Jason. The property is located within the R-1C zoning district which requires a front yard setback of 30 feet, along both Nash and Jason, where the zoning ordinance limits fence height in the front yard to 30 inches (2.5 feet). The petitioner is seeking a fence height variance for the installation of 6 feet high, wood and metal, privacy fence. The fence is proposed to run 66 feet along Jason and return 28 feet to the north face of the house for a total variance length of 6 feet high wood and metal privacy fence of 94 feet in the Jason designated front yard.

CHAPTER 83 FENCE CODE

- 4. COMMUNICATIONS
- 5. PUBLIC COMMENT
- 6. <u>MISCELLANEOUS BUSINESS</u>
- 7. <u>ADJOURNMENT</u>

Chair Abitheira called the Regular meeting of the Building Code Board of Appeals to order at 3:00 p.m. on September 3, 2025 in the Council Chamber of Troy City Hall.

1. ROLL CALL

Present

Gary Abitheira
Teresa Brooks
Matthew Dziurman

Chris Wilson, Assistant City Manager

Absent:

Sande Frisen

Also Present

Salim Huerta, Building Official Dominic Abate, Residential Plans Examiner/Building Inspector Kathy L. Czarnecki, Recording Secretary

2. <u>APPROVAL OF MINUTES</u> – August 13, 2025

Moved by: Dziurman Support by: Abitheira

RESOLVED, To approve the minutes of August 13, 2025 Regular meeting as submitted.

Yes: All present (4)

Absent: Frisen

MOTION CARRIED

3. <u>HEARING OF CASES</u>

Moved by: Dziurman Support by: Brooks

RESOLVED. To reverse the cases and consider Agenda item number 3. B. first.

Yes: All present (4)

Absent: Frisen

MOTION CARRIED

B. <u>VARIANCE REQUEST</u>, 5027 SHADY CREEK, ASHLEY NARAYANAN - This property consists of a corner lot. According to the City of Troy Zoning Ordinance, it qualifies as a corner lot with front lot lines along both Shady Creek and E. Long Lake. The property is located within the R-1B zoning district which requires a front yard setback of 40 feet, along both Shady Creek and E. Long Lake, where the zoning ordinance limits fence height in the front yard to 30 inches (2.5 feet). The petitioner is seeking a fence height variance for the installation of a 6 feet high, vinyl, privacy fence. The fence is proposed

to run 72 feet along E. Long Lake and return 11.5 feet to the south face of the house for a total variance length of 6 feet high vinyl privacy fence of 83.5 feet in the E. Long Lake designated front yard. Of the total 163.8 feet of fence requested, 80.3 feet of the fence complies with zoning regulations and does not require a variance. CHAPTER 83 FENCE CODE

Mr. Abate said the homeowner is present and would like to postpone the item to the next meeting.

Ms. Narayanan approached the podium, signed in and asked to postpone the item to the next meeting.

Moved by: Dziurman Support by: Abitheira

RESOLVED, To postpone a variance request for 5027 Shady Creek to the October 1, 2025 regularly scheduled Board meeting.

Yes: All present (4)

Absent: Frisen

MOTION CARRIED

A. <u>VARIANCE REQUEST</u>, 2143 ALFRED, TYLER HIJAZI – This property is located within the R-1D zoning district which requires a front yard setback of 25 feet along Alfred. The zoning ordinance limits fence height to 30 inches (2.5 feet) within a front yard setback. The petitioner is seeking a fence height variance for the installation of a proposed new wood and mesh "Deer" fence which would be 6 feet in height and placed 1 foot away from the Alfred property line. The fence is proposed to run 30 feet along Alfred and return 24 feet back toward the house for a total variance length of 6 feet high wood and mesh "Deer" fence of 54 feet in the Alfred required front yard. Of the total 91 feet of fence requested, 37 feet of the fence complies with zoning regulations and does not require a variance. *CHAPTER 83 FENCE CODE*

Mr. Abate read the variance request narrative. He said the homeowner started construction on the fence and has been cited with an enforcement, EN2025-0058 Working Without a Permit.

Ms. Hijazi explained the circumstances why construction on the fence started. She addressed a phone conversation she had with the Building Department in which it was her understanding a permit would not be required. Ms. Hijazi submitted a petition signed by 41 neighbors in support. She addressed in detail the garden project and her plan to plant arborvitae in front of the fence for screening.

Mr. Abate said the department received no public comment from the public notice except for the signed petition the applicant submitted today.

Some comments during discussion related to the following:

- Information and pictures submitted with the request.
- Property layout.
 - Rear property could accommodate garden.
 - o Reason applicant wants garden in front yard.
- Consideration by applicant to lower the fence height.
- Variance if granted runs with the land.
- Concern in setting a precedent if variance granted.
- Consideration of conditioning approval, if granted; i.e., removal of fence upon transfer of home ownership.

Ms. Hijazi stated she does not want to lower the fence height. Her concern is that deer and vermin could jump the fence and do damage to the garden. She said she is willing to accept a condition of approval to remove the fence at her expense upon the sale of the home.

After a lengthy discussion, the Board presented an alternative fence layout that would comply with the Zoning Ordinance and require no variance.

- Install a 6 foot high fence 25 feet back from the property line, across the property to the existing chain link fence, with deer mesh.
- Install a 30 inch high fence in the front yard, in front of the 6 foot high fence, accommodating butterfly garden and other plantings.
- Existing posts could remain if railing is dropped to 30 inches.
- Arborvitae in front for screening if desired.
- Provides a safe environment for the children in the front yard.

Moved by: Brooks
Support by: Dziurman

RESOLVED, To deny a variance request for 2143 Alfred, for the following reasons:

- 1. The characteristics of the property have not shown that a variance should be supported at this time.
- 2. There are fencing alternatives that would comply with the Zoning Ordinance.

Yes: All present (4)

Absent: Frisen

MOTION CARRIED

The applicant was advised to apply for a fence permit and encouraged to work with the Building Department on specifics of the alternative design as discussed at this meeting, or potentially other fencing alternatives that would comply with the Zoning Ordinance.

4.	COMMUNICATIONS
	None.
5.	PUBLIC COMMENT
	None.
6.	MISCELLANEOUS BUSINESS
	Mr. Wilson was welcomed to the Board.
7.	<u>ADJOURNMENT</u>
	The Regular meeting of the Building Code Board of Appeals adjourned at 3:58 p.m.
Resp	ectfully submitted,
Gary	Abitheira, Chair
Kathy	L. Czarnecki, Recording Secretary
// .	

 $https://d.docs.live.net/2 f7ed 4 fe 5 f664 ea 8/Documents/Kathy/COT\ Building\ Code\ Board\ of\ Appeals/Minutes/2025/2025\ 09\ 03\ Draft.docx$

CITY OF TROY PLANNING DEPARTMENT BUILDING CODE BOARD OF APPEALS APPLICATION

CITY OF TROY PLANNING DEPARTMENT

500 W. BIG BEAVER ROAD TROY, MICHIGAN 48084 PHONE: 248-524-3364 E-MAIL: planning@troymi.gov



FEE \$500.00

NOTICE TO THE APPLICANT

REGULAR MEETINGS OF THE BUILDING CODE BOARD OF APPEALS ARE HELD ON THE FIRST WEDNESDAY OF EACH MONTH AT 3:00 P.M. AT CITY HALL.

PLEASE FILE A COMPLETE APPLICATION, TOGETHER WITH THE APPROPRIATE FEE, **NOT LESS THAN TWENTY-SEVEN (27) DAYS** BEFORE THE MEETING DATE.

COMPLETE APPLICATIONS ARE PLACED ON THE NEXT AVAILABLE AGENDA OF THE BUILDING CODE BOARD OF APPEALS.

1.	ADDRESS OF THE SUBJECT PROPERTY: 1611-1619 Livernois
	ACREAGE PROPERTY: Attach legal description if this an acreage parcel
2.	PROPERTY TAX IDENTIFICATION NUMBER(S): 60-20-20-170-057 88-20-28-478-062
3.	CODE NAME (e.g. "BUILDING CODE", "SIGN CODE", "FENCE CODE") AND SECTION(S) RELATED TO THE APPEAL:
	Troy ordinance code, Chapter 85 "Signs" 85.01.05 A
4.	REASONS FOR APPEAL/VARIANCE: On a separate sheet, please describe the reasons justifying the requested action. See Submittal Checklist.
5.	HAVE THERE BEEN ANY PREVIOUS APPEALS INVOLVING THIS PROPERTY? YES NO X

6.	APPLICANT INFORMATION:			
	NAME_Chris Corradi			
	COMPANY Aver Sign Co.			
	ADDRESS 1285 Wordsworth St			
	CITY Ferndale	STATE MI		ZIP_48101
	TELEPHONE 248 542 0678			
	E-MAIL_averpermit@aversign.com			
7.	APPLICANT'S AFFILIATION TO THE PROPERTY OW	NER: Sign contractor		
8.	OWNER OF SUBJECT PROPERTY:			
	NAME_ Kenny Koza			
	COMPANY_RW Troy Property LLC			
	ADDRESS			
	CITY	STATE		ZIP
	TELEPHONE			
	E-MAIL			
bes The app	undersigned hereby declare(s) under penalty of per t of my (our) knowledge, information and belief. applicant accepts all responsibility for all of the lication, attachments and/or plans, and the applican	measurements and dim nt releases the City of Tro	ensions	contained within this
I, _ ABC	Kenny Koza OVE STATEMENTS AND STATEMENTS CONTAINED RRECT AND GIVE PERMISSION FOR THE BOARD ME CERTAIN PRESENT CONDITIONS.	WNER), HEREBY DEPOS) IN THE INFORMATION	SUBMIT	TED ARE TRUE AND
	NATURE OF APPLICANT		_DATE_	7/22/25
PRI	NT NAME: Chris Corradi		_	
SIG	NATURE OF PROPERTY OWNER Illen		_ DATE_	7/22/25
PRII	NT NAME: Kenny Koza		_	

Failure of the applicant or his/her authorized representative to appear before the Board, as scheduled, shall be justifiable cause for denial or dismissal of the case with no refund of appeal fee(s). If the person appearing before the Board is not the applicant or property owner, signed permission must be presented to the Board.

The applicant will be notified of the time and date of the hearing by electronic mail.

Aver Sign Co.

1285 Wordsworth St

Ferndale, MI 48220

9/23/25

Troy Planning Dept/BCBA 500 W Big Beaver RD Troy, MI 48084

To Whom it May Concern:

I am writing to describe the practical difficulties we face at 1611-1613 Livernois Rd with regards to signage on-site relative to the road right-of-way.

The current ordinance calls for a 60' right-of-way setback from the recorded center of the road which would require the sign to be placed 22' inboard from the property line. This setback would essentially make any ground sign impossible as it would place the sign squarely into the parking lot of the business. Obviously, this is not a realistic location for a gas station price sign.

We would like to request that the city relax the standard setback requirement; this would allow us to install a sign in a more reasonable location closer to the road and would not block traffic in the parking lot. The parcel's border sits well within the ROW easement, and as a result compliance with the letter of the ordinance would make the required sign position unworkable. These characteristics are simply a matter of changes to the ordinance and development in the area since the parcels were laid out.

Gas stations need to be able to display their prices to passing traffic and a site without a ground sign is at a severe disadvantage. We do not believe that a building sign or canopymounted price signs would be nearly as effective as an alternative, if such alternatives are even permissible, and placing a ground sign in the middle of an active parking lot is not feasible.


Nothing about this proposal seems to negatively impact the neighbors nor the community in general; in fact, this sign is relatively modest even in relation to other signs that are within view of this site.

We respectfully request a variance in the ground sign ordinance that would allow us to erect a sign nearer to the curb, in a more traditional place for a fuel price sign. We propose a 45' setback, which would put the sign more than 5' from the property line. This would allow our client to maintain their business in a competitive environment, would not negatively impact the surroundings, and we believe this would be the minimum variation needed to accommodate the needs of the community while also satisfying the needs of the business to advertise their products and services. Thank you for your consideration.

Sincerely,

Chris Corradi

Permit agent, Aver Sign Co.

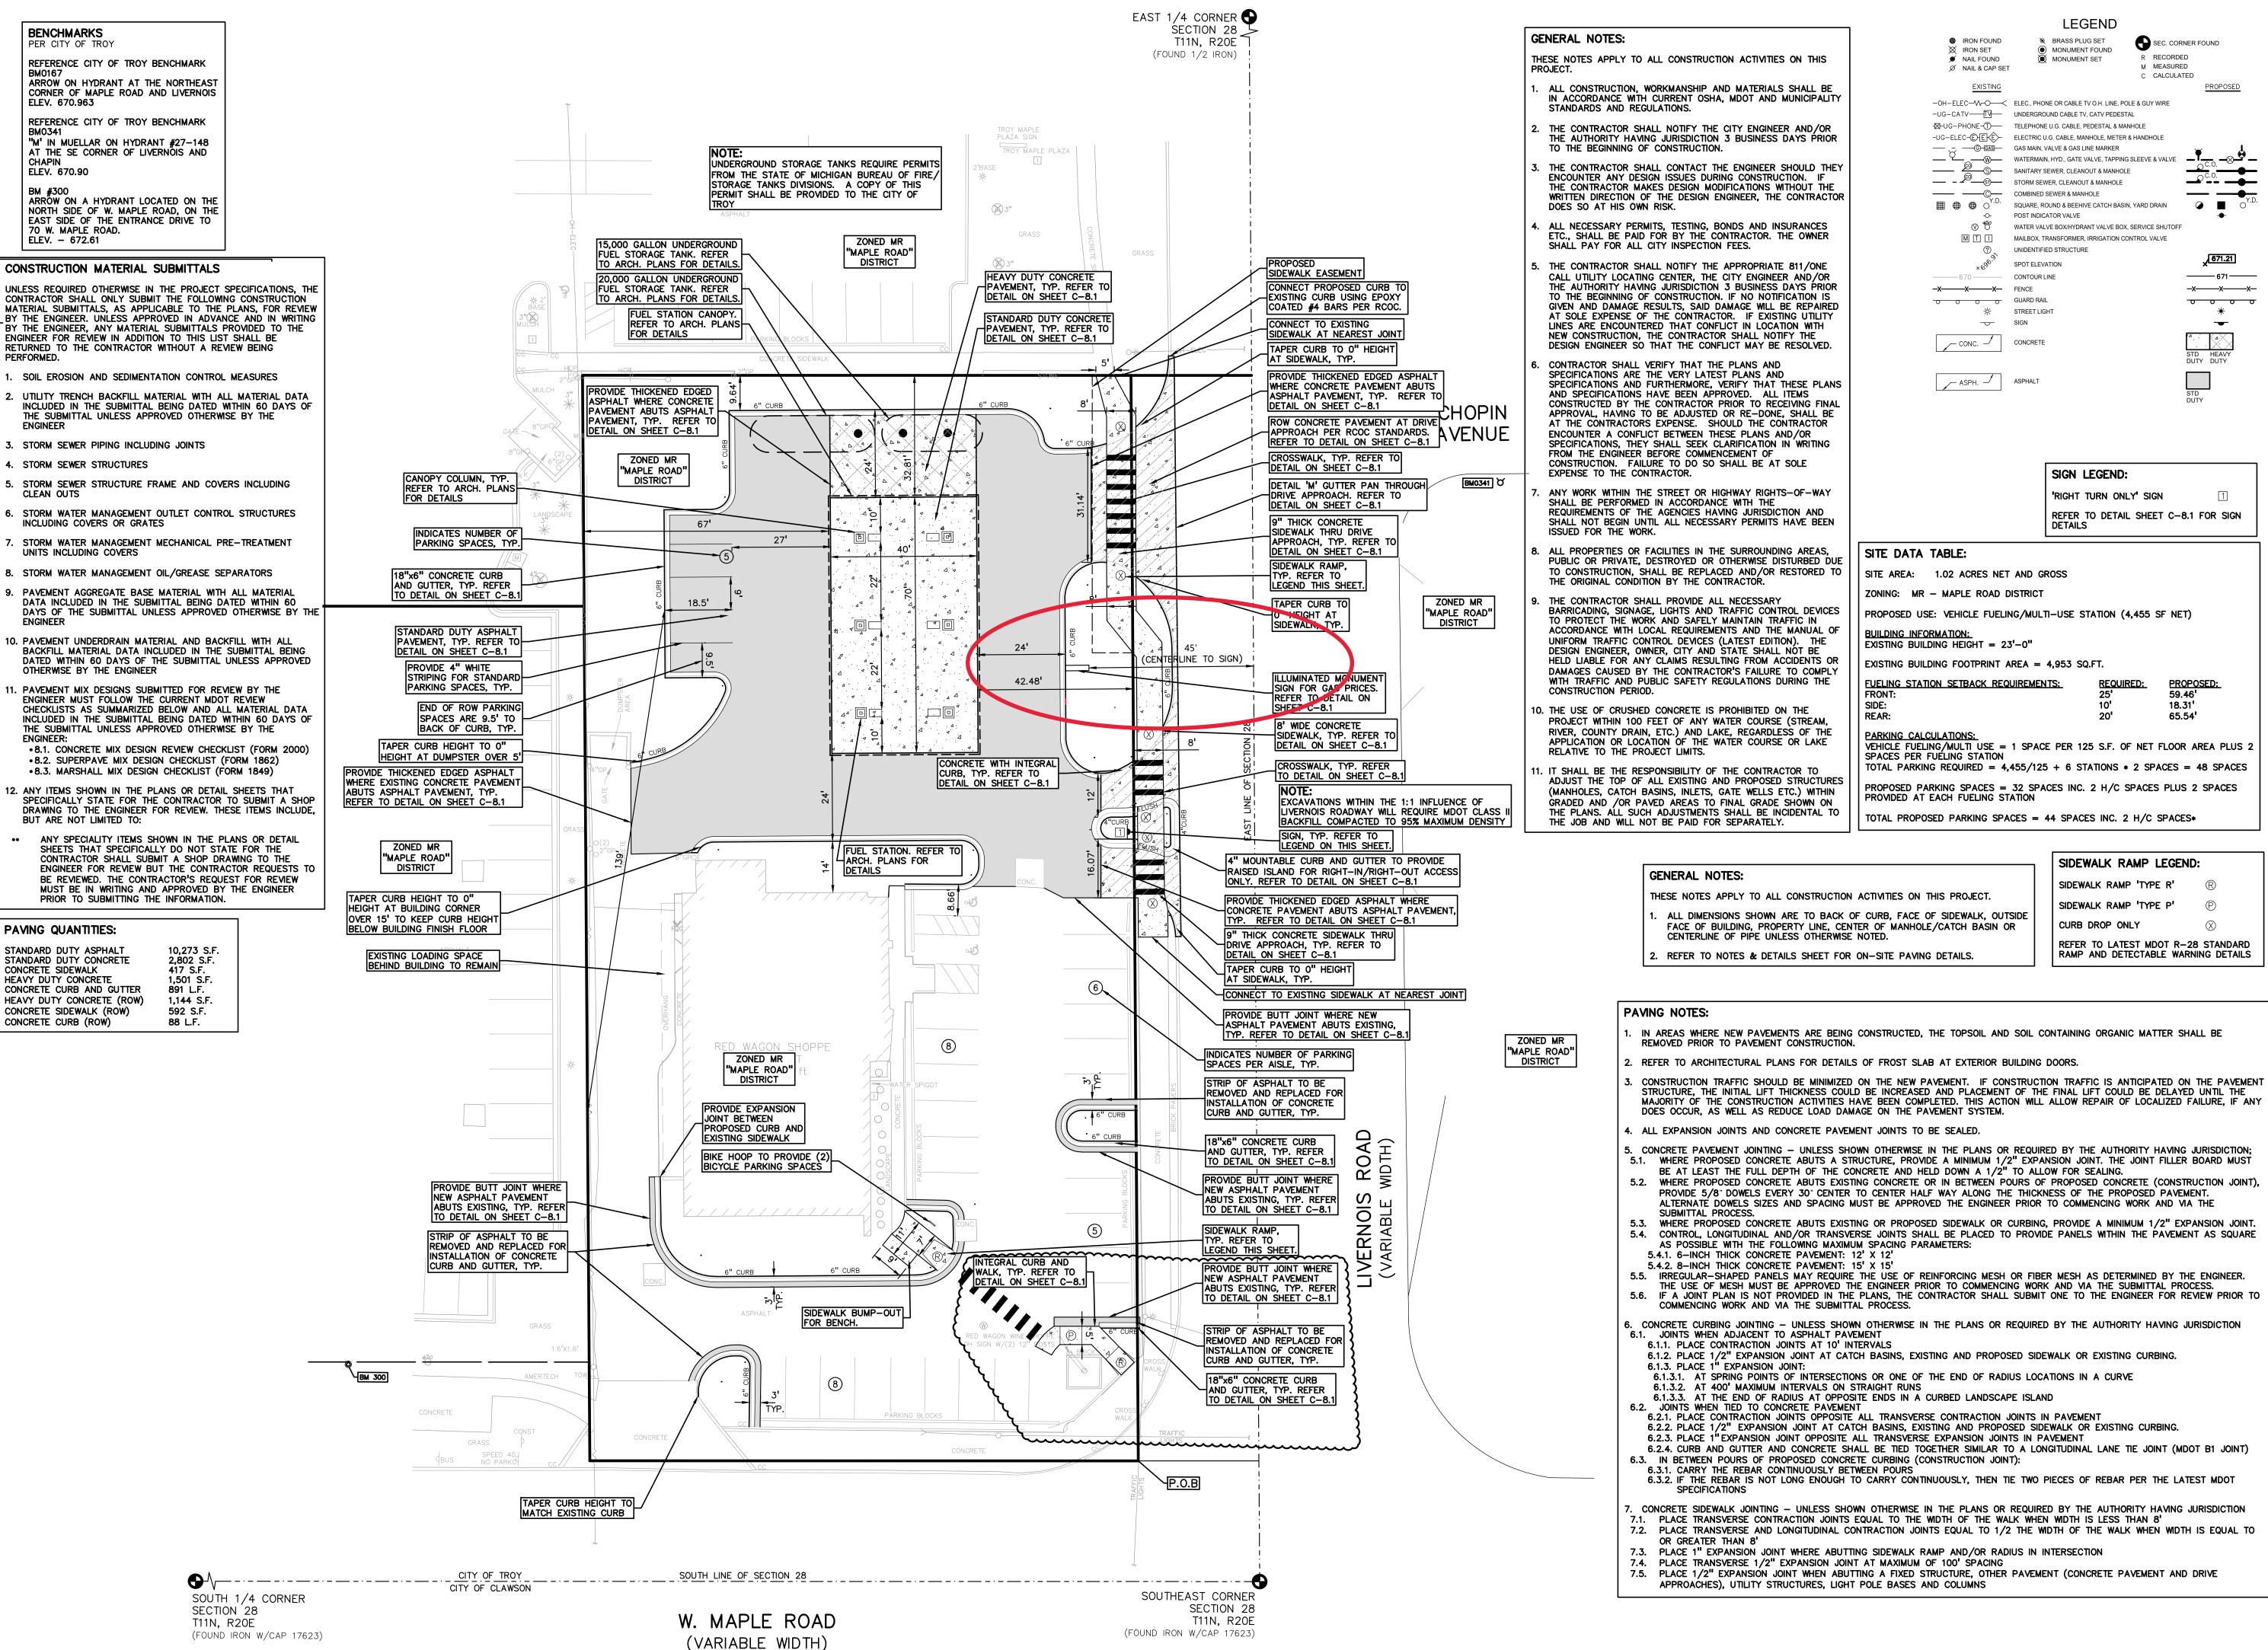

THESE NOTES APPLY TO ALL CONSTRUCTION ACTIVITIES ON THIS

- ALL CONSTRUCTION, WORKMANSHIP AND MATERIALS SHALL BE IN ACCORDANCE WITH CURRENT OSHA, MDOT AND MUNICIPALITY
- THE CONTRACTOR SHALL NOTIFY THE CITY ENGINEER AND/OR THE AUTHORITY HAVING JURISDICTION 3 BUSINESS DAYS PRIOR
- THE CONTRACTOR SHALL CONTACT THE ENGINEER SHOULD THEY ENCOUNTER ANY DESIGN ISSUES DURING CONSTRUCTION. IF THE CONTRACTOR MAKES DESIGN MODIFICATIONS WITHOUT THE
- ALL NECESSARY PERMITS, TESTING, BONDS AND INSURANCES ETC., SHALL BE PAID FOR BY THE CONTRACTOR. THE OWNER
- THE CONTRACTOR SHALL NOTIFY THE APPROPRIATE 811/ONE CALL UTILITY LOCATING CENTER, THE CITY ENGINEER AND/OR THE AUTHORITY HAVING JURISDICTION 3 BUSINESS DAYS PRIOR TO THE BEGINNING OF CONSTRUCTION. IF NO NOTIFICATION IS GIVEN AND DAMAGE RESULTS, SAID DAMAGE WILL BE REPAIRED AT SOLE EXPENSE OF THE CONTRACTOR. IF EXISTING UTILITY LINES ARE ENCOUNTERED THAT CONFLICT IN LOCATION WITH NEW CONSTRUCTION, THE CONTRACTOR SHALL NOTIFY THE DESIGN ENGINEER SO THAT THE CONFLICT MAY BE RESOLVED.
- CONTRACTOR SHALL VERIFY THAT THE PLANS AND SPECIFICATIONS ARE THE VERY LATEST PLANS AND SPECIFICATIONS AND FURTHERMORE, VERIFY THAT THESE PLANS AND SPECIFICATIONS HAVE BEEN APPROVED. ALL ITEMS CONSTRUCTED BY THE CONTRACTOR PRIOR TO RECEIVING FINAL APPROVAL, HAVING TO BE ADJUSTED OR RE-DONE, SHALL BE AT THE CONTRACTORS EXPENSE. SHOULD THE CONTRACTOR ENCOUNTER A CONFLICT BETWEEN THESE PLANS AND/OR SPECIFICATIONS, THEY SHALL SEEK CLARIFICATION IN WRITING FROM THE ENGINEER BEFORE COMMENCEMENT OF CONSTRUCTION. FAILURE TO DO SO SHALL BE AT SOLE
- ANY WORK WITHIN THE STREET OR HIGHWAY RIGHTS-OF-WAY SHALL BE PERFORMED IN ACCORDANCE WITH THE REQUIREMENTS OF THE AGENCIES HAVING JURISDICTION AND SHALL NOT BEGIN UNTIL ALL NECESSARY PERMITS HAVE BEEN
- 8. ALL PROPERTIES OR FACILITIES IN THE SURROUNDING AREAS, PUBLIC OR PRIVATE, DESTROYED OR OTHERWISE DISTURBED DUE TO CONSTRUCTION, SHALL BE REPLACED AND/OR RESTORED TO THE ORIGINAL CONDITION BY THE CONTRACTOR.
- THE CONTRACTOR SHALL PROVIDE ALL NECESSARY BARRICADING, SIGNAGE, LIGHTS AND TRAFFIC CONTROL DEVICES TO PROTECT THE WORK AND SAFELY MAINTAIN TRAFFIC IN ACCORDANCE WITH LOCAL REQUIREMENTS AND THE MANUAL OF UNIFORM TRAFFIC CONTROL DEVICES (LATEST EDITION). THE DESIGN ENGINEER, OWNER, CITY AND STATE SHALL NOT BE HELD LIABLE FOR ANY CLAIMS RESULTING FROM ACCIDENTS OR DAMAGES CAUSED BY THE CONTRACTOR'S FAILURE TO COMPLY WITH TRAFFIC AND PUBLIC SAFETY REGULATIONS DURING THE
- 10. THE USE OF CRUSHED CONCRETE IS PROHIBITED ON THE PROJECT WITHIN 100 FEET OF ANY WATER COURSE (STREAM, RIVER, COUNTY DRAIN, ETC.) AND LAKE, REGARDLESS OF THE APPLICATION OR LOCATION OF THE WATER COURSE OR LAKE
- 11. IT SHALL BE THE RESPONSIBILITY OF THE CONTRACTOR TO ADJUST THE TOP OF ALL EXISTING AND PROPOSED STRUCTURES (MANHOLES, CATCH BASINS, INLETS, GATE WELLS ETC.) WITHIN GRADED AND /OR PAVED AREAS TO FINAL GRADE SHOWN ON THE PLANS. ALL SUCH ADJUSTMENTS SHALL BE INCIDENTAL TO THE JOB AND WILL NOT BE PAID FOR SEPARATELY.

LEGEND IRON FOUND SEC. CORNER FOUND MONUMENT FOUND R RECORDED MAIL FOUND MONUMENT SET M MEASURED Ø NAIL & CAP SET C CALCULATED -OH-ELEC-V√-O ELEC., PHONE OR CABLE TV O.H. LINE, POLE & GUY WIRE -UG-CATV-TV underground cable TV, CATV PEDESTAL -UG-ELEC-E-E-E-ELECTRIC U.G. CABLE, MANHOLE, METER & HANDHOLE GAS MAIN, VALVE & GAS LINE MARKER SANITARY SEWER, CLEANOUT & MANHOLE **____** - STORM SEWER, CLEANOUT & MANHOLE COMBINED SEWER & MANHOLI

SQUARE, ROUND & BEEHIVE CATCH BASIN, YARD DRAIN

MAILBOX, TRANSFORMER, IRRIGATION CONTROL VALVE

SIGN LEGEND:

'RIGHT TURN ONLY' SIGN

REFER TO DETAIL SHEET C-8.1 FOR SIGN

PROPOSED:

65.54

WATER VALVE BOX/HYDRANT VALVE BOX, SERVICE SHUTOFF

------ 671 -----

-x----x---x-

0 0 0

POST INDICATOR VALVE

UNIDENTIFIED STRUCTURE

SPOT ELEVATION

CONTOUR LINE

STREET LIGHT

PROPOSED USE: VEHICLE FUELING/MULTI-USE STATION (4,455 SF NET)

VEHICLE FUELING/MULTI USE = 1 SPACE PER 125 S.F. OF NET FLOOR AREA PLUS 2

TOTAL PARKING REQUIRED = 4,455/125 + 6 STATIONS * 2 SPACES = 48 SPACES

PROPOSED PARKING SPACES = 32 SPACES INC. 2 H/C SPACES PLUS 2 SPACES

TOTAL PROPOSED PARKING SPACES = 44 SPACES INC. 2 H/C SPACES*

-X---X- FENCE

∕— ASPH. —

SITE AREA: 1.02 ACRES NET AND GROSS

FUELING STATION SETBACK REQUIREMENTS:

EXISTING BUILDING FOOTPRINT AREA = 4,953 SQ.FT.

ZONING: MR - MAPLE ROAD DISTRICT

EXISTING BUILDING HEIGHT = 23'-0"

SPACES PER FUELING STATION

PROVIDED AT EACH FUELING STATION

SITE DATA TABLE:



www.peagroup.com



SCALE: 1" = 20'



CAUTION!! THE LOCATIONS AND ELEVATIONS OF EXISTING UNDERGROUND UTILITIES AS SHOWN ON THIS DRAWING ARE ONLY APPROXIMATE. NO GUARANTEE IS EITHER EXPRESSED OR IMPLIED AS TO THE COMPLETENESS OR ACCURACY THEREOF. THE CONTRACTOR SHALL BE EXCLUSIVELY RESPONSIBLE FOR DETERMINING THE EXACT UTILITY LOCATIONS AND ELEVATIONS PRIOR TO THE START OF CONSTRUCTION.

RW TROY, LLC 29200 NORTHWESTERN HWY., SUITE 450 SOUTHFIELD, MICHIGAN 48034

CURB DROP ONLY REFER TO LATEST MDOT R-28 STANDARD RAMP AND DETECTABLE WARNING DETAILS

SIDEWALK RAMP LEGEND:

SIDEWALK RAMP 'TYPE R'

SIDEWALK RAMP 'TYPE P'

RED WAGON 1613 LIVERNOIS RD

CITY OF TROY, OAKLAND COUNTY, MICHIGA

PROJECT TITLE

REVISIONS CITY REVISIONS 10/22/2024 FUEL TANK REVISION 11/5/2024 1/20/2025

REVISED ENGINEERING 2/6/2025 ADDED DIMENSION 08/26/2025 REV. SIDEWALK 09/19/2025

ORIGINAL ISSUE DATE: **FEBRUARY 9, 2022**

DRAWING TITLE **DIMENSION AND PAVING PLAN**


PEA JOB NO. 2021-0438 DN. MT DES. LGD


DRAWING NUMBER:


NEW Shell 5' x 10'

MVI Monument Cabinet.

SHELL ID, 2X REGULAR, 1X DIESEL, 1X V-POWER

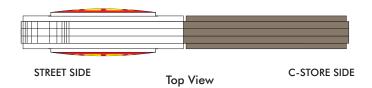

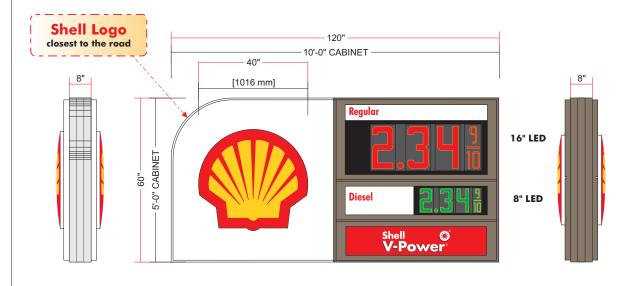

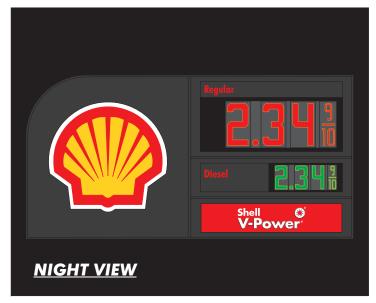

Side View

Cabinet Elevation

Side View

Scale: 1/2" = 1'



(903) 589-2100 • Fax (903) 589-2101

THIS DRAWING IS YOUR FINAL PROOF: IT SUPERCEDES ALL VERBAL AND WRITTEN COMMUNICATION. BY SIGNING BELOW YOU ARE AUTHORIZING US TO MANUFACTURE TO THE ABOVE SPECIFICATION.

Colors Depicted In This Rendering May Not Match Actual Finished Materials. Refer To Product Samples For Exact Color Match







Lafayette, LA

This original drawing is provided as part of a planned project and is not to be exhibited, copied or reproduced without the written permission of Federal Heath Sign Company, LLC or its authorized agent. © 2008

GROUND SIGN DESIGN SPECIFICATIONS:

REFER TO SIGN COMPANY'S DRAWINGS FOR MORE DETAILS. ALL DESIGNS, DETAILING FABRICATION AND CONSTRUCTION SHALL CONFORM TO:

2021 MICHIGAN BUILDING CODE

ACI

AISC


AMERICAN WELDING SOCIETY

LOCAL BUILDING CODES & ORDINANCES

- CONCRETE: 2500 PSI @ 28 DAYS
- STD. STEEL PIPE SECTION: ASTM A53 GRADE B (Fy=35 KSI), U.N.O.
- STEEL PIPE SECTION (> 20" Ø): ASTM A252 GRADE 3 (Fy=42 KSI MIN.) U.N.O.
- HSS ROUND SECTION: ASTM A500 GRADE B (Fy=42 KSI) U.N.O.
- HSS SQUARE/RECTANGULAR SECTION: ASTM A500 GRADE B (Fy=46 KSI)
- W SHAPES: ASTM A992 (Fy = 50 KSI)
- ANCHOR BOLTS: ASTM F1554 GRADE 36 U.N.O. (ALTERNATES GRADE 55 & 105)
- **CONNECTION BOLTS: ASTM A325**
- THREADED RODS: ASTM A193 GRADE B7
- STEEL ANGLES, CHANNELS, STRUCTURAL SHAPES & PLATES ASTM A36
- REINFORCING: GRADE 60 ASTM A615
- 13. PROVIDE A MINIMUM OF THREE INCHES OF CONCRETE COVER OVER EMBEDDED STEEL.
- 14. THE CONTRACTOR (INSTALLER) IS RESPONSIBLE FOR THE MEANS & METHODS OF CONSTRUCTION IN REGARDS TO JOBSITE SAFETY.
- NO FIELD HEATING FOR BENDING OR CUTTING OF STEEL SHALL BE ALLOWED WITHOUT THE ENGINEER'S APPROVAL.
- WELDING ELECTRODES: E70XX
- 17. ALLOWABLE VERTICAL SOIL BEARING PRESSURE ASSUMED: 2000 PSF
- 18. ASSUMED HORIZONTAL (PASSIVE PRESSURE) ASSUMED AT 150 PSF/FT OF DEPTH. ISOLATED LATERAL BEARING FOUNDATIONS FOR SIGNS NOT ADVERSELY AFFECTED A 1/2" MOTION AT THE GROUND SURFACE DUE TO SHORT TERM LATERAL LOADS SHALL BE PERMITTED TO BE DESIGNED USING TWO TIMES THE TABULATED CODE VALUES
- 19. ALL FOOTINGS SHALL BEAR ON FIRM UNDISTURBED RESIDUAL SOIL AND/OR ENGINEERED EARTH.
- 20. IF FILL IS PRESENT (NON-NATIVE SOIL), ENGINEERED FILL MUST BE COMPACTED TO 98% OF ITS MAXIMUM DRY DENSITY AS PER ASTM D 698-70 (STANDARD PROCTOR) UNLESS NOTED OTHERWISE. THE SOIL BEARING CAPACITY IS TO BE VERIFIED BY A GEOTECHNICAL ENGINEER PRIOR TO CONSTRUCTION. IF ALLOWABLE BEARING AND/OR LATERAL PRESSURE IS LESS THAN THE ABOVE ASSUMED AND/OR CALCULATED PRESSURES, THE ENGINEER SHOULD BE CONTACTED FOR RE-EVALUATION.
- 21. EXCAVATION SHALL BE FREE OF LOOSE SOIL BEFORE POURING CONCRETE.
- WELDERS SHALL BE CERTIFIED FOR THE TYPE OF WELDING.
- ADEQUATELY BRACE POLE(S) UNTIL CONCRETE HAS SET UP FOR 14 DAYS.
- THIS ENGINEER DOES NOT WARRANT THE ACCURACY OF DIMENSIONS FURNISHED BY OTHERS.
- ALL EXPOSED STEEL SHALL BE PAINTED WITH AN ENAMEL PAINT TO INHIBIT CORROSION.
- THIS DESIGN IS FOR THE INDICATED ADDRESS ONLY, AND SHOULD NOT BE USED AT OTHER LOCATIONS WITHOUT WRITTEN PERMISSION OF THE
- 27. DESIGN OF DETAILS AND STRUCTURAL MEMBERS NOT SHOWN, BY OTHERS.

- 1.) SEE MANUFACTURERS DRAWINGS FOR ADDITIONAL DETAILS AND DIMENSIONS.
- 2.) SIGN CABINET AND CONNECTION BY AVER SIGN COMPANY.



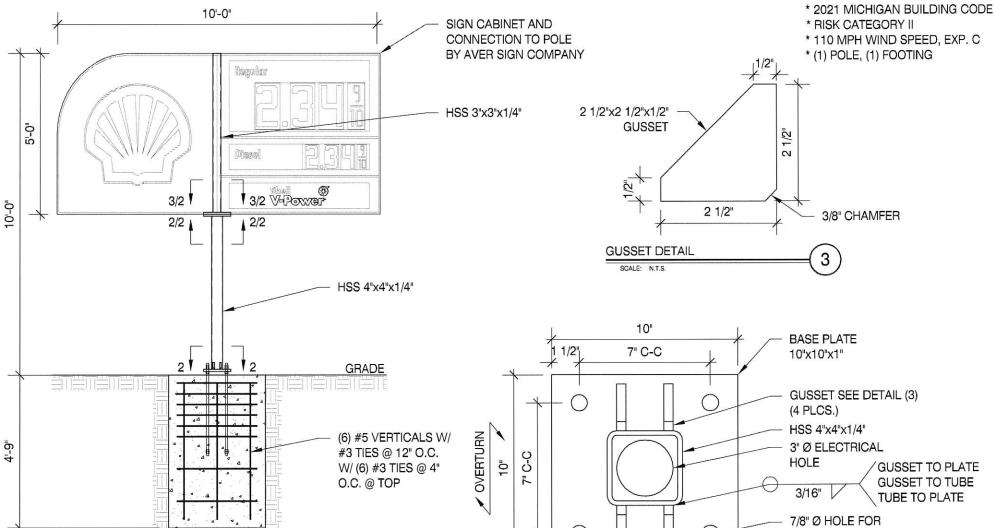



MBI COMPANIES INC.

299 N. WEISGARBER RD KNOXVILLE, TN 37919

PHONE 865.584.0999 SIGN-ENGINEER.COM PROJECT: 1613 LIVERNOIS RD, TROY, MI 48083

DRAWING TITLE:

SHELL

3'-0" Ø

FRONT ELEVATION W/ CAISSON FOUNDATION

DRAWN BY: CTP

NDB

CHECKED BY: COMM. NO.

250890-009-00

1/2

BASE PLATE DETAIL

DATE:

SCALE: N.T.S.


06/20/25 DATE REV #


DRAWING NO. DWG. DRAWN BY

2

3/4" Ø F1554 GRADE 36 A.B.

26 3/4" EMBED. (4 PLCS.)

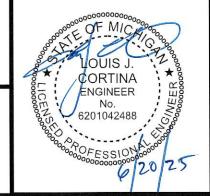

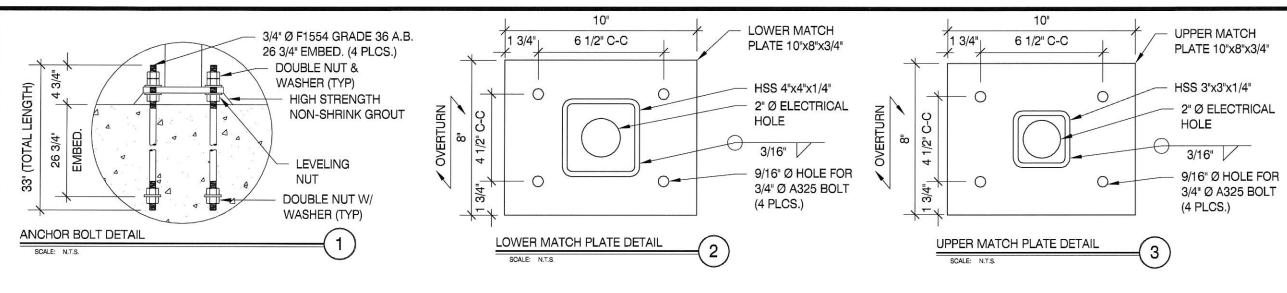

NO

- SEE MANUFACTURERS DRAWINGS FOR ADDITIONAL DETAILS AND DIMENSIONS.
- 2.) SIGN CABINET AND CONNECTION BY AVER SIGN COMPANY.
- * CLIENT AVER SIGN COMPANY
- * 2021 MICHIGAN BUILDING CODE
- * RISK CATEGORY II
- * 110 MPH WIND SPEED, EXP. C
- * (1) POLE, (1) FOOTING

WIND DATA						DEFLECTION ANALYS
Building Code	2021 Michigan	Buil-Importance Factor, I	1.0	Damping Ratio, β	0.005	Deflection Limit
Wind Load Criteria	ASCE 7-16	Directionality Factor, K _d (2)	0.85	Natural Frequency, n ₁	2.32 Hz	Deflection at 0.7*W
Wind Speed, V	110 mph	Topography Factor, K _{st}	1.0	Gust Effect Factor, G	0.85	Deflection Ratio
Exposure Category	C	Base Pressure, y(q,/K,	15.8 psf	ASD Wind Load Factor, y (3)	0.5	
Wind Donner Ornerida and		Self-cit	41-4 (41	1 d' b t b b b - b		

Notes: (1) Loading values in chart below are based upon average K, values for each segment. Actual values are calculated on hidden sheet using derived V-M equations. Chart is provided for information purposes only.

(2) Wind directionality (K_d) factor is 0.95 for Single Pole (Round) segments instead of 0.85. The C_f value

GEOMETRY INPUT (1) Monument: No from Fig. 6-21 has been increased by 0.95/0.85 to account for this variation.

No. of Po	les	 No. of Footings 		(3) Wind pressures listed below have already been multiplied by the ASD Wind Load Factor, γ.													
			Height	Width	Horiz.	Area	Тор	Centroid			Wind	Support Pole Loads			Footing Loads		
Section	Location	Type	neight	with	Offset	Alea	Elev.	Centrolu	K,	C _f	Press.	Trib.	Shear	Moment	Trib.	Shear	Moment
			ft	ft	ft	sq ft	ft	ft			psf	Factor	kips	k-ft	Factor	kips	k-ft
1	Base	Single Pole (Not Round)	5.00	0.33		1.7	5.0	2.5	0.85	1.78	20.3	1.0	0.0	0.1	1.0	0.0	0.1
2		Single Pole w/ Cabinet	5.00	9.87		49.4	10.0	7.5	0.85	1.70	19.4	1.0	1.0	7.2	1.0	1.0	7.2
		Overall Height:	10.00 ft				Sur	nmation ba	sed upor	average.	s above:		1.0	7.3		1.0	7.3
						Ac	tual base	reactions b	ased upo	n V-M ea	uations:		1.0	7.3		1.0	7.3

SUPPORT	POLE DESIGN SUMMARY	MA	TERIAL =	ST	EEL	Lacon manness areas	V. — INN			0.0000000000000000000000000000000000000					5-01089-42		Actual Control of the
Base Elev	- Action - American -		Requi	red Stren	gth Values	(ASD)	Allow	able Stren	gth Value	s (ASD)		Unity	Ratios		Interacti	ion Ratios	
Dase Liev	Section	Axis	V _r	M _r	T,	P,	V _c	M _c	T _c	Pc	V./V.	M,/M,	T _r /T _c	P./P.	P-M	P-M-V-T	Status
ft			kips	kip-ft	kip-ft	kips	kips	kip-ft	kip-ft	kips	V1/VC	IAI*\ IAIC	11/10	F,/ Fc	L-IVI	F-101-0-1	
0.00	HSS4X4X1/4	Strong	1.0	7.3	1.9	0.6	28.3	10.8	9.0	15.2	3.5%	67.6%	21.0%	3.9%	71.5%	77.5%	4
5.00	HSS3X3X1/4	Strong	1.0	2.4	1.9	0.5	19.7	5.7	4.8	38.4	4.9%	42.1%	39.0%	1.4%	43.5%	62.8%	4

ELEMENT DESIGN LOCATIONS, LOADS AND DISPLACEMENTS

Element	Elev.	Tuna	V,	M,	T _r	Pr	0.7*0	0.7*δ
ciement	ft	Туре	kips	kip-ft	kip-ft	kips	radians	in
1	0.00	Base Plate	1.0	7.3	1.9	0.6	0.0	0.0
2	5.00	Match Plate 1	1.0	2.4	1.9	0.5	0.0	0.4

PLATE DESIGN SUMMARY

Jurisdiction Requirement

			Plate Dir	nensions						Во	lts			W	/eld	
	Туре	N	В	D	t	Number	d _b	N _{edga}	B _{edge}	Circle Diamete	Material	/ Vertical Slab	Embed in	Size	Gussets	Status
		in	in	in	in		in	in	in	in		in	in	in	1	
1	Rectangular Base Plate	10	10		0.75	4	0.75	1.5	1.5	**	F1554 Grade 36	26.75	N/A	0.188	Yes	ОК
V	Match Plate 1 (Lower)	8	10	-	0.75	4	0.5	1.75	1.75		A325	++)	-	0.188	No	OK
V	Match Plate 1 (Upper)	8	10	1	0.75	4	0.5	1.75	1.75		A325	**	1	0.188	No	OK

FOUNDATION DESIGN SUMMARY

DRAWING TITLE:

SHELL

Timo	Diameter	Width	Thickness	Length	Depth	Volume	Reinforcing	Status	Allowable Soil
Туре	ft	ft	ft	ft	ft	CY	Reinforcing	Status	Pressure
✓ Caisson	3.00				4.75	1.24	(6) #5 Vert. w/ #3 Ties @ 12 in o.c. and (6) @ 4 in o.c. Top	OK	300 psf/ft



MBI COMPANIES INC.

299 N. WEISGARBER RD. KNOXVILLE, TN 37919

PHONE 865.584.0999 SIGN-ENGINEER.COM PROJECT: 1613 LIVERNOIS RD, TROY, MI 48083 DRAWN BY:

CHECKED BY: COMM. NO.

NDB 250890-009-00

1.23 in H/98

DATE: DRAWING NO.

| 06/20/25 | DWG.
| REV # DATE DRAWN BY | DATE | DRAWN BY | DATE | DRAWN BY | DR

LOUIS J.

CORTINA


ENGINEER


No.

6201042488

COPESSIONA

COPESSIO

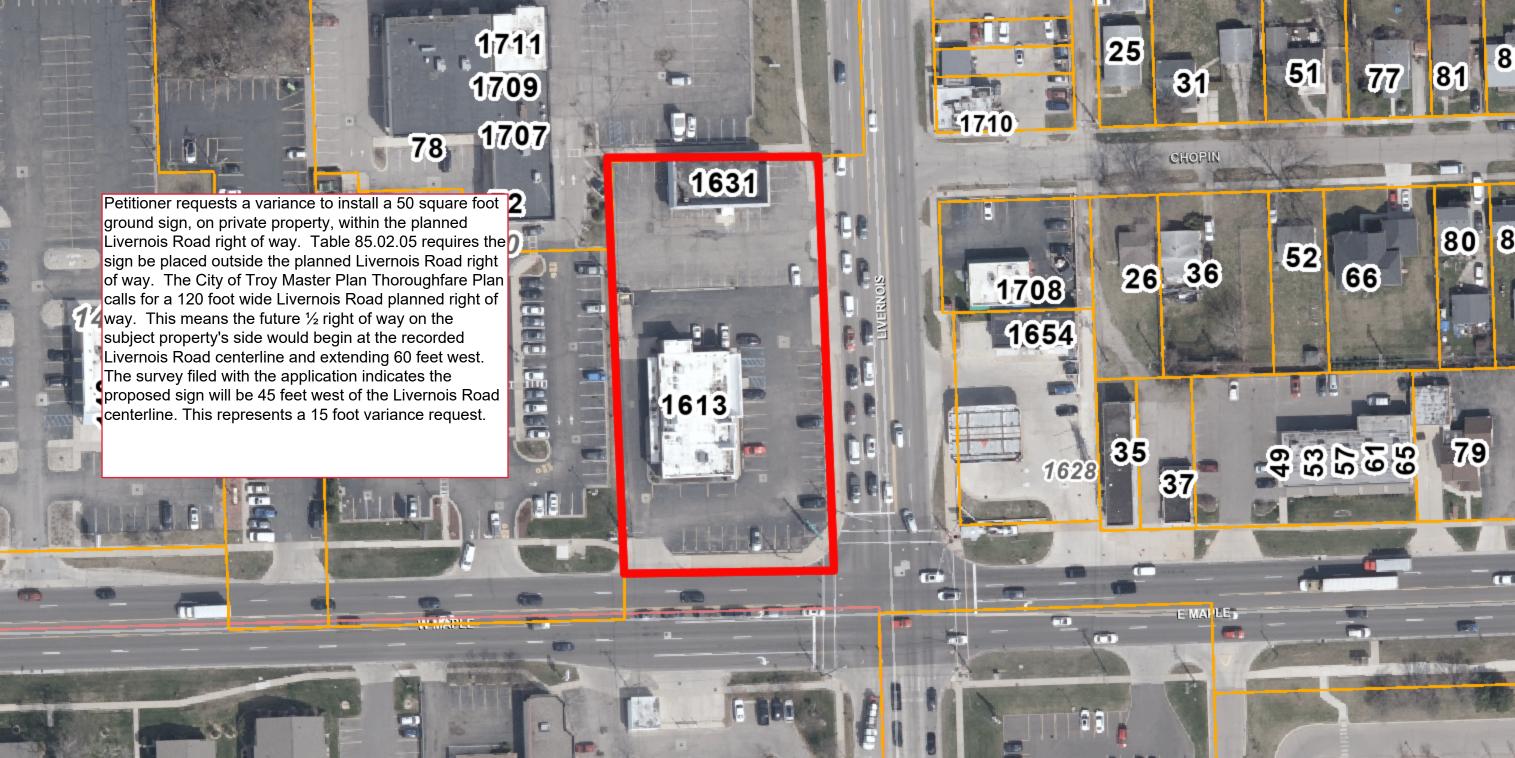

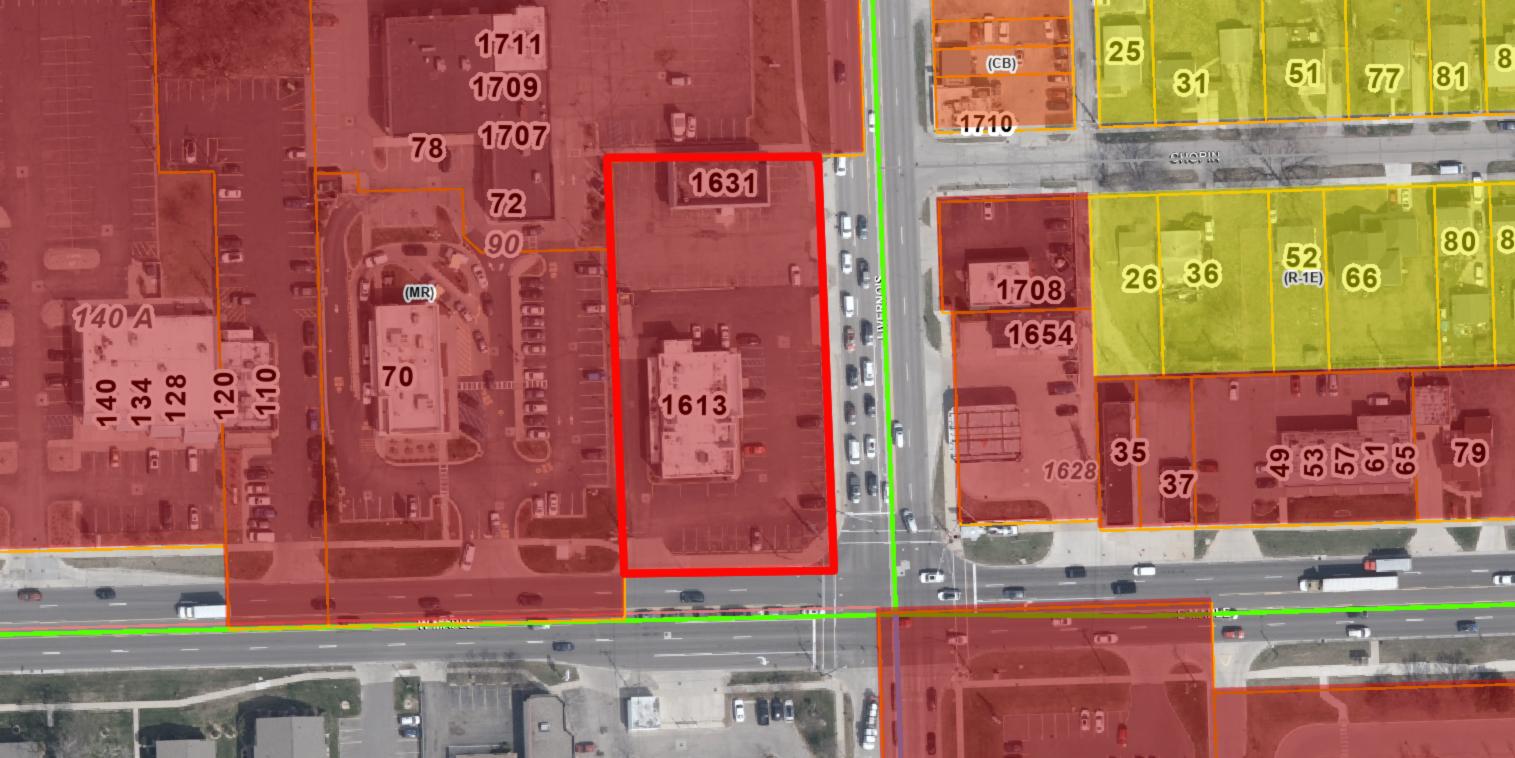

(Rev. 09-24-2018; Effective 10-01-2018)

a. One ground sign for each building in accordance with Table 85.02.06.

(Rev. 09-24-2018; Effective 10-01-2018)

b. One additional ground sign for each building, not to exceed thirty-six square feet in area if the site fronts on a major thoroughfare.

(Rev. 09-24-2018; Effective 10-01-2018)

c. Any number of wall signs, such that the total combined area of all wall signs for each tenant shall not exceed 10% of the front area of the structure or tenant area. Wall signs must be located on the face of the area that is occupied by the tenant.

(Rev. 09-24-2018; Effective 10-01-2018)

d. Interior or exterior signs, including signs affixed to windows, must comply with the Transparency Requirements of the Zoning Ordinance.

(Rev. 09-24-2018; Effective 10-01-2018)

e. One pedestrian-scaled wall sign or projecting sign per tenant, provided it does not exceed twelve square feet in area and does not project more than forty eight (48) inches from the wall.

(Rev. 09-24-2018; Effective 10-01-2018)

	TABL STANDARDS F	E 85.02.05 OR GROUND	SIGNS										
Zoning District Minimum Maximum Maximum Maximum Maximum Area													
All R and C-F	10 ft.	12 ft.	See Section 85.02.05 C (1) & 85.02.05 C (2)										
All CB, GB, BB,	Oft.	10 ft.	50 sq. ft.										
IB, MR, NN, O, R-C and-PV	20 ft.	20 ft.	100 sq. ft.										

^{*} Indicates setback from existing street right-of-way, or from planned right-of-way (as indicated in Master Thoroughfare Plan), whichever is greater.

(Rev. 09-24-2018; Effective 10-01-2018)

85.03.00 <u>General Exceptions:</u> The regulations of this Chapter shall be subject to the following exceptions.

85.03.01 Special Event Signs

(Rev. 09-24-2018; Effective 10-01-2018)

b. The characteristics which make compliance with the requirements of this Chapter difficult must be related to the premises for which the variance is sought, not some other location; and

(Rev. 09-24-2018; Effective 10-01-2018)

c. The characteristics which make compliance with the requirements of this Chapter difficult shall not be of a personal nature; and

(Rev. 09-24-2018; Effective 10-01-2018)

d. The characteristics which make compliance with the requirements of this Chapter difficult must not have been created by the owner of the premises, a previous owner, or the applicant; and

(Rev. 09-24-2018; Effective 10-01-2018)

e. The proposed variance will not be harmful or alter the essential character of the area in which the property is located, will not impair an adequate supply of light and air to adjacent property, or unreasonably increase congestion in public streets, or increase the danger of fire or endanger public safety, or unreasonably diminish or impair established property values within the surrounding area, or in any other respect impair the public health, safety, comfort, morals or welfare of the inhabitants of the City.

(Rev. 09-24-2018; Effective 10-01-2018)


2. <u>Limitation on Variances</u>: In no case shall any variance be granted that would result in a sign that exceeds the height, size, or setback provisions of this Chapter by 25% or that would increase the number of signs permitted by this Chapter by more than 25%.

(Rev. 09-24-2018; Effective 10-01-2018)

85.01.09 <u>Violations</u>

A. It shall be unlawful for any person to erect, construct, maintain, enlarge, alter, move, or convert any sign in the City of Troy, or cause or permit the same to be done, contrary to or in violation of any of the provisions of this Chapter. Any person violating any of the provisions of this Chapter shall be responsible for committing a Municipal Civil Infraction subject to the provisions of Chapter 100 of the Code of the City of Troy. Each day that a violation continues is deemed a separate Municipal Civil Infraction. Sanctions for each violation of Chapter 85 shall include a fine of not more than \$500, costs, damages and injunctive orders as authorized by Chapter 100. Any sign constituting an immediate hazard to health and safety is deemed a nuisance and may be removed by the Zoning Administrator at the expense of the owner of the sign or other responsible party, in the discretion of the Zoning Administrator.

Thoroughfare Plan

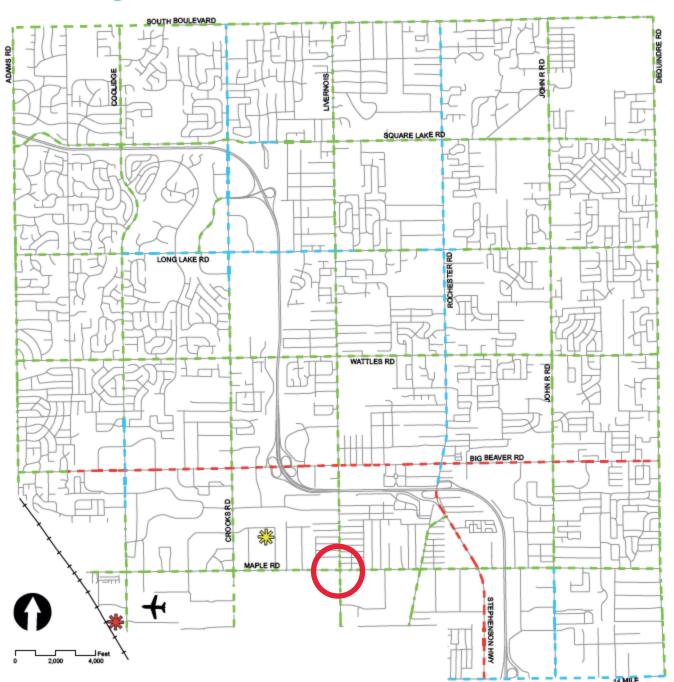

Legend

- 204 ft. R.O.W.

- - 150 ft. R.O.W.

= 120 ft. R.O.W.


Transit Center

Transit Service

← Airport

Date: May 27, 2008

Provided By: Carlisle/Wortman Assoc., Inc. Community Planners & Landscape Architects

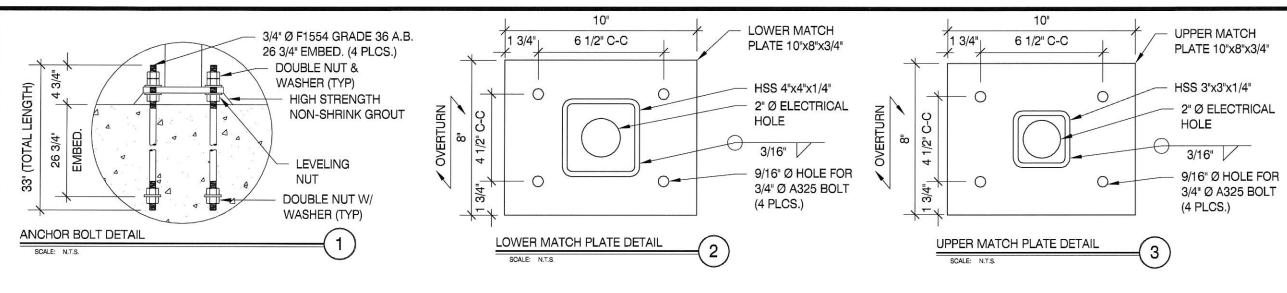

NO

- SEE MANUFACTURERS DRAWINGS FOR ADDITIONAL DETAILS AND DIMENSIONS.
- 2.) SIGN CABINET AND CONNECTION BY AVER SIGN COMPANY.
- * CLIENT AVER SIGN COMPANY
- * 2021 MICHIGAN BUILDING CODE
- * RISK CATEGORY II
- * 110 MPH WIND SPEED, EXP. C
- * (1) POLE, (1) FOOTING

WIND DATA						DEFLECTION ANALYS
Building Code	2021 Michigan	Buil-Importance Factor, I	1.0	Damping Ratio, β	0.005	Deflection Limit
Wind Load Criteria	ASCE 7-16	Directionality Factor, K _d (2)	0.85	Natural Frequency, n ₁	2.32 Hz	Deflection at 0.7*W
Wind Speed, V	110 mph	Topography Factor, K _{st}	1.0	Gust Effect Factor, G	0.85	Deflection Ratio
Exposure Category	C	Base Pressure, y(q,/K,	15.8 psf	ASD Wind Load Factor, y (3)	0.5	
Wind Donner Ornerida and		Self-cit	41-4 (41	1 d' b t b b b - b		

Notes: (1) Loading values in chart below are based upon average K, values for each segment. Actual values are calculated on hidden sheet using derived V-M equations. Chart is provided for information purposes only.

(2) Wind directionality (K_d) factor is 0.95 for Single Pole (Round) segments instead of 0.85. The C_f value

GEOMETRY INPUT (1) Monument: No from Fig. 6-21 has been increased by 0.95/0.85 to account for this variation.

No. of Po	les	 No. of Footings 		(3) Wind pressures listed below have already been multiplied by the ASD Wind Load Factor, γ.													
			Height	Width	Horiz.	Area	Тор	Centroid			Wind	Support Pole Loads			Footing Loads		
Section	Location	Type	neight	with	Offset	Alea	Elev.	Centrolu	K,	C _f	Press.	Trib.	Shear	Moment	Trib.	Shear	Moment
			ft	ft	ft	sq ft	ft	ft			psf	Factor	kips	k-ft	Factor	kips	k-ft
1	Base	Single Pole (Not Round)	5.00	0.33		1.7	5.0	2.5	0.85	1.78	20.3	1.0	0.0	0.1	1.0	0.0	0.1
2		Single Pole w/ Cabinet	5.00	9.87		49.4	10.0	7.5	0.85	1.70	19.4	1.0	1.0	7.2	1.0	1.0	7.2
		Overall Height:	10.00 ft				Sur	nmation ba	sed upor	average.	s above:		1.0	7.3		1.0	7.3
						Ac	tual base	reactions b	ased upo	n V-M ea	uations:		1.0	7.3		1.0	7.3

SUPPORT	POLE DESIGN SUMMARY	MA	TERIAL =	ST	EEL	Lacon manness areas	V 111111			1 July 11 10 Deal of the					5-01089-42	9900	ad annual annual
Base Elev	- Action - American -		Requi	Required Strength Values (ASD) Allowable Strength Values (ASD)						Unity	Ratios	Interaction Ratios					
	Section	Axis	V _r	M _r	T,	P,	V _c	M _c	T _c	Pc	V./V.	M,/M,	T _r /T _c	P./P.	P-M	P-M-V-T	Status
ft			kips	kip-ft	kip-ft	kips	kips	kip-ft	kip-ft	kips	V1/VC	IAI*\ IAIC	11/10	F,/ Fc	L-IVI	F-101-0-1	
0.00	HSS4X4X1/4	Strong	1.0	7.3	1.9	0.6	28.3	10.8	9.0	15.2	3.5%	67.6%	21.0%	3.9%	71.5%	77.5%	4
5.00	HSS3X3X1/4	Strong	1.0	2.4	1.9	0.5	19.7	5.7	4.8	38.4	4.9%	42.1%	39.0%	1.4%	43.5%	62.8%	V

ELEMENT DESIGN LOCATIONS, LOADS AND DISPLACEMENTS

Element	Elev.	Tuna	V,	M,	T _r	Pr	0.7*0	0.7*δ
Liement	ft	Туре	kips	kip-ft	kip-ft	kips	radians	in
1	0.00	Base Plate	1.0	7.3	1.9	0.6	0.0	0.0
2	5.00	Match Plate 1	1.0	2.4	1.9	0.5	0.0	0.4

PLATE DESIGN SUMMARY

Jurisdiction Requirement

		Plate Dimensions								Во	lts			Weld		
Туре		N	В	D	t	Number	d _b	N _{edge}	B _{edge}	Circle Diamete	Material	/ Vertical Slab	Embed in	Size	Gussets	Status
			in	in	in		in	in	in	in		in	in	in		
1	Rectangular Base Plate	10	10		0.75	4	0.75	1.5	1.5	**	F1554 Grade 36	26.75	N/A	0.188	Yes	ОК
V	Match Plate 1 (Lower)	8	10	-	0.75	4	0.5	1.75	1.75		A325	++)	-	0.188	No	OK
V	Match Plate 1 (Upper)	8	10	1	0.75	4	0.5	1.75	1.75		A325	**	1	0.188	No	OK

FOUNDATION DESIGN SUMMARY

DRAWING TITLE:

SHELL

Timo	Diameter Width Thicknes			Length	Depth	Volume	Reinforcing	Status	Allowable Soil	
Туре	ft	ft	ft	ft	ft	CY	Reinforcing	Status	Pressure	
✓ Caisson	3.00				4.75	1.24	(6) #5 Vert. w/ #3 Ties @ 12 in o.c. and (6) @ 4 in o.c. Top	OK	300 psf/ft	



MBI COMPANIES INC.

299 N. WEISGARBER RD. KNOXVILLE, TN 37919

PHONE 865.584.0999 SIGN-ENGINEER.COM PROJECT: 1613 LIVERNOIS RD, TROY, MI 48083 DRAWN BY:

CHECKED BY: COMM. NO.

NDB 250890-009-00

1.23 in H/98

DATE: DRAWING NO.

| 06/20/25 | DWG.
| REV # DATE DRAWN BY | DATE | DRAWN BY | DATE | DRAWN BY | DR

LOUIS J.

CORTINA

ENGINEER

No.

6201042488

COPESSIONA

COPESSIO

RESOLUTION TEMPLATE FOR DENYING SIGN ORDINANCE VARIANCE

Moved by: Seconded by:

I move the Sign Ordinance variance request for (applicant name or location)

Be denied or the following reasons:

The applicant has failed to demonstrate:

(Since an applicant has to demonstrate "all" the criteria, failure to demonstrate just one or more of the following justifies a denial. When making the motion, point out which of the following criteria have not been demonstrated and elaborate¹ as to why it was not met)

- a. Exceptional characteristics of the property for which the variance is sought make compliance with the requirements of this Chapter substantially more difficult than would be the case for the great majority of properties in the same zoning district, and/or
- b. The characteristics which make compliance with the requirements of this Chapter difficult are related to the premises for which the variance is sought, not some other location; and/or
- c. The characteristics which make compliance with the requirements of this Chapter difficult are not of a personal nature; and/or
- d. The characteristics which make compliance with the requirements of this Chapter difficult were not created by the owner of the premises, a previous owner, or the applicant; and/or
- e. The proposed variance will not be harmful or alter the essential character of the area in which the property is located, will not impair an adequate supply of light and air to adjacent property, or unreasonably increase congestion in public streets, or increase the danger of fire or endanger public safety, or unreasonably diminish or impair established property values within the surrounding area, or in any other respect impair the public health, safety, comfort, morals or welfare of the inhabitants of the City.

¹ To elaborate, point out any information presented, whether presented by the applicant, City Staff, or someone else that appeared at the meeting or provided comments, which supports the finding that the specific criterion has not been met.

RESOLUTION TEMPLATE FOR GRANTING SIGN ORDINANCE VARIANCE

Moved by: Seconded by:

I move the Sign Ordinance variance request for (applicant name or location)

Be granted for the following reason:

The applicant has demonstrated all the following:

- a. Exceptional characteristics of the property for which the variance is sought make compliance with the requirements of this Chapter substantially more difficult than would be the case for the great majority of properties in the same zoning district. (Elaborate)¹
- b. The characteristics which make compliance with the requirements of this Chapter difficult are related to the premises for which the variance is sought, not some other location; and
- c. The characteristics which make compliance with the requirements of this Chapter difficult are not of a personal nature; and
- d. The characteristics which make compliance with the requirements of this Chapter difficult were not created by the owner of the premises, a previous owner, or the applicant; and
- e. The proposed variance will not be harmful or alter the essential character of the area in which the property is located, will not impair an adequate supply of light and air to adjacent property, or unreasonably increase congestion in public streets, or increase the danger of fire or endanger public safety, or unreasonably diminish or impair established property values within the surrounding area, or in any other respect impair the public health, safety, comfort, morals or welfare of the inhabitants of the City.

¹ To elaborate, point out any information presented, whether presented by the applicant, City Staff, or someone else that appeared at the meeting or provided comments, which supports the finding.



View West into 1611 Livernois front yard



View southwest into 1611 Livernois front yard



View Northwest looking into front yard of 1611 Livernois



View South looking down Livernois



View South looking down Livernois



View North looking along Livernois



View North looking along Livernois



City of Troy 500 W Big Beaver Rd, Troy MI 48084 248-524-3344 buildinginspection@troymi.gov

FENCE PERMIT APPLICATION

NAME OF HOMEOWNE	R		CONSTRUCTION VALL	ur						
Ashley NaraYan			The control of the co							
• • • • • • • • • • • • • • • • • • • •			\$10,836.00							
and Name)	OB LOCATION (Street Number	NAME OF CITY	, VILLAGE OR TOWNSHIP IN W	HICH JOB IS						
5027 Shady Cre	ek		Troy Michigan		Oakland County					
SOLY SHOOT OF										
WHO IS THE APPLI	CANT	CONTRACTOR BUSIN	ESS NAME & LICENSEE NAME	CONTRACTOR LIC	ENSE	EXPIRATION DAT				
				NUMBER						
(Contractor)	Homeowner	AIS Installation	s / Michael Anderso	n 2102213	708	5/31/2028				
ADDRESS (Street Nur	mber and Name)	CITY		STATE		ZIP CODE				
6040 Wall St		Sterling H	eights	MI		48312				
TELEPHONE NUMBER (I	nclude area code)		EMAIL ADDRESS:	•						
(586) 274-9100	ext 1311		permits@aisoutl							
WORKERS COMPENSAT	ION INSURANCE CARRIER (or	reason for exemption)	FEDERAL EMPLOYER ID NI	UMBER (OR REASON	FOR EXEMP	PTION)				
Federated Mut	tual Insurance		20-0742530							
			12000							
Section 23a of the	state construction code	act of 1972, 1972	PA 230, MCL 125.1523a	, prohibits a perso	on from o	conspiring to				
			persons who are to pe							
The reservoir and the content of the content of the state			to civil fines. I,							
(name),	Contractor		test that the statements							
			rect description of the b							
			with the requirements ments and attestations							
125.1510(2)	under wick 125.1510(2)	to make the state	ments and attestations (contained in this	аррисаці	on under wich				
	NTRACTOR OR HOMEO	WNER (Homeown	er's signature indicates	DAT	DATE					
	ection VI. Homeowner	10.00			1					
х	10			8/4	/2025					
M	mel Clark	and a								
I hereby certify the f	ence work described on th	is permit application	shall be installed by myse	If in my own home	in which I	I am living or				
			83 of the Troy City Ordina							
			Cities Building Inspector.							
Inspector and assum	e the responsibility to arra	ange for necessary in:	spections.							
	-									
			feet of material to be u							
Type:	Wood	Wire	Metal	Masonry	Othe	er				
Symbols:	0000000	XXXXXX	///////		-					
HEIGHT						(vinyl)				
70 VA SECULATION OF STATE						6'				
NO. OF FEET						154'				
PERMIT FEEE	☑ Under 300'	\$150.00	☐ Over 300' \$200.00							
1 - 1 MINI 1	E Olider 500	ψ100.00		200.00						

SITE DRAWING REQUIRED

- A site drawing or plot plan is required for fence permit submittal.
- All drawings shall be accurate and drawn to scale.
- The location of your fence and distances to your property and lot lines are required.
- Final lot grade shall be approved before a fence permit is issued.
- Fences under seven feet do not fall under the 2015 Michigan Building Code.
- Residential Fences cannot exceed 6 feet in height.
- Your Tax Parcels Map is available here: https://cms6.revize.com/revize/citytroymi/departments/maps/index.ph

IMPORTANT INFORMATION

- It is <u>highly recommended</u> that the applicant and/or the owner hire a licensed Professional Surveyor for the proper placement of the fence.
- · All fence placement errors will be the responsibility of the applicant/owner, owner's agent, and fence company.
- · All disputes among property owners regarding the placement of a fence are a civil matter
- The City of Troy will not be inspecting for placement and the Plan Review executed by any or all staff member of the City of Troy will only be approving or disapproving based on the information submitted by the applicant and it will be limited to what is allowed to be installed per the Zoning Ordinance and City Codes.
- Fences 7 feet tall or over fall under the 2015 Michigan Building Code. A building permit will be required and permit review
 will be performed by the Building Department and the Planning Department.
- fire Department Fence Requirements: All commercial fence and/or gate projects of all heights shall be
- submitted for review to the Fire Department for emergency access to the site.
- Department of Public Works (DPW) Fence Requirements: No permit shall be issued for any fence construction within any easement without the approval of the Director of Public Works, or his authorized representative.
- The City of Troy Building Department strongly recommends that applicants check with the Home Owner's Association (HOA) for all alterations that could require approval including but not limited to, Fences, Pools, Decks, Patios, Additions, New Construction, Generators, Windows, Siding and others that could apply

APPLICANT SIGNATURE RQUIRED

В	y si	gni	ing	l am	conf	irm	ing i	hai	11	have read	and	lunc	lers	tood	a	of	the	fence	permi	t requ	uirement	s.
---	------	-----	-----	------	------	-----	-------	-----	----	-----------	-----	------	------	------	---	----	-----	-------	-------	--------	----------	----

ApplicantSignature:	W/ will	(Milani		
Approved Du			Data	

From:

<u>Dominic M Abate</u> <u>PERMITS@AISOUTLET.COM</u> Subject: plan review - 5027 Shady Creek

Wednesday, August 13, 2025 12:11:00 PM Date:


Attachments: image001.png

image002.png image003.png image004.png image005.png image006.png image007.png

Hello,

The Building Permit Application for 5027 Shady Creek has been denied as submitted for the following reason(s):

- This property requires a 40 feet setback from the Long Lake property line.
- As submitted, there appears to be 11.5 feet encroachment.
- See image below for approximate location of 40 feet required setback.

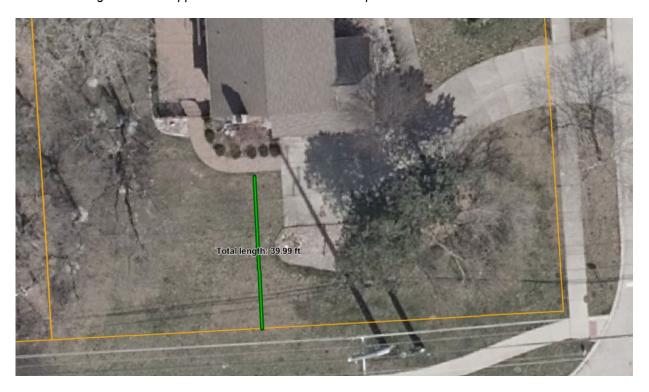

Please "reply" to this email when submitting the requested information.

Sincerely,



Dominic Abate Plans Examiner City of Troy O: 248.524.3432 F: 248.689.3120









CITY OF TROY PLANNING DEPARTMENT BUILDING CODE BOARD OF APPEALS APPLICATION

CITY OF TROY PLANNING DEPARTMENT

500 W. BIG BEAVER ROAD TROY, MICHIGAN 48084 PHONE: 248-524-3364

E-MAIL: planning@troymi.gov



FEE \$500.00

NOTICE TO THE APPLICANT

REGULAR MEETINGS OF THE BUILDING CODE BOARD OF APPEALS ARE HELD ON THE FIRST WEDNESDAY OF EACH MONTH AT 3:00 P.M. AT CITY HALL.

PLEASE FILE A COMPLETE APPLICATION, TOGETHER WITH THE APPROPRIATE FEE, **NOT LESS THAN TWENTY-SEVEN (27) DAYS** BEFORE THE MEETING DATE.

COMPLETE APPLICATIONS ARE PLACED ON THE NEXT AVAILABLE AGENDA OF THE BUILDING CODE BOARD OF APPEALS.

1.	ADDRESS OF THE SUBJECT PROPERTY: 5027 Shady Creek DY, Troy, MI 48085
	ACREAGE PROPERTY: Attach legal description if this an acreage parcel
2.	PROPERTY TAX IDENTIFICATION NUMBER(S): 88-20-10-380-035
3.	CODE NAME (e.g. "BUILDING CODE", "SIGN CODE", "FENCE CODE") AND SECTION(S) RELATED TO THE APPEAL:
	FENCE CODE, CHapter 83
4.	REASONS FOR APPEAL/VARIANCE: On a separate sheet, please describe the reasons justifying the requested action. See Submittal Checklist.
5.	HAVE THERE BEEN ANY PREVIOUS APPEALS INVOLVING THIS PROPERTY? YES NO

6.	APPLICANT INFORMAT	ION:					
	NAME Ashley	Narayanan					
	COMPANY	<u> </u>					
	ADDRESS Soa 7	shady creekdr					
	CITY Tray		STATE _	MI	ZIP	Lenge	
	TELEPHONE 99	9-737-7121		•		1000	
	E-MAIL ashley	nicole chan@gm	ouil.com	η			
7.	APPLICANT'S AFFILIAT	ION TO THE PROPERTY OWNE	<u> </u>	seiz			
8.	OWNER OF SUBJECT	PROPERTY:					
	NAME Ashley	Nevayanan					
	COMPANY						
	ADDRESS 5027 S	hody creek dy					
	CITY Troy	J		MI	ZIP	45086	
	TELEPHONE 989			•		1	
	E-MAIL ashleyn	icolechana gma	il.com				
The	undersigned hereby de	clare(s) under penalty of perjui			this application	on are true to th	e
appii	cation, attachments an	responsibility for all of the m d/or plans, and the applicant r sponsibility or liability with resp	eleases the	City of Tro	ensions conta by and its em	ained within the ployees, officer	S,
COIL	A Shey Naveu VE STATEMENTS AND RECT AND GIVE PERM ERTAIN PRESENT CON	PROPERTY OWN STATEMENTS CONTAINED IN SSION FOR THE BOARD MEMBOITIONS.	IER), HERE N THE INF BERS AND (EBY DEPOS ORMATION CITY STAFF	E AND SAY SUBMITTED TO CONDUCT	THAT ALL TH ARE TRUE AN A SITE VISIT TO	E D O
SIGN	ATURE OF APPLICANT				DATE 05	11212029	
PRIN	TNAME: Ashlee	Navayanan				7771	_
SIGN	ATURE OF PROPERTY	OWNER			DATE O	11212026	
PRIN	TNAME: Ashle	Nexceyanan				1 - (1 - +	_
iustif	iable cause for denial	is/her authorized representative or dismissal of the case with in opplicant or property owner, sign	e to appear	before the	Board, as scl		e

The applicant will be notified of the time and date of the hearing by electronic mail.

Ashley Narayanan

5027 Shady Creek Dr Troy, MI 48085 08/14/2025

To:

Zoning Board of Appeals City of Troy 500 W Big Beaver Rd Troy, MI 48084

Subject: Request for Fence Setback Variance – 5027 Shady Creek Dr

Dear Members of the Zoning Board of Appeals,

I am requesting a variance to install a fence that would encroach 11.5 feet into the required 40-foot front setback, resulting in an effective setback of 28.5 feet along the side of my home. While the fence complies with Chapter 83 – Fences in terms of height and materials, its placement is restricted by the setback requirement.

This variance is necessary due to practical difficulties related to the unique layout of the lot and the needs of our household:

- 1. Safety for children: We have a one-year-old and a newborn (born 8/18/2025). The fence is necessary to create a secure, fully enclosed yard where they can play safely, protected from street traffic and public access.
- Exercise and containment for pets: We have two dogs one 80 lb and one 10 lb
 — that require sufficient space to run, exercise, and move freely. Without this
 portion of the fence, a significant part of the yard would remain unenclosed and
 unsafe for our pets.
- 3. Privacy: The fence placement provides screening from the street and neighbors, allowing our young children to play outdoors safely while maintaining family privacy.
- 4. Noise reduction: The fence will act as a sound barrier from traffic on E Long Lake Road, reducing noise intrusion into our backyard and improving the overall living environment for our family.

The proposed fence is designed to respect the intent of Chapter 83, maintaining safe sightlines where necessary, using acceptable ornamental materials, and not obstructing any public right-of-way or easements.

Given the lot configuration and family needs, the requested variance is the minimum necessary relief to allow practical use of the yard while still adhering to the intent of the ordinance. The fence will enhance safety, security, privacy, and quality of life for our children and pets, without negatively affecting the surrounding neighborhood.

Thank you for your consideration of this request.

Sincerely, Ashley Narayanan



Fencing Quote/Specification

Home Depot License #'s - For the most current listing visit <u>www.Homedepot.com/LicenseNumbers</u>

DAVID LANZ 8667718711	8667718711			
Salesperson Name Salesperson Phone	Salesperson Phone#			
2105218410				
Registration # (Req. in CA,CT,ME,MD,MI,NJ,DC)				
Narayanan Ashley 2727		F53086123		
Customer Last Name Customer First Name Store #/Branch Name		Customer Lead/I	PO#	
5027 Shady Creek Troy		MI	48085	
Customer Address City		State	Zip	
9897377121 9897377121				
Home Phone# Work Phone# Cell Phone# Cross Street 1		Cross Street 2		
PINK = existing fencing				
E. 72	59			
GREEN = 6' tall fencing				
N G				
L A				
K I	5'gate			
E 5'gate	3 3.3			
11 5.5	3 3.3			
40' FROM THE SIDEWALK &				
52' AWAY FROM THE ROAD Driveway				
SHADY CREEK DRIVE				
299A Fencing Quote/SPEC (21 Aug. 23) (C)	Generated Date	7/31/2025 Lead	/PO# <u>F53086123</u> v 13.1.7	

= 6' Clay Vinyl Privacy Fence



Newbury (Element Reserve Rail)

AIS	White	Sand	Clay	Gray
INSTALLATIONS	\$54/ft.	\$59/ft.	\$59/ft.	\$68/ft.
4' gate	\$1,000	\$1,100	\$1,100	\$1,200
5' gate	\$1,050	\$1,150	\$1,150	\$1,250

*highlighted items are stock items in season



- 6" GlideLockTM Boards
- 5" x 5" Posts
- 0 13/4" x 7" Rails
- 8' Width Panels
- 6' Height Available











<u>Fence Height Variance Request,</u> <u>5027 Shady Creek,</u> Applicant: Ashley Narayanan

This property consists of a corner lot. According to the City of Troy Zoning Ordinance, it qualifies as a corner lot with front lot lines along both Shady Creek and E. Long Lake. The property is located within the R-1B zoning district which requires a front yard setback of 40 feet, along both Shady Creek and E. Long Lake, where the zoning ordinance limits fence height in the front yard to 30 inches (2.5 feet). The petitioner is seeking a fence height variance for the installation of a 6 feet high, vinyl, privacy fence. The fence is proposed to run 72 feet along E. Long Lake, outside of the 15 feet greenbelt easement, and return 31.5 feet to the south face of the house for a total variance length of 6 feet high vinyl privacy fence of 103.5 feet in the E. Long Lake designated front yard. Of the total 173.8 feet of fence requested, 70.3 feet of the fence complies with zoning regulations and does not require a variance.

Chapter 83 - Fences.





View West into 5027 Shady Creek front yard



View West into 5027 Shady Creek front yard along E. Long Lake



View Northwest looking into front yard abutting E. Long Lake



View Northwest looking into front yard abutting E. Long Lake



View North looking into front yard abutting E. Long Lake



View Northwest looking into front yard abutting E. Long Lake



View East looking along E. Long Lake

CITY OF TROY PLANNING DEPARTMENT BUILDING CODE BOARD OF APPEALS APPLICATION

CITY OF TROY PLANNING DEPARTMENT

500 W. BIG BEAVER ROAD TROY, MICHIGAN 48084 PHONE: 248-524-3364

E-MAIL: planning@troymi.gov



FEE \$500.00


NOTICE TO THE APPLICANT

REGULAR MEETINGS OF THE BUILDING CODE BOARD OF APPEALS ARE HELD ON THE FIRST WEDNESDAY OF EACH MONTH AT 3:00 P.M. AT CITY HALL.

PLEASE FILE A COMPLETE APPLICATION, TOGETHER WITH THE APPROPRIATE FEE, **NOT LESS THAN TWENTY-SEVEN (27) DAYS** BEFORE THE MEETING DATE.

COMPLETE APPLICATIONS ARE PLACED ON THE NEXT AVAILABLE AGENDA OF THE BUILDING CODE BOARD OF APPEALS.

1.	ADDRESS OF THE SUBJECT PROPERTY: 2800 NASH DR. TROY, MI
	ACREAGE PROPERTY: Attach legal description if this an acreage parcel
2.	PROPERTY TAX IDENTIFICATION NUMBER(S): 88-20-23-127-008
	CODE NAME (e.g. "BUILDING CODE", "SIGN CODE", "FENCE CODE") AND SECTION(S) RELATED TO THE APPEAL:
	FENCE CODE
4.	REASONS FOR APPEAL/VARIANCE: On a separate sheet, please describe the reasons justifying the requested action. See Submittal Checklist.
5.	HAVE THERE BEEN ANY PREVIOUS APPEALS INVOLVING THIS PROPERTY? YES NO

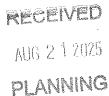

Revised 8/10/2023

о.	NAME SOME OS below	
	COMPANY	
	ADDRESS	
	CITY STATE	ZIP
	TELEPHONE	
	E-MAIL	
7.		
8.	8. OWNER OF SUBJECT PROPERTY:	
	NAME KIMBERLY LAPPIN	
	LAUVERINI	
	ADDRESS 3800 NASH DR.	
	CITY <u>Frod</u> STATE <u>M</u> , TELEPHONE <u>348-834-9365</u>	zip_ <i>482f3</i>
	TELEPHONE 348-824-9265	
	E-MAIL KLAPPINGTE GMAIL COM	
bes	The undersigned hereby declare(s) under penalty of perjury that the contents of this best of my (our) knowledge, information and belief. The applicant accepts all responsibility for all of the measurements and dimensapplication, attachments and/or plans, and the applicant releases the City of Troy	nsions contained within this
	and consultants from any responsibility or liability with respect thereto.	and its employees, officers,
ABC COF	I, KINDERLY LAPPIN (PROPERTY OWNER), HEREBY DEPOSE ABOVE STATEMENTS AND STATEMENTS CONTAINED IN THE INFORMATION SI CORRECT AND GIVE PERMISSION FOR THE BOARD MEMBERS AND CITY STAFF TO ASCERTAIN PRESENT CONDITIONS.	SUBMITTED ARE TRUE AND
	SIGNATURE OF APPLICANT Howard Rage D	DATE 8-19-25
SIG	SIGNATURE OF PROPERTY OWNER Knich Rage D	DATE 8-19-25
	PRINT NAME: KIHBERLY LAPPIN	
just	Failure of the applicant or his/her authorized representative to appear before the Bo justifiable cause for denial or dismissal of the case with no refund of appeal fee(before the Board is not the applicant or property owner, signed permission must be p	(s). If the person appearing

The applicant will be notified of the time and date of the hearing by electronic mail.

SUBMITTAL CHECKLIST FOR APPEALS NOT RELATED TO SIGNS

FOR SIGNS, PLEASE USE SUBMITTAL CHECKLIST ON NEXT PAGE

REQUIRED	PROVIDED	
\boxtimes		COMPLETED APPLICATION.
		1 COPY OF SUPPORTING DOCUMENTS DESCRIBING THE REQUEST, CONSTRUCTION AND/OR WORK INCLUDING BUT NOT LIMITED TO:
	() ()	PLOT PLANS DRAWN TO SCALE, SHOWING THE SHAPE AND DIMENSION OF LOT(S). LOCATION ON THE LOT OF FENCES, OR OTHER STRUCTURES CONCERNING THE REQUEST. DETAILED PLANS SHOWING CONSTRUCTION MATERIALS AND METHOD OF CONSTRUCTION. PHOTOS, DRAWINGS, OR RENDERINGS AS NECESSARY TO ACCURATELY DESCRIBE THE REQUEST.
		ANY ADDITIONAL INFORMATION INCLUDING REPORTS OR ACCREDITED TESTING AGENCIES, INCLUDING ACCREDITED AGENCIES RECOGNIZED BY THE INTERNATIONAL CODE COUNCIL (ICC) AND ACCEPTED ENGINEERING PRACTICES SHOULD ACCOMPANY YOUR APPEAL.
	a	1 COPY OF INFORMATION THAT CLEARLY EXPLAINS THE IMPACTS OF THE REQUEST ON THE AREA.
		A WRITTEN EXPLANATION OF THE REASONS JUSTIFYING THE REQUEST. IF APPEALING AN ICC CONSTRUCTION CODE, PLEASE EXPLAIN ALTERNATIVES THAT WOULD BE EQUAL TO WHAT THE CODE REQUIRES.
\boxtimes	0	MINIMUM SIZE OF ALL DOCUMENTS 8.5" X 11".
		A DIGITAL VERSION OF ALL APPLICATION DOUCUMENTS. E MAILING THEM TO THE DEPARTMENT IS PREFERRED.

yand setbook for your property, which is zoned R-IC, is 30 feet.

LOT LINE: ... In the case of a corner hat, both lines separating said but from the street shall be considered from het lines....

ity of Troy zoeing ordinance Chapter 83 - fences:

- s in testidential areas separating properties shall be of an ornamental type. Such feaces may be constructed of metal, wood or masonry,
- r material, at such material as found to be structurally acceptable to the Chief Building Inspector, shall be used. In residential areas....
- shall be constructed to a height of more than thirty (10°) inches above the existing grade of the land in that portion of the property in front
- est building setback line The maximum heights requirements of this section may be waived with the approval of the Building Board of Appeals (application utached).

eply all" when submitting the requested information.

ncerely,



Dominic Abate Plans Examiner City of Troy

O: 248.524.3432

F: 248.689.3120











BCBA Application.pdf

588 KB



To Whom It May Concern,

This letter is in reference to the concern of a privacy fence being installed at 3800 Nash Dr. Troy, Mi. 48083.

The original fence was built with a permit before 2004. The original panels remained up all through the construction of the new panels using the original posts. No posts were removed. The new panels were stick built inside of the original posts moving the fence towards the back yard 2.5 inches and dropping the height by 2 inches.

The new panels cannot be physically removed without destroying them, causing a \$2000 loss. (it was stick built between the original posts).

The old panels were old, unsightly, and falling apart to the point of injuring someone if one happened to break off a post.

The intention and thoughts were the original structure was grandfathered into the property when I purchased the property in 2004. This is why the original posts were used. If the fence has to be moved to 30 feet, this will significantly effect a storage shed located in the back yard and 20-year-old bushes and shrubs that are permanently attached to the inside of the fence panels, by means of flower boxes.

If any adaptations need to be made, perhaps we can take down the 2 corner panels and rebuild 2nd post to 2nd post at the driveway for better sight at drive, which has never been a problem. The two corner panels are the only place where there are no flower boxes. This would be a \$300 dollar loss instead of \$2000 plus.

This original fence was never a problem until it started deteriorating on the panels. It was unsightly and dangerous.

Again, we did not change the original structure, did not increase the height, width or length of the fence at all. By building the fence inside the yard, we even were able to move the fence panels back 2.5 in. from its original position inside the yard.

It is no longer unsightly or dangerous. People stop by daily to express their likes of the new fence. It is decorative, modern and is a pleasant view for those who pass by.

The dotted line on plot plan shows where corner could be changed, if necessary.

Photos will show construction of the new fence, (including the old fence standing), as it was built within the confines of the back yard.

The newly installed fence being moved would mean all posts removed, losing new fence panels, losing all flower boxes, (secured to posts), all shrubs, and the

storage shed would have to be torn down because it would be outside of dimensions.











<u>Fence Variance Request,</u>
<u>3800 Nash,</u>
Applicant: Kimberly Lappin

This property consists of a corner lot. According to the City of Troy Zoning Ordinance, it qualifies as a corner lot with front lot lines along both Nash and Jason. The property is located within the R-1C zoning district which requires a front yard setback of 30 feet, along both Nash and Jason, where the zoning ordinance limits fence height in the front yard to 30 inches (2.5 feet). The petitioner is seeking a fence height variance for the installation of 6 feet high, wood and metal, privacy fence. The fence is proposed to run 66 feet along Jason and return 28 feet to the north face of the house for a total variance length of 6 feet high wood and metal privacy fence of 94 feet in the Jason designated front yard.

Chapter 83 - Fences.





Front view of 3800 Nash



View of intersection of Nash and Jason




View East looking at 3800 Nash front yard along Jason



View South looking at 3800 Nash from Jason



View South looking at 3800 Nash from Jason

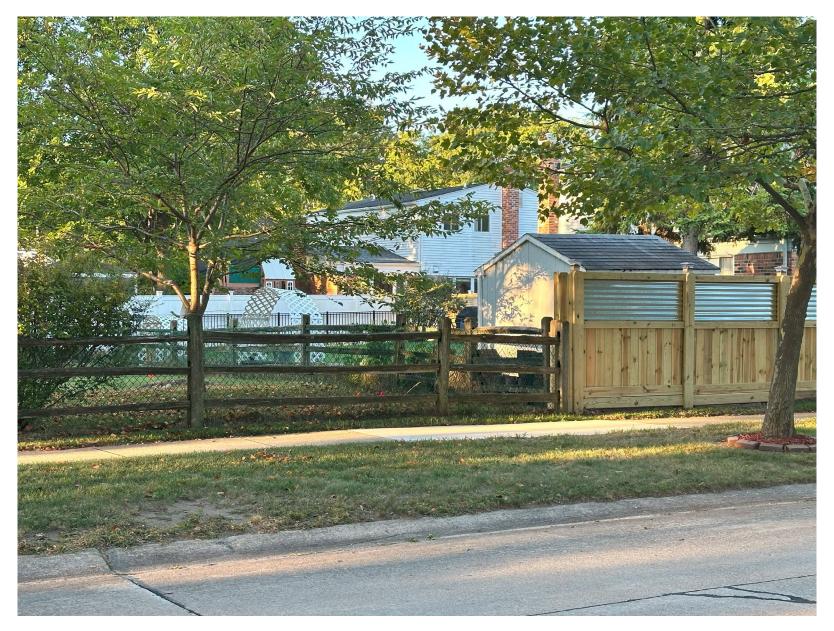

View into 3800 Nash rear yard