

CITY COUNCIL AGENDA ITEM

Date: March 8, 2022

To: Mark F. Miller, City Manager

From: Robert J. Bruner, Assistant City Manager

R. Brent Savidant, Community Development Director

Subject: PUBLIC HEARING - CONDITIONAL REZONING- (CR JPLN2021-001) - Proposed

Pine View Condominiums, West side of Dequindre, north of Long Lake (88-20-12-476-070), Section 12, From NN (Neighborhood Node "J" and EP (Environmental Protection) to

NN (Neighborhood Node "J").

The applicant GFA Development, Inc. seeks a conditional rezoning of the subject parcel from NN (Neighborhood Node "J") and EP (Environmental Protection) to NN (Neighborhood Node "J"). The applicant provided a complete Preliminary Site Plan application as a condition of approval, along with other conditions listed in the application.

The Planning Commission considered a Preliminary Site Plan application for a by-right 25-unit townhome development at the November 12, 2019 Regular meeting. At that meeting the Planning Commission appeared generally in favor the development. The applicant expressed a desire to use the 40-foot wide EP portion of the site for guest parking and additional landscaping. The Planning Commission discussed the item and postponed the item "to allow the developer ample time to consider all the opinions and ideas expressed by the Commission".

The applicant submitted a Conditional Rezoning application to rezone the EP area along the north to NN, with a 25-unit townhome development (the same number of units proposed in 2019). The area rezoned from EP to NN would be utilized for guest parking and increased landscape materials. The Planning Commission considered the conditional rezoning application at a public hearing on August 24, 2021. The recommendation of denial received a 4-4 vote. The recommendation of approval also received a 4-4 vote. A City Council public hearing was scheduled for September 27, 2021. On the day of the City Council public hearing, the applicant requested that the application be sent back to Planning Commission for reconsideration.

The Planning Commission considered the conditional rezoning application at a public hearing on October 26, 2021. The Planning Commission recommended approval of the application by a 7-2 vote.

A City Council public hearing has been scheduled for March 14, 2022.

Attachments:

- 1. Agenda packet from October 26, 2021 Planning Commission Regular meeting.
- 2. Minutes from October 26, 2021 Planning Commission Regular meeting.
- 3. Conditional Rezoning Agreement (draft).

DATE: October 21, 2021

TO: Planning Commission

FROM: R. Brent Savidant, Community Development Director

SUBJECT: <u>CONDITIONAL REZONING- (CR JPLN2021-001)</u> – Proposed Pine View Condominiums,

West side of Dequindre, north of Long Lake (88-20-12-476-070), Section 12, From NN (Neighborhood Node "J" and EP (Environmental Protection) to NN (Neighborhood Node

"J").

The applicant GFA Development, Inc. seeks a conditional rezoning of the subject parcel from NN (Neighborhood Node "J" and EP (Environmental Protection) to NN (Neighborhood Node "J"). The applicant provided a complete Preliminary Site Plan application as a condition of approval, along with other conditions listed in the application. The Planning Commission is a recommending body for this application.

This item was considered by the Planning Commission on August 24, 2021. At that meeting, the vote on the motion to approve was 4-4. The vote on the motion to deny was 4-4. The item was placed on the September 27, 2021 City Council meeting for consideration. The applicant requested to be removed from the City Council agenda so that he could go back before the Planning Commission for reconsideration. Nothing has changed in the application from August 24, 2021. The applicant confirmed the exact height of the 3-story buildings to be 35' 4".

One of the residents who spoke at the public hearing referred to crashes at the entry drive to this site. The entry drive was constructed in 2006. Crash data was provided by the Transportation Improvement Association for the period of January 1, 2000 through December 31, 2006 and the period of January 1, 2007 through August 31, 2021.

The attached report prepared by Carlisle/Wortman Associates, Inc. (CWA), the City's Planning Consultant, summarizes the project. CWA prepared the report with input from various City departments including Planning, Engineering, Public Works and Fire. City Management supports the findings of fact contained in the report and the recommendations included therein.

Attachments:

- 1. Maps
- 2. Memo prepared by Carlisle/Wortman Associates, Inc., dated October 15, 2021
- 3. Report prepared by Carlisle/Wortman Associates, Inc., dated October 19, 2021
- 4. Minutes from November 12, 2019 Planning Commission meeting (excerpt)
- 5. Minutes from August 24, 2021 Planning Commission meeting (excerpt)
- 6. Minutes from September 27, 2021 City Council meeting (excerpt)
- 7. Anticipated Traffic Impacts, Memo prepared by OHM dated September 16, 2021
- 8. Crash data, 01-01-2000 to 12-31-2006, provided by TIA
- 9. Crash data, 01-01-2007 to 08-31-2021, provided by TIA
- 10. Preliminary Site Plan

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595

GIS Online



0 297 595 Feet

Note: The information provided by this application has been compiled from recorded deeds, plats, tax maps, surveys, and other public records and data. It is not a legally recorded map survey. Users of this data are hereby notified that the source information represented should be consulted for verification.

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Note: The information provided by this application has been compiled from recorded deeds, plats, tax maps, surveys, and other public records and data. It is not a legally recorded map survey. Users of this data are hereby notified that the source information represented should be consulted for verification.



117 NORTH FIRST STREET SUITE 70 ANN ARBOR, MI 48104 734.662.2200 734.662.1935 FAX

To: Troy Planning Commission

Brent Savidant, AICP

From: Ben Carlisle, AICP

Date: October 15, 2021

RE: Pineview Conditional Rezoning

The application for the Pineview conditional rezoning was recently considered by the Planning Commission on August 24, 2021. At that meeting Planning Commission held a public hearing and had a lengthy discussion on:

- EP, Environmental Protection zoning district; uses, zoning tool to separate incompatible land uses.
- Landscaping buffer, amenity to application.
- Maintenance of EP, Environmental Protection zoning district strip of land.
- Height of surrounding residential homes.
- Shared driveway with Taco Bell; as relates to traffic, cross access easement.
- Elevations; garage and interior entrance on same side.
- Property to the north; open space, potential headlight shining on residential.
- Existing concrete wall at Taco Bell; applicant prefer trees and landscape.
- Proposed fence on south side; material and height.
- Guest parking; no requirement to provide, good design consideration, appropriate screening for headlights
- Maintenance responsibility of property to north.
- Pedestrian sidewalk as relates if EP, Environmental Protection zoning district stays in place.
- Density; building height, building form.
- Potential traffic congestion with shared access.
- Intent of applicant with by-right development on southern portion.
- Type of desired housing; results of Master Plan survey.

After the public hearing and discussion, there was a motion to recommend denial of the conditional rezoning. The vote to recommend denial failed 4-4. There was a follow-up motion to recommend approval. The vote to recommend approval failed 4-4.

Pineview Conditional Rezoning October 15, 2021

The failed motions, minutes, and planning report were forwarded to the City Council. However, prior to City Council consideration, the applicant pulled their application from City Council and asked to be reconsidered by the Planning Commission.

The applicant has confirmed the height of the structures at 3 stories or 35'4".

The applicant is requesting to come back to the Planning Commission for further consideration, hopefully before a full Commission.

CARLISLE/WORTMAN ASSOC., INC. Benjamin R. Carlisle, LEED AP, AICP

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117 NORTH FIRST STREET SUITE 70 ANN ARBOR, MI 48104 734.662.2200 734.662.1935 FAX

Date: November 5, 2019 August 16, 2021 October 19, 2021

Conditional Rezoning and Preliminary Site Plan Review For City of Troy, Michigan

Applicant: GFA Development

3301 Mirage Drive Troy, MI 48083

Project Name: Pineview

Plan Date: September 18, 2019

Location: West side of Dequindre Road between 18 Mile Road and English

Drive

Zoning: EP, Environmental Protection

Neighborhood Node (NN) - J

Action Requested: Conditional Rezoning and Preliminary Site Plan Approval

SITE DESCRIPTION

The subject site is located on the west side of Dequindre Road between 18 Mile Road and English Drive. The site is 2.39 acres and is vacant, undeveloped property. There is a 40-foot wide strip of EP, Environmental Protection zoned property. The applicant is seeking to conditionally rezone the EP portion of the site to NN, in order to use that strip as landscaping, and provide guest parking.

A site plan application was previously reviewed by the Planning Commission. At that meeting the Planning Commission appeared generally in favor the development but the applicant noted

a desire to use the EP portion of the site for guest parking. It was noted that EP zoning did not allow parking. The item was postponed to allow the applicant to submit a conditional rezoning application to rezone the EP portion of the site.

The applicant proposes to landscape, install underground detention, put a sidewalk, and put guest parking within the currently EP zoned portion of the site. There is already a 60' storm drain and a concrete screenwall within the area zoned EP. These items will remain. The remaining (all of the building area) area of the property is zoned Neighborhood Node (NN).

The applicant proposes two different building types. The buildings in the interior are narrower and provide for a front porch and entrance. The exterior buildings have a front entrance on the garage elevation and an elevated deck on the rear elevation.



Figure 1: 60-inch drain

The applicant proposes to develop the site as twenty-five (25) attached townhomes, accessed by an existing shared access drive with Taco Bell off of Dequindre road. The buildings are proposed to have individual, direct unit access from the proposed interior drive. At the center of the development, twelve (12) of the units will have pedestrian access to a pedestrian circulation area and courtyard. All proposed townhomes are two (2) stories, accompanied by a 2-car garage.

Multiple family residential is a permitted use in the NN. An aerial image of the subject site, with a zoning districts overlay, is provided in *Figure 1*.



Figure 1. Subject Site

Size of Subject Property:

The parcel is 2.389 net acres

Proposed Uses of Subject Parcel:

Twenty-five (25) attached townhomes

<u>Current Use of Subject Property</u>:

The subject property is currently unimproved and vacant.

Current Zoning:

The property is currently zoned NN, Neighborhood Node District

<u>Surrounding Property Details:</u>

Direction	Zoning	Use
North	R1-C, Single Family	Single Family Residential
South	NN, Neighborhood Node	Neighborhood Commercial
East	NN, Neighborhood Node	Neighborhood Commercial
West	R1-C, Single Family	Single Family Residential

VOLUNTARY REZONING CONDITIONS

Voluntary conditions offered by the applicant include:

- 1. Site Plan as a condition of approval
- 2. Screen wall and trees adjacent to Taco Bell shall remain.
- 3. Development shall be limited to a maximum of 7-buildings and 25 total units.
- 4. Maximum building height shall be 3-story or 35'4" in height.
- 5. Minimum guaranteed open space shall be 15%
- 6. Minimum guaranteed landscape area shall be 15%
- 7. Building material shall be a mix of brick, asphalt shingles, plank siding, with variety of color palates and durable low-maintenance or maintenance free materials
- 8. Each unit shall have a 2-car garage. A minimum of 10-guest parking spaces shall be provided
- 9. No exterior refuse containers shall be proposed. Individual waste and recycling containers shall be stored in each unit's garage and placed at the curb on collection days
- 10. Minor modifications to the site plan shall be permitted and administratively approved by the Planning Director. Minor changes would not adversely or substantially affect the conditions of the rezoning.

Items to be addressed: A conditional rezoning agreement between the City and the applicant will be required prior to City Council consideration.

NATURAL FEATURES

Topography: A topographic survey has been provided on sheet C-1.0 and shows that the

site has a generally flat landscape.

Wetlands: There are no wetlands on site.

Floodplain: There are no floodplains onsite.

Woodlands: The applicant has identified a total of 23 regulated trees on the site. Of

the trees surveyed, 1 is a landmark tree and 22 are woodland trees. The

applicant is preserving 21 of the 22 woodland trees.

Replacement Details		
Protected Tree	Inches Removed	Replacement Required
Landmark	22 inches	22 inches
Woodland	6 inches	3 inches

Preservation/Mitigation	Inches Preserved	Credit
Landmark	0 inches	0 inches
Woodland	197 inches	394 inches
Protected Replacement Required	25 Inches	
Preservation Credit	394 Inches	
Total	+ 369-inch credit	
Total Tree Mitigation	Zero. The number o	f inches preserved and
	credited exceed the	mitigation required.

Items to be addressed: None.

BUILDING ARRANGEMENT

The site configuration consists of twenty-five (25) townhomes in five clusters of three homes, one cluster of four homes, and a row of six homes. The clusters are configured around a central courtyard with pedestrian sidewalks connecting to a "meandering" sidewalk, through the currently EP zoned portion of the site, that provides access to the east and Dequindre Road. We find the proposed configuration suitable for the type and size of the development proposed.

Items to be addressed: None.

AREA, WIDTH, HEIGHT, SETBACKS

Table 5.03.B.3, Building Form C of Section 5.03, Standards Applicable to All Districts of the Zoning Ordinance establishes the dimensional requirements for the NN, Neighborhood Node District. The requirements and proposed dimensions are shown in the following table.

	Required	Provided	Compliance
Front (east property line)	10-foot build-to-line	25 feet (this property is a flag lot, however, and this requirement is not applicable)	Complies
Side (north)	N/A, building may be placed up to property line	40 feet	Complies
Side (south)	N/A, building may be placed up to property line	9 feet	Complies
Rear (west)	30-foot minimum setback	40 feet	Complies.
Building Height	Maximum 4 stories, 55 feet, Minimum 2 stories	3 stories, 35'-4"	Complies

Lot Coverage (Building)	30%	21%	Complies
Minimum Open Space	20%	Over 20%	Complies
Parking Location	Cannot be located in front yard	Within garages	Complies

Please note that the applicant is providing decks that project 2-feet into the required rear yard. Uncovered decks are permitted to encroach up to 15-feet into a rear yard.

Items to be addressed: None.

PARKING

Section 13.06.G of the Zoning Ordinance requires:

	Required	Provided
Residential: 2 spaces per unit	25 Units = 50 spaces	50 garage spaces + 18 guest spaces = 68 spaces
Barrier Free	0	0
Bicycle Parking	1	1
Loading	0	0
Total	50 spaces	50 spaces within garages and 18 guest spaces

The applicant is providing 2-car garages and 10 surface guest spaces.

Items to be Addressed: None

SITE ACCESS AND CIRCULATION

Vehicular access to the site is via Dequindre Road. The Engineering Department and Fire Department have reviewed the vehicular circulation and find it sufficient.

The Engineering Department has reviewed the pedestrian circulation and notes the following comments:

- Improve pedestrian connectivity within the site, by adding or extending sidewalks to provide a continuous internal pedestrian walkway around the site and to each unit.
 - As shown on the preliminary site plan, there are no sidewalks connecting to the (presumed) front entry for Units 1-6 and Units 13-19.
 - The existing lone crosswalk is inconvenient for pedestrians traveling to/from the easterly buildings.
 - o Add crosswalk markings to emphasize pedestrian crossing locations within the site.

Items to be addressed: Incorporate the Engineering Departments pedestrian connectivity comments.

LANDSCAPING

A landscaping plan has been provided on sheet L-1.0 and are supplemented by tree protection and planting details on sheet L-1.1. The applicant should verify that the plant list provided on sheet L-1.0 corresponds to drawings provided. The following table discusses the development's compliance with the landscape requirements set forth in Section 13.02.

	Required:	Provided:	Compliance:
North Property Line:			
Landscape buffering: Required buffering between two differentiating land uses. Alternative 1 or 2.	1 large evergreen every 10 feet or 1 narrow evergreen every 3 feet. Approx. 370'/10=37 trees	39 evergreen screening trees	Complies
East Property Line:			
Street Trees: The Ordinance requires that the greenbelt shall be landscaped with a minimum of one (1) deciduous tree for every thirty (30) lineal feet, or fraction thereof, of frontage abutting a public road right-of-way.	60-foot ROW = 2 trees	2 trees	Complies
West Property Line:			
Landscape buffering:	1 large evergreen every 10 feet or 1 narrow evergreen every 3 feet. 240' / 10= 24 trees	26 evergreen screening trees	Complies
South Property Line:			
Landscape buffering:	1 large evergreen every 10 feet or 1 narrow evergreen every 3 feet. Alternative screening method may be considered by the Planning Commission.	Six (6) foot fence along property boundary.	Planning Commission shall consider alternative screening proposed.
Overall:			
Site landscaping: A minimum of twenty percent (20%) of the site area shall be comprised of landscape material. Up to twenty-five percent (25%) of the required landscape area may be brink, stone, pavers, or other public	20%	Figure not provided	Unknown

plaza elements, but shall not include any parking area or required sidewalks.		
Mitigation:	The tree inventory and calculat requirements of the ordinance	e with the

Transformer / Trash Enclosure:

The applicant has not indicated a central trash enclosure. It is assumed that each unit will have trash bins in the garage to be rolled out for trash pickup.

Items to be Addressed: 1) Planning Commission to consider the use of a fence in place of required screening at the south edge of the property; and 2). Provide site landscaping calculation.

PHOTOMETRICS

A photometric plan has not been provided. For final site plan a photometric plan and fixture details are required to be submitted.

Items to be Addressed: Submit photometric plans and fixture details.

FLOOR PLAN AND ELEVATIONS

The applicant has provided floor plans, elevations, and renderings. Materials include brick veneer and siding. Type of siding is not indicated.

Items to be Addressed: Siding material note indicated.

DESIGN STANDARDS and SITE PLAN REVIEW STANDARDS

The Neighborhood Node design standards as well as Site Plan review standards provide the Planning Commission with direction when reviewing the proposed site plan and design features of this development.

Section 5.06.E. outlines Design Standards:

- 1. Building Orientation and Entrance
- 2. Ground Story Activation
- 3. Transitional Features
- 4. Site Access, Parking, and Loading

Please see Section 5.06.E for standard details.

We find that the design standards have been met.

Section 8.06 outlines Site Plan Review Design Standards.

- 1. Development shall ensure compatibility to existing commercial districts and provide a transition between land uses.
- 2. Development shall incorporate the recognized best architectural building design practices.
- 3. Enhance the character, environment and safety for pedestrians and motorists.

Please see Section 8.06 for standard details

The applicant is providing a medium density multiple family residential project. The project provides a transition from a number of commercial uses and the rear yards of single family residential to the north and east. We find that the site plan standards have been met.

REZONING STANDARDS

According to Rezoning Procedures in Section 16.04C, a conditional rezoning may only be approved upon a finding and determination that all of the following are satisfied:

a. The conditions, proposed development, and/or proposed use of the land are designed or proposed for public health, safety, and welfare purposes.

CWA: The purpose of the rezoning is in significant part to allow for additional guest parking and include a pedestrian sidewalk. These improvements are not possible without the rezoning. The applicant has provided sufficient landscaping along the northern property to mitigate any potential impacts upon the northern property line. These improvements are conditions of rezoning as the site plan documents are conditions of approval.

- b. The conditions, proposed development and/or proposed use are not in material conflict with the Master Plan, or, if there is material conflict with the Master Plan, such conflict is due to one of the following:
 - 1. A change in City policy since the Master Plan was adopted.
 - 2. A change in conditions since the Master Plan was adopted.
 - 3. An error in the Master Plan.

CWA: The purpose of the rezoning is in significant part to allow for additional guest parking and include a pedestrian sidewalk. These improvements are not possible without the rezoning. The applicant has provided sufficient landscaping along the northern property to mitigate any potential impacts upon the northern property line. Providing additional guest parking, when necessary, and better pedestrian connections, coupled landscaping buffer to protect adjacent properties is consistent with the Master Plan.

c. The conditions, proposed development and/or proposed use are in accordance with all terms and provisions of the zoning district to which the land is to be rezoned, except as otherwise allowed in the Conditional Rezoning Agreement. Pineview – CRZ and PSP October 19, 2021

CWA: The conditions provided by the applicant, including the site plan, are consistent with all terms and provisions of the zoning district.

d. Public services and facilities affected by a proposed development will be capable of accommodating service and facility loads caused by use of the development.

CWA: The rezoning will not impact nor affect public services or facilities.

e. The conditions, proposed development and/or proposed use shall insure compatibility with adjacent uses of land.

CWA: The conditions provided by the applicant, including the site plan, insure compatibility with adjacent uses of land.

RECOMMENDATION

Planning Commission to consider the use of a fence in place of required screening at the south edge of the property. Based on that discussion, we recommend that the Planning Commission recommend to the City Council conditional rezoning and preliminary site plan approval with the following conditions:

- 1. Submit photometric plans and fixture details
- 2. Address the Engineering Departments pedestrian connection comments
- 3. Provide site landscaping calculation.
- 4. Indicate siding material.
- 5. A conditional rezoning agreement between the City and the applicant.

Sincerely,

CARLISLE/WORTMAN ASSOC., INC. Benjamin R. Carlisle, LEED AP, AICP

6. PRELIMINARY SITE PLAN REVIEW (File Number SP JPLN2019-0032) – Proposed GFA Long Lake Multifamily Development, West side of Dequindre, North of Long Lake (PIN 88-20-12-476-070), Section 12, Currently Zoned NN (Neighborhood Node "J") and EP (Environmental Protection) Zoning Districts

Mr. Carlisle reviewed the Preliminary Site Plan application for the proposed multifamily development. He addressed the EP-zoned strip of property along the northern property line, shared access with Taco Bell, parking, landscaping and elevations. Mr. Carlisle said the application meets requirements of the NN zoning district and the Site Plan standards. He recommends shifting the development 10 feet to the east to provide a better transition with the residential homes on the west.

Mr. Carlisle recommended Preliminary Site Plan approval with the conditions as identified in his report dated November 5, 2019.

Gary Abitheira addressed the application as relates to the EP-zoned property along the northern property line, shared access and the target market for townhomes.

Chair Faison opened the floor for public comment.

- Avis Landmesser, 568 Ottawa; asked for clarification on general site plan specifics.
- Azhagu Subramanian, 5114 Fedora; addressed buffer transition and privacy.

Chair Faison closed the floor for public comment.

There was discussion on:

- Shared access drive with Taco Bell.
- Design layout as relates to proximity of Taco Bell.
- Courtyard and sidewalk connectivity; opportunity to create additional green space.
- Transition buffer to adjacent residential.
- Property zoned EP; intent of EP zoning district historically.
- Potential to rezone EP-zoned property for better design layout; traditional versus conditional rezoning.
- Building materials in relation to target market; millennials.

Resolution # PC-2019-11-078

Moved by: Krent Support by: Tagle

RESOLVED, That Preliminary Site Plan Approval, pursuant to Article 8 of the Zoning Ordinance, as requested for the proposed GFA Long Lake Multifamily Development, located on the West side of Dequindre, North of Long Lake (PIN 88-20-12-476-070), Section 12, Currently Zoned NN (Neighborhood Node "J") and EP (Environmental Protection) Zoning Districts, be postponed for the following reason:

1. To allow the developer ample time to consider all the opinions and ideas expressed by the Commission.

Yes: All present (9)

MOTION CARRIED

CONDITIONAL REZONING

7. <u>PUBLIC HEARING - CONDITIONAL REZONING- (CR JPLN2021-001)</u> – Proposed Pine View Condominiums, West side of Dequindre, north of Long Lake (88-20-12-476-070), Section 12, From NN (Neighborhood Node "J" and EP (Environmental Protection) to NN (Neighborhood Node "J")

Mr. Carlisle presented a review of the Pine View Condominiums. He addressed the 40-foot wide strip of E-P zoning and referenced the previous action taken by the Planning Commission to postpose the item to allow the applicant to submit a conditional rezoning application to rezone the E-P portion so it could be used for guest parking. Mr. Carlisle said the layout design has not changed and noted the southern portion of the property is a by-right development. He noted of significant importance are the applicant's voluntary conditions numbered 1, 4, 7 and 8. Mr. Carlisle addressed the landscaping, required screening at the south edge of the property, the engineering department pedestrian connection improvements and design and site plan standards. Mr. Carlisle recommended that the Planning Commission recommend to the City Council conditional rezoning and preliminary site plan approval with the conditions as identified in his report dated August 16, 2021.

Gary Abitheira clarified as a voluntary condition to the application, the maximum height would be a 3 story building, noting an error in the Planning Consultant report stating the maximum height of a 2-1/2 story building. He addressed the number of units, landscaping and elevations.

Mr. Savidant addressed the intent of the application dated November 12, 2019 and the recently adopted text amendment limiting the building height of development within the Neighborhood Node zoning district that abuts residential.

There was discussion on:

- E-P zoning district; uses, zoning tool to separate incompatible land uses.
- Landscaping buffer, amenity to application.
- Maintenance of E-P strip of land.
- Height of surrounding residential homes.
- Shared driveway with Taco Bell; as relates to traffic, cross access easement.
- Elevations; garage and interior entrance on same side.
- Property to the north; open space, potential headlight shining on residential.
- Existing concrete wall at Taco Bell; applicant prefer trees and landscape.
- Proposed fence on south side; material and height.
- Guest parking; no requirement to provide, good design consideration, appropriate screening for headlights.

PUBLIC HEARING OPENED

- Pamela Prewitt, 41203 Dequindre; addressed concerns with safety and traffic congestion relating to Taco Bell; traffic back-ups block her driveway, addressed maintenance of E-P strip of land.
- Doug Roach, 5237 Windmill; addressed concerns with safety, congestion, parking, and light pollution.

PUBLIC HEARING CLOSED

Mr. Carlisle and Mr. Savidant acknowledged the traffic concern addressed by the residents would be reported and looked into by the Engineering.

Mr. Savidant encouraged residents who experience light pollution from nearby commercial to contact the Planning Department and any violation of the Zoning Ordinance would be enforced.

Discussion continued on:

- Maintenance responsibility of property to north.
- Pedestrian sidewalk as relates if E-P zoning stays in place.
- Density; building height, building form.
- Potential traffic congestion with shared access.
- Intent of applicant with by-right development on southern portion.
- Type of desired housing; results of Master Plan survey.

Resolution # PC-2021-08-064

Moved by: Rauch Seconded by: Perakis

RESOLVED, That the Planning Commission hereby recommends to the City Council that the NN "J" and EP to NN "J" conditional rezoning request, as per Section 16.04 of the City of Troy Zoning Ordinance, located on the west side of Dequindre, north of Long Lake, within Section 12, being approximately 2.389 acres in size, be **denied**, for the following reasons:

- 1. The request does not comply with the Master Plan, including but not limited to its definition of transitional density.
- 2. The conditions offered by the applicant do not reasonably protect the adjacent properties.
- 3. The rezoning and conditions offered by the applicant would be incompatible with surrounding zoning and land use and do not comply with the Zoning Ordinance, including but not limited to building form.

Yes: Hutson, Malalahalli, Perakis, Rauch No: Faison, Krent, Lambert, Rahman

Absent: Tagle

MOTION FAILED

Resolution # PC-2021-08-065

Moved by: Rahman Seconded by: Lambert

RESOLVED, That the Planning Commission hereby recommends to the City Council that the NN "J" and EP to NN "J" conditional rezoning request, as per Section 16.04 of the City of Troy Zoning Ordinance, located on the west side of Dequindre, north of Long Lake, within Section 12, being approximately 2.389 acres in size, be **granted**, for the following reasons:

- 1. The request complies with the Master Plan.
- 2. The EP district does not include any significant natural features.
- 3. The rezoning would permit greater flexibility in use and development of the property.
- 4. The conditions offered by the applicant reasonably protect the adjacent properties.
- 5. The rezoning would be compatible with surrounding zoning and land use.
- 6. The site can be adequately served with municipal water and sewer.

BE IT FURTHER RESOLVED, That the Planning Commission recommends the following site plan design considerations:

- 1. Submit photometric plans and fixture details.
- 2. Address the Engineering Department pedestrian connection comments.
- 3. Provide site landscaping calculation.
- 4. Provide floor plans and elevations.
- 5. Consider residents' feedback on headlight glaring and traffic safety.

Discussion on the motion on the floor.

Ms. Perakis addressed standards that must be met.

Mr. Rauch addressed primary entrance on interior streets and transitional density. Mr. Rauch stated Section 5.06.E.1.a. requires the primary entrance (to buildings) be on a street; there is no primary entrance on a street. He stated Table 5.03.B.3 Lot Access and Circulation it states Driveways must access garages, if provided, integrated into buildings from the rear, in an alley configuration. The buildings facing east and west, the driveways and the Primary Entrance are accessing an alley. And he was sorry this issue wasn't raised previously. Transitional issues between four story buildings and single family residential, why aren't we allowing duplexes, quads, attached residential Bungalow Court.

Ms. Dufrane addressed conditional rezoning applications with respect to conditions offered by applicant.

Vote on the motion on the floor.

Yes: Faison, Krent, Lambert, Rahman No: Hutson, Malalahalli, Perakis, Rauch

Absent: Tagle

MOTION FAILED

Development on behalf of the City; a copy shall be **ATTACHED** to the original Minutes of this meeting.

BE IT FURTHER RESOLVED, That Troy City Council hereby **AUTHORIZES** City Administration to record the executed Troy Crossing Planned Unit Development Agreement with the Oakland County Register of Deeds.

BE IT FINALLY RESOLVED, That Troy City Council hereby **AUTHORIZES** the petitioner to submit the Final Development Plan pursuant to Section 11.08 of Chapter 39.

Yes: All-7 No: None

MOTION CARRIED

E-2 Conditional Rezoning (CR JPLN2021-001) – Proposed Pine View Condominiums, West Side of Dequindre, North of Long Lake (Parcel 88-20-12-476-070), Section 12, From NN (Neighborhood Node "J") and EP (Environmental Protection) to NN (Neighborhood Node "J") (Introduced by: Brent Savidant, Community Development Director)

Mayor Baker announced that the Petitioner for this item has requested the item be removed from the Agenda and returned to the Planning Commission for reconsideration.

The Mayor opened the Public Hearing. The following individuals offered public comment:

Paul Balas	Commented in opposition to the rezoning
Susan Neely	Commented in opposition to the rezoning.
Daniel Raubinger	Commented in opposition to the rezoning.
Michael Lipinski	Commented in opposition to the rezoning.
Pamela Prewitt	Commented in opposition to the rezoning.

F. PUBLIC COMMENT:

G. CITY COUNCIL/CITY ADMINISTRATION RESPONSE/REPLY TO PUBLIC COMMENT:

H. POSTPONED ITEMS:

H-1 No Postponed Items

I. REGULAR BUSINESS:

I-1 Board and Committee Appointments: a) Mayoral Appointments – Downtown Development Authority; b) City Council Appointments – None

memorandum



Date: September 16, 2021

To: Bill Huotari, PE

From: Sara Merrill, PE, PTOE

Re: Pine View Condominiums Anticipated Traffic Impacts

The purpose of this memorandum is to provide an overview of anticipated traffic impacts resulting from Pine View Condominiums, a proposed site condominium development consisting of 7-attached, 2.5 story single-family buildings with a total of 25 dwelling units. The development will utilize a shared driveway with an existing Taco Bell. The site is located on the east side of Dequindre Road, north of East Long Lake Road. In the immediate vicinity of the site, Dequindre Road is a 5-lane roadway, with two through lanes in each direction plus a center left turn lane.

The Institute of Transportation Engineers (ITE) Trip Generation Manual, 10^{th} Edition, provides trip generation rates for numerous land uses, based on thousands of studies throughout the United States and Canada. This data can then be used to estimate the number of vehicle trips generated by a development. For residential housing, traffic impacts are usually most noticeable during the peak hour of adjacent street traffic – that is, during morning and evening "rush hour", when traffic on the roads is most congested. In most areas, the morning (AM) peak is a one hour period that occurs between 7 am – 9 am, and the evening (PM) peak is a one hour period usually between 4 pm – 6 pm.

The table below provides the calculated number of trips generated for the proposed Pine View Condominiums, based on the ITE Trip Generation Manual for Multi-Family Housing, Low Rise (ITE Land Use Code #220). For comparison, the table also shows trip generation for a theoretical "by-right" project, a 20,000 square foot General Office Building (ITE Lane Use Code #710).

			Nur	nber of	Site-Gen	erated Tr	ips		
Land Use	AN	l Peak Ho	our	PΝ	/I Peak H	our		Daily	
	In	Out	Total	In	Out	Total	In	Out	Total
Multi-Family Housing, Low-Rise (25 Units)	3	10	13	11	6	17	74	74	148
General Office Building (20,000 gross sq. ft.)	39	6	45	4	21	25	111	111	222

During the morning (AM) peak hour, the proposed Pine View Condominiums development is expected to generate 13 new trips: 3 inbound (entering the site), and 10 outbound (exiting the site). During the evening (PM) peak hour, the proposed site is expected to generate 17 new vehicle trips: 11 inbound (entering the site) trips, and 6 outbound (exiting the site). This pattern coincides with residents typically leaving in the morning for work, and returning home in the evening.

Under the NN zoning, office use would also be considered a by-right development. If, instead of a 25-unit multi-family development, this site was instead developed as 20,000 square foot office building, the site would be expected to generate 45 new trips (39 inbound, 6 outbound) during the morning peak hour, and 25 new trips (4 inbound, 21 outbound) during the evening peak hour. An office use would generate more trips than a comparably sized residential development.



As a multi-family land use, the traffic generated by the proposed development would be minimal, adding less than two dozen vehicle trips during the peak ("busiest") hour. The traffic impact of this site on the adjacent road network is negligible and would be imperceptible to the majority of road users.

As a point of comparison Dequindre Road (at East Long Lake Road/ 18 Mile Road) carries over 2,200 vehicles during the PM peak hour, and with an annual average daily traffic count of almost 25,000 vehicles in 2020 (during the pandemic). Even amongst typical weekdays, traffic volumes during the peak hours alone often vary by 10%+ from one day to the next. The day-to-day fluctuations result in peak hour traffic volumes that vary by upwards of a couple hundred vehicles. The proposed Pine View Condominium homes are expected to generate fewer than 20 new vehicle trips during the peak hour.



Crash Detail Report

Request #: 0057228		Printed By: Chuck		Printed On: 9/10/202
Dequindre Rd n/o Long Lake	, Toco Bell: 01/01/2000	and 12/31/2006		
#1 Location: N DEQUINDRE Crash Date: 05/11/2000 Injuries K: 0 CVT: Sterling Heights	E (10.15) 390 feet N of Day: Thu Hour: 9ar Inj A: 0 Inj B: 0 Area: transition	-	ded Roadway: dry Inj 0: 1 Drugs: N	Crash ID: 4027710 Light: day How: ss-same Complaint No:
Unit No Veh Dir Action 1 N change 2 N go strai UD-10: N/A	lanes veh in transpt	Event 2 Event 3 none none none none	Event 4 Haz Action none left of center none none	Veh TypeDamagepickuplftfrontcarrtfront
#2 Location: DEQUINDRE F Crash Date: 01/26/2001 Injuries K: 0 CVT: Troy	RD (10.21) 700 feet N o Day: Fri Hour: 6pr Inj A: 0 Inj B: 0 Area: straight	-		Crash ID: 4357315 Light: dark/unltd How: rr-end Complaint No:
Unit No Veh Dir Action 1 S go straig 2 S stop on UD-10: N/A	ght veh in transpt	Event 2 Event 3 none none none none	Event 4 Haz Action none unable to stop none none	Veh Type Damage pickup ctrfront car rtrear
Injuries K: 0	10.17) 500 feet N of E I Day: Wed Hour: unk Inj A: 0 Inj B: 0 Area : driveway	-	loudy Roadway: wet Inj 0: 2 Drugs: N	Crash ID: 4372829 Light: day How: angle Complaint No:
Unit No Veh Dir Action 1 NE left turn 2 N go strai UD-10: N/A	veh in transpt	none none none	none failed to yield none none	Veh Type Damage car rtfront car lftside
#4 Location: DEQUINDRE (Crash Date: 03/20/2002 Injuries K: 0 CVT: Sterling Heights	10.15) 350 feet N of E I Day: Wed Hour: 7 Inj A: 0 Inj B: 0 Area: inter driveway	-	ndy Roadway: dry Inj 0: 3 Drugs: N	Crash ID: 4988017 Light: dark/ltd How: angle Complaint No:
Unit No Veh Dir Action 1 W enter ro 2 N go strait UD-10: 029269834 O29269834	dwy veh in transpt	rone none none	Event 4 Haz Action none other none none	Veh Type Damage car ctrfront car rtside
Injuries K: 0	RD (10.18) 500 feet N o Day: Tue Hour: 1pm Inj A: 0 Inj B: 0 Area: straight	•	Inj 0: 1 How	Crash ID: 5688783 nt: day v: rr-end nplaint No: 0419288
Unit No Veh Dir Action 1 S go straig 2 S stop on UD-10: 041195150	ght veh in transpt	none none	Event 4 Haz Action none unable to stop none none	Veh Type Damage car ctrfront car ctrrear

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njuries K	e: 02/13/2 : 0 ing Height		Day: Mo Inj A: 0 Area: di	Inj B: 1	n Weath Inj C: (HBD: N		Roadv Inj 0: Drugs		How	it: day v: angle nplaint No: (065488
Unit No	Veh Dir	Action	Prior	Event 1	Event 2	Event 3	Event 4	Haz Acti	on	Veh Type	Damage
1	W	leaving	parking	veh in transp	t none	none	none	failed to	yield	car	Iftfront
2	N	go straiç	ght	none	none	none	none	none		car	Iftfront
JD-10: <mark>06</mark>	1036005										
		IINDRE F	RD (10.18	3) 500 feet N o	f E Long La	ake Rd				Crash II	D : 6360419
	n: DEQU		•	3) 500 feet N o t Hour: 10ar	•	ake Rd er: clear	Roadwa	ny: dry L	_ight:		D: 6360419
[‡] 7 Locatio	on: DEQU e: 06/03/2		•	•	•	er: clear	Roadwa	•	•		D : 6360419
‡7 Locatio	on: DEQU e: 06/03/2	2006	Day: Sa	t Hour: 10ar Inj B: 0	n Weath	er: clear 0		ŀ	low:	day	
[‡] 7 Locatio Crash Dat njuries K CVT: Sterl	on: DEQU e: 06/03/2	2006 ts	Day: Sa Inj A: 0 Area: d	t Hour: 10ar Inj B: 0	n Weath Inj C:	er : clear 0 N	Inj 0: 3 Drugs:	ŀ	How: Comp	day angle	
[‡] 7 Locatio Crash Dat njuries K CVT: Sterl	on: DEQU e: 06/03/2 : 0 ing Height	2006 ts	Day: Sa Inj A: 0 Area: di Prior I	t Hour: 10ar Inj B: 0	Meath Inj C: (HBD:	er: clear 0 N Event 3	Inj 0: 3 Drugs: Event 4	N C	How: Comp	day angle blaint No: 06	620485

UD-10: 061123194

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Crash Type

	•
Count	Туре
0	uncoded
0	single
0	head-on
0	head-on/lt
4	angle
2	rr-end
0	rr-end/lt
0	rr-end/rt
1	ss-same
0	ss-opp
0	back
0	other
0	unknown
Totals:	7

Light Conditions

Count	Туре
0	uncoded
5	day
0	dawn
0	dusk
1	dark/ltd
1	dark/unltd
0	other
0	unknown
Totals:	7

Weather

Count	Type
1	uncoded
1	clear
0	smoke
4	cloudy
0	fog
0	rain
1	snow
0	wind
0	sleet/hail
0	blowing snow
0	blowing sand
0	unknown
Totals:	7

Road Condition

Count	Туре
0	uncoded
5	dry
0	oily
1	wet
0	ice
1	snow
0	mud
0	slush
0	debris
0	water
0	sand
0	other
0	unknown
Totals:	7

Crashes By Month

Count	Туре
2	January
1	February
1	March
0	April
1	May
2	June
0	July
0	August
0	September
0	October
0	November
0	December
Totals:	7

Hazardous Action

Count	Туре
7	none
0	speeding
0	imprp/no signal
0	imprp backing
2	unable to stop
1	other
0	unknown
0	reckls driving
0	carels driving
0	spd too slow
3	failed to yield
0	disrgd traffic cntrl
0	wrong way
1	left of center
0	imprp passing
0	imprp lane use
0	imprp turn
Totals:	14

Unit Type

Count	Туре
0	Bicyclist
0	Engineer
12	Vehicle
0	Pedestrian
Totals:	12

Crashes By Year

Count	Type
1	2000
2	2001
1	2002
0	2003
1	2004
0	2005
2	2006
0	2007
0	2008
0	2009
0	2010
0	2011
0	2012
0	2013
0	2014
0	2015
0	2016
0	2017
0	2018
0	2019
0	2020
0	2021
Totals:	7

iotais: /

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Crash Severity

TCLS Report [Request #0057228]

	FATAL	Α	В	С	No Inj	Total
Persons	0	0	1	1	15	17
Crashes	0	0	1	1	5	7

Alcohol in Crashes

	FATAL	PI	PD	Total
Drinking	0	0	1	1
Not Drinking	0	2	4	6
Total	0	2	5	7

Crashes per Hour by Day

	Sunday	Monday	Tuesday	Wednesday	Thursday	Friday	Saturday	Unknown	Total
12a - 1a	0	0	0	0	0	0	0	0	0
1a - 2a	0	0	0	0	0	0	0	0	0
2a - 3a	0	0	0	0	0	0	0	0	0
3a - 4a	0	0	0	0	0	0	0	0	0
4a - 5a	0	0	0	0	0	0	0	0	0
5а - 6а	0	0	0	0	0	0	0	0	0
6a - 7a	0	0	0	0	0	0	0	0	0
7a - 8a	0	0	0	0	0	0	0	0	0
8a - 9a	0	0	0	0	0	0	0	0	0
9a - 10a	0	0	0	0	1	0	0	0	1
10a - 11a	0	0	0	0	0	0	1	0	1
11a - 12p	0	0	0	0	0	0	0	0	0
12p - 1p	0	0	0	0	0	0	0	0	0
1p - 2p	0	0	1	0	0	0	0	0	1
2p - 3p	0	0	0	0	0	0	0	0	0
3p - 4p	0	0	0	0	0	0	0	0	0
4p - 5p	0	1	0	0	0	0	0	0	1
5p - 6p	0	0	0	0	0	0	0	0	0
6p - 7p	0	0	0	0	0	1	0	0	1
7p - 8p	0	0	0	1	0	0	0	0	1
8p - 9p	0	0	0	0	0	0	0	0	0
9p - 10p	0	0	0	0	0	0	0	0	0
10p - 11p	0	0	0	0	0	0	0	0	0
11p - 12a	0	0	0	0	0	0	0	0	0
Unknown Time	0	0	0	1	0	0	0	0	1
Total	0	1	1	2	1	1	1	0	7

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Crash Detail Report

	9		Printed By:	Chuck K	eller			Pr	inted On: 9/10/202
Dequindre Rd n/o L	ong Lake, Toco Be	ell: 01/01/2007	and 08/31/2	2021					
#1 Location: DEQU Crash Date: 06/05/ Injuries K: 0 CVT: Sterling Heigh	2007 Day: Tue Inj A: 0	Hour: 10am	-		Roadw Inj 0: 2 Drugs:) : 6687528 723327
Unit No Veh Dir	Action Prior E	vent 1 E	vent 2	Event	t 3 Event	t 4 Haz A	ction	Veh Type	Damage
1 N	go straight cr	oss ctrline v	eh in transp	ot none	none	other		car	rtrear
2 N	change lanes ve	eh in transpt in	ione	none	none	none		car	Iftfront
UD-10: 075529322									
#2 Location: DEQU Crash Date: 10/20/ Injuries K: 0 CVT: Troy	•	n Hour: 5pn Inj B: 0	_	e r: rain	Roadwa Inj 0: 1 Drugs: N	ı			D: 7119734 36411
Unit No Veh Dir	Action Prior E	vent 1	Event 2 Ev	vent 3 E	Event 4	Haz Actio	n	Veh Type	Damage
1 E	left turn v	eh in transpt	none no	one r	one f	ailed to yie		car	rtfront
2 S		eh in transpt		one r	one i	mprp lane	use	car	ctrfront
UD-10: 080497387	, 080497387								
#3 Location: DEQU Crash Date: 07/27/	2010 Day: Tue	9) 600 feet N of e Hour: 7pm Inj B: 0			Roadwa	-	Light:) : 7673296
-	Inj A: 0 ats Area: st	-	HBD: N		Inj 0: 2 Drugs:			laint No: 10	028035
Injuries K: 0 CVT: Sterling Heigh Unit No Veh Dir	its Area: sti	-	-	Event 3	Drugs:	N	Comp		
CVT: Sterling Heigh	Action Prior	raight	HBD: N	Event 3	Drugs:	N	Comp	laint No: 10	
Unit No Veh Dir	Action Prior	raight Event 1	HBD: N Event 2 none		Drugs:	N Haz Actio	Comp	Veh Type	Damage
Unit No Veh Dir N N N	Action Prior slow/stop on rd	raight Event 1 veh in transpt	HBD: N Event 2 none	none	Drugs: Event 4 none	N Haz Action unable to	Comp	Veh Type	Damage rtfront
Unit No Veh Dir N N N N UD-10: 100401970 #4 Location: DEQU Crash Date: 02/04/ Injuries K: 0	Action Prior slow/stop on rd stop on road JINDRE RD (10.19 2011 Day: Fri Inj A: 0	raight Event 1 veh in transpt veh in transpt o) 554 feet N of Hour: 7pm Inj B: 0	HBD: N Event 2 none none E LONG LA Weather: 0 Inj C: 0	none none AKE RD clear F	Drugs: Event 4 none none Roadway: nj 0: 5	N Haz Action unable to none dry Lig	compon stop ht: da w: ss-s	Veh Type car car Crash IE rk/unltd	Damage rtfront Iftside 2: 7948141
Unit No Veh Dir N N N N UD-10: 100401970 H4 Location: DEQU Crash Date: 02/04/ Injuries K: 0 CVT: Troy	Action Prior slow/stop on rd stop on road JINDRE RD (10.19 2011 Day: Fri Inj A: 0 Area: str	raight Event 1 veh in transpt veh in transpt 0) 554 feet N of Hour: 7pm Inj B: 0 raight	HBD: N Event 2 none none E LONG LA Weather: 0 Inj C: 0 HBD: N	none none AKE RD clear F II	Drugs: Event 4 none none Roadway: nj 0: 5 Drugs: N	N Haz Action unable to none dry Lighton Hoco	on stop jht: da w: ss-: mplair	Veh Type car car Crash IE rk/unltd same nt No: 1100	Damage rtfront Iftside 2: 7948141
Unit No Veh Dir N N N N UD-10: 100401970 H4 Location: DEQU Crash Date: 02/04/ njuries K: 0 CVT: Troy Unit No Veh Dir	Action Prior slow/stop on rd stop on road JINDRE RD (10.19 2011 Day: Fri Inj A: 0 Area: sto	raight Event 1 veh in transpt veh in transpt 0) 554 feet N of Hour: 7pm Inj B: 0 raight Event 1	HBD: N Event 2 none none E LONG LA Weather: 0 Inj C: 0 HBD: N Event 2	none AKE RD clear F II C	Drugs: Event 4 none none Roadway: nj 0: 5 Drugs: N Event 4	Haz Action unable to none dry Light Ho Co	compon stop ht: da w: ss-smplair	Veh Type car car Crash IE rk/unitd same nt No: 1100 Veh Type	Damage rtfront Iftside D: 7948141 03552 Damage
Unit No Veh Dir 1 N 2 N UD-10: 100401970 44 Location: DEQU Crash Date: 02/04/ njuries K: 0 CVT: Troy Unit No Veh Dir 1 S	Action Prior slow/stop on road JINDRE RD (10.19 2011 Day: Fri Inj A: 0 Area: sti Action Prior change lanes	raight Event 1 veh in transpt veh in transpt 9) 554 feet N of Hour: 7pm Inj B: 0 raight Event 1 veh in transpt	HBD: N Event 2 none none E LONG LA Weather: 0 Inj C: 0 HBD: N Event 2 none	none AKE RD clear II Event 3	Drugs: Event 4 none none Roadway: nj 0: 5 Drugs: N Event 4 none	Haz Action unable to none dry Lighto Co Haz Action failed to y	compon stop jht: da w: ss-smplain on	Veh Type car car Crash III rk/unitd same nt No: 1100 Veh Type car	Damage rtfront Iftside D: 7948141 03552 Damage Iftfront
Unit No Veh Dir N N N N Unit No Veh Dir N Veh Dir N Veh Dir N Unit No Veh Dir	Action Prior slow/stop on rd stop on road JINDRE RD (10.19 2011 Day: Fri Inj A: 0 Area: str Action Prior change lanes go straight	raight Event 1 veh in transpt veh in transpt 0) 554 feet N of Hour: 7pm Inj B: 0 raight Event 1	HBD: N Event 2 none none E LONG LA Weather: C Inj C: 0 HBD: N Event 2 none none none	none AKE RD clear F II C	Drugs: Event 4 none none Roadway: nj 0: 5 Drugs: N Event 4	Haz Action unable to none dry Light Ho Co	on stop jht: da w: ss-s mplair on	Veh Type car car Crash IE rk/unitd same nt No: 1100 Veh Type	Damage rtfront Iftside D: 7948141 03552 Damage

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Injuries K		Inj A: 0	at Hour : 7pm Inj B: 0 nter other	Weather: Inj C: 0 HBD: N	lr	Roadway: : nj 0: 3 Drugs: N	How: s	dark/unltd ss-same aint No: 110	0006904
Unit No	_	Action Prior	Event 1		Event 3	Event 4	Haz Action	Veh Type	Damage
1	S	change lanes	veh in transpt		none	none	other	car	Iftside
2	S	go straight	veh in transpt	none	none	none	none	car	rtfront
UD-10: 11	0181773								
#6 Locatio	n: DEQU	INDRE RD (10.	.18) 500 feet N o	f 18 MILE	RD			Crash I	D : 8028371
Crash Dat	te: 05/07/2	2011 Day: \$	Sat Hour: 12pr	n Weath	ier: clear	Roadwa	ay: dry Ligh	t: day	
Injuries K		lnj A:	0 Inj B: 0	Inj C:	0	Inj 0: 5	How	: angle	
CVT: Sterl	ing Height	s Area:	driveway	HBD:	N	Drugs:	N Com	plaint No: 1	117719
Unit No	Veh Dir	Action Prior	Event 1	Event 2	Event 3	Event 4	Haz Action	Veh Type	Damage
1	Е	go straight	veh in transpt	none	none	none	failed to yield	car	rtfront
2	N	go straight	veh in transpt	none	none	none	none	car	Iftside
UD-10: 11	0296832								
#7 Locatio	n: DEQU	INDRE RD (10.	.16) 450 feet N o	f E LONG	LAKE RD			Crash I	D: 8109563
Crash Dat		•	Ved Hour: 4pm			Roadway	r: dry Light:	day	
Injuries K	: 0	Inj A: () Inj B : 0	Inj C: 1		Inj 0: 1	How: a	ngle	
CVT: Troy		Area: i	inter driveway	HBD: N		Drugs: N	Compl	aint No: 110	025043
Unit No	Veh Dir	Action Prior	Event 1	Event 2	Event 3	Event 4	Haz Action	Veh Type	Damage
1	W	left turn	veh in transpt	none	none	none	failed to yield	car	ctrfront
	S		•	2020	nono	none	none	car	Iftside
2	3	go straight	ven in transpt	none	none	HOHE	HOHE	oui	IIISIUC
UD-10: 11 #8 Locatio	0520088 on: DEQU	•	.18) 500 feet N o	f E LONG	LAKE RD			Crash I	D: 8398223
UD-10: 11	0520088 on: DEQU te: 07/19/2	INDRE RD (10. 2012 Day Inj A	.18) 500 feet N o : Thu Hour : 1	f E LONG 0am W o		in Roa Inj 0	dway: wet		D: 8398223
UD-10: 110 #8 Location Crash Dat Injuries K CVT: Troy	0520088 on: DEQU te: 07/19/2 : 0	INDRE RD (10. 2012 Day Inj A	.18) 500 feet N o : Thu Hour : 1 A : 0 Inj B : 0	f E LONG 0am Wo Inj HE	LAKE RD eather: rai C: 0 BD: N	in Roa Inj 0 Drug	dway: wet	Crash I Light: day How: ss-san	D : 8398223 ne lo :
UD-10: 110 #8 Location Crash Dat Injuries K CVT: Troy	0520088 on: DEQU te: 07/19/2 : 0	INDRE RD (10. 2012 Day Inj A Area Action Prior	.18) 500 feet N o : Thu Hour : 10 A : 0 Inj B : 0 a: straight	f E LONG Dam Wo Inj HE Event 2	LAKE RD eather: rai C: 0 BD: N Event 3	in Roa Inj 0 Druţ Event 4	dway: wet : 2 gs: N Haz Action	Crash I Light: day How: ss-san Complaint N Veh Type	D : 8398223 ne lo :
#8 Location Transport Transport With	0520088 on: DEQU ee: 07/19/2 : 0	INDRE RD (10. 2012 Day Inj A Area Action Prior	.18) 500 feet N o : Thu Hour: 10 A: 0 Inj B: 0 a: straight Event 1	f E LONG Dam Wo Inj HE Event 2 none	LAKE RD eather: rai C: 0 BD: N Event 3	in Roa Inj 0 Druţ Event 4	dway: wet : 2 gs: N Haz Action	Crash I Light: day How: ss-san Complaint N Veh Type	D: 8398223 ne lo: Damage
WD-10: 110 #8 Location Crash Date Injuries K CVT: Troy Unit No	0520088 on: DEQU te: 07/19/2 : 0 Veh Dir S S	INDRE RD (10.2012 Day Inj A Area Action Prior change lanes	.18) 500 feet N o : Thu Hour: 10 A: 0 Inj B: 0 a: straight Event 1 veh in transpt	f E LONG Dam Wo Inj HE Event 2 none	LAKE RD eather: rai C: 0 BD: N Event 3 none	in Roa Inj 0 Druç Event 4 none	dway: wet : 2 gs: N Haz Action failed to yield	Crash I Light: day How: ss-san Complaint I Veh Type car	D: 8398223 ne lo: Damage rtfront
#8 Location Crash Date Injuries K CVT: Troy Unit No 1 2 UD-10: 83	0520088 on: DEQU te: 07/19/2 : 0 Veh Dir S S 98223 on: DEQU te: 06/22/2	INDRE RD (10.2012 Day Inj A Area Action Prior change lanes go straight INDRE RD (10.2012)	.18) 500 feet N o : Thu Hour: 16 A: 0 Inj B: 0 a: straight Event 1 veh in transpt veh in transpt veh in transpt .19) 554 feet N o Sat Hour: 9am	f E LONG Dam Wo Inj HE Event 2 none none	LAKE RD eather: rai C: 0 BD: N Event 3 none none	in Roa Inj 0 Druç Event 4 none	dway: wet : 2 gs: N Haz Action failed to yield none	Crash I Light: day How: ss-san Complaint N Veh Type car car car Crash I	D: 8398223 ne lo: Damage rtfront
#8 Location Crash Date Injuries K CVT: Troy Unit No 1 2 UD-10: 83	0520088 on: DEQU ie: 07/19/2 : 0 Veh Dir S S 98223 on: DEQU ie: 06/22/2 : 0	INDRE RD (10.2012 Day Inj A Area Action Prior change lanes go straight INDRE RD (10.2013 Day: 52 Inj A:	.18) 500 feet N o : Thu Hour: 16 A: 0 Inj B: 0 a: straight Event 1 veh in transpt veh in transpt veh in transpt .19) 554 feet N o Sat Hour: 9am	f E LONG Oam Woln Inj HE Event 2 none none	LAKE RD eather: rai C: 0 BD: N Event 3 none none	in Roa Inj 0 Drug Event 4 none none	dway: wet : 2 gs: N Haz Action failed to yield none : dry Light: c How: of	Crash I Light: day How: ss-san Complaint N Veh Type car car car Crash I	D: 8398223 ne lo: Damage rtfront Iftside D: 8673085
#8 Location #8 Location Crash Date Injuries K CVT: Troy Unit No 1 2 UD-10: 83 #9 Location Crash Date Injuries K CVT: Troy	0520088 on: DEQU ie: 07/19/2 : 0 Veh Dir S S 98223 on: DEQU ie: 06/22/2 : 0	INDRE RD (10.2012 Day Inj A Area Action Prior change lanes go straight INDRE RD (10.2013 Day: 52 Inj A:	18) 500 feet N o Thu Hour: 10 This is traight Event 1 Veh in transpt Veh in transpt Veh in transpt The intranspt	f E LONG Oam Wood Inj HE Event 2 none none f E LONG Weather Inj C: 1	LAKE RD eather: rai C: 0 BD: N Event 3 none none LAKE RD	in Roa Inj 0 Drug Event 4 none none Roadway: Inj 0: 3 Drugs: N	dway: wet : 2 gs: N Haz Action failed to yield none : dry Light: c How: of	Crash I Light: day How: ss-san Complaint I Veh Type car car car Crash I	D: 8398223 ne lo: Damage rtfront Iftside D: 8673085
#8 Location #8 Location Crash Date Injuries K CVT: Troy Unit No 1 2 UD-10: 83 #9 Location Crash Date Injuries K CVT: Troy	0520088 on: DEQU ie: 07/19/2 : 0 Veh Dir S S 98223 on: DEQU ie: 06/22/2 : 0	INDRE RD (10.2012 Day Inj A Area Action Prior change lanes go straight INDRE RD (10.2013 Day: S Inj A: Area:	.18) 500 feet N o : Thu Hour: 10 A: 0 Inj B: 0 a: straight Event 1 veh in transpt veh in transpt veh in transpt .19) 554 feet N o Sat Hour: 9am 0 Inj B: 0 straight	f E LONG Oam Woln Inj HE Event 2 none none f E LONG Weather Inj C: 1 HBD: N	LAKE RD eather: rai C: 0 BD: N Event 3 none none LAKE RD	in Roa Inj 0 Drug Event 4 none none Roadway: Inj 0: 3 Drugs: N	dway: wet : 2 gs: N Haz Action failed to yield none : dry Light: c How: of Compla	Crash I Light: day How: ss-san Complaint N Veh Type car car Crash I day ther aint No: 130	D: 8398223 ne lo: Damage rtfront Iftside D: 8673085
#8 Location Crash Date Injuries K CVT: Troy Unit No 1 2 UD-10: 83 #9 Location Crash Date Injuries K CVT: Troy Unit No Unit No Unit No	0520088 on: DEQU te: 07/19/2 : 0 Veh Dir S S 98223 on: DEQU te: 06/22/2 : 0	INDRE RD (10.2012 Day Inj A Area Action Prior change lanes go straight INDRE RD (10.2013 Day: S Inj A: Area: Action Prior	.18) 500 feet N o : Thu Hour: 16 A: 0 Inj B: 0 a: straight Event 1 veh in transpt veh in transpt veh in transpt .19) 554 feet N o Sat Hour: 9am 0 Inj B: 0 straight Event 1	f E LONG Oam Woln HE Event 2 none none f E LONG Weather Inj C: 1 HBD: N	LAKE RD eather: rai C: 0 BD: N Event 3 none none LAKE RD c: clear	in Roan Inj 0 Drug Event 4 none none Roadways Inj 0: 3 Drugs: N	dway: wet : 2 gs: N Haz Action failed to yield none : dry Light: c How: of Comple	Crash I Light: day How: ss-san Complaint N Veh Type car car Crash I day ther aint No: 130 Veh Type	D: 8398223 ne lo: Damage rtfront Iftside D: 8673085
#8 Location Crash Date Injuries K CVT: Troy Unit No 1 2 UD-10: 83 #9 Location Crash Date Injuries K CVT: Troy Unit No 1 Injuries K CVT: Troy Unit No 1	0520088 on: DEQU te: 07/19/2 : 0 Veh Dir S 98223 on: DEQU te: 06/22/2 : 0 Veh Dir N S	INDRE RD (10.2012 Day Inj A Area Action Prior change lanes go straight INDRE RD (10.2013 Day: S Inj A: Area: Action Prior left turn	a: straight Event 1 veh in transpt veh in transpt 19) 554 feet N o Sat Hour: 9am Inj B: 0 straight Event 1 veh in transpt	f E LONG Oam Woln Inj HE Event 2 none none f E LONG Weather Inj C: 1 HBD: N Event 2 none	LAKE RD eather: rai C: 0 BD: N Event 3 none none LAKE RD c: clear Event 3 none	in Roa Inj 0 Drug Event 4 none none Roadway: Inj 0: 3 Drugs: N Event 4 none	dway: wet : 2 gs: N Haz Action failed to yield none dry Light: c How: or Compla Haz Action failed to yield	Crash I Light: day How: ss-san Complaint N Veh Type car car Crash I day ther aint No: 130 Veh Type car	D: 8398223 ne lo: Damage rtfront Iftside D: 8673085 019432 Damage ctrfront
#8 Location Crash Dat Injuries K CVT: Troy Unit No 1 2 UD-10: 83 #9 Location Crash Dat Injuries K CVT: Troy Unit No 1 2 UD-10: 83	0520088 on: DEQU te: 07/19/2 : 0 Veh Dir S S 98223 on: DEQU te: 06/22/2 : 0 Veh Dir N S 73085	INDRE RD (10.2012 Day Inj A Area Action Prior change lanes go straight INDRE RD (10.2013 Day: S Inj A: Area: Action Prior left turn go straight	.18) 500 feet N o : Thu Hour: 10 A: 0 Inj B: 0 a: straight Event 1 veh in transpt veh in transpt veh in B: 0 Sat Hour: 9am 0 Inj B: 0 straight Event 1 veh in transpt veh in transpt	f E LONG Oam Woln Inj HE Event 2 none none f E LONG Weather Inj C: 1 HBD: N Event 2 none none	LAKE RD eather: rai C: 0 BD: N Event 3 none none LAKE RD c: clear Event 3 none	in Roal Inj 0 Drug Event 4 none none Roadway: Inj 0: 3 Drugs: N Event 4 none none	dway: wet : 2 gs: N Haz Action failed to yield none dry Light: c How: or Compla Haz Action failed to yield	Crash I Light: day How: ss-san Complaint N Veh Type car car Crash I day ther aint No: 130 Veh Type car car	D: 8398223 ne lo: Damage rtfront Iftside D: 8673085 019432 Damage ctrfront ctrfront
#8 Location Crash Date Injuries K CVT: Troy Unit No 1 2 UD-10: 83 #9 Location Crash Date Injuries K CVT: Troy Unit No 1 2 UD-10: 86 #10 Location	0520088 on: DEQU te: 07/19/2 : 0 Veh Dir S 98223 on: DEQU te: 06/22/2 : 0 Veh Dir N S 73085 ion: DEQU	INDRE RD (10.2012 Day Inj A Area Action Prior change lanes go straight INDRE RD (10.2013 Day: Sinj A: Area: Action Prior left turn go straight	.18) 500 feet N o : Thu Hour: 10 A: 0 Inj B: 0 a: straight Event 1 veh in transpt veh in transpt .19) 554 feet N o Sat Hour: 9am 0 Inj B: 0 straight Event 1 veh in transpt veh in transpt veh in transpt	f E LONG Oam Wining HE Event 2 none none f E LONG Weather Inj C: 1 HBD: N Event 2 none none	LAKE RD eather: rai C: 0 BD: N Event 3 none none LAKE RD c: clear Event 3 none none	in Roa Inj 0 Drug Roadway: Inj 0: 3 Drugs: N Event 4 none none	dway: wet : 2 gs: N Haz Action failed to yield none : dry Light: c How: or Compla Haz Action failed to yield none	Crash I Light: day How: ss-san Complaint I Veh Type car car Crash I day ther aint No: 130 Veh Type car car	D: 8398223 ne lo: Damage rtfront Iftside D: 8673085 019432 Damage ctrfront
#8 Location Crash Date Injuries K CVT: Troy Unit No 1 2 UD-10: 83 #9 Location Crash Date Injuries K CVT: Troy Unit No 1 2 UD-10: 86 #10 Locate Crash Date Crash Date	0520088 on: DEQU te: 07/19/2 : 0 Veh Dir S 98223 on: DEQU te: 06/22/2 : 0 Veh Dir N S 73085 ion: DEQU te: 07/16/2	INDRE RD (10.2012 Day Inj A Area Action Prior change lanes go straight INDRE RD (10.2013 Day: S Inj A: Area: Action Prior left turn go straight UINDRE RD (10.2013 Day: T	a: straight Event 1 veh in transpt veh in transpt 19) 554 feet N o Sat Hour: 9am Inj B: 0 straight Event 1 veh in transpt 0 Inj B: 0 straight Event 1 veh in transpt veh in transpt veh in transpt	f E LONG Oam Wood Inj HE Event 2 none none f E LONG Weather Inj C: 1 HBD: N Event 2 none none of E LONG	LAKE RD eather: rai C: 0 BD: N Event 3 none none LAKE RD c: clear Event 3 none none	in Roal Inj 0 Drug Event 4 none none Roadway: Inj 0: 3 Drugs: N Event 4 none none	dway: wet : 2 gs: N Haz Action failed to yield none dry Light: of Complate Haz Action failed to yield none	Crash I Light: day How: ss-san Complaint I Veh Type car car Crash I day ther hint No: 130 Veh Type car car Crash I day	D: 8398223 ne lo: Damage rtfront Iftside D: 8673085 019432 Damage ctrfront ctrfront
#8 Location Crash Date Injuries K CVT: Troy Unit No 1 2 UD-10: 83 #9 Location Crash Date Injuries K CVT: Troy Unit No 1 2 UD-10: 86 #10 Location	0520088 on: DEQU te: 07/19/2 : 0 Veh Dir S 98223 on: DEQU te: 06/22/2 : 0 Veh Dir N S 73085 ion: DEQU te: 07/16/2 : 0	INDRE RD (10.2012 Day Inj A Area Action Prior change lanes go straight INDRE RD (10.2013 Day: S Inj A: Area: Action Prior left turn go straight UINDRE RD (10.2013 Day: T Inj A: (10.2013 Day: T	a: straight Event 1 veh in transpt veh in transpt 19) 554 feet N o Sat Hour: 9am Inj B: 0 straight Event 1 veh in transpt 0 Inj B: 0 straight Event 1 veh in transpt veh in transpt veh in transpt	f E LONG Oam Wining HE Event 2 none none f E LONG Weather Inj C: 1 HBD: N Event 2 none none	LAKE RD eather: rai C: 0 BD: N Event 3 none none LAKE RD c: clear Event 3 none none	in Roa Inj 0 Drug Roadway: Inj 0: 3 Drugs: N Event 4 none none	dway: wet : 2 gs: N Haz Action failed to yield none dry Light: of Compla Haz Action failed to yield none	Crash I Light: day How: ss-san Complaint I Veh Type car car Crash I day ther hint No: 130 Veh Type car car Crash I day	D: 8398223 ne lo: Damage rtfront Iftside D: 8673085 Damage ctrfront ctrfront Ctrfront
#8 Location Crash Date Injuries K CVT: Troy Unit No 1 2 UD-10: 83 #9 Location Crash Date Injuries K CVT: Troy Unit No 1 2 UD-10: 86 #10 Locate Crash Date Injuries K CVT: Troy	0520088 on: DEQU te: 07/19/2 : 0 Veh Dir S 98223 on: DEQU te: 06/22/2 : 0 Veh Dir N S 73085 ion: DEQU te: 07/16/2 : 0	INDRE RD (10.2012 Day Inj A Area Action Prior change lanes go straight INDRE RD (10.2013 Day: S Inj A: Area: Action Prior left turn go straight UINDRE RD (11.2013 Day: T Inj A: (Area: i	a: straight Event 1 veh in transpt veh in transpt 19) 554 feet N o at Hour: 9am Inj B: 0 straight Event 1 veh in transpt 19) 554 feet N o at Hour: 9am Inj B: 0 straight Event 1 veh in transpt veh in transpt veh in transpt Inj B: 0 Inter driveway	f E LONG Oam Wo Inj HE Event 2 none none f E LONG Weather Inj C: 1 HBD: N Event 2 none none	LAKE RD eather: rai C: 0 BD: N Event 3 none none LAKE RD c: clear Event 3 none none	in Roaminj 0 Drug Event 4 none none Roadway: Inj 0: 3 Drugs: N Event 4 none none Roadway Inj 0: 2 Drugs: N	dway: wet : 2 gs: N Haz Action failed to yield none : dry Light: o Compla Haz Action failed to yield none	Crash I Light: day How: ss-san Complaint N Veh Type car car Crash I day ther aint No: 130 Veh Type car car Crash I day ngle aint No: 130	D: 8398223 ne lo: Damage rtfront Iftside D: 8673085 Damage ctrfront ctrfront ctrfront 0: 8689141
#8 Location Crash Date Injuries K CVT: Troy Unit No 1 2 UD-10: 83 #9 Location Crash Date Injuries K CVT: Troy Unit No 1 2 UD-10: 86 #10 Locate Crash Date Injuries K CVT: Troy	0520088 on: DEQU te: 07/19/2 : 0 Veh Dir S 98223 on: DEQU te: 06/22/2 : 0 Veh Dir N S 73085 ion: DEQU te: 07/16/2 : 0	INDRE RD (10.2012 Day Inj A Area Action Prior change lanes go straight INDRE RD (10.2013 Day: S Inj A: Area: Action Prior left turn go straight UINDRE RD (10.2013 Day: T Inj A: (Area: i Action Prior	a: straight Event 1 veh in transpt veh in transpt 19) 554 feet N o Sat Hour: 9am Inj B: 0 straight Event 1 veh in transpt veh in transpt veh in transpt I veh in transpt	f E LONG Oam Winder Inj HE Event 2 none none f E LONG Weather Inj C: 1 HBD: N Event 2 none none of E LONG Weather Inj C: 1 HBD: N Event 2 HBD: N	LAKE RD eather: rai C: 0 BD: N Event 3 none none LAKE RD c: clear Event 3 none none	in Roalinj 0 Drug Event 4 none none Roadway: Inj 0: 3 Drugs: N Event 4 none none Roadway Inj 0: 2 Drugs: N Event 4	dway: wet : 2 gs: N Haz Action failed to yield none : dry Light: o	Crash I Light: day How: ss-san Complaint N Veh Type car car Crash I day ther car car Crash I day ngle aint No: 130 Veh Type Car Crash I day ngle aint No: 130	D: 8398223 ne lo: Damage rtfront Iftside D: 8673085 D19432 Damage ctrfront ctrfront D: 8689141
#8 Location Crash Date Injuries K CVT: Troy Unit No 1 2 UD-10: 83 #9 Location Crash Date Injuries K CVT: Troy Unit No 1 2 UD-10: 86 #10 Locate Crash Date Injuries K CVT: Troy	0520088 on: DEQU te: 07/19/2 : 0 Veh Dir S 98223 on: DEQU te: 06/22/2 : 0 Veh Dir N S 73085 ion: DEQU te: 07/16/2 : 0	INDRE RD (10.2012 Day Inj A Area Action Prior change lanes go straight INDRE RD (10.2013 Day: S Inj A: Area: Action Prior left turn go straight UINDRE RD (11.2013 Day: T Inj A: (Area: i	a: straight Event 1 veh in transpt veh in transpt 19) 554 feet N o at Hour: 9am Inj B: 0 straight Event 1 veh in transpt 19) 554 feet N o at Hour: 9am Inj B: 0 straight Event 1 veh in transpt veh in transpt veh in transpt Inj B: 0 Inter driveway	f E LONG Oam Wo Inj HE Event 2 none none f E LONG Weather Inj C: 1 HBD: N Event 2 none none	LAKE RD eather: rai C: 0 BD: N Event 3 none none LAKE RD c: clear Event 3 none none	in Roaminj 0 Drug Event 4 none none Roadway: Inj 0: 3 Drugs: N Event 4 none none Roadway Inj 0: 2 Drugs: N	dway: wet : 2 gs: N Haz Action failed to yield none : dry Light: o Compla Haz Action failed to yield none	Crash I Light: day How: ss-san Complaint N Veh Type car car Crash I day ther aint No: 130 Veh Type car car Crash I day ngle aint No: 130	D: 8398223 ne lo: Damage rtfront Iftside D: 8673085 Damage ctrfront ctrfront ctrfront 0: 8689141

2 of 7

Crash Dat njuries K CVT: Troy		Inj A: 0	Inj B: 0	Weather Inj C: 0 HBD: N	. cloudy	Roadwa Inj 0: 5 Drugs: N	How:	: day rr-end blaint No: 130	0038928
1 2	S S	Action Prior slow/stop on ro stop on road	Event 1 d veh in transpt veh in transpt	none	Event 3 none none	Event 4 none none	Haz Action unable to sto none		Damage ctrfront ctrrear
JD-10: 88		LUNDDE DD /4/	0.40\ 400 fo at N	of E LONG	NI AKE DE			Creab I	D . 0200700
∓ı∠ Locat Crash Dat		•	0.16) 400 feet N Mon Hour: 5pm			ر Roadway	r: dry Light		D : 9388769
njuries K		Inj A: (•	Inj C: 0	II oloui	Inj 0: 2	How:	-	
CVT: Troy		-	inter driveway	HBD: N		Drugs: N		laint No: 150	031207
Unit No	Veh Dir	Action Prior	Event 1	Event 2	Event 3	Event 4	Haz Action	Veh Type	Damage
1	W	left turn	veh in transpt	none	none	none	failed to yield		rtside
2	S	go straight	veh in transpt	none	none	none	none	car	ctrfront
JD-10: 93	88769		•						
#13 Locat	ion: DEQ	UINDRE RD (1	0.18) 500 feet N	of E LONG	LAKE RI)		Crash I	D : 9473230
Crash Dat	e: 12/15/2	2015 Day: T	ue Hour: 6pm	Weathe	r: clear	Roadway	: dry Light:	dark/unltd	
njuries K	: 0	Inj A:	0 Inj B: 0	Inj C : 0		Inj 0 : 2	How:	rr-end	
CVT: Troy		Area:	straight	HBD: N		Drugs: N	Comp	laint No : 150	040871
Unit No	Veh Dir	Action Prior	Event 1	Event 2	Event 3	Event 4	Haz Action	Veh Type	Damage
1	0		veh in transpt	none	none	none	unable to sto	p car	ctrfront
•	S	start on rdwy	ven in nanspi	110110					
2	S	start on rdwy	•		none	none	none	car	ctrrear
=	S	•	•			none	none	car	ctrrear
2 UD-10: 94	S 73230	slow/stop on ro	•	none	none		none		ctrrear D: 9989840
2 UD-10: 94	S 73230 ion: DEQ	slow/stop on ro	d veh in transpt	none of E LONG	none LAKE RI				
2 JD-10: 94 #14 Locat Crash Dat njuries K	S 73230 ion: DEQ te: 03/13/2	UINDRE RD (10 2017 Day: Mo	0.19) 600 feet N on Hour: 7pm Inj B: 0	none of E LONG	none LAKE RI cloudy	O Roadway Inj 0: 1	: snow Ligh How	Crash I t: dark/ltd : single	D : 9989840
2 UD-10: 94 #14 Locat Crash Dat	S 73230 ion: DEQ te: 03/13/2	slow/stop on ro UINDRE RD (10 2017 Day: Me	0.19) 600 feet N on Hour: 7pm Inj B: 0	none of E LONG Weather:	none LAKE RI cloudy	⊃ Roadway	: snow Ligh How	Crash I t: dark/ltd	D : 9989840
2 UD-10: 94 #14 Locat Crash Dat injuries K	S 73230 ion: DEQ te: 03/13/2 : 0	UINDRE RD (10 2017 Day: Mo	0.19) 600 feet N on Hour: 7pm Inj B: 0	none of E LONG Weather: Inj C: 0 HBD: Y	none S LAKE RI cloudy	O Roadway Inj 0: 1 Drugs: N	: snow Ligh How	Crash I t: dark/ltd : single	D : 9989840
2 UD-10: 94 #14 Locat Crash Dat injuries K	S 73230 ion: DEQ te: 03/13/2 : 0	UINDRE RD (10 2017 Day: Mo Inj A: 0 Area: s	0.19) 600 feet N on Hour: 7pm Inj B: 0 traight	none of E LONG Weather: Inj C: 0 HBD: Y Event 2	none LAKE RI cloudy Event 3	C Roadway Inj 0: 1 Drugs: N	: snow Ligh How Com	Crash I t: dark/ltd : single plaint No: 17 Veh Type	D : 9989840
2 UD-10: 94 #14 Locat Crash Dat njuries K CVT: Troy Unit No	S 73230 ion: DEQ ie: 03/13/2 : 0 Veh Dir S	UINDRE RD (10 2017 Day: Mo Inj A: 0 Area: s	0.19) 600 feet Non Hour: 7pm Inj B: 0 traight Event 1	none of E LONG Weather: Inj C: 0 HBD: Y Event 2	none LAKE RI cloudy Event 3	C Roadway Inj 0: 1 Drugs: N	: snow Ligh How Com	Crash I t: dark/ltd : single plaint No: 17 Veh Type	D : 9989840 0007770 Damage
2 UD-10: 94 #14 Locat Crash Dat njuries K CVT: Troy Unit No 1 UD-10: 99	\$ 73230 ion: DEQ te: 03/13/2 : 0 Veh Dir \$ 89840	UINDRE RD (10 2017 Day: Monitor No. 10 Inj A: 0 Area: s Action Prior go straight	0.19) 600 feet Non Hour: 7pm Inj B: 0 traight Event 1	none of E LONG Weather: Inj C: 0 HBD: Y Event 2 mailbox	none B LAKE RI cloudy Event 3 ditch	O Roadway Inj 0: 1 Drugs: N Event 4 none	: snow Ligh How Com	Crash I t: dark/ltd : single plaint No: 17 Veh Type pickup	D : 9989840 0007770 Damage
2 UD-10: 94 #14 Locat Crash Dat njuries K CVT: Troy Unit No 1 UD-10: 99	S 73230 ion: DEQ ie: 03/13/2 : 0 Veh Dir S 89840 ion: DEQ	UINDRE RD (10 2017 Day: Monitor Inj A: 0 Area: s Action Prior go straight	0.19) 600 feet Non Hour: 7pm Inj B: 0 traight Event 1 ran off road/r	none of E LONG Weather: Inj C: 0 HBD: Y Event 2 mailbox of E LONG	none B LAKE RI cloudy Event 3 ditch	O Roadway Inj 0: 1 Drugs: N Event 4 none	: snow Ligh How Com Haz Action carels driving	Crash I t: dark/ltd : single plaint No: 17 Veh Type pickup	D: 9989840 0007770 Damage multiple
2 UD-10: 94 #14 Locat Crash Dat injuries K CVT: Troy Unit No 1 UD-10: 99	S 73230 ion: DEQ te: 03/13/2 : 0 Veh Dir S 89840 ion: DEQ te: 09/11/2	UINDRE RD (10 2017 Day: Monitor Inj A: 0 Area: s Action Prior go straight	o.19) 600 feet Non Hour: 7pm Inj B: 0 traight Event 1 ran off road/r 0.15) 375 feet Noue Hour: 3pm	none of E LONG Weather: Inj C: 0 HBD: Y Event 2 mailbox of E LONG	none B LAKE RI cloudy Event 3 ditch B LAKE RI c: clear	Roadway Inj 0: 1 Drugs: N Event 4 none	: snow Ligh How Com Haz Action carels driving	Crash I t: dark/ltd : single plaint No: 17 Veh Type pickup Crash I	D: 9989840 0007770 Damage multiple
2 UD-10: 94 #14 Locat Crash Dat njuries K CVT: Troy Unit No 1 UD-10: 99 #15 Locat Crash Dat	S 73230 ion: DEQ te: 03/13/2 : 0 Veh Dir S 89840 ion: DEQ te: 09/11/2 : 0	UINDRE RD (102017 Day: Months of the Inj A: 0 Area: s Action Prior go straight UINDRE RD (102018 Day: Tolon Inj A: 0 I	o.19) 600 feet Non Hour: 7pm Inj B: 0 traight Event 1 ran off road/r 0.15) 375 feet Noue Hour: 3pm	none of E LONG Weather: Inj C: 0 HBD: Y Event 2 mailbox of E LONG Weather	none B LAKE RI cloudy Event 3 ditch B LAKE RI T: clear	Control Contro	: snow Ligh How Com Haz Action carels driving : dry Light: How:	Crash I t: dark/ltd : single plaint No: 17 Veh Type pickup Crash I	D: 9989840 0007770 Damage multiple D: 1484607
JD-10: 94 #14 Locat Crash Dat njuries K CVT: Troy Unit No 1 JD-10: 99 #15 Locat Crash Dat njuries K CVT: Troy	S 73230 ion: DEQ te: 03/13/2 : 0 Veh Dir S 89840 ion: DEQ te: 09/11/2 : 0	UINDRE RD (102017 Day: Months of the Inj A: 0 Area: s Action Prior go straight UINDRE RD (102018 Day: Tolon Inj A: 0 I	o.19) 600 feet Non Hour: 7pm Inj B: 0 traight Event 1 ran off road/r 0.15) 375 feet Noue Hour: 3pm 0 Inj B: 0 driveway	of E LONG Weather: Inj C: 0 HBD: Y Event 2 mailbox of E LONG Weather Inj C: 1 HBD: N	none G LAKE RI cloudy Event 3 ditch G LAKE RI	Control Contro	: snow Ligh How Com Haz Action carels driving : dry Light: How:	Crash I t: dark/ltd t: single plaint No: 17 Veh Type pickup Crash I day angle	D: 9989840 0007770 Damage multiple D: 1484607
JD-10: 94 #14 Locat Crash Dat njuries K CVT: Troy Unit No 1 JD-10: 99 #15 Locat Crash Dat njuries K CVT: Troy	S 73230 ion: DEQ te: 03/13/2 : 0 Veh Dir S 89840 ion: DEQ te: 09/11/2 : 0	UINDRE RD (102017 Day: Months of the Inj A: 0 Area: s Action Prior go straight UINDRE RD (102018 Day: Tolling A: 0 Area: s	o.19) 600 feet Non Hour: 7pm Inj B: 0 traight Event 1 ran off road/r 0.15) 375 feet Noue Hour: 3pm 0 Inj B: 0 driveway	of E LONG Weather: Inj C: 0 HBD: Y Event 2 mailbox of E LONG Weather Inj C: 1 HBD: N	Event 3 ditch Class Clear Event 3	Control Contro	: snow Ligh How Com Haz Action carels driving : dry Light: How: Comp	Crash I t: dark/ltd t: single plaint No: 17 Veh Type pickup Crash I day angle laint No: 180 Veh Type	D: 9989840 0007770 Damage multiple D: 1484607
JD-10: 94 #14 Locat Crash Dat Injuries K CVT: Troy Unit No 1 JD-10: 99 #15 Locat Crash Dat Injuries K CVT: Troy Unit No Unit No	S 73230 ion: DEQ te: 03/13/2 : 0 Veh Dir S 89840 ion: DEQ te: 09/11/2 : 0	UINDRE RD (102017 Day: Months of the Inj A: 0 Area: s Action Prior go straight UINDRE RD (102018 Day: Tolinj A: 0 Area: Action Prior Inj Area: Action Prior	o.19) 600 feet Non Hour: 7pm Inj B: 0 traight Event 1 ran off road/r 0.15) 375 feet Noue Hour: 3pm Inj B: 0 driveway Event 1	none of E LONG Weather: Inj C: 0 HBD: Y Event 2 mailbox of E LONG Weather Inj C: 1 HBD: N Event 2 none	Event 3 ditch Cloudy Event 3 ditch Cloudy Cloudy	Roadway Inj 0: 1 Drugs: N Event 4 none Roadway Inj 0: 1 Drugs: N Event 4	: snow Light How Com Haz Action carels driving : dry Light: How: Comp	Crash I t: dark/ltd t: single plaint No: 17 Veh Type pickup Crash I day angle laint No: 180 Veh Type	D: 9989840 0007770 Damage multiple D: 1484607 031587 Damage
2 JD-10: 94 #14 Locat Crash Dat njuries K CVT: Troy Unit No 1 JD-10: 99 #15 Locat Crash Dat njuries K CVT: Troy Unit No	S 73230 ion: DEQ te: 03/13/2 : 0 Veh Dir S 89840 ion: DEQ te: 09/11/2 : 0	UINDRE RD (10 2017 Day: Month Inj A: 0 Area: s Action Prior go straight UINDRE RD (10 2018 Day: Toler Inj A: 0 Area: Action Prior left turn	0.19) 600 feet Noon Hour: 7pm Inj B: 0 traight Event 1 ran off road/r 0.15) 375 feet Note Hour: 3pm 0 Inj B: 0 driveway Event 1 veh in transpt	none of E LONG Weather: Inj C: 0 HBD: Y Event 2 mailbox of E LONG Weather Inj C: 1 HBD: N Event 2 none	Event 3 ditch Cloudy Event 3 ditch Cloudy Cloudy	Roadway Inj 0: 1 Drugs: N Event 4 none Roadway Inj 0: 1 Drugs: N Event 4 none	: snow Ligh How Com Haz Action carels driving : dry Light: How: Comp Haz Action unable to stop	Crash I t: dark/ltd : single plaint No: 17 Veh Type pickup Crash I day angle laint No: 180 Veh Type	D: 9989840 0007770 Damage multiple D: 1484607 031587 Damage rtside
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2 JD-10: 94 #14 Locat Crash Dat njuries K CVT: Troy Unit No 1 JD-10: 99 #15 Locat Crash Dat njuries K CVT: Troy Unit No 1 2 JD-10: 14 #16 Locat Crash Dat njuries K	S 73230 ion: DEQ te: 03/13/2 : 0 Veh Dir S 89840 ion: DEQ te: 09/11/2 : 0 Veh Dir W S 84607 ion: DEQ te: 09/14/2 : 0	UINDRE RD (102017 Day: Months of the Inj A: 0 Area: s Action Prior go straight UINDRE RD (102018 Day: Tolen Area: s Action Prior left turn go straight UINDRE RD (102018 UINDRE UIN	d veh in transpt 0.19) 600 feet Noon Hour: 7pm Inj B: 0 traight Event 1 ran off road/r 0.15) 375 feet Noue Hour: 3pm 0 Inj B: 0 driveway Event 1 veh in transpt veh in transpt veh in transpt 0.17) 470 feet Noon Fri Hour: 7am	none of E LONG Weather: Inj C: 0 HBD: Y Event 2 mailbox of E LONG Weather Inj C: 1 HBD: N Event 2 none none	Event 3 ditch Event 3 none none LAKE RI Clear Event 3 none none	Roadway Inj 0: 1 Drugs: N Event 4 none Roadway Inj 0: 1 Drugs: N Event 4 none none	: snow Light How Com Haz Action carels driving : dry Light: How: Comp Haz Action unable to stop none dry Light: How: a	Crash I t: dark/ltd : single plaint No: 17 Veh Type pickup Crash I day angle laint No: 180 Veh Type car car Crash I day	D: 9989840 0007770 Damage multiple D: 1484607 031587 Damage rtside ctrfront D: 1485982
JD-10: 94 #14 Locat Crash Dat njuries K CVT: Troy Unit No 1 JD-10: 99 #15 Locat Crash Dat njuries K CVT: Troy Unit No 1 2 JD-10: 14 #16 Locat Crash Dat	S 73230 ion: DEQ te: 03/13/2 : 0 Veh Dir S 89840 ion: DEQ te: 09/11/2 : 0 Veh Dir W S 84607 ion: DEQ te: 09/14/2 : 0	UINDRE RD (10 2017 Day: Monday: Monday: Section Prior go straight UINDRE RD (10 2018 Day: Toler turn Go straight UINDRE RD (10 2018 Day: Toler turn Go straight UINDRE RD (10 2018 Day: Toler turn Go straight UINDRE RD (10 2018 Day: Toler turn Go straight	d veh in transpt 0.19) 600 feet Noon Hour: 7pm Inj B: 0 traight Event 1 ran off road/r 0.15) 375 feet Noue Hour: 3pm 0 Inj B: 0 driveway Event 1 veh in transpt veh in transpt veh in transpt 0.17) 470 feet Noon Fri Hour: 7am	none of E LONG Weather: Inj C: 0 HBD: Y Event 2 mailbox of E LONG Weather Inj C: 1 HBD: N Event 2 none none of E LONG Weather	Event 3 ditch Event 3 none none LAKE RI Clear Event 3 none none	Roadway Inj 0: 1 Drugs: N Event 4 none Roadway Inj 0: 1 Drugs: N Event 4 none none	: snow Light How Com Haz Action carels driving : dry Light: How: Comp Haz Action unable to stop none dry Light: How: a	Crash I t: dark/ltd t: single plaint No: 17 Veh Type pickup Crash I day angle laint No: 180 Veh Type car car Crash I day	D: 9989840 0007770 Damage multiple D: 1484607 031587 Damage rtside ctrfront D: 1485982
JD-10: 94 #14 Locat Crash Dat njuries K: CVT: Troy Unit No 1 JD-10: 99 #15 Locat Crash Dat njuries K: CVT: Troy Unit No 1 2 JD-10: 14 #16 Locat Crash Dat njuries K: CVT: Troy	S 73230 ion: DEQ te: 03/13/2 : 0 Veh Dir S 89840 ion: DEQ te: 09/11/2 : 0 Veh Dir W S 84607 ion: DEQ	UINDRE RD (10 2017 Day: Monday: Monday: Section Prior go straight UINDRE RD (10 2018 Day: Toler turn Go straight UINDRE RD (10 2018 Day: Toler turn Go straight UINDRE RD (10 2018 Day: Toler turn Go straight UINDRE RD (10 2018 Day: Toler turn Go straight	o.19) 600 feet Noon Hour: 7pm Inj B: 0 traight Event 1 ran off road/r 0.15) 375 feet Noue Hour: 3pm 0 Inj B: 0 driveway Event 1 veh in transpt veh in transpt veh in transpt veh in transpt 0.17) 470 feet Noon Fri Hour: 7am 0 Inj B: 0	of E LONG Weather: Inj C: 0 HBD: Y Event 2 mailbox of E LONG Weather Inj C: 1 HBD: N Event 2 none none of E LONG Weather Inj C: 0 HBD: N	Event 3 ditch Event 3 none none ELAKE RI Clear Event 3 none none ELAKE RI Clear	Roadway Inj 0: 1 Drugs: N Event 4 none Roadway Inj 0: 1 Drugs: N Event 4 none none	: snow Light How Com Haz Action carels driving : dry Light: How: Comp Haz Action unable to stop none dry Light: How: a	Crash I t: dark/ltd : single plaint No: 17 Veh Type pickup Crash I day angle laint No: 180 Veh Type car car Crash I day	D: 9989840 0007770 Damage multiple D: 1484607 031587 Damage rtside ctrfront D: 1485982
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JD-10: 94 #14 Locat Crash Dat njuries K CVT: Troy Unit No 1 JD-10: 99 #15 Locat Crash Dat njuries K CVT: Troy Unit No 1 2 JD-10: 14 #16 Locat Crash Dat njuries K CVT: Troy Unit No 1 2 UD-10: 14 #16 Locat Crash Dat njuries K CVT: Troy Unit No Unit No	S 73230 ion: DEQ te: 03/13/2 : 0 Veh Dir S 89840 ion: DEQ te: 09/11/2 : 0 Veh Dir W S 84607 ion: DEQ te: 09/14/2 : 0	UINDRE RD (102017 Day: Morea: s Action Prior go straight UINDRE RD (102018 Day: Tolent turn go straight	o.19) 600 feet Non Hour: 7pm Inj B: 0 traight Event 1 ran off road/r 0.15) 375 feet Noue Hour: 3pm 0 Inj B: 0 driveway Event 1 veh in transpt	none of E LONG Weather: Inj C: 0 HBD: Y Event 2 mailbox of E LONG Weather Inj C: 1 HBD: N Event 2 none none of E LONG Weather Inj C: 0 HBD: N Event 2	Event 3 none Event 3 ditch Event 3 none none ELAKE RI r: clear	Roadway Inj 0: 1 Drugs: N Event 4 none Roadway Inj 0: 1 Drugs: N Event 4 none none Roadway: nj 0: 2 Drugs: N Event 4	: snow Ligh How Com Haz Action carels driving : dry Light: How: Comp Haz Action unable to stop none dry Light: How: a Compl	Crash I t: dark/ltd : single plaint No: 17 Veh Type pickup Crash I day angle laint No: 180 Veh Type car car Crash I day ngle aint No: 1800 Veh Type	D: 9989840 0007770 Damage multiple D: 1484607 031587 Damage rtside ctrfront D: 1485982

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Crash Date Injuries K: CVT: Sterlii	e: 11/01/2 0	2018 Day: Inj A	10.18) 528 feet N Thu Hour: 5pi .: 0 Inj B: 0 i: driveway		her: rain 0	Roadwa Inj 0: 2 Drugs:	How:	Crash II : dusk ss-same plaint No: 18	D : 1518234 342770
Unit No 1 2 UD-10: 151	NE N	Action Prior enter rdwy go straight	Event 1 veh in transpt veh in transpt	none	Event 3 none none	Event 4 none none	Haz Action failed to yield none	Veh Type car car	Damage rtside lftside
#18 Locati Crash Date Injuries K: CVT: Troy	e: 04/24/2	2019 Day: '	10.16) 400 feet N Wed Hour: 2pn 0 Inj B: 0 straight		er: clear)	D Roadwa Inj 0: 2 Drugs: N	How: r	day	D: 1697010
	S S	Action Prior go straight stop on road	Event 1 veh in transpt	Event 2 none none	Event 3 none none		Haz Action unable to stop none	Veh Type car car	
#19 Locati Crash Date Injuries K: CVT: Troy	e: 05/23/2	2019 Day: Inj A :	10.19) 600 feet N Thu Hour: 7an : 0 Inj B: 0 : driveway		er: rain)	D Roadway Inj 0: 2 Drugs: N	How: a	lay	D : 1720931 017832
Unit No 1 2 UD-10: 172	S E	Action Prior go straight enter rdwy	Event 1 veh in transpt veh in transpt	Event 2 none none	Event 3 none none	Event 4 none none	Haz Action imprp passing none	Veh Type car car	Damage rtside ctrfront
#20 Locati Crash Date Injuries K: CVT: Troy	e: 07/24/2	2019 Day: \ Inj A:	10.16) 450 feet N Wed Hour: 12p 0 Inj B: 0 straight		ner: clear 0	D Roadwa Inj 0: 5 Drugs:	How: r	day	D : 1772216
Unit No		Action Prior			Event 3 none		Haz Action unable to stop	Veh Type car	Damage ctrfront
1 2 UD-10: 177	S S 72216	go straight stop on road	veh in transpt		none	none	none	car	ctrrear
2 UD-10: 17 7	S 72216 on: DEQU e: 08/02/2	stop on road UINDRE RD (1 2019 Day:	veh in transpt 10.16) 428 feet N Fri Hour: 7am	none of 18 MILI	none E RD er: clear		none ay: dry Light How:	car Crash II	ctrrear D: 1766635
2 UD-10: 177 #21 Locati Crash Date Injuries K: CVT: Sterlin Unit No 1 2 3	S 72216 on: DEQI e: 08/02/2 0 ng Height Veh Dir N N	stop on road UINDRE RD (1 2019 Day:	veh in transpt 10.16) 428 feet N : Fri Hour: 7am x: 0 Inj B: 0 a: driveway Event 1	of 18 MILI Weather Inj C: 0 HBD: N Event 2 veh in tran	none E RD er: clear) N	Roadwa Inj 0: 4 Drugs: nt 3 Ever e none e none	none ay: dry Light How: N Comp nt 4 Haz Action other e none	car Crash II : day rr-end blaint No: 19	ctrrear D: 1766635
#21 Locati Crash Date Injuries K: CVT: Sterlin Unit No 1 2 3 UD-10: 176 #22 Locati Crash Date Injuries K: CVT: Sterlin	S 72216 on: DEQI e: 08/02/2 0 ng Height Veh Dir N N N 66635 on: NB D e: 10/26/2 0 ng Height	UINDRE RD (12019 Day: Inj A s Area Action Prior change lanes go straight right turn EQUINDRE R 2019 Day: Inj A	veh in transpt 10.16) 428 feet N Fri Hour: 7am 10.16) 11 B: 0 11 driveway Event 1 veh in transpt 10 (10.20) 528 feet Sat Hour: 10p 10 Inj B: 0 11 straight	of 18 MILI Meather Inj C: 0 HBD: N Event 2 veh in trannone none et S of HER	none E RD er: clear) N Even none none RITAGE P cher: clear : 0 : N	Roadwa Inj 0: 4 Drugs: nt 3 Ever e none e none OINTE DF Roadwa Inj 0: 2 Drugs	none ay: dry Light How: N Comp at 4 Haz Action other none none none R way: wet Light How: How:	Crash II : day rr-end Dlaint No: 19 n Veh Type pickup car truck/bus Crash II nt: dark/ltd v: ss-same nplaint No:	ctrrear D: 1766635 D29929 Damage rtfront rtrear none D: 1860574

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UD-10: 1860574

#23 Locati	on: DEQI	JINDRE RD (10	.19) 600 feet N	of W LON	G LAKE F	RD.			Crash I	I D: 1895811
Crash Date	e: 11/26/2	019 Day: Tu	e Hour: 12pm	Weath	er: clear	Roadwa	y: dry	Light:	day	
Injuries K:	0	Inj A: 0	Inj B: 0	Inj C: 0)	Inj 0: 2		How: a	ngle	
CVT: Troy		Area: d	riveway	HBD: N	١	Drugs: N	1	Comple	aint No: 190	0041098
Unit No	Veh Dir	Action Prior	Event 1	Event 2	Event 3	Event 4	Haz A	ction	Veh Type	Damage
1	E	enter rdwy	veh in transpt	none	none	none	failed	to yield	car	Iftfront
2	S	go straight	veh in transpt	none	none	none	none		car	rtrear
UD-10: 189	95811									
#24 Locati	on: DEQI	JINDRE RD (10	.21) 454 feet N	of E LONG	3 LAKE R	D			Crash I	D : 1970997
Crash Dat	e: 02/17/2	020 Day: Mo	n Hour: 11pm	Weathe	r: snow	Roadway	: snow	Light:	dark/unltd	
Injuries K:	0	Inj A : 0	Inj B : 0	Inj C: 0		Inj 0 : 2		How:	head-on/It	
CVT: Troy		Area: st	raight	HBD: Y		Drugs: N		Comp	laint No: 20	0005381
Unit No	Veh Dir	Action Prior	Event 1	Event 2	Event 3	Event 4	Haz	Action	Veh Type	Damage
1	NW	left turn	veh in transpt	none	none	none	impr	o turn	car	ctrfront
2	S	go straight	veh in transpt	none	none	none	none	:	pickup	Iftrear
UD-10: 197	70997									
#25 Locat i	on: DEQl	JINDRE RD (10	.17) 456 feet N	of 18 MILE	E RD				Crash I	D : 2336651
Crash Dat	e: 08/10/2	021 Day: T	ue Hour: 4pm	Weath	er: clear	Roadw	ay: dry	Light	: day	
Injuries K:	0	Inj A:	Inj B: 0	Inj C:	0	Inj 0 : 2		How:	rr-end	
CVT: Sterli	ng Height	s Area:	driveway	HBD:	N	Drugs:	N	Com	olaint No: 2	153305
Unit No	Veh Dir	Action Prior	Event 1	Event 2	Event 3	Event 4	Haz A	ction	Veh Type	Damage
1	W	start on rdwy	veh in transpt	none	none	none	unable	to stop	pickup	ctrfront
2	W	stop on road	veh in transpt	none	none	none	none		car	ctrrear
UD-10: 23										

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Crash Type

	71
Count	Туре
0	uncoded
1	single
0	head-on
2	head-on/lt
8	angle
7	rr-end
0	rr-end/lt
0	rr-end/rt
6	ss-same
0	ss-opp
0	back
1	other
0	unknown
Totals:	25

Light Conditions

Count	Туре
0	uncoded
17	day
0	dawn
2	dusk
2	dark/ltd
4	dark/unltd
0	other
0	unknown
Totals:	25

Weather

Count	Type
0	uncoded
14	clear
0	smoke
4	cloudy
1	fog
4	rain
2	snow
0	wind
0	sleet/hail
0	blowing snow
0	blowing sand
0	unknown
Totals:	25

Road Condition

Count	Туре
0	uncoded
18	dry
0	oily
4	wet
0	ice
3	snow
0	mud
0	slush
0	debris
0	water
0	sand
0	other
0	unknown
Totals:	25

Crashes By Month

Count	Type
0	January
2	February
2	March
1	April
2	May
2	June
4	July
3	August
3	September
2	October
2	November
2	December
Totals:	25

Hazardous Action

Count	Туре
25	none
0	speeding
0	imprp/no signal
0	imprp backing
7	unable to stop
3	other
0	unknown
0	reckls driving
1	carels driving
0	spd too slow
11	failed to yield
0	disrgd traffic cntrl
0	wrong way
0	left of center
1	imprp passing
2	imprp lane use
1	imprp turn
Totals:	51

Unit Type

Count	Туре
0	Bicyclist
0	Engineer
51	Vehicle
0	Pedestrian
Totals:	51

Crashes By Year

Count	Type
0	2000
0	2001
0	2002
0	2003
0	2004
0	2005
0	2006
1	2007
1	2008
0	2009
1	2010
4	2011
1	2012
3	2013
0	2014
2	2015
0	2016
1	2017
3	2018
6	2019
1	2020
1	2021
Totals:	25

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Crash Severity

	FATAL	Α	В	С	No Inj	Total
Persons	0	0	0	5	62	67
Crashes	0	0	0	5	20	25

Alcohol in Crashes

	FATAL	PI	PD	Total
Drinking	0	0	2	2
Not Drinking	0	5	18	23
Total	0	5	20	25

Crashes per Hour by Day

	Sunday	Monday	Tuesday	Wednesday	Thursday	Friday	Saturday	Unknown	Total
12a - 1a	0	0	0	0	0	0	0	0	0
1a - 2a	0	0	0	0	0	0	0	0	0
2a - 3a	0	0	0	0	0	0	0	0	0
3a - 4a	0	0	0	0	0	0	0	0	0
4a - 5a	0	0	0	0	0	0	0	0	0
5a - 6a	0	0	0	0	0	0	0	0	0
6a - 7a	0	0	0	0	0	0	0	0	0
7a - 8a	0	0	0	0	1	2	0	0	3
8a - 9a	0	0	0	0	0	0	0	0	0
9a - 10a	0	0	0	0	0	0	1	0	1
10a - 11a	0	0	1	0	1	0	0	0	2
11a - 12p	0	0	0	0	0	0	0	0	0
12p - 1p	0	0	2	1	0	0	1	0	4
1p - 2p	0	0	0	0	0	0	0	0	0
2p - 3p	0	0	0	1	0	0	0	0	1
3p - 4p	0	0	1	1	0	0	0	0	2
4p - 5p	0	0	1	1	0	0	0	0	2
5p - 6p	0	2	0	0	1	0	0	0	3
6p - 7p	0	0	1	0	0	0	0	0	1
7p - 8p	0	1	1	0	0	1	1	0	4
8p - 9p	0	0	0	0	0	0	0	0	0
9p - 10p	0	0	0	0	0	0	0	0	0
10p - 11p	0	0	0	0	0	0	1	0	1
11p - 12a	0	1	0	0	0	0	0	0	1
Unknown Time	0	0	0	0	0	0	0	0	0
Total	0	4	7	4	3	3	4	0	25

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QUINDRE | PEA JOB NO. 2016-368 | PRELIMINARY SITE PLANS

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GFA 18 MILE & DEQUINDRE

PART OF THE SOUTHEAST 1/4 OF SECTION 12, T.02N., R. 11E., CITY OF TROY, OAKLAND COUNTY, MICHIGAN


PERMIT / APPROVAL SUMMARY

DATE SUBMITTED DATE APPROVED PERMIT / APPROVAL

LEGAL DESCRIPTION
(Per City of Troy Assessor)

PARCEL ID 20-12-476-070 Land in the City of Troy, Oakland County, Michigan, described as follows

Part of Lots 10, 11 and 12 of JENNINGS SUBDIVISION, as recorded in Liber 59, Page 8 Oakland County Records, beginning at point distant North 00 degrees 08 minutes 52 Wes 60 feet and North 89 degrees 32 minutes 26 seconds West 60 feet and North 00 degrees 08 minutes 52 West 493.11 feet from the Southeast section corner; thence North 88 degrees 10 minutes 33 seconds West 170 feet; thence South 75 degrees 18 minutes 2 seconds West 70.21 feet; thence South 00 degrees 08 minutes 52 seconds East 159.98 feet; thence North 88 degrees 11 minutes 10 seconds West 371.57 feet; thence North 00 degrees 08 minutes 43 seconds West 240 feet; thence South 88 degrees 10 minutes 33 seconds East 609.56 feet; thence South 00 degrees 08 minutes 52 seconds East 59.98 feet to beginning.

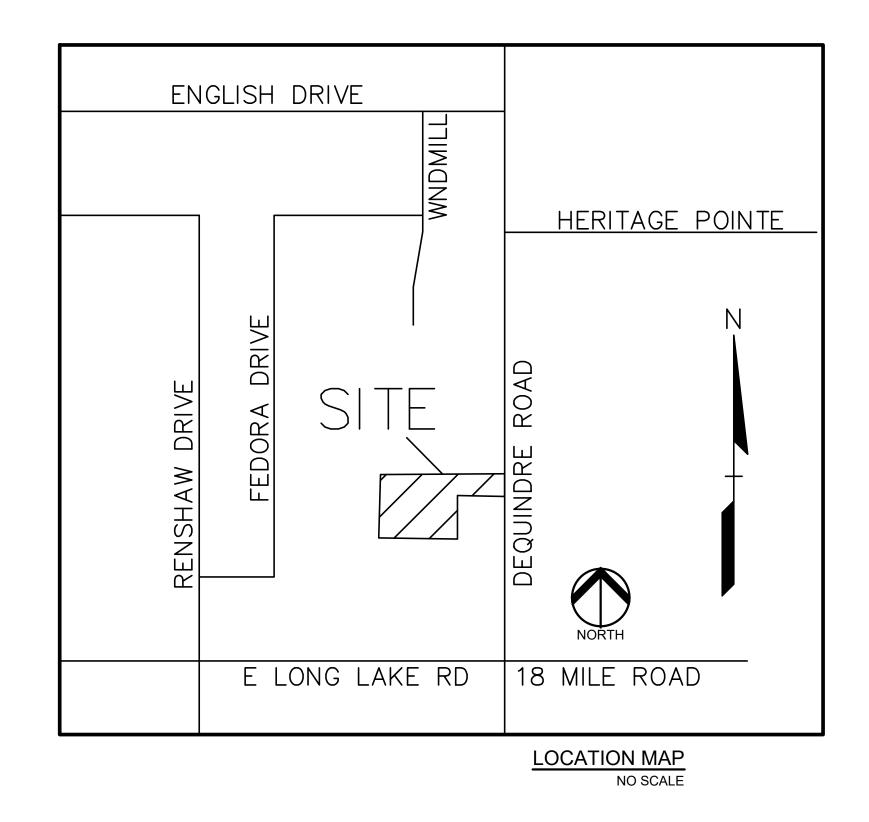

INDEX OF DRAWINGS NUMBER TITLE C-0.0 COVER SHEET C-1.0 TOPOGRAPHIC SURVEY C-2.0 PRELIMINARY SITE PLAN C-3.0 PRELIMINARY GRADING PLAN C-4.0 PRELIMINARY UTILITY PLAN L-1.0 PRELIMINARY LANDSCAPE PLAN T-1.0 PRELIMINARY PRESERVATION PLAN

DESIGN TEAM

OWNER/APPLICANT/DEVELOPER CIVIL ENGINEER

GFA DEVELOPMENT, INC.
986 ELMSFORD DRIVE
TROY, MI 48083
CONTACT: GARY ABITHEIRA
PHONE: 248.840.2828
EMAIL: GFAHOMES@GMAIL.COM


PEA GROUP
2430 ROCHESTER COURT, STE. 100
TROY, MI 48083-1872
CONTACT: JOHN B. THOMPSON, PE
PHONE: 844.813.2949
EMAIL: JTHOMPSON@PEAGROUP.COM


ARCHITECT


MGA ARCHITECTS/DESIGNERS
MOISEEV/GORDON ASSOCIATES, INC.
4351 DELEMERE COURT
ROYAL OAK, MI 48073
CONTACT: ANDREW J. MOISEEV, RA
PHONE: 248.549.4500 EXT. 221
EMAIL: ANDREWM@MGA-ARCHITECTS.NET

LANDSCAPE ARCHITECT

45 W. GRAND RIVER AVE., STE. 501 DETROIT, MI 48226 CONTACT: KIMBERLY DIETZEL, RLA PHONE: 844.813.2949 EMAIL: KDIETZEL@PEAGROUP.COM

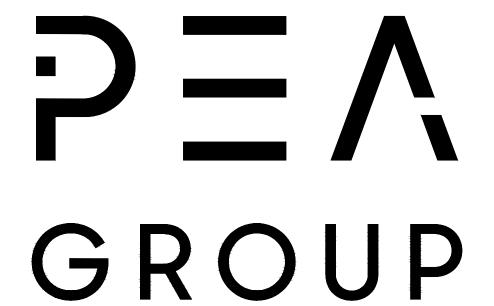

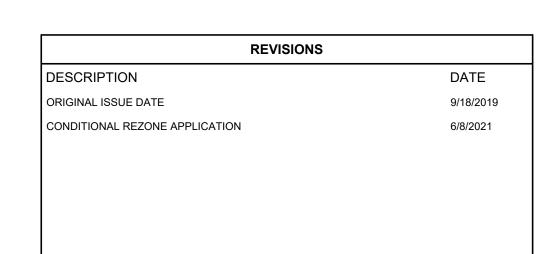

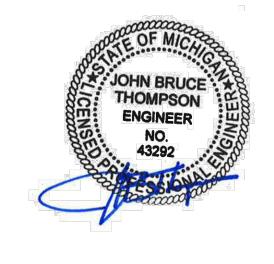

LEGAL DESCRIPTION (Per City of Troy Assessor)

PARCEL ID 20-12-476-070 Land in the City of Troy, Oakland County, Michigan, described as follows:

Part of Lots 10, 11 and 12 of JENNINGS SUBDIVISION, as recorded in Liber 59, Page 8, Oakland County Records, beginning at point distant North 00 degrees 08 minutes 52 West 60 feet and North 89 degrees 32 minutes 26 seconds West 60 feet and North 00 degrees 08 minutes 52 West 493.11 feet from the Southeast section corner; thence North 88 degrees 10 minutes 33 seconds West 170 feet; thence South 75 degrees 18 minutes 21 seconds West 70.21 feet; thence South 00 degrees 08 minutes 52 seconds East 159.98 feet; thence North 88 degrees 11 minutes 10 seconds West 371.57 feet; thence North 00 degrees 08 minutes 43 seconds West 240 feet; thence South 88 degrees 10 minutes 33 seconds East 609.56 feet; thence South 00 degrees 08 minutes 52 seconds East 59.99 feet to beginning.

BM #301 PUNCH MARK ON THE NORTHWEST BOLT OF A LIGHT POLE LOCATED AT THE NORTH SIDE OF THE ARBY'S PARKING LOT, APPROX. 26'± SOUTH OF THE SOUTH PROPERTY LINE. ELEV. - 645.29

BM #300
PUNCH MARK ON ARROW OF A HYDRANT LOCATED ON THE

WEST SIDE OF DEQUINDRE ROAD, APPROX. 45'± NORTHEAST


BENCHMARKS

ELEV. - 645.78

(GPS DERIVED - NAVD88)

OF THE NORTHEAST PROPERTY CORNER.

FLOODPLAIN NOTE: BY GRAPHICAL PLOTTING, SITE IS WITHIN ZONE 'X', AREA DETERMINED TO BE OUTSIDE OF THE 0.2% ANNUAL CHANCE FLOODPLAIN PER FLOOD INSURANCE RATE MAP NUMBER 26125C0552F, DATED SEPTEMBER 29, 2006.

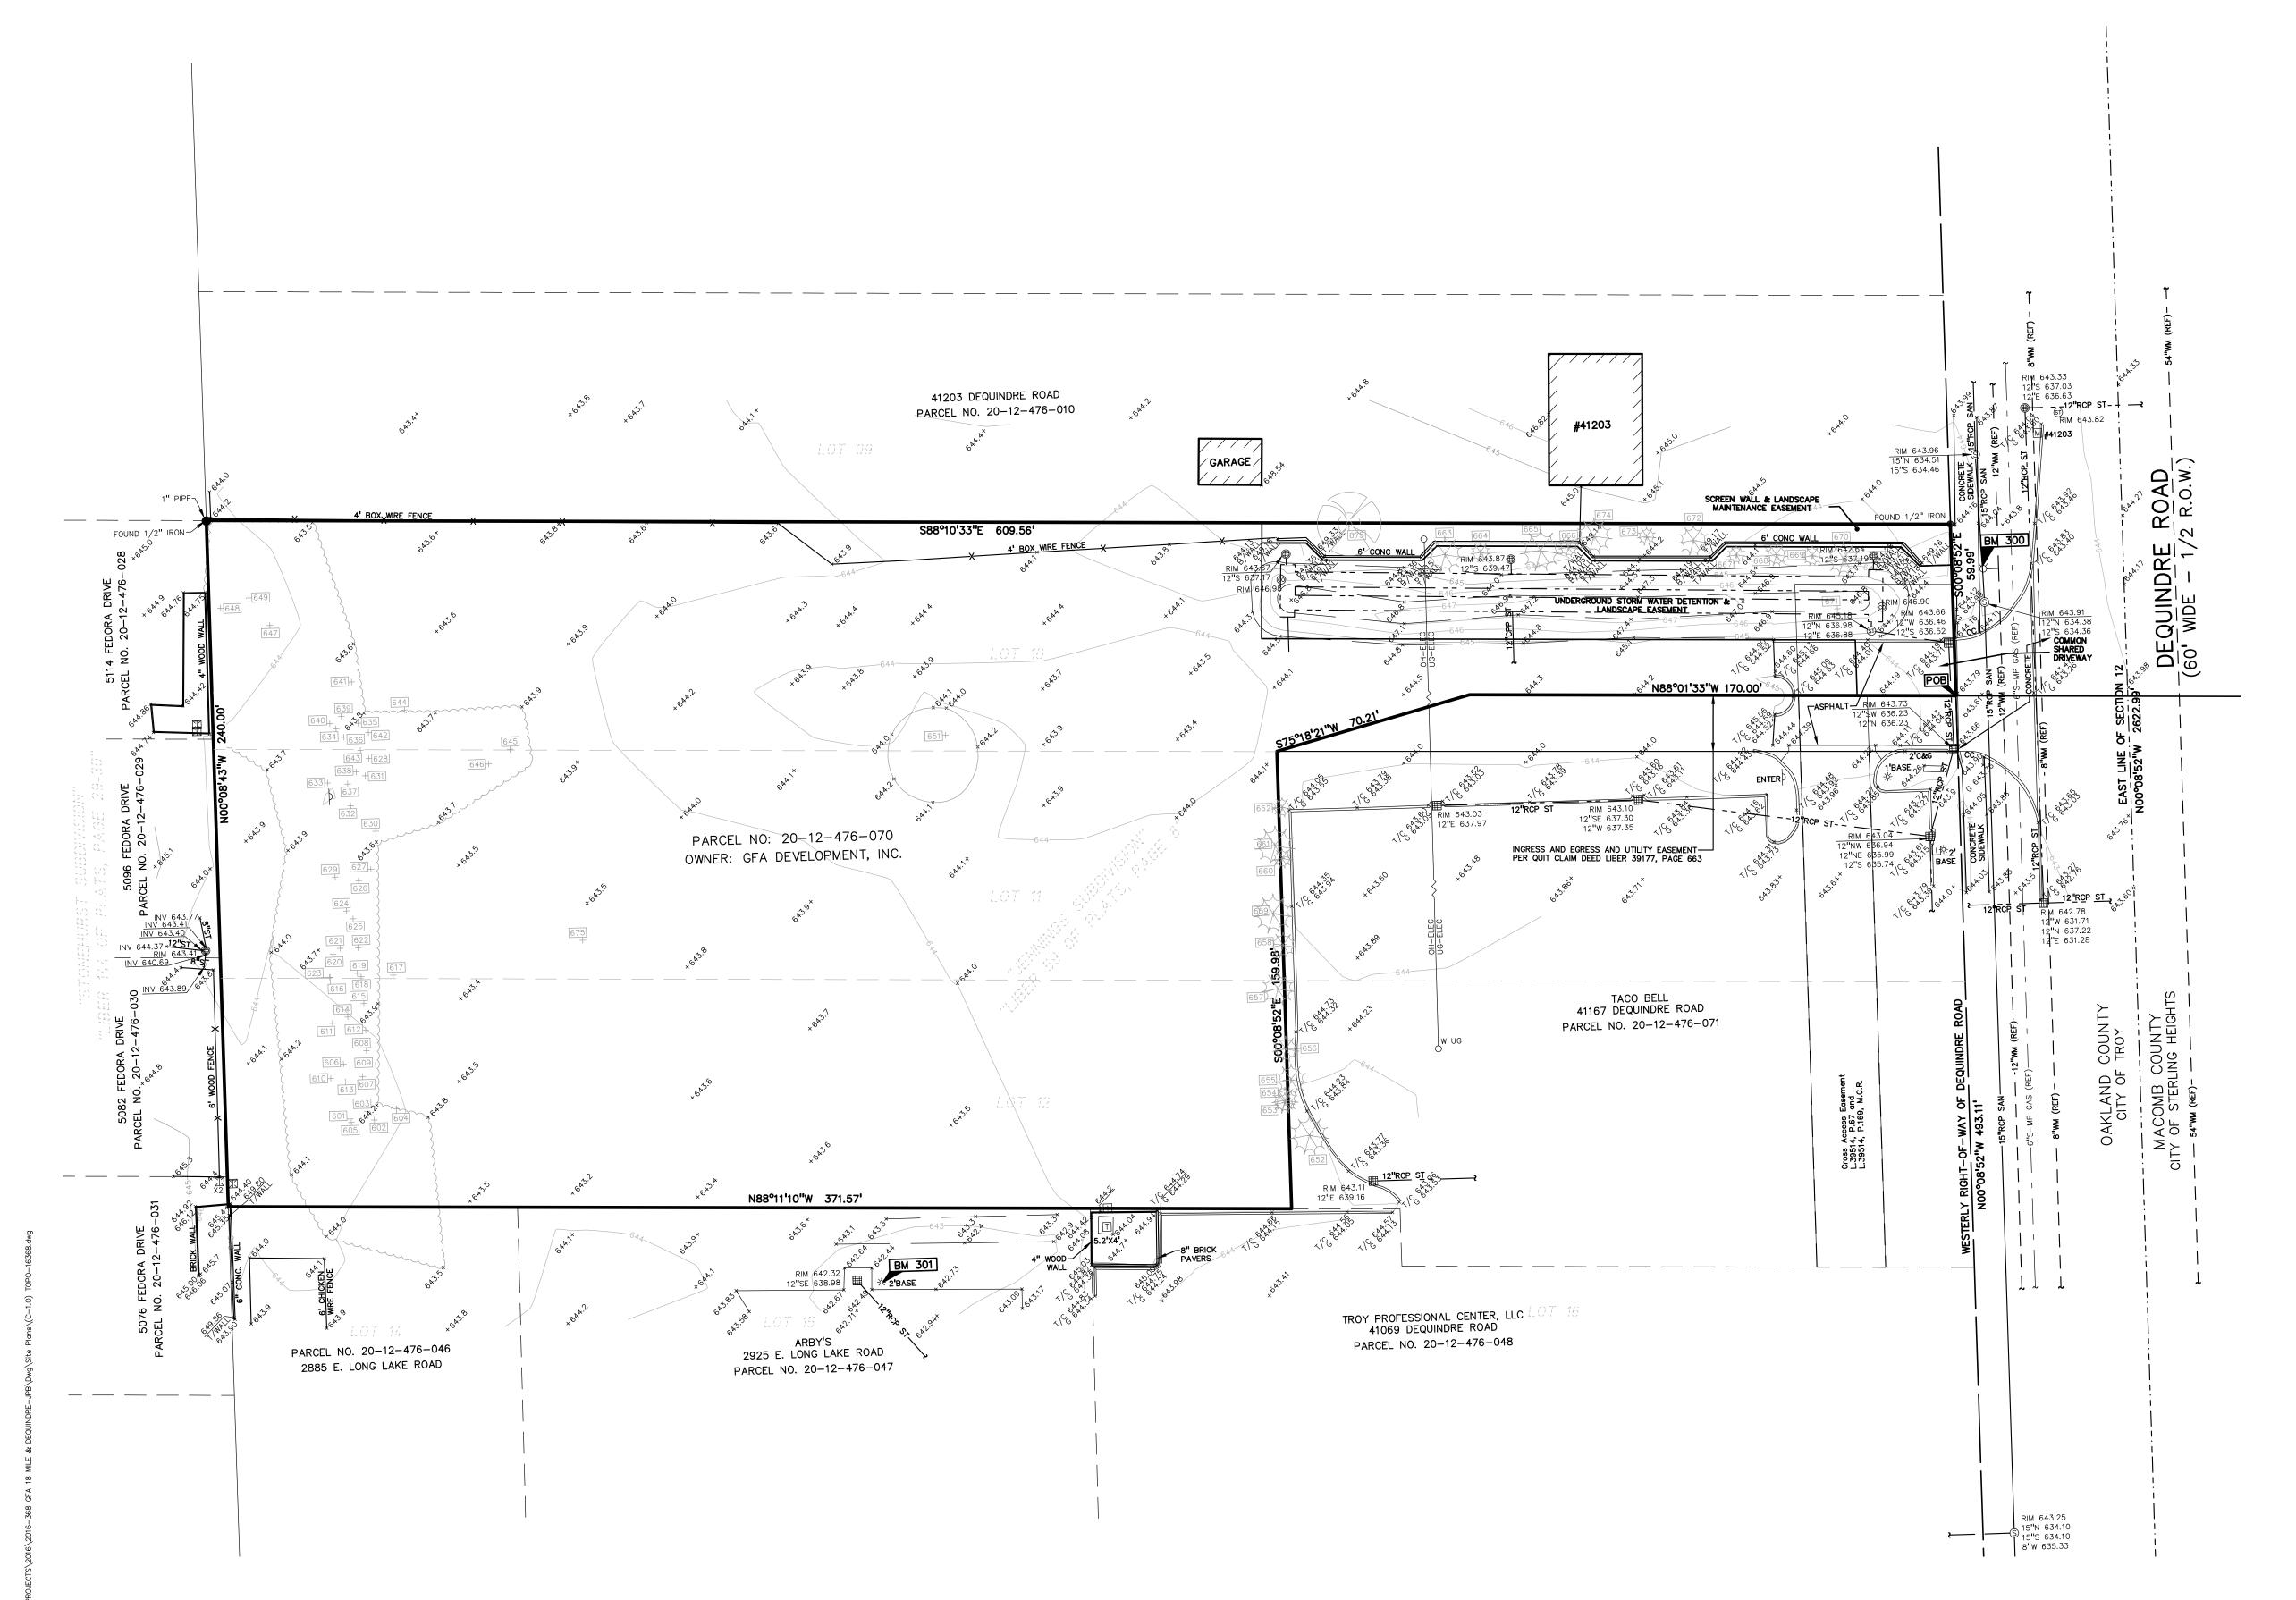

LEGEND

IRON FOUND MAIL FOUND Ø NAIL & CAP SET

 BRASS PLUG SET MONUMENT FOUND MONUMENT SET

SEC. CORNER FOUND R RECORDED M MEASURED C CALCULATED

-OH-ELEC-W-O- ELEC., PHONE OR CABLE TV O.H. LINE, POLE & GUY WIRE -UG-CATV-TV- UNDERGROUND CABLE TV, CATV PEDESTAL -⊠-UG-PHONE-①--- TELEPHONE U.G. CABLE, PEDESTAL & MANHOLE -UG-ELEC-E-E- ELECTRIC U.G. CABLE, MANHOLE, METER & HANDHOLE — _ GAS MAIN, VALVE & GAS LINE MARKER WATERMAIN, HYD., GATE VALVE, TAPPING SLEEVE & VALVE

SANITARY SEWER, CLEANOUT & MANHOLE — - - STORM SEWER, CLEANOUT & MANHOLE SQUARE, ROUND & BEEHIVE CATCH BASIN, YARD DRAIN POST INDICATOR VALVE WATER VALVE BOX/HYDRANT VALVE BOX, SERVICE SHUTOFF M T I MAILBOX, TRANSFORMER, IRRIGATION CONTROL VALVE UNIDENTIFIED STRUCTURE SPOT ELEVATION

CONTOUR LINE -X-X-X- FENCE ☆ STREET LIGHT SIGN CONC. →

∕— ASPH. →

GRAVEL SHOULDER __GRAVEL_


REFERENCE DRAWINGS


GAS - CONSUMERS ENERGY QUARTER SECTION MAP 02-61-12-4, DATED 10-21-05 CITY OF TROY UTILITY GIS MAP
TACO BELL GRADING AND UTILITY PLAN, DESIGN, INC. PROJECT NO. 61055, DWG. NAME 055UT, DATED 11-07-07
TACO BELL SITE PLAN, DESIGN, INC. PROJECT NO. 61055, DWG. NAME 055SP, DATED 06-27-07

t: 844.813.2949

www.peagroup.com



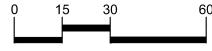

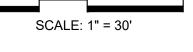



CAUTION!! THE LOCATIONS AND ELEVATIONS OF EXISTING UNDERGROUND UTILITIES AS SHOWN ON THIS DRAWING ARE ONLY APPROXIMATE. NO GUARANTEE IS EITHER EXPRESSED OR IMPLIED AS TO THE COMPLETENESS OR ACCURACY THEREOF. THE CONTRACTOR SHALL BE EXCLUSIVELY RESPONSIBLE FOR DETERMINING THE EXACT UTILITY LOCATIONS AND ELEVATIONS PRIOR TO THE START OF CONSTRUCTION.

CLIENT GFA
DEVELOPMENT,
INC.
986 ELMSFORD DR.
TROY, MI 48083

PROJECT TITLE


GFA 18 MILE & DEQUINDRE
PART OF THE SE 1/4 OF SECTION 12, T.02N., R.11E. TROY, OAKLAND COUNTY, MI


REVISIONS	
ONDITIONAL REZONE APP.	6/8/21

ORIGINAL ISSUE DATE: **SEPTEMBER 18, 2019**

TOPOGRAPHIC SURVEY

PEA JOB NO.	2016-368
P.M.	JBT
DN.	TMK
DES.	TMK
DRAWING NUMBER:	

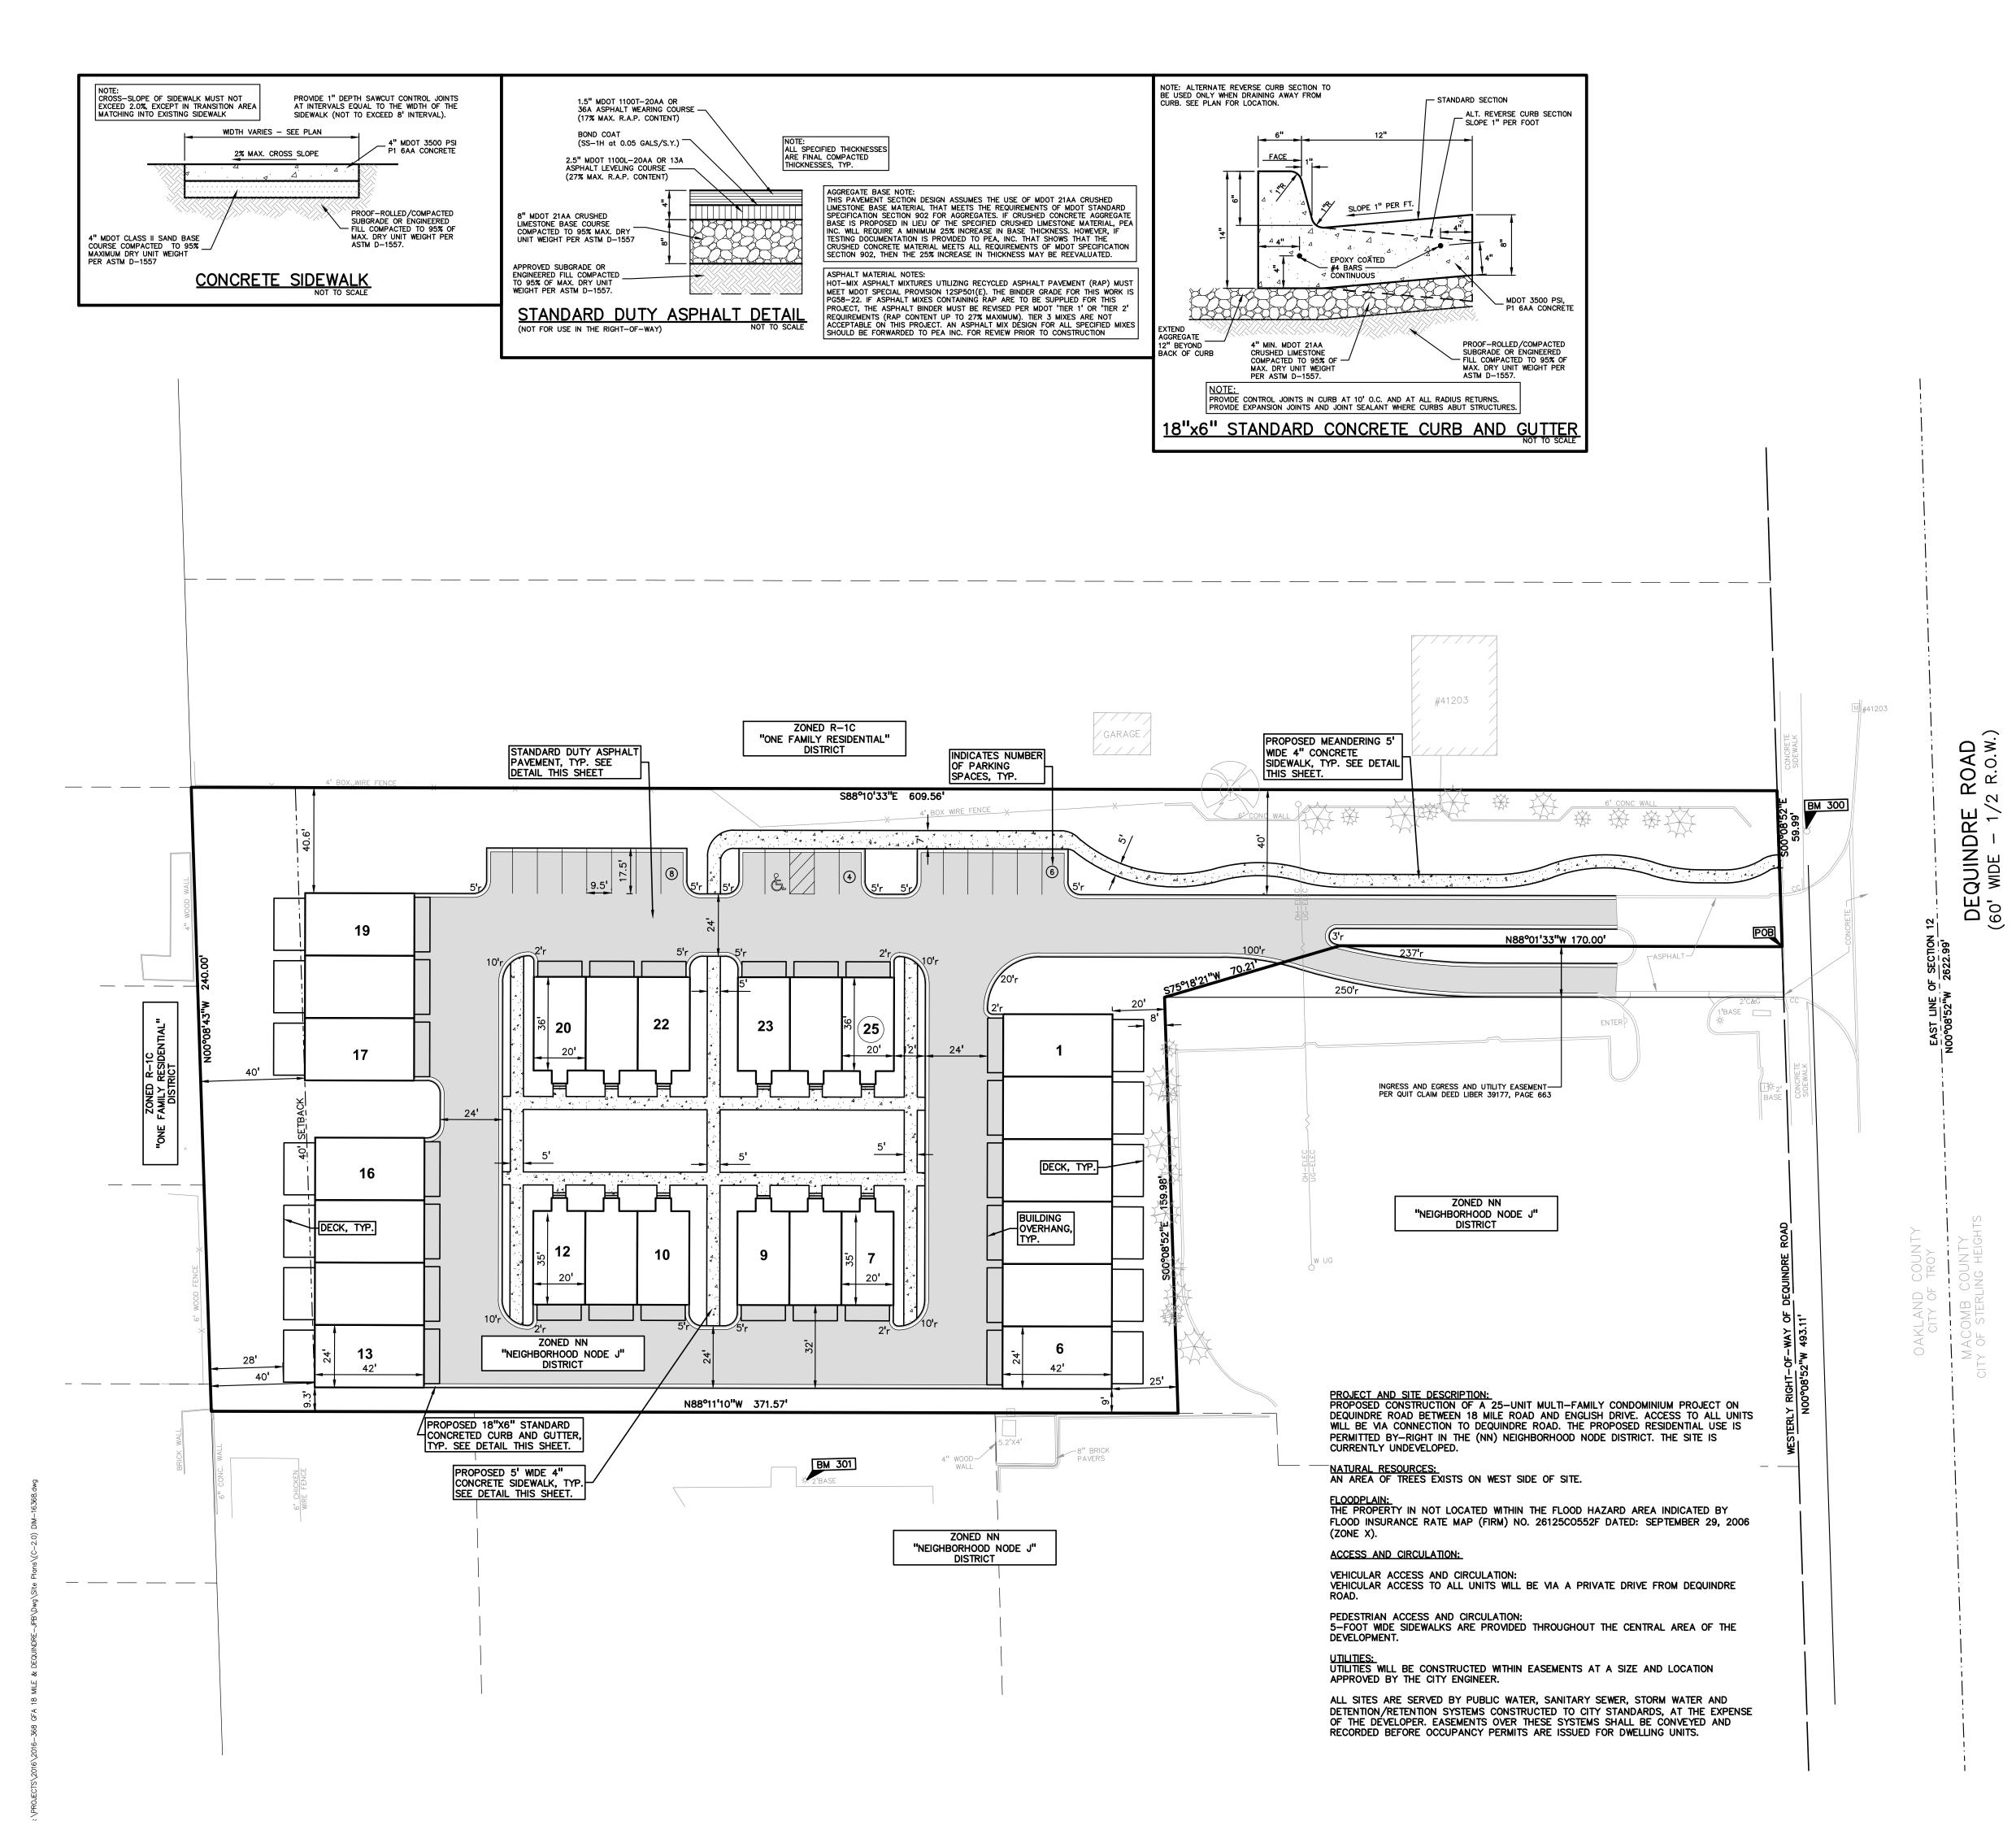

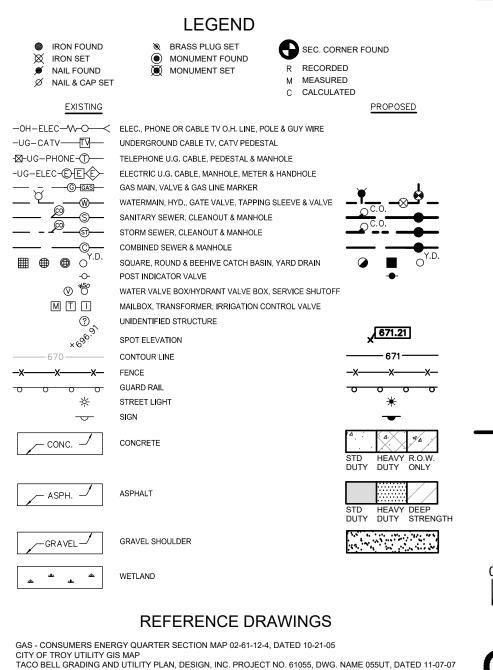

TACO BELL SITE PLAN, DESIGN, INC. PROJECT NO. 61055, DWG. NAME 055SP, DATED 06-27-07

CAUTION!!

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SCALE: 1" = 30'

t: 844.813.2949

www.peagroup.com

ALL WORK IN THE DEQUINDRE ROAD RIGHT-OF-WAY IS UNDER THE JURISDICTION OF THE ROAD COMMISSION FOR OAKLAND COUNTY AND REQUIRES A PERMIT. DEVELOPMENT, SITE DATA TABLE:

40' PROVIDED

SITE AREA: 2.389 ACRES (104,056.4021 SQ.FT.) NET AND GROSS

REAR SETBACK (WEST): 40 FEET REQUIRED

EX. ZONING: (NN) NODE J AND EP

PR. ZONING: (NN), NODE J; SITE TYPE NN:B, STREET TYPE:A

PROPOSED USE: TOWNHOMES

BUILDING INFORMATION:

MAXIMUM ALLOWABLE BUILDING HEIGHT = 72 FEET (6 STORIES)

PROPOSED BUILDING HEIGHT = 3 STORY

SETBACK REQUIREMENTS:

NN: B ZONING DISTRICT:
FRONT SETBACK (EAST): 0 FEET REQUIRED 20' PROVIDED SIDE SETBACK (NORTH): 0 FEET REQUIRED 40' PROVIDED SIDE SETBACK (SOUTH): 0 FEET REQUIRED 9' PROVIDED

PARKING CALCULATIONS:
MULTIFAMILY = 2 SPACES PER UNIT REQUIRED
TOTAL REQUIRED PARKING = 2 X 25 GARAGE = 50 SPACES
TOTAL GUEST PARKING = 18 SPACES

TOTAL PROVIDED PARKING = 68 SPACES (INCLUDES 2-CAR GARAGES)

OPEN SPACE:
MINIMUM OPEN SPACE REQUIRED = 15% + 15% LANDSCAPE
PROVIDED OPEN SPACE = 15%
PROVIDED LANDSCAPE > 15%

SITE SOILS INFORMATION:
ACCORDING TO THE USDA NATURAL RESOURCES CONSERVATION SERVICE WEB SOIL SURVEY FOR OAKLAND COUNTY, THE SITE CONSISTS OF THE FOLLOWING SOIL TYPES: 52A - SELFRIDGE LOAMY SAND, 0 TO 3 PERCENT SLOPES

GFA 18 MILE & DEQUINDRE PART OF THE SE 1/4 OF SECTION 12, ROY, OAKLAND COUNTY, MI

986 ELMSFORD DR. TROY, MI 48083


PROJECT TITLE


REVISIONS CONDITIONAL REZONE APP.

ORIGINAL ISSUE DATE: **SEPTEMBER 18, 2019** DRAWING TITLE

PRELIMINARY SITE PLAN

2016-368 PEA JOB NO. TMK DES. TMK DRAWING NUMBER:

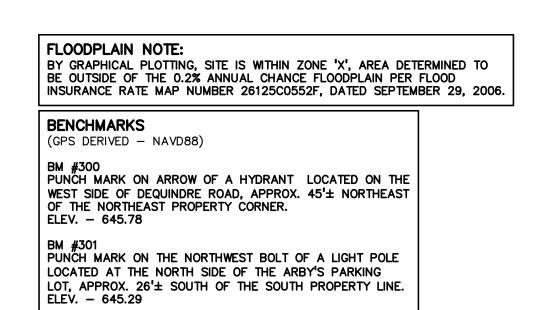

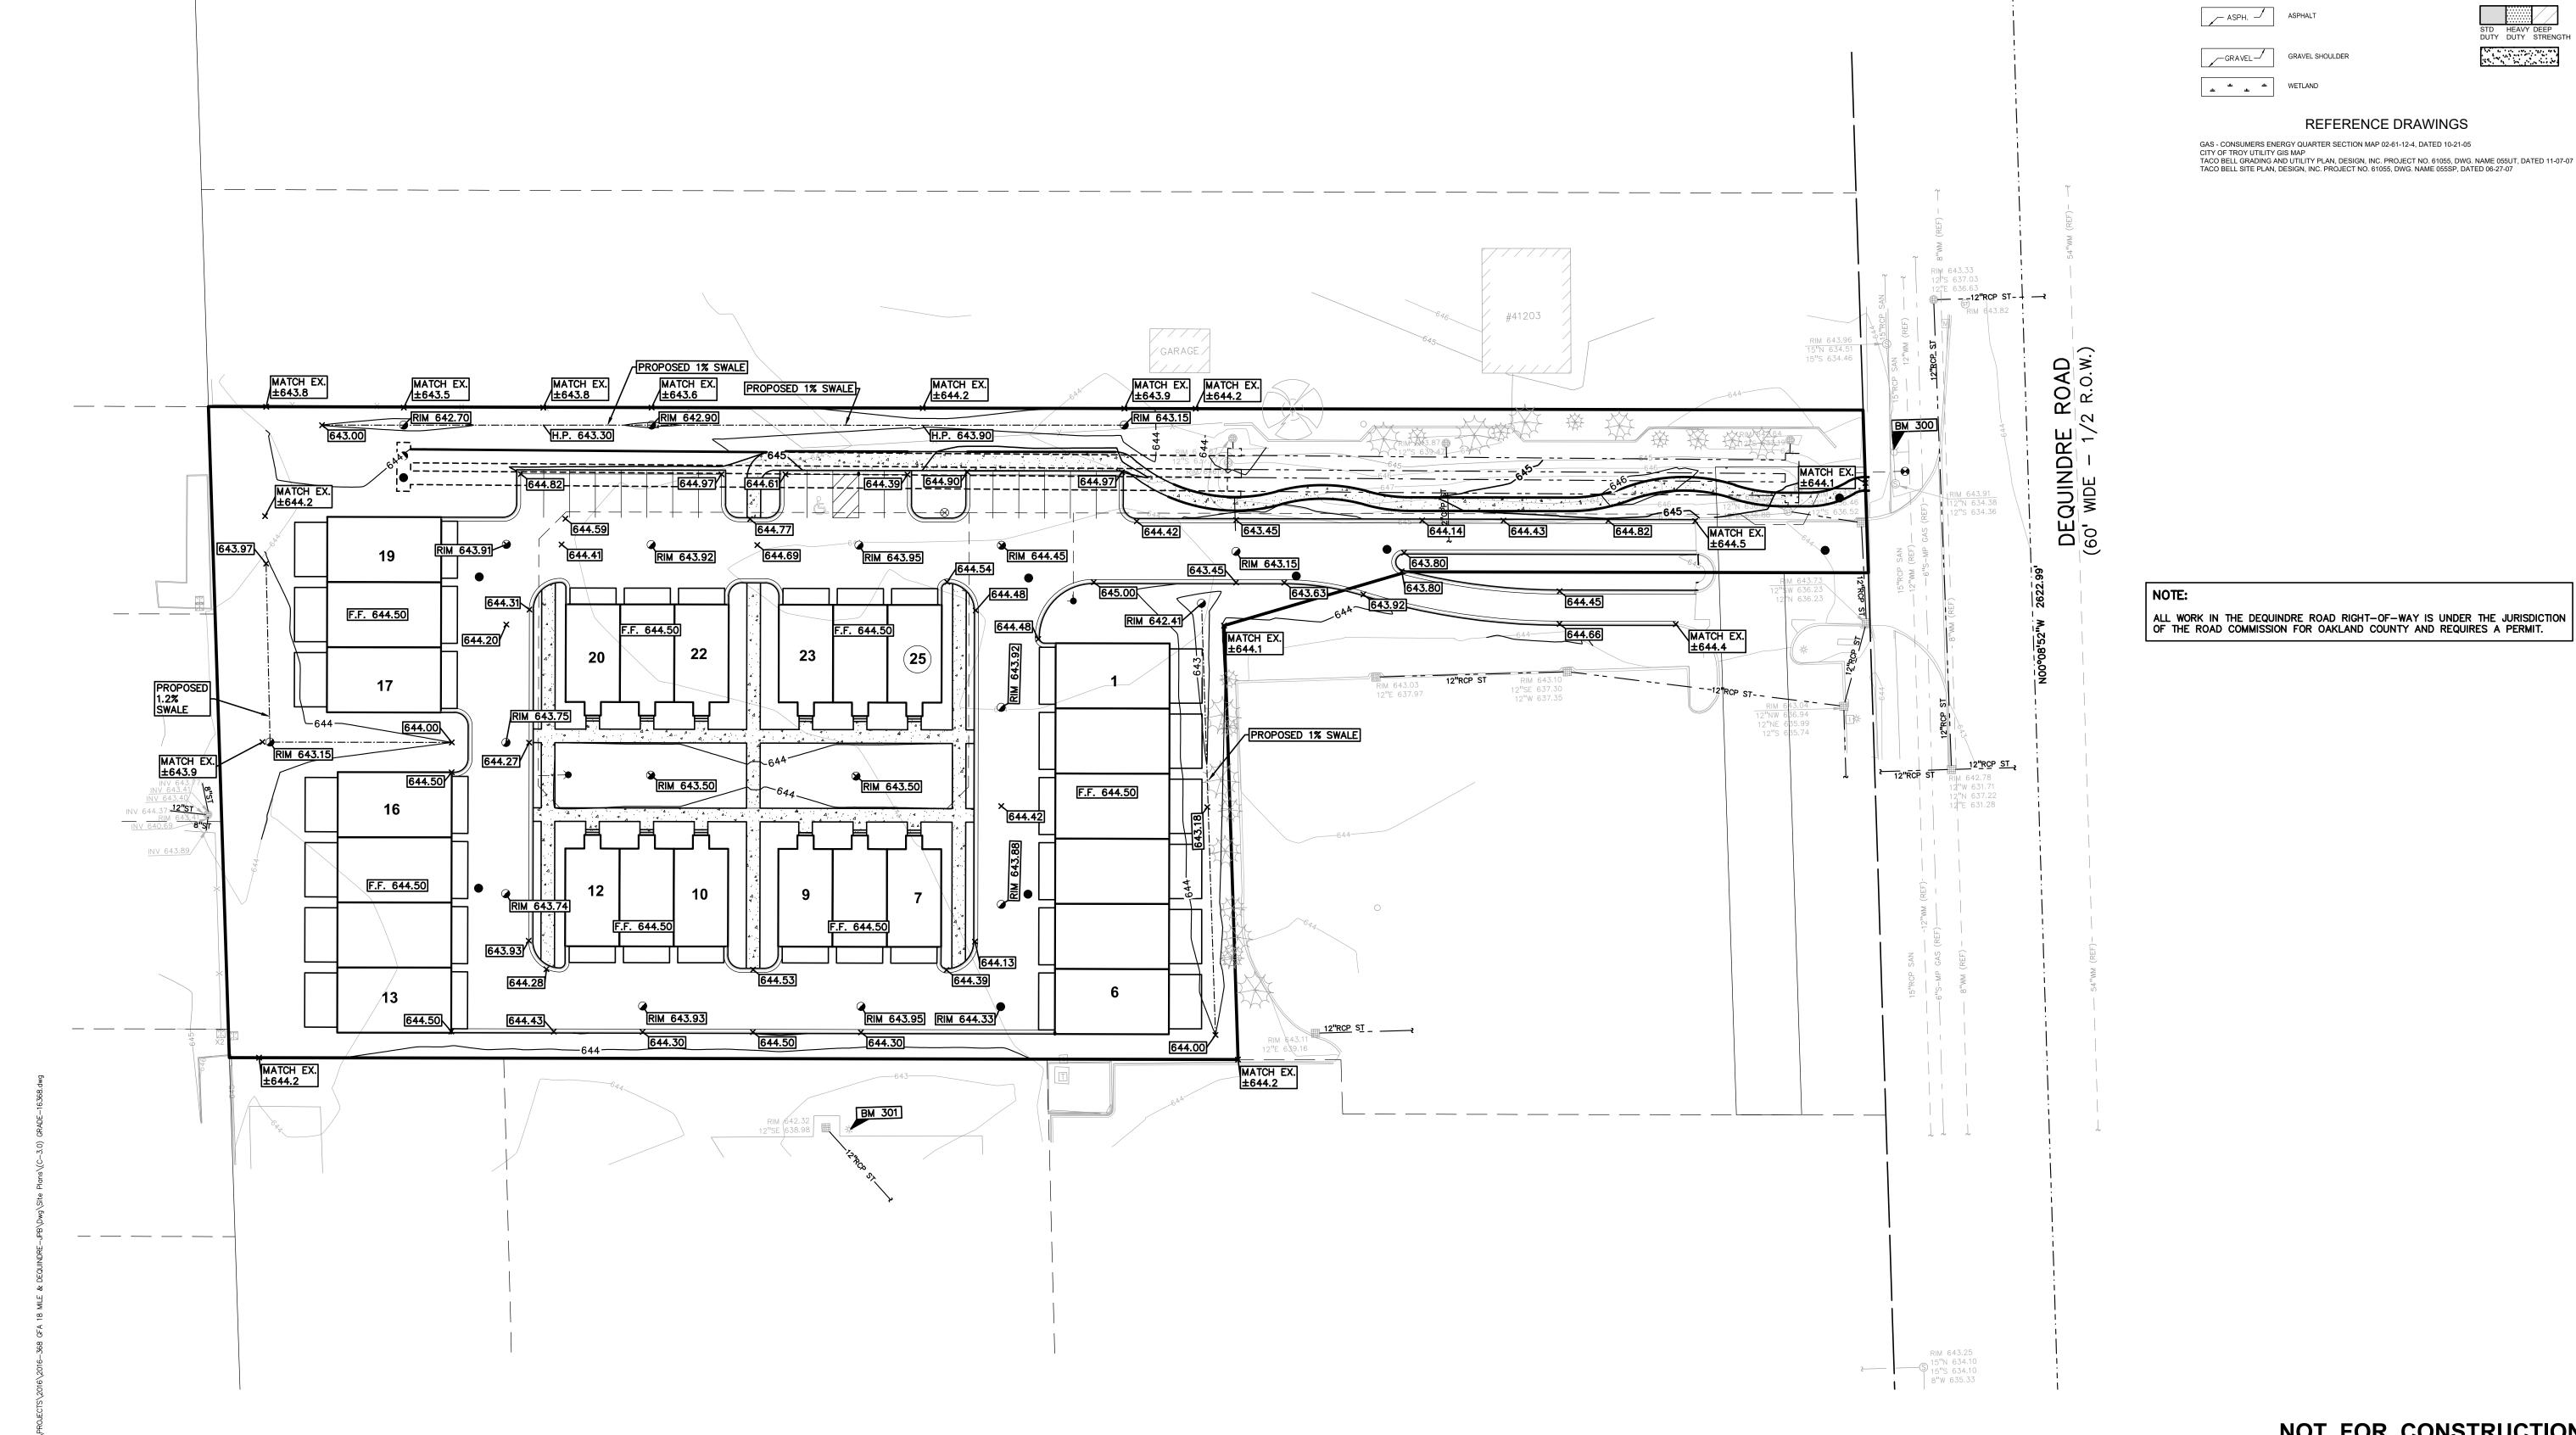

LEGEND

-OH-ELEC-W-O- ELEC., PHONE OR CABLE TV O.H. LINE, POLE & GUY WIRE

IRON FOUND RASS PLUG SET MONUMENT FOUND MAIL FOUND MONUMENT SET Ø NAIL & CAP SET

-UG-CATV-TV- UNDERGROUND CABLE TV, CATV PEDESTAL

SEC. CORNER FOUND R RECORDED M MEASURED C CALCULATED

671.21

671

-x----x---x-

_

GROUP www.peagroup.com

-UG-ELEC-E-E- ELECTRIC U.G. CABLE, MANHOLE, METER & HANDHOLE — _ GAS MAIN, VALVE & GAS LINE MARKER WATERMAIN, HYD., GATE VALVE, TAPPING SLEEVE & VALVE SANITARY SEWER, CLEANOUT & MANHOLE — — STORM SEWER, CLEANOUT & MANHOLE SQUARE, ROUND & BEEHIVE CATCH BASIN, YARD DRAIN POST INDICATOR VALVE WATER VALVE BOX/HYDRANT VALVE BOX, SERVICE SHUTOFF M T I MAILBOX, TRANSFORMER, IRRIGATION CONTROL VALVE UNIDENTIFIED STRUCTURE SPOT ELEVATION -----670 ------ CONTOUR LINE -X-X-X- FENCE

0 0 0 0 ☆ STREET LIGHT ── SIGN CONC. → ∕— ASPH. →

GRAVEL SHOULDER __GRAVEL_

REFERENCE DRAWINGS

GAS - CONSUMERS ENERGY QUARTER SECTION MAP 02-61-12-4, DATED 10-21-05 CITY OF TROY UTILITY GIS MAP
TACO BELL GRADING AND UTILITY PLAN, DESIGN, INC. PROJECT NO. 61055, DWG. NAME 055UT, DATED 11-07-07
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SCALE: 1" = 30'

t: 844.813.2949



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GFA
DEVELOPMENT,
INC. 986 ELMSFORD DR. TROY, MI 48083

CLIENT

PROJECT TITLE

GFA 18 MILE & DEQUINDRE
PART OF THE SE 1/4 OF SECTION 12, T.02N., R.11E.
TROY, OAKLAND COUNTY, MI

REVISIONS CONDITIONAL REZONE APP.

ORIGINAL ISSUE DATE: SEPTEMBER 18, 2019

DRAWING TITLE **PRELIMINARY GRADING PLAN**

2016-368 PEA JOB NO. TMK DES. DRAWING NUMBER:

C-3.0

GFA 18 MILE & DEQUINDRE Project: TROY, MI

Location: 9/16/2019 Date: 2016-368 Project No:

25 YEAR STORM DETENTION DESIGN (OAKLAND COUNTY DESIGN METHOD)

Contributing Area (A): C.F.S. (= 0.2 CFS/AC.) 0.48 Allowable Discharge (Qa) Coefficient of Runoff (Cr): 0.56

Calculation of Required Discharge/Acre

0.36 Qo = ((Qa)/(A)(Cr): 125.25 T = -25 + ((8062.5/Qo))0.5:

Storage Volume Required:

Vs = (12900(T)/(T+25)) - 40Qo(T): 8964.29

11997.8 Vt = (Vs)(A)(Cr):

PIPE STORAGE: 612 ft. SIZE= 60 in. C.F./FT.= 19.625 c.f./ft. VOLUME= 12,010.50 c.f.


CALCULATIONS OF EXISTING U.G. DETENTION:

Contributing Area (A): 1.35 0.27 C.F.S. (=0.2 CFS/AC.) Allowable Discharge (Qa) 0.59 Coefficient of Runoff (Cr): Calculation of Required Discharge/Acre Qo = ((Qa)/(A)(Cr):0.34 129 T = -25 + ((8062.5/Qo))0.5: Storage Volume Required: Vs = (12900(T)/(T+25)) - 40Qo(T): 9057 Vt = (Vs)(A)(Cr):

> PROVIDED STORAGE IN UNDERGROUND DETENTION DETENTION SYSTEM PROVIDED: 60" SLCPP PIPE STORAGE PER LINEAR FOOT OF PIPE: 19.63 C.F NUMBER OF ROWS PROVIDED: 2 LENGTH OF ROWS PROVIDED: 200 L.F.

NOTE:

ALL WORK IN THE DEQUINDRE ROAD RIGHT-OF-WAY IS UNDER THE JURISDICTION OF THE ROAD COMMISSION FOR OAKLAND COUNTY AND REQUIRES A PERMIT.

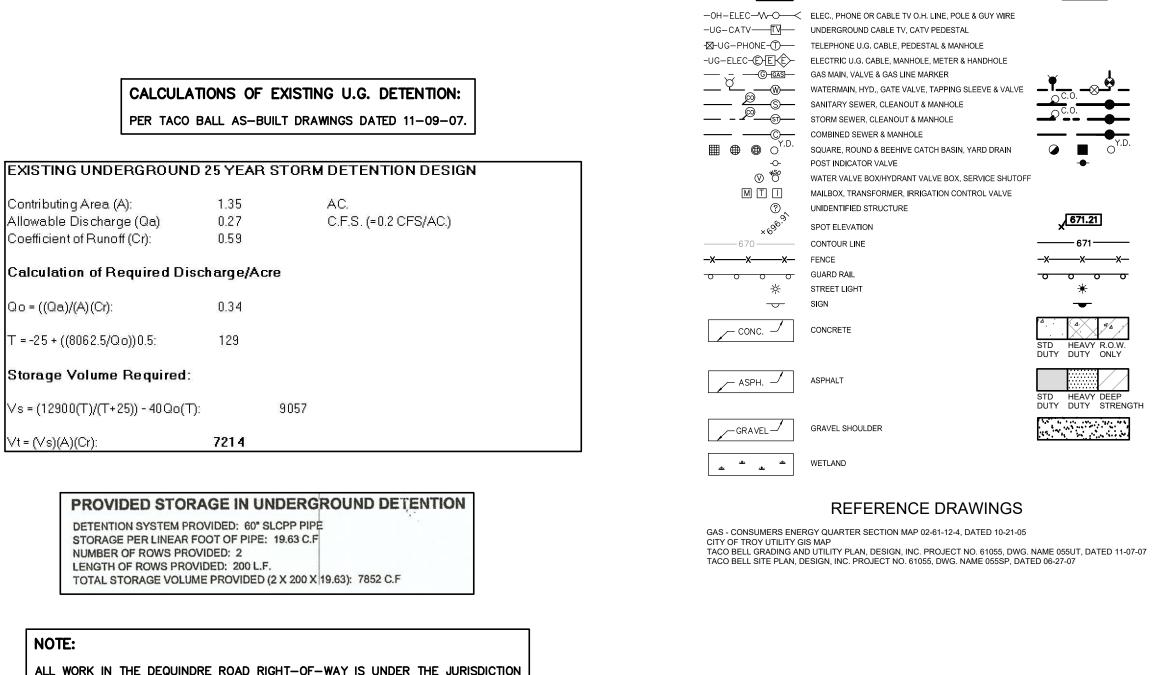



LEGEND

REFERENCE DRAWINGS

SEC. CORNER FOUND

_

R RECORDED

M MEASURED

C CALCULATED

RASS PLUG SET

MONUMENT SET

MONUMENT FOUND

IRON FOUND

MAIL FOUND

Ø NAIL & CAP SET







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CLIENT GFA DEVELOPMENT, INC. 986 ELMSFORD DR. TROY, MI 48083

PROJECT TITLE

GFA 18 MILE & DEQUINDRE
PART OF THE SE 1/4 OF SECTION 12, T.02N., R.11E.
TROY, OAKLAND COUNTY, MI


REVISIONS CONDITIONAL REZONE APP.

ORIGINAL ISSUE DATE: SEPTEMBER 18, 2019

PRELIMINARY UTILITY PLAN

2016-368 PEA JOB NO. TMK DES. DRAWING NUMBER:

NOT FOR CONSTRUCTION

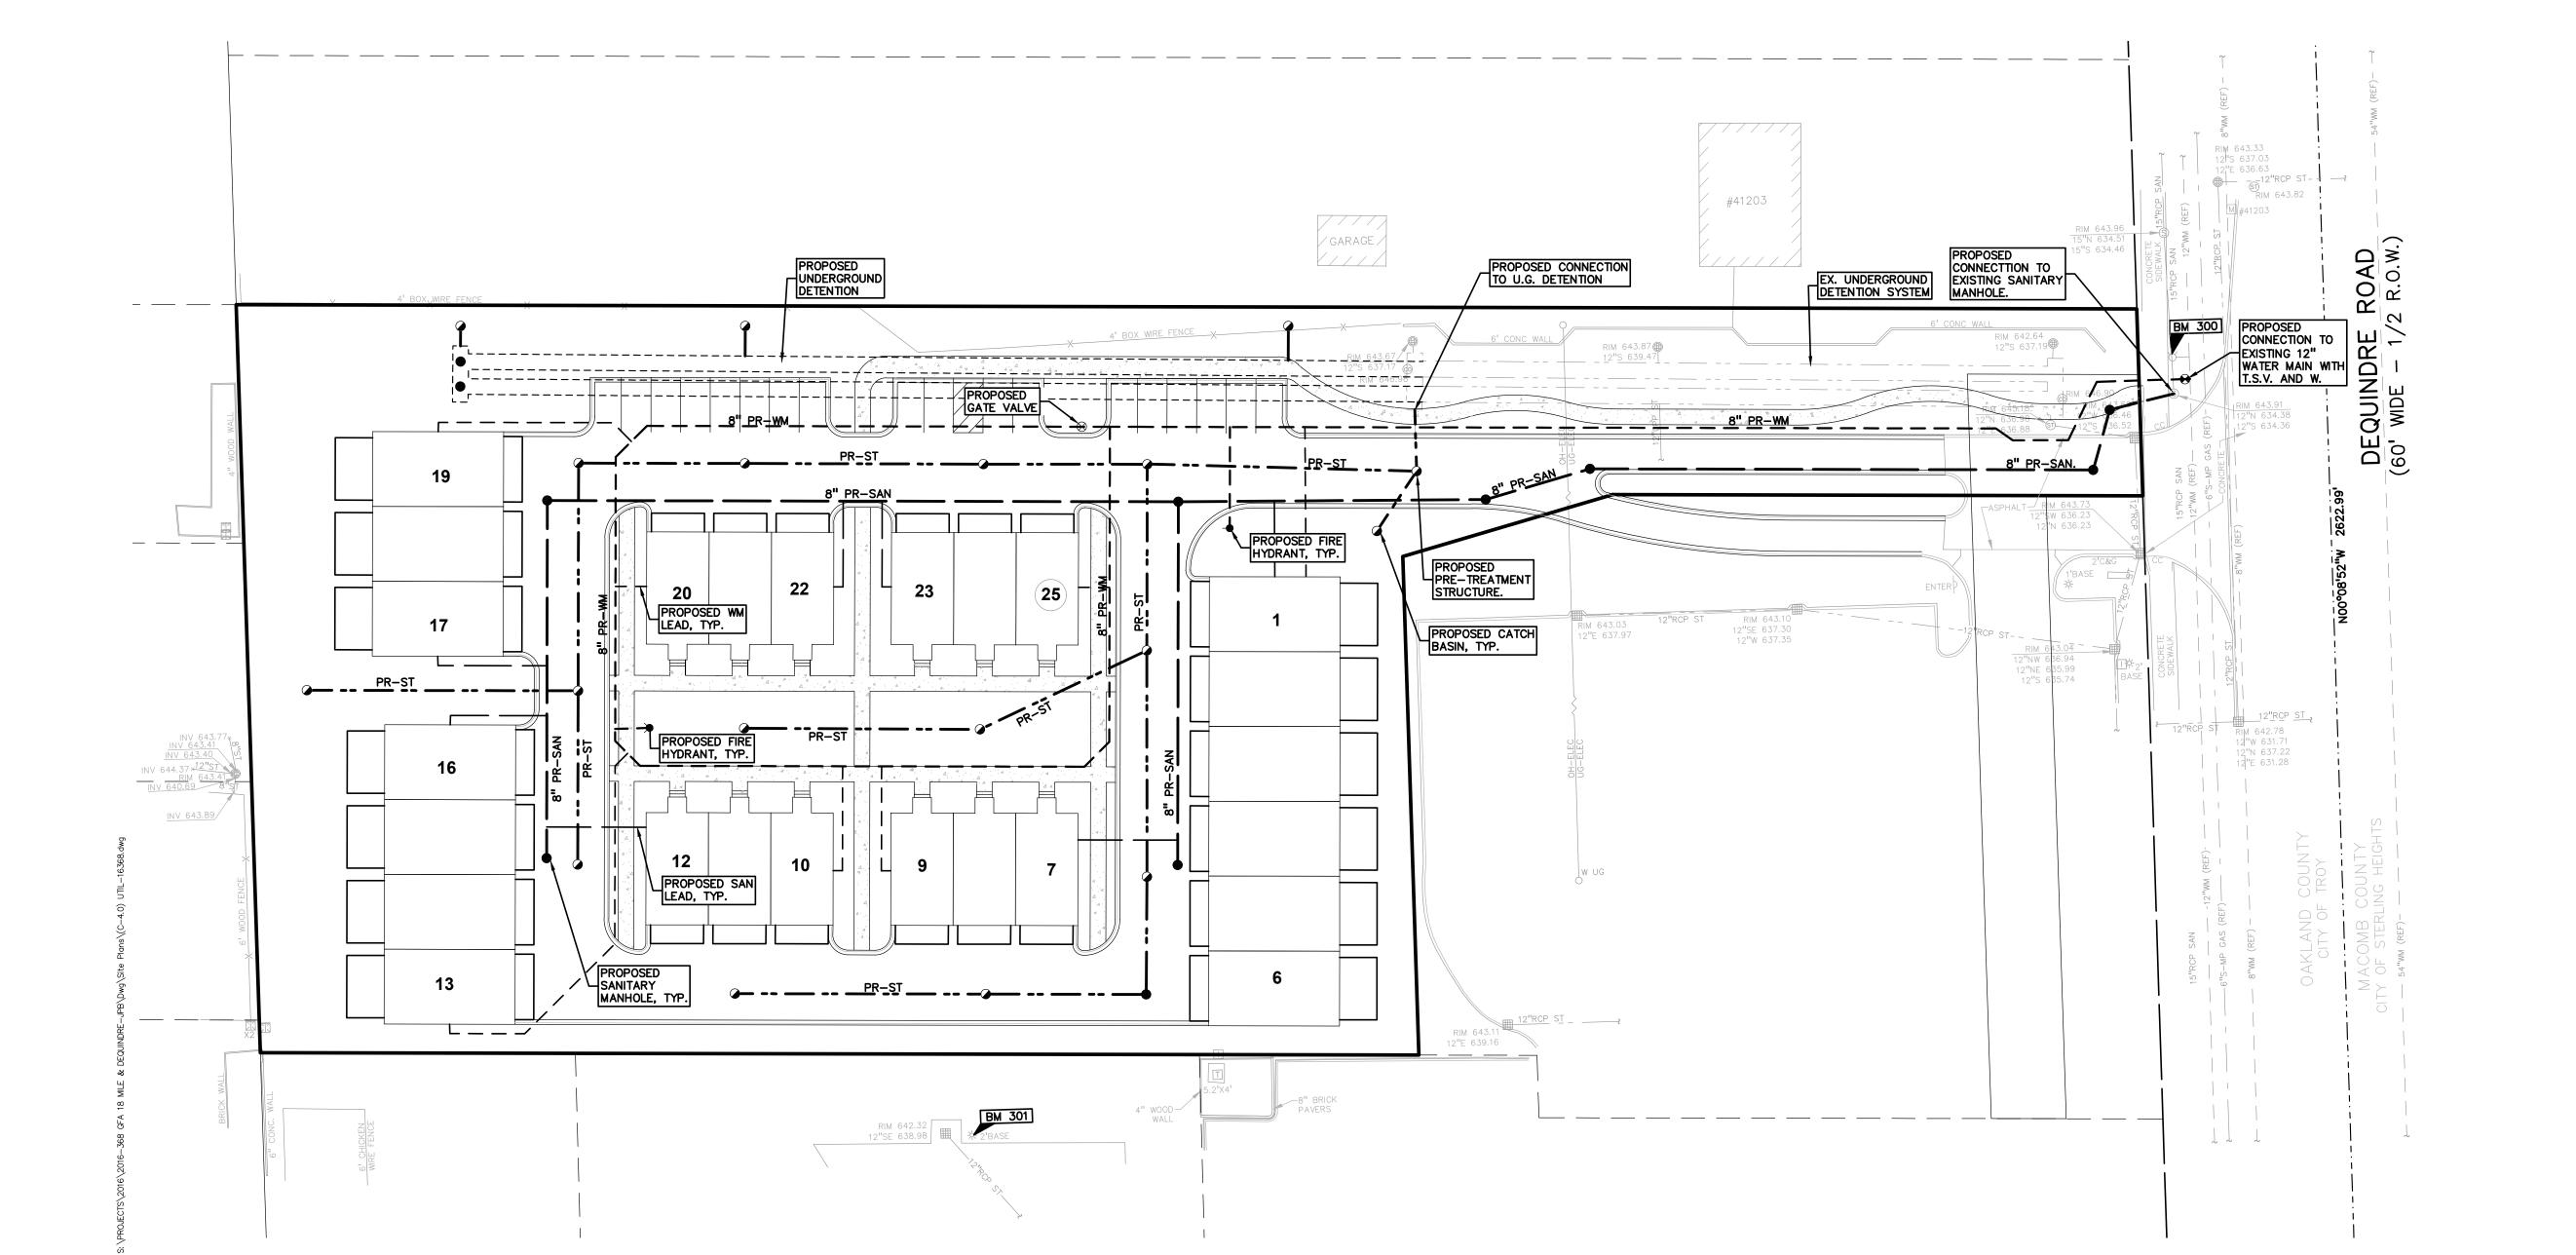


DECIDUO	US TREE PL	ANT LIST:			
		COMMON NAME	SCIENTIFIC NAME	SIZE	SPEC
3	AS2.5	Sugar Maple	Acer saccharum 'Green Mountain'	2.5" Cal.	B&B
2	QR2.5	Red Oak	Quercus rubra	2.5" Cal.	B&B
5	TOTAL DEC.				
EVERGRE	EN TREE PL	ANT LIST:			
QUANTITY	KEY SYMBOL	COMMON NAME	SCIENTIFIC NAME	SIZE	SPEC
7	AC8	Concolor Fir	Abies concolor	8' Ht.	B&B
7	PA8	Norway Spruce	Picea abies	8' Ht.	B&B
8	PC8	Columnar Norway Spruce	Picea abies 'Cupressina'	8' Ht.	B&B
14	PG8	Black Hills Spruce	Picea glauca 'Densata'	8' Ht.	B&B
5	PO8	Serbian Spruce	Picea omorika	8' Ht.	B&B
6	PB8	Lacebark Pine	Pinus bungeana	8' Ht.	B&B
11	PN8	Austrian Pine	Pinus nigra	8' Ht.	B&B
7	PS8	Eastern White pine	Pinus strobus	8' Ht.	B&B

65 TOTAL EVG.



GROUP

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4'HIGH PROTECTIVE FENCING WITH STEEL POSTS - 10' O.C. - EXISTING SOIL

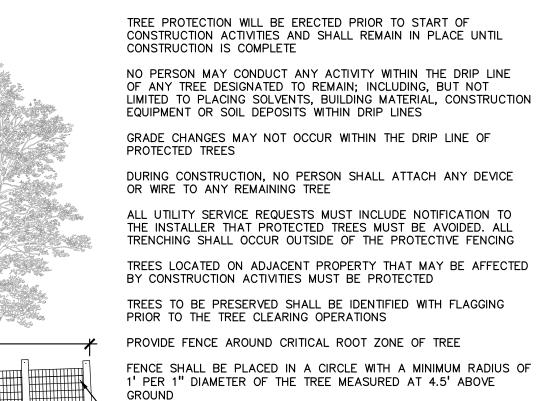STAKING/GUYING LOCATION TAMPED SOIL

PLANT SO THAT TOP OF ROOT BALL IS FLUSH TO GRADE OR 1-2" HIGHER IF IN POORLY DRAINED SOILS STAKE JUST BELOW BRANCHES WITH 2"-3" WIDE NYLON OR PLASTIC STRAPS. CONNECT -FROM TREE TO STAKE AND ALLOW FOR FLEXIBILITY. REMOVE AFTER (1) ONE YEAR. (DO NOT USE WIRE & HOSE) THREE 2"X2" HARDWOOD STAKES OR STEEL T-POSTS DRIVEN A MIN. OF 18" DEEP FIRMLY INTO SUBGRADE PRIOR TO BACKFILLING SHREDDED HARDWOOD BARK MULCH TO DRIPLINE. 3" DEEP AND LEAVE 3" CIRCLE OF BARE SOIL AROUND TREE TRUNK, DO NOT PLACE MULCH IN CONTACT WITH TREE TRUNK. FORM SAUCER WITH 4" HIGH CONTINUOUS RIM -FINISH GRADE SPECIFIED PLANTING MIX, WATER & TAMP TO - REMOVE AIR POCKETS, AMEND SOIL PER SITE CONDITIONS & TREE REQUIREMENTS EXPOSE ROOT FLARE OF TREE. CONTRACTOR MAY HAVE TO REMOVE EXCESS SOIL FROM - TOP OF ROOTBALL. REMOVE ALL BURLAP FROM TOP 1 OF ROOTBALL. DISCARD ALL NON-BIODEGRADABLE MATERIAL OFF SITE PLACE ROOTBALL ON UNEXCAVATED OR

STAKING/GUYING CONTINUOUS RIM -FINISH GRADE DECIDUOUS TREE PLANTING DETAIL

PLANT SO THAT TOP OF ROOT BALL IS FLUSH TO GRADE OR 1-2" HIGHER IF IN POORLY DRAINED SOILS SECURE TREE WRAP WITH BIODEGRADABLE MATERIAL AT TOP & BOTTOM, REMOVE AFTER FIRST WINTER DO NOT PRUNE TERMINAL LEADER PRUNE ONLY DEAD, BROKEN BRANCHES AS DIRECTED BY LANDSCAPE ARCHITECT STAKE JUST BELOW BRANCHES WITH 2"-3" WIDE NYLON OR PLASTIC STRAPS. CONNECT FROM TREE TO STAKE AND ALLOW FOR FLEXIBILITY. REMOVE AFTER (1) ONE YEAR. (DO NOT USE WIRE & HOSE) (3) THREE 2"X2" HARDWOOD STAKES DRIVEN A MIN. OF 18" DEEP FIRMLY INTO SUBGRADE PRIOR TO BACKFILLING SHREDDED HARDWOOD BARK MULCH TO DRIPLINE. 3" DEEP AND LEAVE 3" CIRCLE OF BARE SOIL AROUND TREE TRUNK. DO NOT PLACE MULCH IN CONTACT WITH TREE TRUNK. FORM SAUCER WITH 4" HIGH SPECIFIED PLANTING MIX. WATER & TAMP TO - REMOVE AIR POCKETS, AMEND SOIL PER SITE CONDITIONS & TREE REQUIREMENTS EXPOSE ROOT FLARE OF TREE. CONTRACTOR MAY HAVE TO REMOVE EXCESS SOIL FROM - TOP OF ROOTBALL. REMOVE ALL BURLAP FROM TOP 1 OF ROOTBALL. DISCARD ALL NON-BIODEĞRADABLE MATERIAL OFF SITE _ PLACE ROOTBALL ON UNEXCAVATED OR TAMPED SOIL

LANDSCAPE CALCULATIONS:
PER CITY OF TROY ZONING ORDINANCE; NN GREENBELT TREES REQUIRED: 1 DEC TREE / 30 LF OF STREET FRONTAGE. 60' OF RIGHT OF WAY/ 30 = 2 DEC TREES REQUIRED.

PROVIDED: 2 PROPOSED TREES REQUIRED: 1 TREE / 8 PARKING SPACES. 18 SPACES / 8 = 3 TREES

= EVERGREEN SCREENING TREES

= PARKING LOT TREES

= GREENBELT TREES

PROVIDED: 3 TREES

REPLACEMENT TREES
REQUIRED: REPLACE 50% OF REMOVED DBH OF WOODLAND TREES, AND 100% OF REMOVED LANDMARK TREES DBH. 1 WOODLAND AND 1 LANDMARK TREES REMOVED, SEE CALCULATIONS THIS SHEET. 384" DBH CREDIT SAVED, O REPLACEMENT TREES REQUIRED. PROVIDED: 27 EXISTING TREES SAVED, NO REPLACEMENT REQUIRED.

SCREENING TREES REQUIRED: 1 LARGE EVG TREE / 10 LF (USE ALT 2: MULTIFAMILY ADJACENT TO SINGLE FAMILY RESIDENTIAL -NORTH & WEST).

- NORTH: 370 LF/10 = 37 LG EVG (6' FENCE ALONG REMAINING PROPERTY BOUNDARY.)- WEST: 240 LF /10 = 24 LG EVG


PROVIDED: 65 TREES (NORTH- 39 LG EVG; WEST- 26 LG EVG)

GENERAL PLANTING NOTES:

THE PLANT MATERIAL.

- . LANDSCAPE CONTRACTOR SHALL VISIT SITE, INSPECT EXISTING SITE CONDITIONS AND REVIEW PROPOSED PLANTING AND RELATED WORK. IN CASE OF DISCREPANCY BETWEEN PLAN AND PLANT LIST, PLAN SHALL GOVERN QUANTITIES. CONTACT LANDSCAPE ARCHITECT WITH ANY CONCERNS.
- 2. CONTRACTOR SHALL VERIFY LOCATIONS OF ALL ON SITE UTILITIES PRIOR TO BEGINNING CONSTRUCTION ON HIS/HER PHASE OF WORK. ELECTRIC, GAS, TELEPHONE, CABLE TELEVISION MAY BE LOCATED BY CALLING MISS DIG 1-800-482-7171. ANY DAMAGE OF INTERRUPTION OF SERVICES SHALL BE THE RESPONSIBILITY OF CONTRACTOR. CONTRACTOR SHALL COORDINATE ALL RELATED ACTIVITIES WITH OTHER TRADES ON THE JOB AND SHALL REPORT ANY UNACCEPTABLE JOB CONDITIONS TO OWNER'S REPRESENTATIVE PRIOR TO COMMENCING.
- . ALL PLANT MATERIAL TO BE PREMIUM GRADE NURSERY STOCK AND SHALL SATISFY AMERICAN ASSOCIATION OF NURSERYMEN STANDARD FOR NURSERY STOCK. ALL LANDSCAPE MATERIAL SHALL BE NORTHERN GROWN, NO. 1. GRADE.
- 4. CONTRACTOR IS RESPONSIBLE FOR VERIFYING ALL QUANTITIES SHOWN ON LANDSCAPE PLAN PRIOR TO PRICING THE WORK.
- 5. THE OWNER'S REPRESENTATIVE RESERVES THE RIGHT TO REJECT ANY PLANT MATERIAL NOT MEETING SPECIFICATIONS.
- 6. ALL SINGLE STEM SHADE TREES TO HAVE STRAIGHT TRUNKS AND SYMMETRICAL
- '. ALL SINGLE TRUNK SHADE TREES TO HAVE A CENTRAL LEADER; TREES WITH FORKED OR IRREGULAR TRUNKS WILL NOT BE ACCEPTED.
- 8. ALL MULTI STEM TREES SHALL BE HEAVILY BRANCHED AND HAVE SYMMETRICAL CROWNS. ONE SIDED TREES OR THOSE WITH THIN OR OPEN CROWNS SHALL NOT BE
- 9. ALL EVERGREEN TREES SHALL BE HEAVILY BRANCHED AND FULL TO THE GROUND, SYMMETRICAL IN SHAPE AND NOT SHEARED FOR THE LAST FIVE GROWING SEASONS.
- 10.ALL TREES TO HAVE CLAY OR CLAY LOAM BALLS, TREES WITH SAND BALLS WILL BE 11.NO MACHINERY IS TO BE USED WITHIN THE DRIP LINE OF EXISTING TREES; HAND
- GRADE ALL LAWN AREAS WITHIN THE DRIP LINE OF EXISTING TREES. 12.ALL TREE LOCATIONS SHALL BE STAKED BY LANDSCAPE CONTRACTOR AND ARE SUBJECT TO THE APPROVAL OF THE LANDSCAPE ARCHITECT PRIOR TO INSTALLATION OF
- 13.IT IS MANDATORY THAT POSITIVE DRAINAGE IS PROVIDED AWAY FROM ALL BUILDINGS. 14.ALL PLANTING BEDS SHALL RECEIVE 3" SHREDDED HARDWOOD BARK MULCH WITH PRE EMERGENT, SEE SPECIFICATIONS. SHREDDED PALETTE AND DYED MULCH WILL NOT BE ACCEPTED.
- 15.ALL LANDSCAPED AREAS SHALL RECEIVE 3" COMPACTED TOPSOIL.
- 16.SEE SPECIFICATIONS FOR ADDITIONAL COMMENTS, REQUIREMENTS, PLANTING PROCEDURES AND WARRANTY STANDARDS.
- 17.FOR NON-LAWN SEED MIX AREAS, AS NOTED ON PLAN, BRUSH MOW ONCE SEASONALLY FOR INVASIVE SPECIES CONTROL.




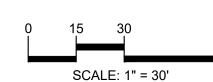

= IRRIGATED SEED LAWN

= EXISTING TREES



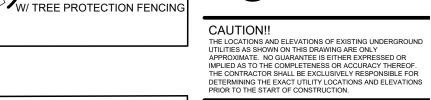

GFA DEVELOPMENT, 986 ELMSFORD DR.

PROJECT TITLE GFA 18 MILE & **DEQUINDRE**

TROY, OAKLAND COUNTY, MI

PART OF THE SE 1/4 OF SECTION 12,

REVISIONS CONDITIONAL REZONE APP.


ORIGINAL ISSUE DATE: **SEPTEMBER 18, 2019**

DRAWING TITLE **PRELIMINARY** LANDSCAPE **PLAN**

2016-368 PEA JOB NO. TMK DES. TMK

DRAWING NUMBER:

NOT FOR CONSTRUCTION

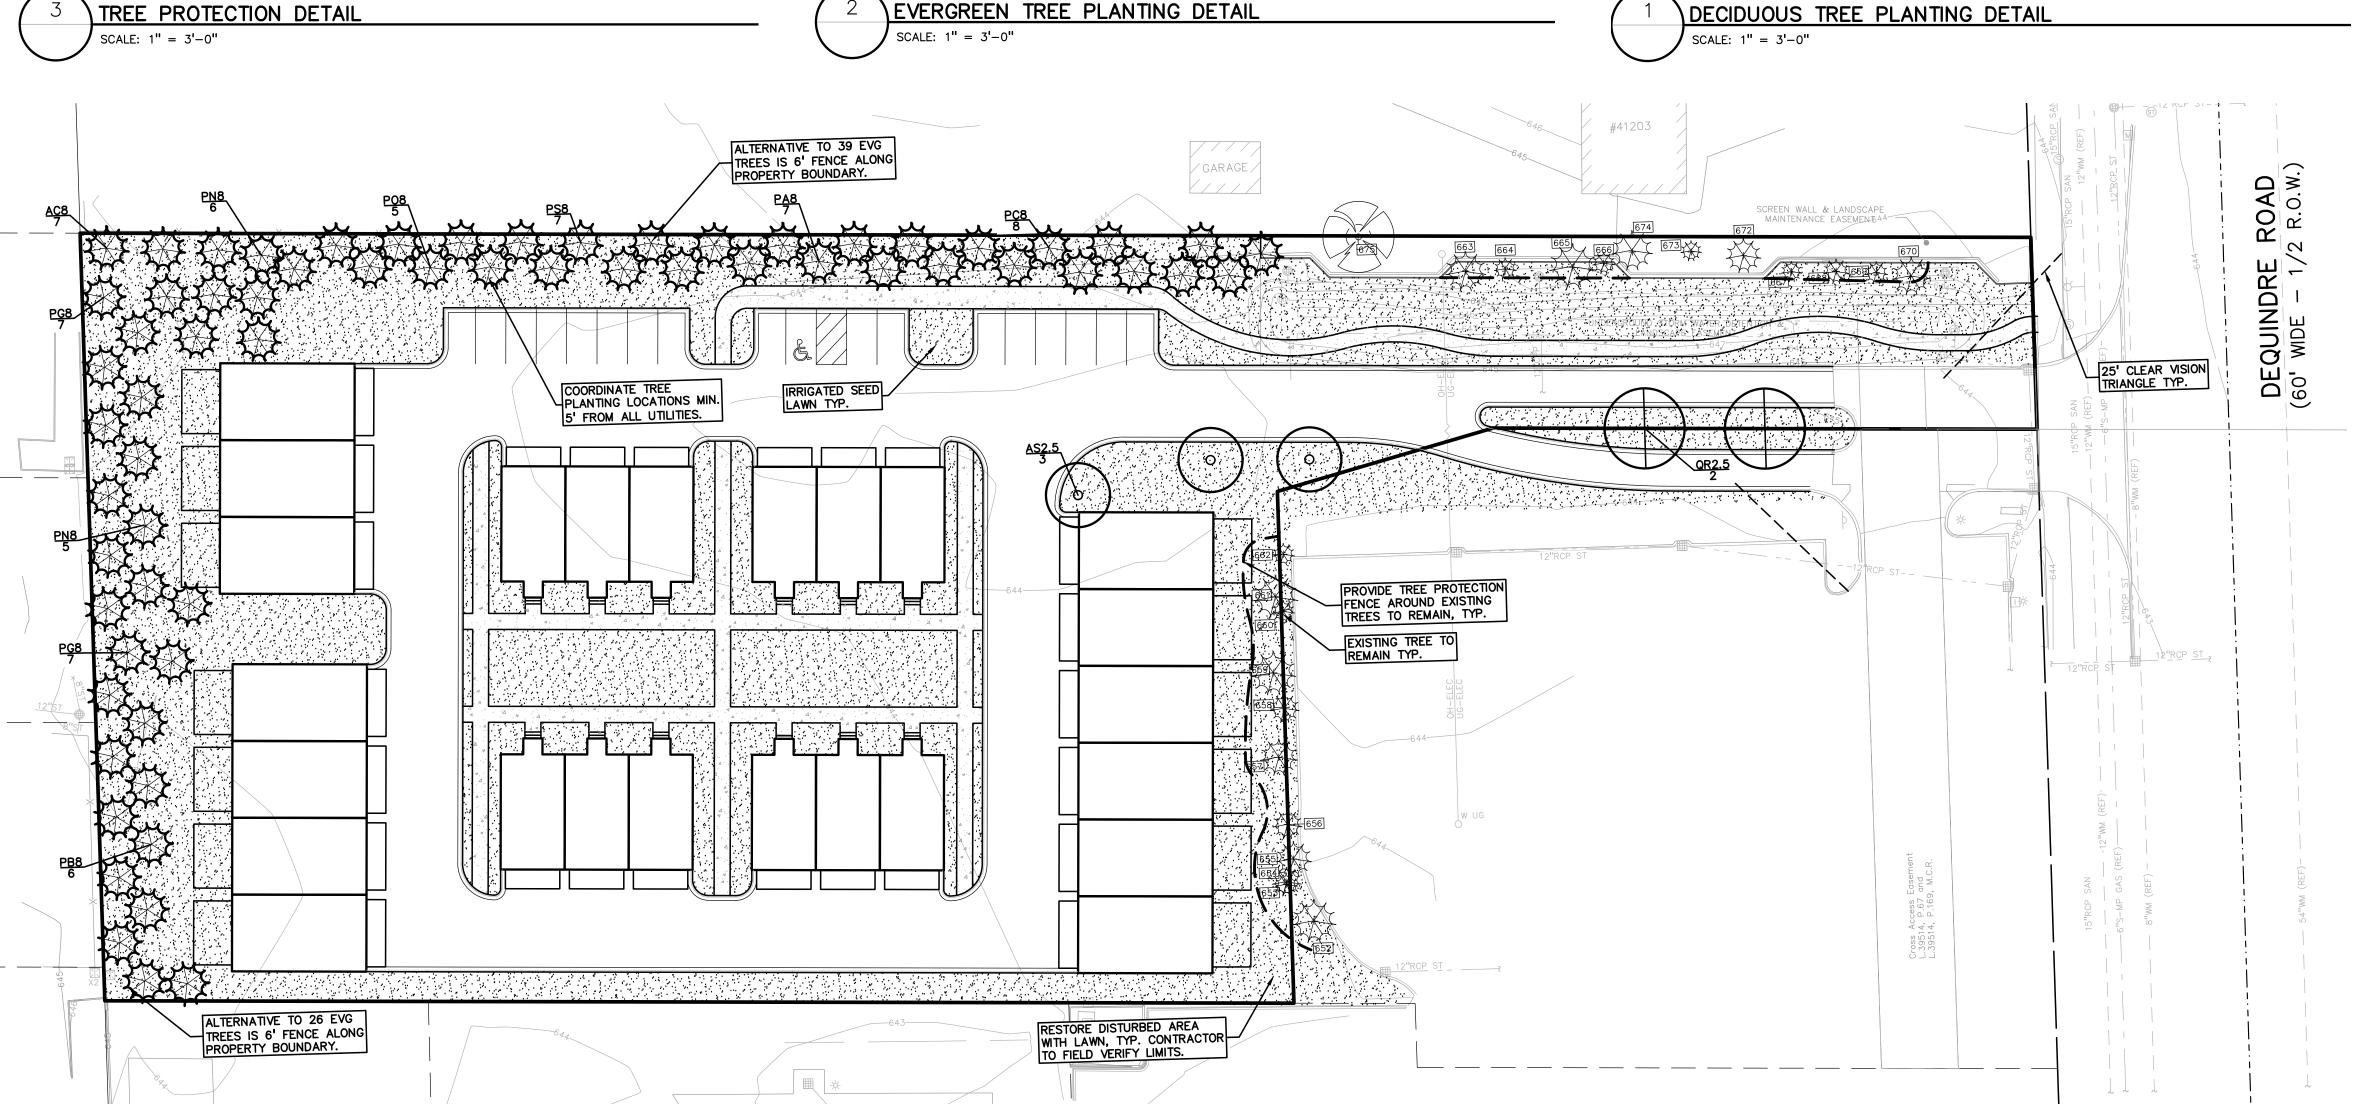

TAG	CODE	DBH	COMMON NAME	LATIN NAME	COND	NOTE	CLASS	SAVE / REMOVE	ON-SITE	REPLACE
601	EE	25	Siberian Elm	Ulmus pumila	Very Poor		INVASIVE	R	¥	-
602	NS	6	Norway Spruce	Picea Abies	Very Poor		WOODLAND	R	¥	-
603	EE	14	Siberian Elm	Ulmus pumila	Fair	4	INVASIVE	R	¥	-
604	CC	6	Choke Cherry	Prunus virginia	Poor		WOODLAND	R	¥	-
605	EE	6	Siberian Elm	Ulmus pumila	Good		INVASIVE	R	¥	-
606	EE	22	Siberian Elm	Ulmus pumila	Good		INVASIVE	R	¥	-
607	EE	7	Siberian Elm	Ulmus pumila	Very Poor		INVASIVE	R	¥	-
608	EE	22	Siberian Elm	Ulmus pumila	Very Poor		INVASIVE	R	¥	-
609	₽E	25	Siberian Elm	Ulmus pumila	Good		INVASIVE	R	¥	-
610	EE	6	Siberian Elm	Ulmus pumila	Very Poor		INVASIVE	R	¥	_
611	EE	1 3	Siberian Elm	Ulmus pumila	Poor		INVASIVE	R	¥	-
612	EE	14	Siberian Elm	Ulmus pumila	Fair		INVASIVE	R	¥	-
613	EE	17	Siberian Elm	Ulmus pumila	Fair		INVASIVE	R	¥	-
614	EE	13	Siberian Elm	Ulmus pumila	Poor		INVASIVE	R	¥	-
615	EE	19	Siberian Elm	Ulmus pumila	Fair		INVASIVE	R	¥	-
616	EE	8	Siberian Elm	Ulmus pumila	Poor		INVASIVE	R	¥	-
617	EE	2 4	Siberian Elm	Ulmus pumila	Poor		INVASIVE	R	¥	-
618	₽E	14	Siberian Elm	Ulmus pumila	Very Poor		INVASIVE	R	¥	_
619	EE	12	Siberian Elm	Ulmus pumila	Fair		INVASIVE	R	¥	-
620	EE	13	Siberian Elm	Ulmus pumila	Poor		INVASIVE	R	¥	-
621	EE	18	Siberian Elm	Ulmus pumila	Fair		INVASIVE	R	¥	-
622	EE	8	Siberian Elm	Ulmus pumila	Poor		INVASIVE	R	¥	-
623	EE	8	Siberian Elm	Ulmus pumila	Fair		INVASIVE	R	¥	-
624	EE	9	Siberian Elm	Ulmus pumila	Very Poor		INVASIVE	R	¥	-
625	EE	20	Siberian Elm	Ulmus pumila	Fair		INVASIVE	R	¥	-
626	EE	9	Siberian Elm	Ulmus pumila	Poor		INVASIVE	R	¥	-
627	EE	11	Siberian Elm	Ulmus pumila	Very Poor		INVASIVE	R	¥	-
628	EE	8	Siberian Elm	Ulmus pumila	Very Poor		INVASIVE	R	¥	-
629	EE	20	Siberian Elm	Ulmus pumila	Fair		INVASIVE	R	¥	-
630	EE	13	Siberian Elm	Ulmus pumila	Very Poor		INVASIVE	R	¥	-
631	EE	6	Siberian Elm	Ulmus pumila	Very Poor		INVASIVE	R	¥	-
632	EE	19	Siberian Elm	Ulmus pumila	Fair		INVASIVE	R	¥	-
633	MW	8	White Mulberry	Morus alba	Fair		INVASIVE	R	¥	-
634	EE	12	Siberian Elm	Ulmus pumila	Fair		INVASIVE	R	¥	-
635	EE	14	Siberian Elm	Ulmus pumila	Fair		INVASIVE	R	¥	-
636	EE	8	Siberian Elm	Ulmus pumila	Poor		INVASIVE	R	¥	-
637	EE	20	Siberian Elm	Ulmus pumila	Poor		INVASIVE	R	¥	-

TAG	CODE	DBH	COMMON NAME	LATIN NAME	COND	NOTE	CLASS	SAVE / REMOVE	ON-SITE	REPLACE
638	EE	9	Siberian Elm	Ulmus pumila	Fair		INVASIVE	R	¥	-
639	EE	22	Siberian Elm	Ulmus pumila	Fair		INVASIVE	R	¥	-
640	MW	7	White Mulberry	Morus alba	Poor		INVASIVE	R	¥	-
641	E	12	American Elm	Ulmus americana	Fair		INVASIVE	R	¥	-
642	EE	8	Siberian Elm	Ulmus pumila	Very Poor		INVASIVE	R	¥	-
643	EE	22	Siberian Elm	Ulmus pumila	Poor		INVASIVE	R	¥	-
644	₽₩	7	Black Walnut	Juglans nigra	Poor		WOODLAND	R	¥	-
645	CA	11	Crab Apple	Malus caronaria	Very Poor		WOODLAND	R	¥	-
646	EE	20	Siberian Elm	Ulmus pumila	Poor		INVASIVE	R	¥	-
647	E	10	American Elm	Ulmus americana	Good		INVASIVE	R	¥	-
648	EE	16	Siberian Elm	Ulmus pumila	Good		INVASIVE	R	¥	-
649	EE	7	Siberian Elm	Ulmus pumila	Fair		INVASIVE	R	¥	-
650	ВХ	20	Box elder	Acer negundo	Very Poor		INVASIVE	S	Υ	-
651	EE	13	Siberian Elm	Ulmus pumila	Fair	1	INVASIVE	R	¥	-
652	DF	13	Douglas Fir	Pseudotsuga menziesii	Good		WOODLAND	S	Υ	-
653	BS	6	Blue Spruce	Picea pungens	Good		WOODLAND	S	Υ	-
654	NS	8	Norway Spruce	Picea Abies	Good		WOODLAND	S	Y	-
655	NS	10	Norway Spruce	Picea Abies	Good		WOODLAND	S	Υ	-
656	BS	7	Blue Spruce	Picea pungens	Poor		WOODLAND	S	Y	-
657	NS	10	Norway Spruce	Picea Abies	Good		WOODLAND	S	Υ	-
658	BS	7	Blue Spruce	Picea pungens	Good		WOODLAND	S	Y	-
659	NS	13	Norway Spruce	Picea Abies	Fair		WOODLAND	S	Y	-
660	NS	6	Norway Spruce	Picea Abies	Good		WOODLAND	S	Y	-
661	NS	14	Norway Spruce	Picea Abies	Good		WOODLAND	S	Υ	-
662	BS	6	Blue Spruce	Picea pungens	Good		WOODLAND	S	Y	-
663	DF	13	Douglas Fir	Pseudotsuga menziesii	Good		WOODLAND	S	Y	-
664	BS	7	Blue Spruce	Picea pungens	Good		WOODLAND	S	Y	-
665	DF	15	Douglas Fir	Pseudotsuga menziesii	Good		WOODLAND	S	Υ	-
666	BS	6	Blue Spruce	Picea pungens	Good		WOODLAND	S	Υ	-
667	BS	6	Blue Spruce	Picea pungens	Fair		WOODLAND	S	Υ	-
668	DF	8	Douglas Fir	Pseudotsuga menziesii	Good		WOODLAND	S	Υ	-
669	BS	7	Blue Spruce	Picea pungens	Good		WOODLAND	S	Υ	-
670	NS	12	Norway Spruce	Picea Abies	Good		WOODLAND	S	Υ	-
671	FC	6	Flowering Cherry	Prunus spp.	Good		WOODLAND	R	¥	REPLACE
672	DF	11	Douglas Fir	Pseudotsuga menziesii	Good		WOODLAND	S	Υ	-
673	BS	7	Blue Spruce	Picea pungens	Good		WOODLAND	S	Υ	-
674	NS	12	Norway Spruce	Picea Abies	Good		WOODLAND	S	Υ	-
675	RB	22	River Birch	Betula nigra	Fair		LANDMARK	R	¥	REPLACE




WOODLAND TRE	ES REMOVED:	1	(REPLA	CE AT 50% (OF REMOVED DBH)
6''	DBH x 0.5 =		3''	REPLACE	MENT
WOODLAND TRE	ES SAVED:	21	(CREDI	T OF 2X DBI	H)
197 [DBH x 2 =		394''	CREDIT	
-	3 -	394	=	-391	
	ა -	39 4		-331	
" <u>" DBH</u>	REQUIRED FOR				<u>IT</u>
LANDMARK TREE	REQUIRED FOR		LAND RE	PLACEMEN	_
	REQUIRED FOR		LAND RE	PLACEMEN	OF REMOVED DBH)
LANDMARK TREE	REQUIRED FOR		LAND RE	PLACEMEN	OF REMOVED DBH)
LANDMARK TREE	REQUIRED FOR ES ES REMOVED: DBH x 1 =		(REPLA	CE AT 100%	OF REMOVED DBH)
LANDMARK TREE LANDMARK TREE 22" LANDMARK TREE	REQUIRED FOR ES ES REMOVED: DBH x 1 =	1 1	(REPLA	CE AT 100%	OF REMOVED DBH)







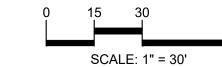



CAUTION!!

THE LOCATIONS AND ELEVATIONS OF EXISTING UNDERGROUND UTILITIES AS SHOWN ON THIS DRAWING ARE ONLY APPROXIMATE. NO GUARANTEE IS EITHER EXPRESSED OR IMPLIED AS TO THE COMPLETENESS OR ACCURACY THEREOF. THE CONTRACTOR SHALL BE EXCLUSIVELY RESPONSIBLE FOR DETERMINING THE EXACT UTILITY LOCATIONS AND ELEVATIONS PRIOR TO THE START OF CONSTRUCTION.

GFA
DEVELOPMENT,
INC.
986 ELMSFORD DR.
TROY, MI 48083

PROJECT TITLE

GFA 18 MILE & DEQUINDRE
PART OF THE SE 1/4 OF SECTION 12, T.02N., R.11E.
TROY, OAKLAND COUNTY, MI


REVISIONS	
CONDITIONAL REZONE APP.	6/8/21

ORIGINAL ISSUE DATE: SEPTEMBER 18, 2019

PRELIMINARY
PRESERVATION
PLAN

PEA JOB NO.	2016-368
P.M.	JBT
DN.	TMK
DES.	TMK
DRAWING NUMBER:	


41203 DEQUINDRE ROAD	2
41203 DEQUINDRE ROAD PARCEL NO. 20–12–476–010 GARAGE GARAGE	RCP SAN REF) — 12"RCP SAN REF) — 12"RCP ST
FAM FEXISTING TREE TO BE REMOVED TYP. FAM FAM FAM FAM FAM FAM FAM FA	DEQUINDRE RO (60' WIDE - 1/2 R.F)
639 644 639 644 634 + 635 634 + 635 634 + 635 645 + 644	644 644 15"RCP SAN 15"RCP SAN 15"RCP SAN 12"MM (REF)
OWNER: GFA DEVELOPMENT, INC. Control of the cont	12 RCP ST
TACO BELL A1167 DEQUINDRE ROAD PARCEL NO. 20–12–476–071	-15"RCP SAN12"WM (REF)6"S-MP GAS (REF)
FEDORA DRIVE O. 20–12–476–031 White the state of the st	
TROY PROFESSIONAL CENTER, LLC 41069 DEQUINDRE ROAD PARCEL NO. 20–12–476–046 2885 E. LONG LAKE ROAD PARCEL NO. 20–12–476–048	

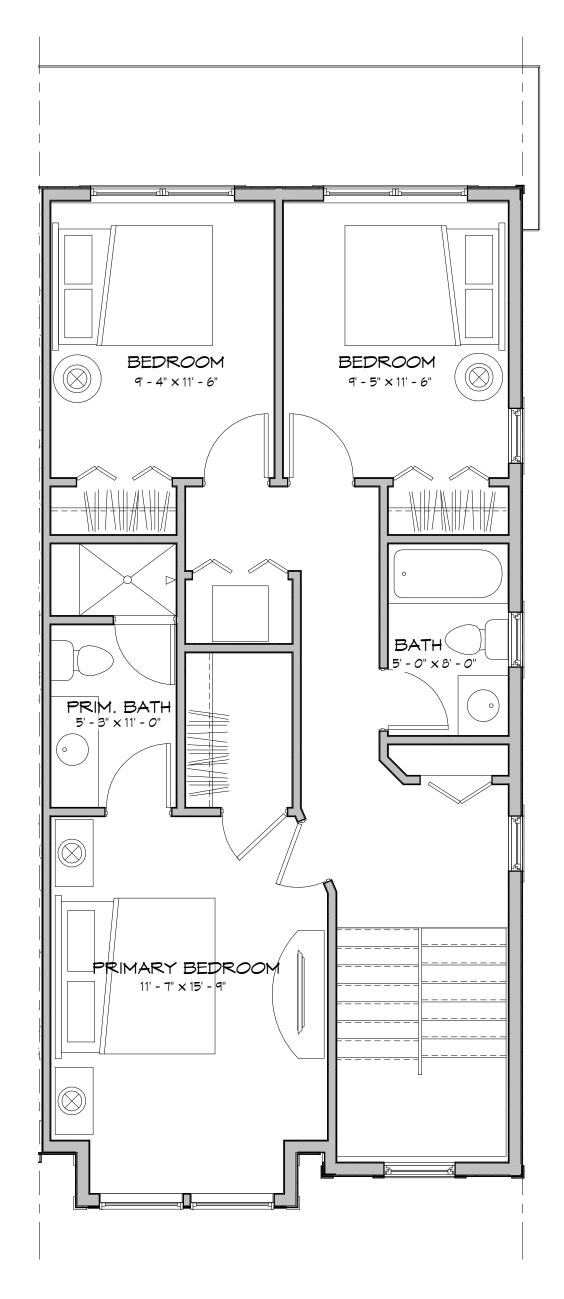

Third Floor Plan


Scale: 1/4" = 1'-0"



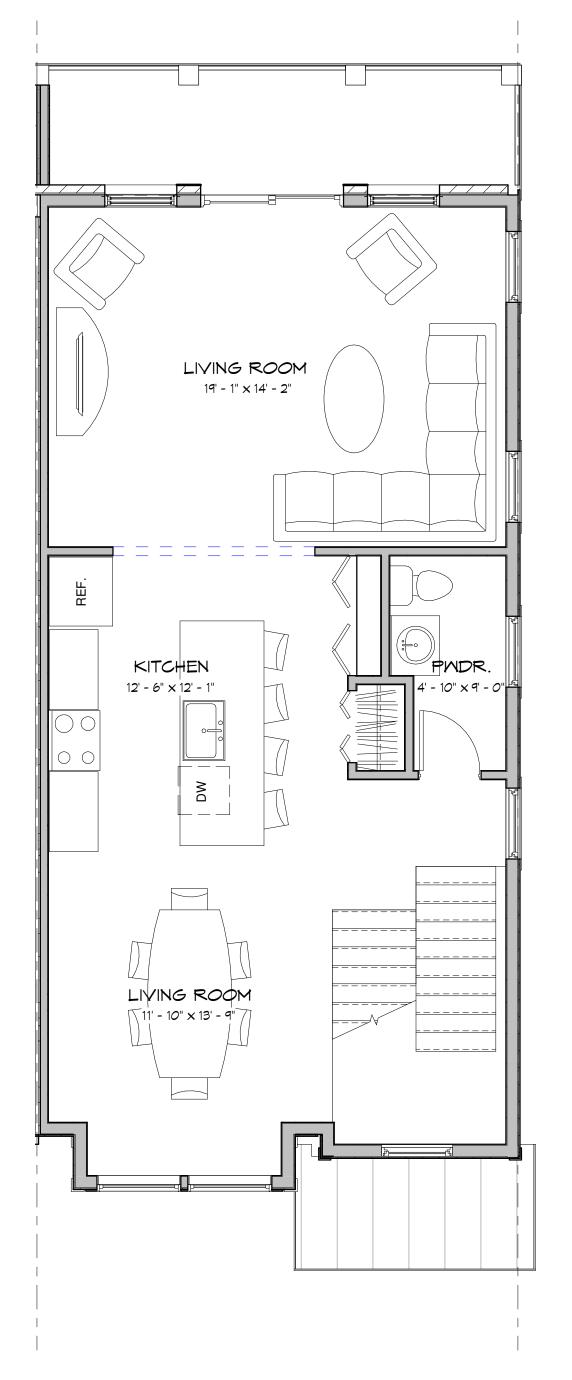

Second Floor Plan

Scale: 1/4" = 1'-0"

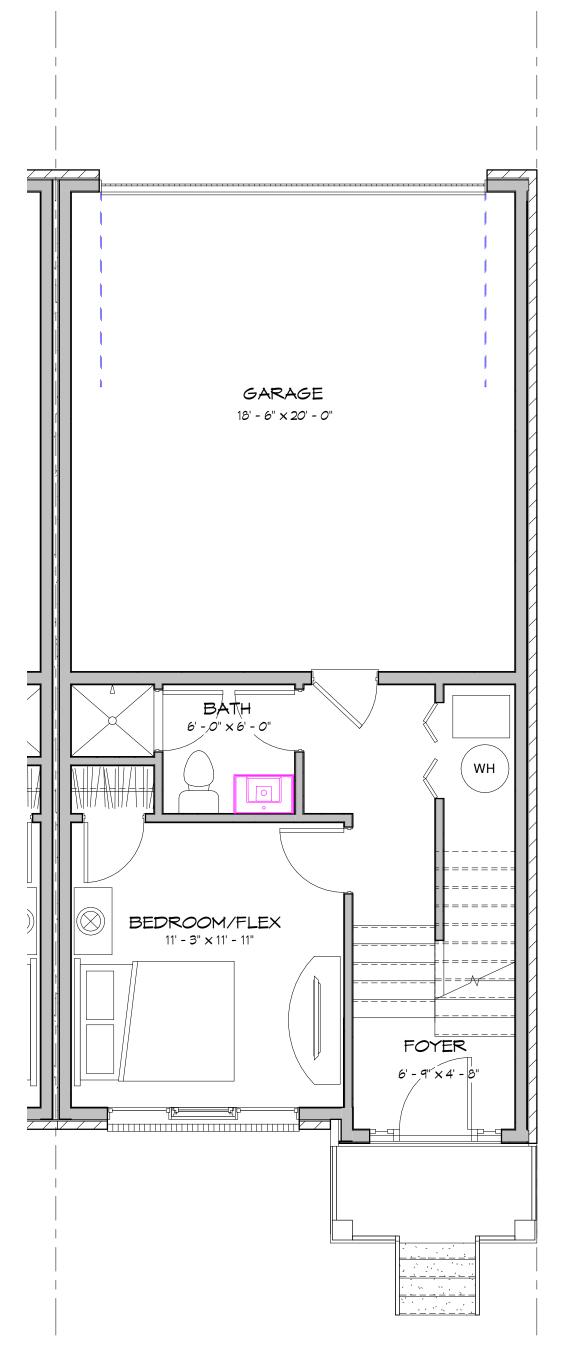

First Floor Plan

Scale: 1/4" = 1'-0"



Moiseev/Gordon Associates, Inc. 4351 Delemere Court Royal Oak, MI 48073

248.549.4500 voice 248.549.7300 facs.

www.mga-architects.net

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Client:

GFA

Development

Project Title:

Pine View Townhouses

Troy, MI

Sheet Title: Unit Plans

Project Number: 16327
Drawn By: JB, EMW
Checked By: AJM
Approved By: AJM
Date:1-13-17

2021-08-23

Issued:

For Site Plan Approval

Sheet Number:



Left Elevation

Scale: 1/4" = 1'-0"

Front Elevation

Scale: 1/4" = 1'-0"



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Client:

ASPHALT SHINGLE

BOARD & BATTEN SIDING

GFA

Development

Project Title:

Pine View Townhouses

Troy, MI

Sheet Title: Elevations

Project Number: 16327 Drawn By: JB, EMW Checked By: AJM Approved By: AJM Date:1-13-17

Issued:

For Site Plan Approval Revised

2021-08-23 2021-09-21

Sheet Number:





Rear Elecation

Right Elevation

Scale: 1/4" = 1'-0"



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Client:

GFA

Development

Project Title:

Pine View Townhouses

Troy, MI

Sheet Title:

Elevations

Project Number: 16327 Drawn By: JB, EMW Checked By: AJM Approved By: AJM Date:1-13-17

2021-08-23

2021-09-21

Issued:For Site Plan
Approval
Revised



3D VIEW



Moiseev/Gordon Associates, Inc. 4351 Delemere Court Royal Oak, MI 48073

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Client:

GFA

Development

Project Title:

Pine View Townhouses

Troy, MI

Sheet Title:

3D VIEW

Project Number: 16327 Drawn By: JB, EMW Checked By: AJM Approved By: AJM Date:1-13-17

2021-08-23

Issued: For Site Plan Approval

Sheet Number:

PEA GROUP

. . .

2430 Rochester Court, Suite 100 Troy, MI 48083 844.813.2949 peagroup.com

October 21, 2021 PEA Project No: 2016-368

Mr. Brent Savidant Community Development Director City of Troy Planning Department 500 W. Big Beaver Troy, MI 48084

RE: Conditional Rezoning Application
Parcel # 20-12-476-070
Dequindre Road, north of E. Long Lake Road
City of Troy, Oakland County, Michigan

Dear Mr. Savidant:

On behalf of **GFA Development, Inc**, we respectfully request a change in the zoning for Parcel # 20-12-476-070.

Pursuant to the provisions of the Michigan Zoning Enabling Act, P.A. 110 of 2006, as amended, and pursuant to all applicable provisions of law, we are requesting the Zoning Map of the City of Troy be amended to conditionally rezone Parcel Number 20-12-476-070, from Neighborhood Node J and EP to Neighborhood Node J, in order to construct 7-attached single-family dwelling buildings totally 25-units.

Location & Existing Conditions:

The property is located on the east side of Dequindre Road just north of the East Long Lake Road intersection (behind Taco Bell). The parcel is 2.389 acres in size and is currently undeveloped. Surrounding uses include single-family dwellings to the north and west. To the east and south are commercial businesses.

A shared drive exists for the subject parcel and Taco Bell. A landscaped berm, mature trees and 6' high concrete screen wall separate the adjacent residential home and Taco Bell. Underground detention for the Taco Bell is located under the berm.

Existing Zoning & Future Land Use:

Most of the site is zoned NN (Neighborhood Node). The northerly 40-feet of the property is zoned EP (Environmental Protection), to provide a buffer to the adjacent R-1C zoning (One Family Residential District). (See Exhibit A)

Prior to 2006, the City of Troy Zoning Ordinance did not have a zoning mechanism to provide open space buffers. Even though there may not be environmentally sensitive issues, the EP (Environmental Protection) zoning district was commonly used to provide a buffer between two different zoning classifications.

According to the Master Plan, The Future Land Use for the subject parcel is Neighborhood Node.

Proposed Use & Site Plan:

Under the proposed rezoning (**see** *Exhibit B*), the entire site would become a part of the Neighborhood Node J. The existing screen wall and trees would remain adjacent to Taco Bell and new Landscape screening would be provided along the northerly and westerly property lines (residential zoned areas).

With exception to the proposed guest parking, the area currently designated EP will remain an open space buffer.

The existing underground detention area will be expanded to the west to provide the required storm water detention for this development.

The proposed development (see Site Plan Sheets C-0.0, C-1.0, C-2.0, C-3.1, C-4.0, L-1.0, T-1.0), shall be limited to 7-buildings and 25 total units. Each unit is an attached three-story single-family residential unit. Each unit will be 1,400 to 1,700-SF and include an attached 2-car garage. The buildings materials shall consist of a mix of brick, asphalt shingles, plank siding, with variety of color palates and durable low-maintenance or maintenance free materials.

Voluntary Conditions:

Under Section 405 of the Zoning Enabling Act, the petitioner voluntarily offers uses and restrictions of the property as a condition to rezoning the land. These conditions result in recognizable and material benefits to the city that would unlikely be achieved otherwise under the site's existing zoning.

The following conditions are provided voluntarily as conditions of rezoning approval:

- 1. The Site Plan is a condition of approval.
- 2. Screen wall and trees adjacent to Taco Bell shall remain.
- 3. Development shall be limited to a maximum of 7-buildings with 25 total units.
- 4. Maximum Building Height shall not exceed 3 story or 35'4" in height.
- 5. Minimum guaranteed Open Space shall be 15%.
- 6. Minimum guaranteed Landscape Area shall be 15%
- 7. Building Materials shall be a mix of brick, asphalt shingles, plank siding, with variety of color palates and durable low-maintenance or maintenance free materials.
- 8. Each Unit shall have a 2-car garage. A minimum of 10-guest parking space shall be provided.
- 9. No exterior refuse containers shall be proposed. Individual waste and recycling containers shall be stored in each unit's garage and placed at the curb on collection days.
- 10. Minor modifications to the site plan shall be permitted and administratively approved by the Community Development Director. Minor changes would not adversely or substantially affect the conditions of the rezoning.

Rezoning Standards:

As set forth in Section 16.03.C, the Planning Commission shall consider the following:

- 1. The proposed rezoning is consistent with the Master Plan. If the current zoning is in the material conflict with the Master Plan, such conflict is does to one of the following:
 - a. A change in City policy since the Master Plan was adopted.
 - b. A change in conditions since the Master Plan was adopted.
 - c. An error in the Master Plan.
 - The City of Troy Master Plan designates the subject parcel as Neighborhood Node J.
 - Node J is defined as predominantly commercial, catering to both local needs and regional traffic, new
 development and redevelopment should be mostly commercial, identifying opportunities for small
 office mixed-use and variations in floor area to allow for a wide range of commercial types. Pedestrian
 access to the adjoining area and effective screening should be primary areas of focus during the site
 design process.
 - The proposed townhouse development is a less intense use than a commercial or small office mixed-use.
 - Landscape screening will be provided along residential zoning districts.
- 2. The proposed rezoning will not cause nor increase any non-conformity.
 - There are no natural features to protect on this parcel, as per the definition of EP. The EP zoned area
 was provided to create an open space buffer from the commercial businesses to the single-family
 residence.
 - Rezoning the EP area to Neighborhood Node will not provide any noticeable visual difference to what
 is currently provided. The proposed screening satisfies the intent to provide a buffer as was intended
 by the then Planning Commission. Additional landscape screening will be provided along the northerly
 property line.
- 3. Public services and facilities affected by a proposed development will be capable of accommodating service and facility loads caused by use of the development.
 - The proposed number of multiple-family dwelling units is compatible with surrounding uses and zoning in terms of:

Environment

Density

Traffic volumes

Aesthetics

Infrastructure

Potential influence on property values

- All public utilities are available at the property and sized to accommodate the develop.
- Dequindre Road is capable of safely and efficiently accommodating expected traffic volumes generated by the proposed number of multiple-family dwelling units.
- 4. The rezoning will not impact public health, safety, or welfare.
 - The capacity of public utilities and services is sufficient to accommodate the proposed number of multiple-family dwelling units without compromising the city's health, safety and welfare.
- 5. The rezoning will ensure compatibility with adjacent uses of land.

- Rezoning to NN is constant with the Future Land Use Map.
- The proposed number of multiple-family dwelling units is consistent with the characteristics of surrounding buildings and uses.
- Rezoning would create a uniform district that could not be provided prior to the Michigan Zoning Enabling Act.
- The Townhouse development will provide a transition between the Commercial Businesses and the Single-Family District.

Rezoning Standards / Reasons of Recommendation:

- A. Creates a uniform Zoning district that could not be provided prior to the Michigan Zoning Enabling Act.
- B. The site's physical and other environmental features are compatible with the proposed number of multiple-family dwelling units.
- C. The proposed number of multiple-family dwelling units is compatible with surrounding uses and zoning in terms of the environment, density, traffic volumes, aesthetics, infrastructure, and potential influence on property values.
- D. The street system is capable of safely and efficiently accommodating expected traffic volumes generated by the proposed number of multiple-family dwelling units.
- E. The capacity of public utilities and services is sufficient to accommodate the proposed number of multiple-family dwelling units without compromising the city's health, safety and welfare.
- F. There is an apparent demand in the City for multiple-family dwelling units in relation to the amount of land in the city currently zoned and available to accommodate the demand.
- G. The rezoning of the property does not unreasonably impact the adjacent properties.

The proposed rezoning will allow the site to be developed in a manner consistent with the City of Troy's Master Plan and maintain the intended open space buffer between proposed condominium and the existing single-family homes.

Thank you for your consideration,

PEA Group, Inc.

John B. Thompson, PE Senior Project Manager

Cc: Gary Abitheira, GFA Development, Inc.

Attachment: Application

Exhibit A – Existing Zoning Exhibit B – Proposed Zoning

Exhibit C – Site Plan

Chair Krent called the Regular meeting of the Troy City Planning Commission to order at 7:01 p.m. on October 26, 2021, in the Council Chamber of the Troy City Hall. Chair Krent presented opening remarks relative to the role of the Planning Commission and

procedure of tonight's meeting.

1. ROLL CALL

Present:

Carlton M. Faison Michael W. Hutson Tom Krent David Lambert Lakshmi Malalahalli Marianna Perakis Sadek Rahman Jerry Rauch

Also Present:

John J. Tagle

R. Brent Savidant, Community Development Director Ben Carlisle, Carlisle Wortman Associates Allan Motzny, Assistant City Attorney Kathy L. Czarnecki, Recording Secretary

2. <u>APPROVAL OF AGENDA</u>

Resolution # PC-2021-10-074

Moved by: Faison Support by: Rauch

RESOLVED, To approve the Agenda as prepared.

Yes: All present (9)

MOTION CARRIED

3. <u>APPROVAL OF MINUTES</u>

Resolution # PC-2021-10-075

Moved by: Lambert Support by: Tagle

RESOLVED, To approve the minutes of the October 12, 2021, Regular meeting as submitted with one typographical error that has been corrected.

Yes: All present (9)

MOTION CARRIED

4.

PUBLIC COMMENT – For Items Not on the Agenda

There was no one present who wished to speak.

ZONING ORDINANCE TEXT AMENDMENT

PUBLIC HEARING – ZONING ORDINANCE TEXT AMENDMENT (File Number ZOTA 256) Residential Uses in BB Zoning District

Mr. Savidant said the intent of the proposed Zoning Ordinance Text Amendment is to provide flexibility for developers when renovating existing multi-story buildings and constructing new multi-story buildings in the Big Beaver zoning district. He said the amendment would permit some residential use in appropriate locations on the first floor for sites located on Big Beaver and arterials, which presently residential uses are permitted only on upper floors.

PUBLIC HEARING OPENED

There was no one present to speak.

PUBLIC HEARING CLOSED

Ms. Perakis expressed opposition to the proposed text amendment. She said it is clearly a contradiction to the Master Plan, that she sees no unique circumstances that would warrant a rezoning, that we are not permitted to rezone property simply to make a more valuable use, and we are not permitted to rezone property to reassure a developer is able to maximize their profits. Ms. Perakis said she had hoped the developer who initiated the email message was present to address the Board.

Mr. Rauch said he supports the proposed text amendment with a Special Use requirement. He does not think one solution fits all. Mr. Rauch asked what would happen to parking lots if residential is developed. He addressed office vacancy, walkability in downtown area and potential opportunity for developers.

Mr. Savidant said it would be a simple change to the proposed text amendment to change the first floor lodging to a Special Use requirement. He said a Special Use application would add an additional layer to the application process and Special Use standards would apply. He said it could be a better step in direction for the developer. Mr. Savidant said approval of a Special Use by the Planning Commission would be subjective.

There was discussion on:

- Potential of residential development attracting more commercial development.
- Viable walkability throughout City.
- Existing buildings with residential on first floor; relationship to Big Beaver.
- Consensus to revise amendment to require Special Use application.

Resolution # PC-2021-10-076

Moved by: Lambert Support by: Hutson

RESOLVED, To recommend that Chapter 39 of the Code of the City of Troy be amended to revise Table 5.04.C-1, Line 2 for Residential Lodging, to amend that "P" be changed to "S" for the items that are listed on the line and the footnote to be revised as well.

Yes: All present (9)

MOTION CARRIED

PRELIMINARY SITE PLAN REVIEWS

6. PRELIMINARY SITE PLAN REVIEW - (SP JPLN2021-019) — Proposed Motor City Church, East side of Livernois, North of Big Beaver (3668 Livernois), Section 22, Currently Zoned R-1C (One Family Residential) District

Mr. Tagle asked to recuse himself from this item because his architectural firm is involved in the project.

(Mr. Tagle exited meeting at 7:25 p.m.)

Mr. Carlisle gave a review of the Preliminary Site Plan application for Motor City Church. He identified the "dome" area and "school" area, noting the school would turn into the church. He identified the site and building changes proposed, noting there are no significant changes to the site and building arrangement. Mr. Carlisle addressed the proposed demolition of the "dome" church and Special Use that applies to the entire site. He said the landscaping is compliant apart from the required number of interior trees within the parking lot. He reported the applicant is asking the Planning Commission to consider a parking lot landscaping deviation. Mr. Carlisle recommended approval of the application with the condition to provide required bicycle parking.

Discussion among Board and administration:

- Proposed split of properties as relates to parking.
- Condition approval on property split.
- Current use of "dome" church.
- Explanation of Special Use as relates to proposed and future development.
- Condition approval on existing "dome" church does not function as church.
- Height and width of Livernois elevation.

Present were Rachel Pisani, representative of Motor City Church, and Project Architect Michele Sargeant of John Tagle Associates.

Ms. Pisani said the property was acquired from Zion Christian Church in October 2019. She gave a brief history of the Motor City Church since its launch on March 15, 2020. She addressed its online services through the pandemic, its involvement in community projects and its commitment to the community. Ms. Pisani said Motor City Church wants to update the building to make it more attractive and inviting. She addressed the use of the chapel, growth in congregation, offering of multiple services and parking sufficiency. Ms. Pisani said their intent is to sell the property to the north for future development. She said Motor City Church would open other campuses should the congregation grow beyond its current capacity to keep the small community church feel. Ms. Pisani addressed present uses of the buildings, the new playground and demolition of the "dome" church building.

There was discussion on:

- Ownership of property.
- Size of congregation; growth potential.
- Vision of property to north for future development.
- Current and future uses of buildings.
- Parking lot improvements.
- Size of property; 22 acres total, 8 acres for proposed development.
- Potential change of use in future; review by Planning Commission.

Mr. Carlisle explained how the underlining zoning and Special Use for a place of worship relates to the entire property, the proposed development before the Board and future development or redevelopment of the remaining property.

Mr. Savidant stated the sanctuary area of the "dome" cannot be used as a church, but a classroom can be used as an ancillary use.

Ms. Sargeant clarified Motor City Church is currently using the "dome" building until the proposed new building is built out. She gave dimensions of the proposed entry addition as 24 feet in height and an estimated 30 feet in width, and confirmed the rendering is a view from Livernois. Ms. Sargeant addressed landscaping of the existing parking lot. She said the intent is for a tree-lined entrance, a landscaped area in the front and in the center with sidewalks and walkways throughout an improved parking lot.

After a lengthy discussion on landscaping the parking lot, there was consensus by the Planning Commission and the applicant to break up the parking lot into six islands and provide 12 additional trees within the parking lot.

Resolution # PC-2021-10-077

Moved by: Rauch Support by: Lambert

RESOLVED, The Planning Commission recommends that Preliminary Site Plan Approval, pursuant to Article 8 of the Zoning Ordinance, as requested for the proposed Motor City Church, East side of Livernois, North of Big Beaver (3668 Livernois), Section

- 22, Currently Zoned R-1C (One Family Residential) District, be **GRANTED**, subject to the following conditions:
- 1. Provide two (2) bicycle racks.
- 2. Six islands with 12 trees be provided in the parking lot.
- 3. That the present use of the sanctuary be discontinued at the time of completion of the new building and the new building takes over that use as a sanctuary.

Discussion on the motion on the floor.

Mr. Lambert acknowledged that adding trees in the interior parking lot not only improves safety but also helps to dissipate heat from the asphalt.

Vote on the motion on the floor.

Yes: Faison, Hutson, Krent, Lambert, Malalahalli, Perakis, Rahman, Rauch (*Tagle recused*)

MOTION CARRIED

(Mr. Tagle returned to meeting at 8:15 p.m.)

7. PRELIMINARY SITE PLAN REVIEW (JPLN 2021-0013) — Proposed Center Court at Butterfield 48-unit Townhome Development, North side of Butterfield, South of Big Beaver, West of Crooks (Parcels 88-20-29-226-021, -022, -023), Section 29, Currently Zoned MF (Multiple Family Residential) District

Mr. Carlisle reviewed the changes to the Preliminary Site Plan application for Center Court at Butterfield since last reviewed by the Planning Commission at their October 12, 2021 meeting. He indicated the changes relate to an overall net loss of four (4) units, a larger recreational area in the center of the site, an increase in recreation space and decrease in building coverage. Mr. Carlisle said the applicant added windows to both the side elevation and the front door entrance based on Planning Commission comments. He indicated no changes were made to the guest parking spaces initially addressed in his report. Mr. Carlisle said the application meets all requirements of the multiple family residential district and recommended approval with conditions to revise guest parking spaces and to address elevations and materials as directed by the Planning Commission.

Discussion among Board and administration:

- Pedestrian crosswalk at entrance; layout in angle and termination.
- Non-symmetry of buildings to accommodate fire apparatus.
- Open space / recreation space.
 - o Definitions.
 - Interpretation / intent of Zoning Ordinance.
- Various municipality calculations on open space, occupancy, price points.
- Sidewalks; location, conflict with seating areas and material.

Mr. Carlisle read the definition of open space noting that sidewalks would be counted as open space. He said the proposed sidewalk/pathway constitutes recreation space but there is no definition of recreation space.

Erion Nikolla of Eureka Building Company addressed reducing the units by four (4) to provide for more recreation space, a bigger playground and additional family activities. Mr. Nikolla indicated he is open to making a sidewalk track on the perimeter of the property and of a different material such as black tar or pavers. He said glass was added to the center door of the entrances and windows to the side elevations.

There was discussion on:

- Side elevations; prominence of windows.
- Landscaping; push back landscaping in middle.
- Location of sidewalks.
 - Jogging/walking path around property perimeter.
 - Material of path.
- Guest parking.
 - No requirement to provide.
 - o Elimination of some spaces to ease reversing out.
 - o Adding landscaping along side of building.
- · Widening sidewalk to seven (7) feet.
- Entrance doors; provide overhang for protection from inclement weather.

Resolution # PC-2021-10-078

Moved by: Lambert Support by: Faison

RESOLVED, The Planning Commission recommends that Preliminary Site Plan approval, pursuant to Article 8 of the Zoning Ordinance, as requested for the proposed Center Court at Butterfield 48-unit Townhome Development, North side of Butterfield, South of Big Beaver, West of Crooks (Parcels 88-20-29-226-021, -022, -023), Section 29, Currently Zoned MF (Multiple Family Residential) District, be **GRANTED**, subject to the following:

- 1. Revise the guest parking spaces to reduce the number of spaces to allow landscape buffers between the vehicles and those guest parking spaces.
- 2. Revise the perimeter walkway so that it would be extended out farther to avoid the seating areas around the corners of the site and to use enhanced concrete.
- 3. Widen the sidewalk to seven (7) feet.
- 4. Push back landscaping to expand the open space.
- 5. Revise pedestrian crosswalk layout at the front of the building to make it more logical and safer.

Yes: All present (9)

MOTION CARRIED

CONDITIONAL REZONING

8. <u>CONDITIONAL REZONING - (CR JPLN2021-001)</u> – Proposed Pine View Condominiums, West side of Dequindre, North of Long Lake (88-20-12-476-070), Section 12, From NN (Neighborhood Node "J") and EP (Environmental Protection) to NN (Neighborhood Node "J")

Chair Krent announced the applicant has requested to give a statement prior to the presentation of the application by staff.

Applicant Gary Abitheira asked that Commissioner Rauch recuse himself from this item due to a conflict of interest. Mr. Abitheira acknowledged a letter from his attorney that Commissioner Rauch has entered into a lawsuit against developer Sam Stafa relating to a Neighborhood Node development near the home of Commissioner Rauch. Mr. Abitheira believes that Commissioner Rauch has a conflict of interest with all Neighborhood Node developments.

Mr. Rauch said he does not understand how he could have a conflict of interest on the application before the Board this evening. He said the lawsuit to which the applicant is referring relates to potential flooding on his property as a result of a Neighborhood Node development near his home.

Mr. Motzny referenced material he researched on conflicts of interest from the Troy Board and Committee Appointee Code of Ethics, State Law with regard to Public Officers, Planning Commission Bylaws, Parliamentary Procedure and the Michigan Planning Enabling Act.

Mr. Motzny concluded that a Board member himself/herself must disclose a potential conflict of interest. If the member does not believe there is a conflict, the Board cannot compel that member not to vote. If the member discloses a potential conflict of interest, the remaining members can conduct a vote whether the member should be disqualified.

Mr. Rauch said the lawsuit to which the applicant refers relates to the Neighborhood Node located at Crooks and Wattles and the potential flooding onto his property. Mr. Rauch said any decision on the application before the Commission this evening would have no impact on his property. He declared no conflict of interest on the application before the Board this evening.

After a brief discussion, it was the consensus of the Board to move forward because there was no conflict of interest disclosed by Mr. Rauch.

Mr. Savidant reported there are no changes to the Conditional Rezoning application since it was last reviewed by the Planning Commission at its August 24, 2021 meeting, with exception of clarification on the height of the 3-story building at 35 feet, 4 inches. Mr. Savidant reminded the Board of the two failed Resolutions with a 4-4 vote, one for approval and one for denial. He said the application and public hearing was scheduled at the September 27, 2021 City Council meeting but the applicant pulled the item prior

to City Council consideration and asked to come back to the Planning Commission for reconsideration.

Mr. Tagle asked the Planning Consultant to give a brief review of the application because he was absent from the August meeting.

Mr. Carlisle addressed the 40-foot wide strip of EP zoning and referenced the action taken by the Planning Commission at their November 19, 2020 meeting to postpose the item to allow the applicant to submit a conditional rezoning application to rezone the EP portion so it could be used for guest parking.

Mr. Carlisle said the southern portion of the property is a by-right development. He noted of significant importance are the applicant's voluntary conditions numbered 1, 4, 7 and 8. Mr. Carlisle addressed the landscaping, required screening at the southern edge of the property, the engineering department pedestrian connection improvements, shared access to the site with Taco Bell, maximum height not to exceed 35 feet, and design and site plan standards.

Mr. Carlisle referenced the failed Resolutions at the August 24, 2021 Planning Commission meeting and the applicant's request to be considered again by Planning Commission.

Mr. Carlisle recommended that the Planning Commission recommend to the City Council to grant the Conditional Rezoning and Preliminary Site Plan application with the conditions as identified in his most recent report dated October 19, 2021. He asked the Planning Commission to consider the applicant's request to use a fence in lieu of the required landscape screening.

There was discussion on:

- Crash data provided in the agenda packet.
- Anticipated traffic impact, as relates to office and residential.
- Traffic backup mentioned during public comment.
 - No information to support.
 - Queuing for drive through resulting in backup; no issues reported to police.
- Building orientation as relates to design standards.
 - Memorandum prepared and provided by Zoning Administrator relating to building orientation.
 - Role of Zoning Administrator to interpret the Zoning Ordinance.
 - o Site Type B, Building Form C, permitted use.
- Confirmation that application meets open space requirement (15%).
- Master Plan survey results with respect to desirable residential.
- Transition and compatibility of development.
- Ownership of access (easement).

Mr. Abitheira addressed previous actions taken by Planning Commission on the shared entrance with Taco Bell. He addressed Taco Bell hours of operation, timing of accidents, curb cuts, queuing of drive-through traffic, housing that attracts young professionals and the initial request by a former Planning Commission member to eliminate the EP zoning district. Mr. Abitheira distributed to the Board a map/site plan of the Taco Bell property and his property in 2007, at which time the subject property was zoned O-1. He addressed ingress/egress of the properties and traffic.

Mr. Savidant addressed his memorandum and interpretation of the Zoning Ordinance on building orientation.

Chair Krent opened the floor for public comment.

There was no one present who wished to speak.

Chair Krent closed the floor for public comment.

An email message from Laura and Mike Lipinski, 4233 Carson, Troy, in opposition of the proposed application was provided to the Board prior to the beginning of tonight's meeting.

Mr. Tagle brought it to the attention of the Board and audience that the Lipinski's do not live near the proposed application and the development would have no impact on their property.

Mr. Carlisle said clearly there is a disagreement with the interpretation of the Zoning Ordinance by the Zoning Administrator and him on the issue of building entrance frontage. He addressed transition, urban characteristics and compatibility on the subject site and its surrounding properties, noting it could be determined more urban than not. Mr. Carlisle said townhomes or lower-scaled density multi-family residential has been traditionally an appropriate transition buffer from single family to commercial, one story or multi-story commercial.

Mr. Carlisle said the proposed use is an appropriate transitional use from adjacent single family and commercial that fronts on Dequindre and Long Lake. He said based on the intent of the Neighborhood Node, this Neighborhood Node might not be the vision the City wants to achieve there so it is difficult to compare with what is there now. The intent was for multi-family and other mixed use types of products.

Mr. Carlisle said results from the Master Plan survey indicated residents do not want more townhomes but he would like to make it clear to the Planning Commission that townhomes are a permitted and by-right building form in this district; and the application meets the standards of a Neighborhood Node for a by-right development. He said discussion this evening is whether to conditionally rezone the EP part of the site plan to Neighborhood Node. He said if the applicant removed the EP request from the application and came in with a by-right development where there is no proposed development on the EP portion, the recommendation would be for approval because it

is a transitional land use and product supported by the Zoning Ordinance for that particular site.

Mr. Rauch said he does not think townhomes in this instance are transitional versus single family. He says when the Planning Consultant states that a development is a byright development, it feels like he is being bullied to do whatever the recommendation is from the Planning Consultant.

Mr. Savidant again addressed traffic data provided and the approval in 2006 of the relationship between the subject property and Taco Bell. He said office would be another transitional use and stated office would generate more traffic than multiple family residential. Mr. Savidant addressed the development rights of the property owner and said he does not think it is fair or proper to deny an application based on traffic or existing conditions that have been in place for the past 15 years.

Mr. Savidant stated there is a wide range of different uses that are permitted by right in Neighborhood Nodes, including townhomes and other forms of residential, office and commercial.

Mr. Abitheira requested to construct a 6-foot high decorative fence on the south side of the property in lieu of the required landscaping. He shared that the property is very tight and it would be somewhat of a challenge to landscape.

Mr. Abitheira said he owns the cross access easement property at the Taco Bell entrance up to Dequindre Road and the title work process will verify that.

Resolution # PC-2021-10-079

Moved by: Tagle Support by: Faison

RESOLVED, That the Planning Commission hereby recommends to the City Council that the NN "J" and EP to NN "J" Conditional Rezoning request, as per Section 16.04 of the City of Troy Zoning Ordinance, located on the west side of Dequindre, north of Long Lake, within Section 12, being approximately 2.389 acres in size, be **GRANTED**, for the following reasons:

- 1. The request complies with the Master Plan.
- 2. The EP district does not include any significant natural features.
- 3. The rezoning would permit greater flexibility in use and development of the property.
- 4. The conditions offered by the applicant reasonably protect the adjacent properties.
- 5. The rezoning would be compatible with surrounding zoning and land use.
- 6. The site can be adequately served with municipal water and sewer.

BE IT FURTHER RESOLVED, That the Planning Commission recommends the following site plan design considerations:

- 1. Submit photometric plans and fixture details prior to Final approval.
- 2. Address Engineering Department comments related to pedestrian connection prior to Final approval.
- 3. Provide site landscaping calculation.
- 4. Indicate siding material.
- 5. Provide conditional rezoning agreement prior to City Council consideration.
- 6. That the barrier on the south property line be a fence in lieu of landscaping.

Yes: Faison, Hutson, Krent, Lambert, Malalahalli, Rahman, Tagle

No: Perakis, Rauch

MOTION CARRIED

OTHER ITEMS

9. <u>PUBLIC COMMENTS</u> – For Items on the Agenda

There was no one present who wished to speak.

10. PLANNING COMMISSION COMMENT

Mr. Tagle stated for the record in all his years on the Commission he has never felt bullied by the Planning Consultant, and he thought the comment inappropriate.

Mr. Faison said the conversation about transition was interesting. He said he accepted both the applicant's comments about the ranch being able to redevelop into something taller and Mr. Carlisle's comments about the projects on the corner not necessarily being what the Board would like the node to be and what the node could be. He said he thinks it might be more appropriate to look at what could be there.

Mr. Faison addressed the issue of the entrances on the street. He said he has read the language several times and the memorandum prepared by staff. He said he sees the logic of the approach taken in the interpretation of the Zoning Ordinance by the administration. Mr. Faison questioned if the matter should be discussed during a meeting or if each member individually should decide.

Mr. Lambert informed the Board that at last evening's meeting, City Council voted to name the park next to the skate park the *Jeanne Stine Community Park*.

Ms. Perakis said she appreciated Mr. Faison's comments on transition. Ms. Perakis shared favorable comments on the Citizens Planner course she is taking and looks forward to getting her certification in a week.

Mr. Rauch formally requested his communication on the Zoning Ordinance interpretation for primary building entrances in Neighborhood Nodes and the proposed text amendment be placed on an agenda for discussion.

Mr. Rauch addressed his comment on bullying. He said it appears that if there are objections to an application, the members often hear from the staff or the consultant that the application is a by-right development. He wished that Ms. Dufrane were in attendance this evening to provide an explanation on the subjectivity of the Zoning Ordinance relating to transition, compatibility, open space and recreation space. He considers those items to be subjective. Mr. Rauch said some of the answers to questions have been along the lines that an application is allowed within the form based district and the Board should approve. He said it completely takes the subjectivity out of a determination. Mr. Rauch addressed changes in the density of residential developments within the last five years, noting the survey shows that residents are not happy.

Ms. Malalahalli asked that the Board be provided a clear understanding of the open space requirements and how open space is defined.

Chair Krent asked that the Board be advised of a better definition of recreation space.

Mr. Savidant asked that there be a formal resolution to place Mr. Rauch's communication on an agenda. Mr. Savidant said he does not think it is appropriate that the Zoning Administrator, which he serves as and as a representative of the City Manager, is put in a position to debate or defend an interpretation of the Zoning Ordinance. He said he is not sure if that was the intent of Mr. Rauch but that he hesitates to go down that path. Mr. Savidant asked to confer with the City Attorney prior to placing the item on an agenda for discussion.

Chair Krent stated he never felt bullied by Mr. Carlisle, he appreciates Mr. Carlisle's excellent perspective on the Zoning Ordinance and Master Plan and that he conducts himself in a professional manner to get things done. Chair Krent addressed the upcoming Michigan Association of Planners Conference that again is a virtual event this year. He encouraged Board members to participate.

Mr. Savidant said the beauty of remote sessions at the Michigan Association of Planners Conference is that one can view all the sessions offered.

Mr. Rauch said he would hold off on a formal resolution so that the administration can confer with the City Attorney.

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Mr. Rauch said he would hold off on a formal resolution so that the administration can confer with the City Attorney.

11. ADJOURN

The Regular meeting of the Planning Commission adjourned at 10:45 p.m.

Respectfully submitted,

Tom Krent, Chair

Kathy L. Czarnecki, Recording Secretary

Kathy J. Garnechi

https://d.docs.live.net/2f7ed4fe5f664ea8/Documents/Kathy/COT Planning Commission Minutes/2021/Jun through Dec 2021/2021 10 26 Regular Meeting_Final.doc

CONDITIONAL REZONING AGREEMENT

THIS CONDITIONAL REZONING AGREEMENT is hereby entered into and among GFA DEVELOPMENT INC., a Michigan Corporation ("Developer" and "Owner"), whose address is 985 Elmsford, Troy, Michigan 48083, and the CITY OF TROY, a Michigan Municipal Corporation ("City"), on 500 W Big Beaver, Troy Michigan, 48084.

RECITALS:

- A. The Owner is currently the fee owner of real property located of vacant property the west side of Dequindre, north of Long Lake Road, Troy, Michigan, more specifically described on Exhibit A attached hereto ("Development Parcel").
- B. The Owner/Developer has purchased the Development Parcel and intends to improve the Development Parcel as an attached multi-family residential townhouse development.
- C. In order to facilitate the sale of the development, the Developer desires to have the Development Parcel be re-zoned from Neighborhood Node ("NN") and Environmental Protection ("EP") to NN per section 16.04 of the Neighborhood Node "J" under the Troy

Zoning Ordinance.

- D. The Developer has voluntarily offered to enter into the Conditional Rezoning Agreement consistent with the Michigan Zoning Enabling Act, Public Act 110 of 2006, as amended.
- E. This Conditional Rezoning Agreement is made by the City pursuant to authority granted to the City under MCLA §125.3405, as amended.
- F. The City, by action of its City Council at its meeting of _______,
 2022, has accepted the offer of the Owner/Developer to enter into this Conditional Rezoning
 Agreement.

ARTICLE 1 DEFINITIONS AND COVENANTS

- 1.1 "Effective Date" means the date of ______, 2022, which is ten (10) days after the execution of this Conditional Rezoning Agreement by the City.
- 1.2 "Improvements" means (a) acquisition of building permits; or (b) submission of required site bonds to the City; or (c) on-site improvements such as site grading, inground utility changes, and building staking.
 - 1.3 "Troy Zoning Ordinance" means Chapter 39 of the Code of the City of Troy.
- 1.4 "Zoning Enabling Act" means the State of Michigan's Act 110 of the Public Acts of 2006, as amended (MCLA §125.3101, et. seq., as amended).
- 1.5 "Zoning Parcel" means parcel number 88-20-12-476-070 with approximately2.38 acres, legally described in Section 12 from NN Neighborhood Node "J" and EP(Environmental Protection) to NN Neighborhood Node "J" in Exhibit A attached hereto.

ARTICLE 2 DESCRIPTION OF DEVELOPMENT

- 2.1 <u>Development Description</u>. The development involves the construction of an attached multi-family townhome with attached buildings community on the Development Parcel as referenced in Exhibit B attached hereto.
- 2.2 Zoning Parcel. The Development Parcel is described in Exhibit B attached hereto.
- 2.3 <u>Current Ownership of Development Parcel</u>. The Development Parcel is currently owned by the Owner/Developer and he has fee title to the development Parcel, as the Owner, which does not require a further act or deed. The Owner/Developer shall have the subsequent right, if it desires, to assign or transfer the fee title of the Development parcel to another entity or an entity to be formed, and this Conditional Rezoning Agreement shall be assigned to that entity.
- 2.4 <u>Site Plan</u>. The documents, drawings and submittals for the Development Parcel which constitute the Preliminary Site Plan are identified on PEA Group Sheet Nos. C.0.0 Cover Sheet, C.1.0 Topographic Land Survey, C.2.0 Preliminary Site Plan, C.3.0 Preliminary Grading Plan, C.4.0 Preliminary Utility Plan, L-1.0 Preliminary Landscape Plan; T-1.0 Preliminary Preservation Plan and described and attached as Exhibit B.

ARTICLE 3 REZONING AND CONDITIONS

Pursuant to the provisions of the Michigan Zoning Enabling Act, P.A. 110 of 2006, as amended, and pursuant to all applicable provisions of law, Developer is requesting the Zoning Map of the City of Troy be amended to conditionally rezone Parcel Number 20-12-476-070,

from Neighborhood Node J and EP to Neighborhood Node J, in order to construct 7-attached single-family townhouse dwelling buildings totaling 25-units.

3.1 <u>Location & Existing Conditions</u>. The property is located on the west side of Dequindre Road just north of the East Long Lake Road intersection (behind Taco Bell). The parcel is 2.389 acres in size and is currently undeveloped. Surrounding uses include single-family dwellings to the north and west. To the east and south are commercial businesses.

A shared drive exists for the subject parcel and Taco Bell. A landscaped berm, mature trees and 6' high concrete screen wall separate the adjacent residential home and Taco Bell.

Underground detention for the Taco Bell is located under the berm.

3.2 Existing Zoning & Future Land Use. Most of the site is zoned NN (Neighborhood Node). The northerly 40-feet of the property is zoned EP (Environmental Protection), to provide a buffer to the adjacent R-1C zoning (One Family Residential District). (See Exhibit A). Prior to 2006, the EP zoning district was commonly used to provide a buffer between two different zoning classifications.

According to the Master Plan of 2008 and as Amended in 2016, The Future Land Use for the subject parcel is Neighborhood Node.

3.3 **Proposed Use & Site Plan**. Under the proposed rezoning (*see Exhibit B*), the entire site would be zoned Neighborhood Node J. The existing screen wall and trees would remain adjacent to Taco Bell and new Landscape screening would be provided along the northerly and westerly property lines (residential zoned areas).

With the exception of the proposed guest parking, the area currently designated EP will remain an open space buffer, including the addition of landscape materials to screen the site from the northern adjacent properties.

The existing underground detention area on the subject property will be expanded to the west to provide the required storm water detention for this development.

The proposed development (*see Site Plan Sheets C-0.0*, *C-1.0*, *C-2.0*, *C-3.1*, *C-4.0*, *L-1.0*, *T-1.0*), Exhibit B, which shall be limited to seven (7) total buildings and twenty-five (25) total units. Each unit is an attached three-story single-family residential unit. Each unit will be 1,400 to 1,700 square feet and each will include an attached 2-car garage. The building materials shall consist of a mix of brick, asphalt shingles, plank siding, with variety of color palates and durable low-maintenance materials.

3.4 <u>Voluntary Conditions.</u> Under Section 405 of the Zoning Enabling Act (MCL 125.3405), the petitioner voluntarily offers uses and restrictions of the property as a condition to rezoning the land.

The following conditions are provided voluntarily as conditions of rezoning approval:

- Screen wall and existing mature trees adjacent to Taco Bell shall remain along the northern property line, north of the side entrance.
- 2. Development shall be limited to a maximum of 7-buildings with 25 total units.
- 3. Maximum Building Height shall not exceed 3 stories or 35'4" in height.
- 4. Minimum guaranteed Open Space shall be fifteen percent (15%).
- 5. Building Materials shall be a mix of brick, asphalt shingles, plank siding, with variety of color palates and durable low-maintenance materials.
- 6. Each Unit shall have an attached two (2) car garage on the first level of each unit.

 A minimum of ten (10) guest parking spaces shall provide additional parking for the entire development.

- 7. No exterior refuse containers shall be used. Individual waste and recycling containers shall be stored in each unit's garage and placed at the curb on collection days in accordance with the City's ordinances.
- 8. Minor modifications to the site plan shall be reviewed, and if appropriate, administratively approved by the Community Development Director. Any such minor changes are those that in the City's discretion would not adversely or substantially affect the conditions of the rezoning or the site plan.

ARTICLE 4 REZONING AND CONDITIONS SUBSEQUENT TO REZONING

- 4.1 <u>Rezoning</u>. The City hereby agrees to rezone a portion of the Zoning Parcel from EP to Neighborhood Node NN-J, making the entire parcel zoned NN-J. This rezoning allows the developer to construct attached single-family townhouse dwellings, as that term is identified in Article 5, Section 5.06, Neighborhood Nodes District, of the Troy Zoning Ordinance, and allows the uses permitted by right and identified as "Permitted Uses" under that section, which permits the use of a maximum of 25 attached residential units. The maximum building height permitted is three (3) stories with a maximum height of thirty-five feet, four inches (35'4") to the midpoint of the highest roof peak, as measured from the average of the front and rear walls of the building, as set forth in Article 3 above.
- 4.2 <u>Conditions Subsequent to Rezoning</u>. If any of the following events occur, then this conditional Rezoning Agreement shall be null and void and the zoning of the Development Parcel shall revert to the EP zoning classification. The Developer's failure to commence physical improvements, as that term is defined above in section 1.2, to the Development Parcel within 36 months of the effective date. Simply pulling permits to begin the construction phase is insufficient to satisfy this provision.

4.3 <u>Changes in Market Conditions.</u> The parties agree and acknowledge that the approved plans represent the current intent of the Developer to develop the Development Parcel, with the knowledge and market condition information possessed by the Developer as of the present date. The parties acknowledge that housing market conditions may change over time, which could cause the Developer to change its plans or timing with respect to the development of the Development Parcel. The parties further acknowledge that the buildings and improvements as shown on the approved plans may be constructed, if at all, at different dates in the future, and that the Developer may elect to develop such improvements in the order and at such times as it determines necessary and appropriate in its discretion, if at all. Site improvements reasonably necessary or reasonably related to any particular building, including without limitation road improvements, storm drainage facilities, sidewalks and landscaping, will be made at the time of construction of such particular building, as determined through the site plan process. Provided that the Developer is proceeding in good faith and with due diligence to develop the Development Parcel in light of existing economic conditions, and subject to acts of force majeure, shortage of available materials, supplies and labor including any pandemic or event for which Developer has not created, and is otherwise in compliance with this Agreement and City ordinances, the City will not unreasonably refuse to extend any time periods for completion for a reasonable lime to enable the Developer to complete the Development Parcel. The Developer shall provide City Staff with a written report of the status of the development of the Development Parcel on an annual basis commencing one year from the date of this Agreement until project development is completed. Time is of the essence to this Conditional Rezoning. The Site Plan shall be in effect for a period of three (3) years, during which time Developer shall obtain final site plan approval in accordance with Section 8.03 of Troy's Zoning

Ordinance.

4.4 <u>Force Majeure</u>. Notwithstanding anything to the contrary contained in Section 4.2 or 4.3 above, if any failure or inability of the Developer to meet the conditions set forth in Sections 4.2 or 4.3 is caused by delay beyond the reasonable control of the Developer, such as war, pandemic, civil insurrection, strike, inclement weather, inability to procure material or labor, and the like, then the Developer shall be given an extension in accordance with Troy's Zoning Ordinance.

ARTICLE 5 GENERAL PROVISIONS

5.1 Site Plan Approval. The City hereby approves the Developer's Preliminary Site Plan as attached as Exhibit B. Minor modifications to the site plan may be required during the course of final site plan review based on factors discovered during the course of civil or architectural drawing preparation or in the field during the construction of the improvements, or upon subsequent request of the Developer. For purposes of expediency, minor changes to the site plan that are necessary or appropriate shall be reviewed and, if reasonable, administratively approved by the city staff, provided that such changes comply with the Troy Zoning Ordinance and the intent of this agreement. A minor modification is defined as any change that does not significantly or substantively alter the site plan or the conditions set forth in this Agreement. The determination of whether a change is a minor modification is at the discretion of the City staff. Any minor modifications to the site plan must be approved in writing. If a modification is more than minor, then a revised plan shall be submitted to the Planning Commission for review and proposed recommendation to City Council. The Troy City Council shall have final approval authority over a revised site plan with more than minor modifications.

- 5.2 <u>City's Representations and Warranties.</u>
- A. <u>Authority.</u> The City has the authority to enter into this Conditional Rezoning Agreement under Section 16.04 of Article 16 of Troy' Zoning Ordinance and to perform and carry out all obligations, covenants and provisions hereof. The City's authority shall be evidenced by appropriate resolutions of the Troy City Council.
- B. <u>Transfer of Ownership</u>. The transfer of title of the Development Parcel to an entity in which the principals of the Developer have a significant ownership interest, if such transfer is made prior to substantial completion of the Improvements, shall not constitute an event of default under this Conditional Rezoning Agreement.
- C. <u>Compliance</u>. The Conditional Rezoning Agreement complies with the requirements of City Ordinances, including the Troy Zoning Ordinance.
- D. <u>Sole Authority.</u> The City Council is the sole and appropriate municipal body to enter into the Conditional Rezoning Agreement with the Developer and the Owner.
- E. <u>Plan Review</u>. The City will review within a reasonable time period not to exceed sixty days the plans and documents submitted for building permits, public utilities and signage, and all proposed amendments submitted by the Developer.
- F. <u>Uses</u>. The intended land uses for the Development Parcel are permitted uses under§ 39-5.06, Neighborhood Nodes District "NN-J" of the Troy Zoning Ordinance.
- G. <u>Validity of Uses</u>. In the event that the Troy Zoning Code is amended such that the uses provided for in this Conditional Rezoning Agreement for the Development Parcel are no longer permitted uses of right in a Neighborhood Node zone, NN-J the Improvements completed in accordance with this Conditional Rezoning Agreement shall be considered legally nonconforming and continuation of those uses shall be governed by Chapter 39, Article

- 14, Nonconforming Lots, Uses, and Structures, of the Troy Zoning Ordinance.
- H. <u>Restraints</u>. Neither the execution nor delivery of this Conditional Rezoning

 Agreement nor the consummation of the transaction contemplated hereby is in violation of any
 provision of any existing law or regulation, order or decree of any court or governmental entity,
 the City's Charter, or any agreement to which the City is a party or by which it is bound.
- I. <u>Disclosure</u>. No representation of warranty by the City, or any statement or certificate furnished to the Developer pursuant hereto or in connection with the transactions contemplated hereby, contains or will contain any untrue statement of a material fact or will omit to state any fact necessary to make the statements contained herein or therein not misleading.
- J. <u>Litigation</u>. The City has no notice of and there is no known pending or threatened litigation, administrative action, claim or demand before any court or any federal, state or municipal governmental department, commission, board, bureau, agency or instrumentality thereof which would affect the City or its principals from carrying out the covenants and promises made herein.
 - 5.3 <u>Developer's Representations and Warranties.</u>
- A. <u>Organization.</u> The Developer is duly organized and validly existing, in good standing under the laws of the State of Michigan, and has all requisite power and authority to own and operate its assets and properties, to carry on its business as now being conducted, and to enter into and perform the terms of the Conditional Rezoning Agreement.
- B. <u>Authorization</u>. The execution and delivery of this Conditional Rezoning

 Agreement and consummation of the transactions contemplated hereby have been duly

 authorized by the Developer and Owner, who has the authority to enter into a binding agreement
 - C. <u>Restraints.</u> Neither the execution nor delivery of this Conditional Rezoning

Agreement nor the consummation of the transaction contemplated hereby is in violation of any provision of any existing law or regulation, order or decree of any court or governmental entity, the Developer's organizational documents, or any agreement to which the Developer is a party or by which it is bound.

- D. <u>Disclosure.</u> No representation of warranty by the Developer, or any statement or certificate furnished to the City pursuant hereto or in connection with the transactions contemplated hereby, contains or will contain any untrue statement of a material fact or will omit to state any fact necessary to make the statements contained herein or therein misleading.
- E. <u>Litigation</u>. The Developer has no notice of and there is no known pending or threatened litigation, administrative action, claim or demand before any court or any federal, state or municipal governmental department, commission, board, bureau, agency or instrumentality thereof which would affect the Developer or its principals from carrying out the covenants and promises made herein.
- F. <u>Financial</u>. The Developer is financially able to develop the Development Parcel as depicted in the Preliminary Site Plan and as outlined in this Agreement.
- G. <u>Compliance with Laws</u>. The Developer shall comply with all laws and all City ordinances applicable to the construction, ownership, maintenance, operation and use of the Development Parcel.
- H. <u>Taxes and Assessments.</u> After the effective date of this Conditional Rezoning Agreement, the owner of the Development Parcel shall pay on or before the date by which penalties are assessed, all real estate taxes and special assessments levied against the Development Parcel.

ARTICLE 6 NOTICES

All notices, consents, approvals, requests and other communications, herein collectively called "Notices," required or permitted under this Conditional Rezoning Agreement shall be given in writing, signed by an authorized representative of the City or the Developer and mailed by certified or registered mail, return receipt requested or personally delivered, sent by overnight courier or sent by electronic transmission to a party as follows:

To City: Community Development Director

City of Troy

500 W Big Beaver Troy, Michigan 48084 Telephone: (248) 524-3364 SavidantB@troymi.gov

With a Copy To: City Attorney

City of Troy

500 W Big Beaver Troy, Michigan 48084 Telephone: (248) 524-3320 BluhmLG@troymi.gov

To Developer/ GFA Development Inc.
Owner: 985 Elmsford Drive

985 Elmsford Drive Troy, Michigan 48083

Telephone: (248) 840-2828

Garyabitheira@wideopenwest.com

With a copy to: Robert A. Jacobs, Esq.

Robert A. Jacobs, PLC 121 West Long Lake Road,

Suite 200

Bloomfield Hills, Michigan 48304

Jacobs@rjacobsplc.com

All such notices, certificates or other communications shall be deemed served upon the date of personal delivery, the day after delivery to a recognized overnight courier, the date of the transmission by any electronic means is verified or two days after mailing by register or certified mail. Any party may by written notice given under this Conditional Rezoning Agreement modify the designees or addresses to which subsequent notices, certificates or communications hereunder shall be sent.

ARTICLE 7 MISCELLANEOUS

- 7.1 Non-Liability of City, Officials, and Employees. No City official, officer, employee, board member, City Council member, elected or appointed official, attorney, consultant, advisor, agent and representative, shall be personally liable to the Developer for any default or breach by the City of any obligation under this Conditional Rezoning Agreement or in any manner arising out of the performance of this Conditional Rezoning Agreement by any party.
- 7.2 <u>Successors/Provisions Running With the Land</u>. This Conditional Rezoning Agreement shall be binding upon and inure to the benefit of the parties hereto and their respective successors, heirs, assigns and transferees. The provisions of Sections 3.1 and 3.2 and 4.1 and 4.2 of this Conditional Rezoning Agreement shall be deemed benefits and burdens which shall run with the Development Parcel.
- 7.3 Recording. This Conditional Rezoning Agreement in its entirety shall constitute deed restrictions on the Development Parcel. The Developer shall record this Agreement with the Oakland County Register of Deeds at its own expense within 30 days of its approval by City Council, and it shall provide the Troy City Clerk with a certified copy of the agreement as recorded.

- 7.4 <u>Complete Agreement.</u> This Conditional Rezoning Agreement constitutes the entire agreement between the parties with respect to the subject of this Conditional Rezoning Agreement and it may not be amended or its terms varied except in writing and signed by the required parties, except for the Owner pursuant to Section 2.3 above.
- 7.5 <u>Conflicts</u>. In the event of conflict between the provisions of this Conditional Rezoning Agreement and the provisions of the Troy Zoning Ordinance, the provisions of this Conditional Rezoning Agreement shall prevail.
- 7.6 Default Remedies of Developer. The City shall not be in default in any term or condition of this Agreement unless and until the Developer has provided the City with written notice that the City has failed to comply with an obligation under this Agreement, and the City has failed to cure such failure within thirty (30) days of the written notice, unless the nature of the noncompliance is such that it cannot be cured with due diligence within such period, in which case the City has failed to commence the cure within such period and thereafter diligently pursued the cure. In the event of a default, the Developer's sole remedy at law or in equity shall be the right to seek specific performance as to the issuance of approvals, consents, or the issuance of building permits required by the City pursuant to this Conditional Rezoning Agreement.
- 7.7 <u>Default Remedies of City</u>. The Developer shall not be in default in any term or condition of this Agreement unless and until the City has provided the Developer with written notice that the Developer has failed to comply with an obligation under this Agreement, and the Developer has failed to cure such failure within thirty (30) days of the written notice, unless the nature of the noncompliance is such that it cannot be cured with due diligence within such period, in which case the Developer has failed to commence the cure

within such period and thereafter diligently pursued the cure. In the event of a default, the City's sole remedy at law or in equity shall be the right to seek specific performance of the obligations of the Developer pursuant to this Conditional Rezoning Agreement.

- 7.8 <u>Third-Party Benefits</u>. No term or provision of this Conditional Rezoning Agreement is intended to be, or shall be, for the benefit of any person not a party to the Agreement, and no such person shall have any right or cause of action hereunder.
- 7.9 <u>Severability.</u> The invalidity of any article, section, subsection, clause or provision of this Agreement shall not affect the validity of the remaining articles, sections, subsections, clauses, or provisions hereof, which shall remain valid and enforceable to the fullest extent permitted by law.
- 7.10 Waiver of Breach. A party to this Agreement does not waive any default, condition, promise, obligation, or requirement applicable to any other party hereunder, unless such waiver is in writing, signed by an authorized representative of that party, and expressly stated to constitute such waiver. Such waiver shall only apply to the extent given and shall not be deemed or construed to waive any such or other default, condition, promise, obligation, or requirement in any past or future instance. A failure of a party to insist upon strict performance of any covenant, agreement, term or condition of this Conditional Rezoning Agreement or to the exercise of any right or remedy in the event of a default shall not constitute a waiver of any such default in such covenant, agreement, term or condition.
- 7.11 Governing Law. This Conditional Rezoning Agreement shall be governed by, construed and enforced in accordance with the laws of the State of Michigan. The Developer agrees, consents and submits to the personal jurisdiction of any competent court of jurisdiction in Oakland County, Michigan, for any action brought against it arising out of this Conditional

Rezoning Agreement. The Developer also agrees that it will not commence any action against the City because of any matter whatsoever arising out of, or relating to, the validity, construction, interpretation and enforcement of this Agreement in any courts other than those within Oakland County, Michigan. Nothing in this Agreement shall be construed to limit or prohibit the Developer to petition or submit land use or zoning requests to the City after the Effective Date as permitted under this Agreement.

7.12 <u>Joint Drafting</u>. This Conditional Rezoning Agreement, except for the voluntarily offered conditions in section 3.4 above, has been negotiated by the parties and each party has joined in and contributed to its drafting. Accordingly, there shall be no presumption favoring or burdening any of the parties based upon draftsmanship.

		DEVELOPMENT INC. chigan corporation
	By: Its:	Gary Abitheira President
STATE OF MICHIGAN))ss COUNTY OF OAKLAND) The foregoing CONDITIONAL REZO	NING 2	AGREEMENT was acknowledged before
me this day of, Development Inc., on behalf of the Company.		
		, Notary Public, Notary Public County, Michigan ting in Oakland County Commission Expires:

CITY OF TROY, MICHIGAN a Michigan municipality

	By: Its:	Ethan Baker Mayor
STATE OF MICHIGAN)	113.	Wayor
COUNTY OF OAKLAND)		
Subscribed and sworn before me the Baker, Mayor of City of Troy on behalf of the	day	of, 202_, by Ethan Proy, a Michigan municipality.
		, Notary Public County, Michigan ting in Oakland County Commission Expires:
		OF TROY, MICHIGAN chigan municipality
	By: Its:	M. Aileen Dickson Clerk
STATE OF MICHIGAN))ss COUNTY OF OAKLAND)		
Subscribed and sworn before me the Aileen Dickson, Clerk of City of Troy on beh		y of, 202_, by M. City of Troy, a Michigan municipality.
J:\9123\026\00301522.DOCX		, Notary Public, County, Michigan ting in Oakland County Commission Expires:

When recorded return to:

City of Troy Clerk's Office 500 West Big Beaver Road Troy, MI 48084 Attn: M.Aileen Dickson, City Clerk

EXHIBIT A DEVELOPMENT PARCEL

(Per City of Troy Assessor)

PARCEL ID 20-12-476-070

Land in the City of Troy, Oakland County, Michigan, described as follows:

Part of Lots 10, 11 and 12 of JENNINGS SUBDIVISION, as recorded in Liber 59, Page 8, Oakland County Records, beginning at point distant North 00 degrees 08 minutes 52 West 60 feet and North 89 degrees 32 minutes 26 seconds West 60 feet and North 00 degrees 08 minutes 52 West 493.11 feet from the Southeast section corner; thence North 88 degrees 10 minutes 33 seconds West 170 feet; thence South 75 degrees 18 minutes 21 seconds West 70.21 feet; thence South 00 degrees 08 minutes 52 seconds East 159.98 feet; thence North 88 degrees 11 minutes 10 seconds West 371.57 feet; thence North 00 degrees 08 minutes 43 seconds West 240 feet; thence South 88 degrees 10 minutes 33 seconds East 609.56 feet; thence South 00 degrees 08 minutes 52 seconds East 59.99 feet to beginning.

EXHIBIT B

SITE PLAN

The original Site Plan and related plans referenced in Section 2.4 of the Conditional Rezoning Agreement are maintained in the records of the City of Troy, Michigan and are identified as follows:

- C.0.0 Cover Sheet
- C.1.0 Topographic Survey, prepared by PEA Group Engineers
- C.3.0 Preliminary Grading Plan, prepared by PEA Group Engineers
- C.4.0 Preliminary Utility Plan, prepared by PEA Group Engineers
- L.1.0 Preliminary Landscape Plan, prepared by PEA Group Engineers
- T.1.0 Preliminary Reservation Plan

QUINDRE | PEA JOB NO. 2016-368 | PRELIMINARY SITE PLANS

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U @

GFA 18 MILE & DEQUINDRE

PART OF THE SOUTHEAST 1/4 OF SECTION 12, T.02N., R. 11E., CITY OF TROY, OAKLAND COUNTY, MICHIGAN


PERMIT / APPROVAL SUMMARY

DATE SUBMITTED DATE APPROVED PERMIT / APPROVAL

LEGAL DESCRIPTION
(Per City of Troy Assessor)

PARCEL ID 20-12-476-070 Land in the City of Troy, Oakland County, Michigan, described as follows

Part of Lots 10, 11 and 12 of JENNINGS SUBDIVISION, as recorded in Liber 59, Page 8 Oakland County Records, beginning at point distant North 00 degrees 08 minutes 52 Wes 60 feet and North 89 degrees 32 minutes 26 seconds West 60 feet and North 00 degrees 08 minutes 52 West 493.11 feet from the Southeast section corner; thence North 88 degrees 10 minutes 33 seconds West 170 feet; thence South 75 degrees 18 minutes 2 seconds West 70.21 feet; thence South 00 degrees 08 minutes 52 seconds East 159.98 feet; thence North 88 degrees 11 minutes 10 seconds West 371.57 feet; thence North 00 degrees 08 minutes 43 seconds West 240 feet; thence South 88 degrees 10 minutes 33 seconds East 609.56 feet; thence South 00 degrees 08 minutes 52 seconds East 59.98 feet to beginning.

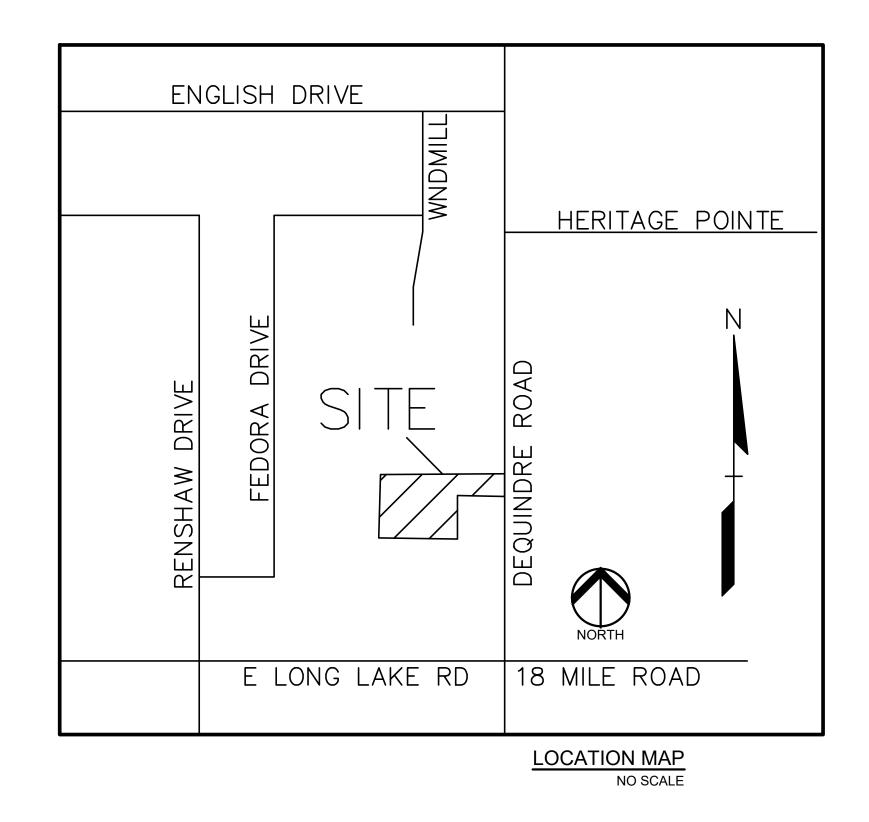

INDEX OF DRAWINGS NUMBER TITLE C-0.0 COVER SHEET C-1.0 TOPOGRAPHIC SURVEY C-2.0 PRELIMINARY SITE PLAN C-3.0 PRELIMINARY GRADING PLAN C-4.0 PRELIMINARY UTILITY PLAN L-1.0 PRELIMINARY LANDSCAPE PLAN T-1.0 PRELIMINARY PRESERVATION PLAN

DESIGN TEAM

OWNER/APPLICANT/DEVELOPER CIVIL ENGINEER

GFA DEVELOPMENT, INC.
986 ELMSFORD DRIVE
TROY, MI 48083
CONTACT: GARY ABITHEIRA
PHONE: 248.840.2828
EMAIL: GFAHOMES@GMAIL.COM


PEA GROUP
2430 ROCHESTER COURT, STE. 100
TROY, MI 48083-1872
CONTACT: JOHN B. THOMPSON, PE
PHONE: 844.813.2949
EMAIL: JTHOMPSON@PEAGROUP.COM


ARCHITECT


MGA ARCHITECTS/DESIGNERS
MOISEEV/GORDON ASSOCIATES, INC.
4351 DELEMERE COURT
ROYAL OAK, MI 48073
CONTACT: ANDREW J. MOISEEV, RA
PHONE: 248.549.4500 EXT. 221
EMAIL: ANDREWM@MGA-ARCHITECTS.NET

LANDSCAPE ARCHITECT

45 W. GRAND RIVER AVE., STE. 501 DETROIT, MI 48226 CONTACT: KIMBERLY DIETZEL, RLA PHONE: 844.813.2949 EMAIL: KDIETZEL@PEAGROUP.COM

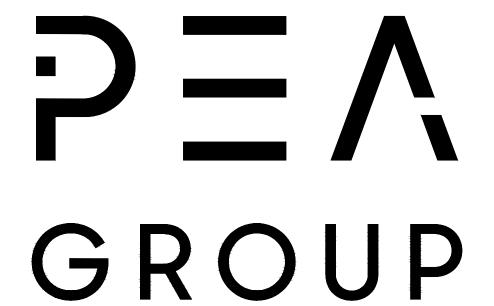

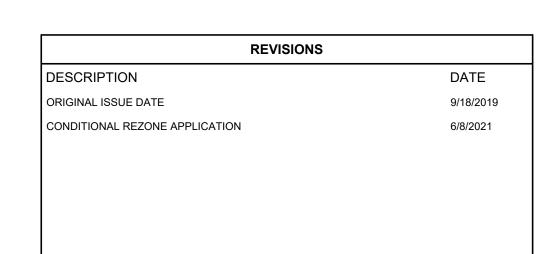

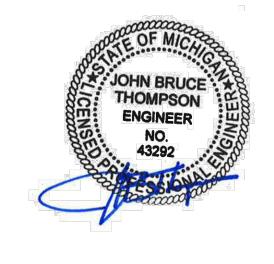

LEGAL DESCRIPTION (Per City of Troy Assessor)

PARCEL ID 20-12-476-070 Land in the City of Troy, Oakland County, Michigan, described as follows:

Part of Lots 10, 11 and 12 of JENNINGS SUBDIVISION, as recorded in Liber 59, Page 8, Oakland County Records, beginning at point distant North 00 degrees 08 minutes 52 West 60 feet and North 89 degrees 32 minutes 26 seconds West 60 feet and North 00 degrees 08 minutes 52 West 493.11 feet from the Southeast section corner; thence North 88 degrees 10 minutes 33 seconds West 170 feet; thence South 75 degrees 18 minutes 21 seconds West 70.21 feet; thence South 00 degrees 08 minutes 52 seconds East 159.98 feet; thence North 88 degrees 11 minutes 10 seconds West 371.57 feet; thence North 00 degrees 08 minutes 43 seconds West 240 feet; thence South 88 degrees 10 minutes 33 seconds East 609.56 feet; thence South 00 degrees 08 minutes 52 seconds East 59.99 feet to beginning.

BM #301 PUNCH MARK ON THE NORTHWEST BOLT OF A LIGHT POLE LOCATED AT THE NORTH SIDE OF THE ARBY'S PARKING LOT, APPROX. 26'± SOUTH OF THE SOUTH PROPERTY LINE. ELEV. - 645.29

BM #300
PUNCH MARK ON ARROW OF A HYDRANT LOCATED ON THE

WEST SIDE OF DEQUINDRE ROAD, APPROX. 45'± NORTHEAST


BENCHMARKS

ELEV. - 645.78

(GPS DERIVED - NAVD88)

OF THE NORTHEAST PROPERTY CORNER.

FLOODPLAIN NOTE: BY GRAPHICAL PLOTTING, SITE IS WITHIN ZONE 'X', AREA DETERMINED TO BE OUTSIDE OF THE 0.2% ANNUAL CHANCE FLOODPLAIN PER FLOOD INSURANCE RATE MAP NUMBER 26125C0552F, DATED SEPTEMBER 29, 2006.

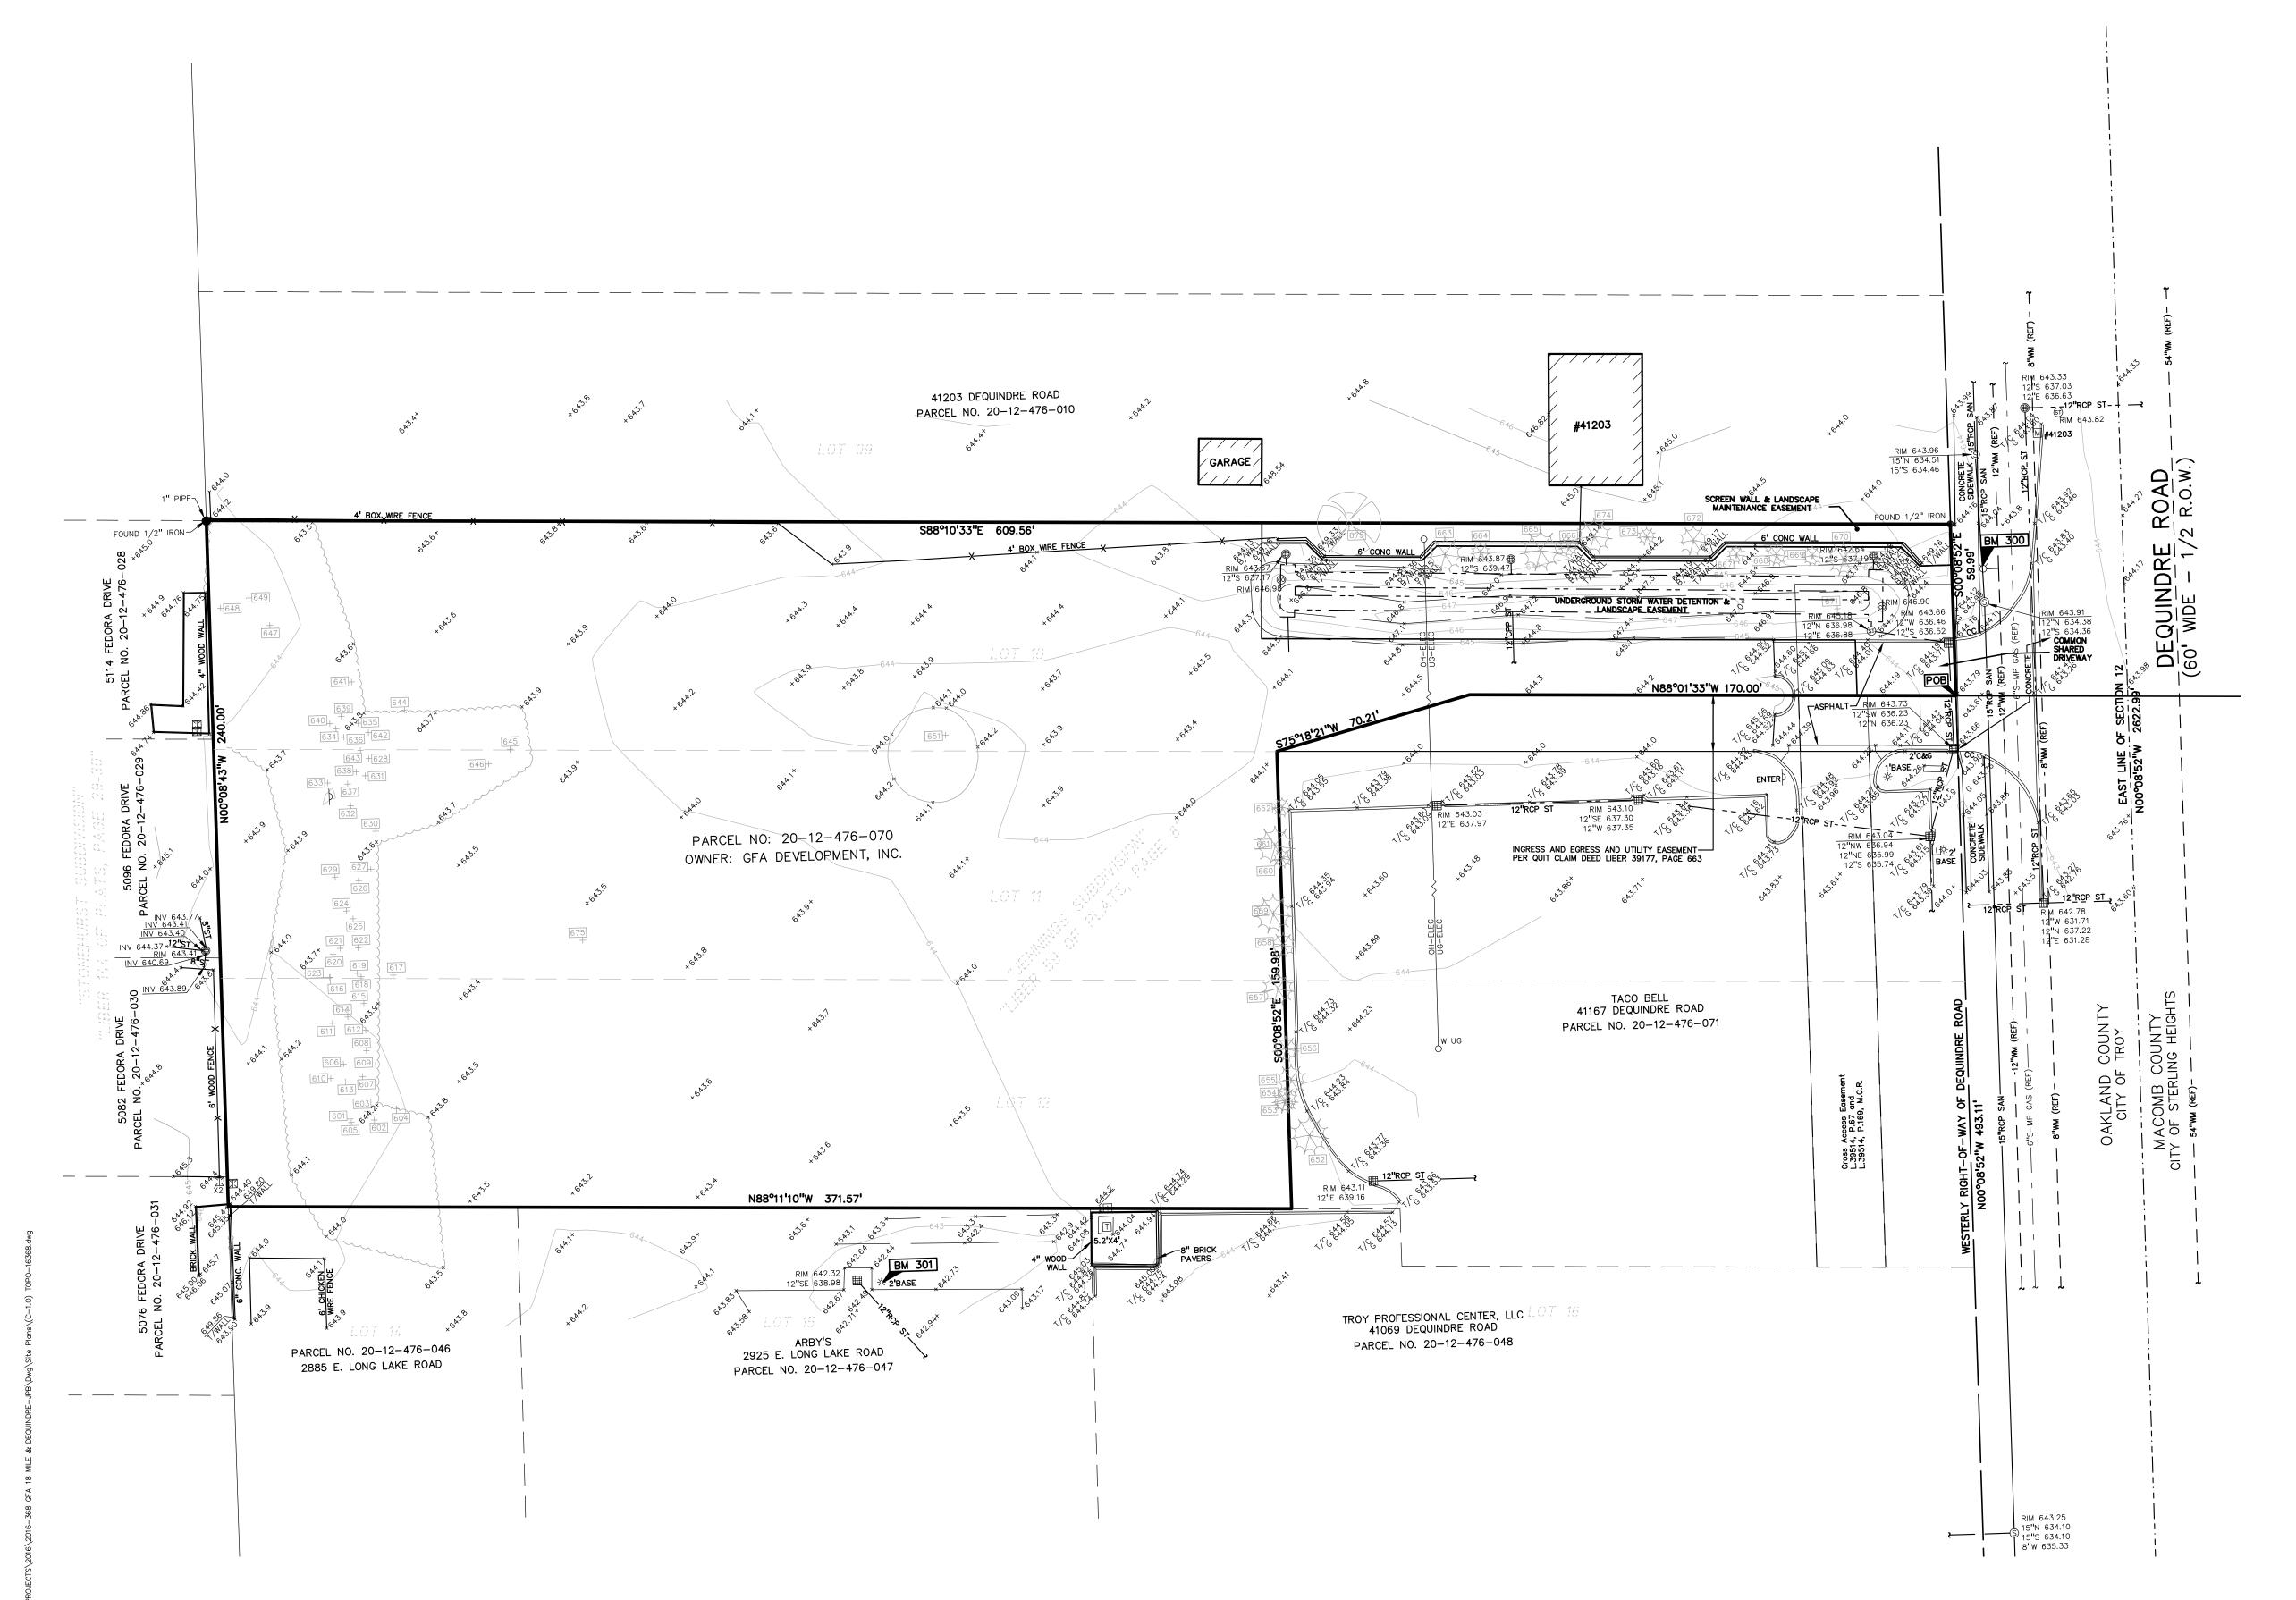

LEGEND

IRON FOUND MAIL FOUND Ø NAIL & CAP SET

 BRASS PLUG SET MONUMENT FOUND MONUMENT SET

SEC. CORNER FOUND R RECORDED M MEASURED C CALCULATED

-OH-ELEC-W-O- ELEC., PHONE OR CABLE TV O.H. LINE, POLE & GUY WIRE -UG-CATV-TV- UNDERGROUND CABLE TV, CATV PEDESTAL -⊠-UG-PHONE-①--- TELEPHONE U.G. CABLE, PEDESTAL & MANHOLE -UG-ELEC-E-E- ELECTRIC U.G. CABLE, MANHOLE, METER & HANDHOLE — _ GAS MAIN, VALVE & GAS LINE MARKER WATERMAIN, HYD., GATE VALVE, TAPPING SLEEVE & VALVE

SANITARY SEWER, CLEANOUT & MANHOLE — - - STORM SEWER, CLEANOUT & MANHOLE SQUARE, ROUND & BEEHIVE CATCH BASIN, YARD DRAIN POST INDICATOR VALVE WATER VALVE BOX/HYDRANT VALVE BOX, SERVICE SHUTOFF M T I MAILBOX, TRANSFORMER, IRRIGATION CONTROL VALVE UNIDENTIFIED STRUCTURE SPOT ELEVATION

CONTOUR LINE -X-X-X- FENCE ☆ STREET LIGHT SIGN CONC. →

∕— ASPH. →

GRAVEL SHOULDER __GRAVEL ____


REFERENCE DRAWINGS


GAS - CONSUMERS ENERGY QUARTER SECTION MAP 02-61-12-4, DATED 10-21-05 CITY OF TROY UTILITY GIS MAP
TACO BELL GRADING AND UTILITY PLAN, DESIGN, INC. PROJECT NO. 61055, DWG. NAME 055UT, DATED 11-07-07
TACO BELL SITE PLAN, DESIGN, INC. PROJECT NO. 61055, DWG. NAME 055SP, DATED 06-27-07

t: 844.813.2949

www.peagroup.com



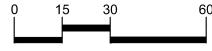

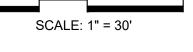



CAUTION!! THE LOCATIONS AND ELEVATIONS OF EXISTING UNDERGROUND UTILITIES AS SHOWN ON THIS DRAWING ARE ONLY APPROXIMATE. NO GUARANTEE IS EITHER EXPRESSED OR IMPLIED AS TO THE COMPLETENESS OR ACCURACY THEREOF. THE CONTRACTOR SHALL BE EXCLUSIVELY RESPONSIBLE FOR DETERMINING THE EXACT UTILITY LOCATIONS AND ELEVATIONS PRIOR TO THE START OF CONSTRUCTION.

CLIENT GFA
DEVELOPMENT,
INC.
986 ELMSFORD DR.
TROY, MI 48083

PROJECT TITLE


GFA 18 MILE & DEQUINDRE
PART OF THE SE 1/4 OF SECTION 12, T.02N., R.11E. TROY, OAKLAND COUNTY, MI


REVISIONS	
ONDITIONAL REZONE APP.	6/8/21

ORIGINAL ISSUE DATE: **SEPTEMBER 18, 2019**

TOPOGRAPHIC SURVEY

PEA JOB NO.	2016-368
P.M.	JBT
DN.	TMK
DES.	TMK
DRAWING NUMBER:	

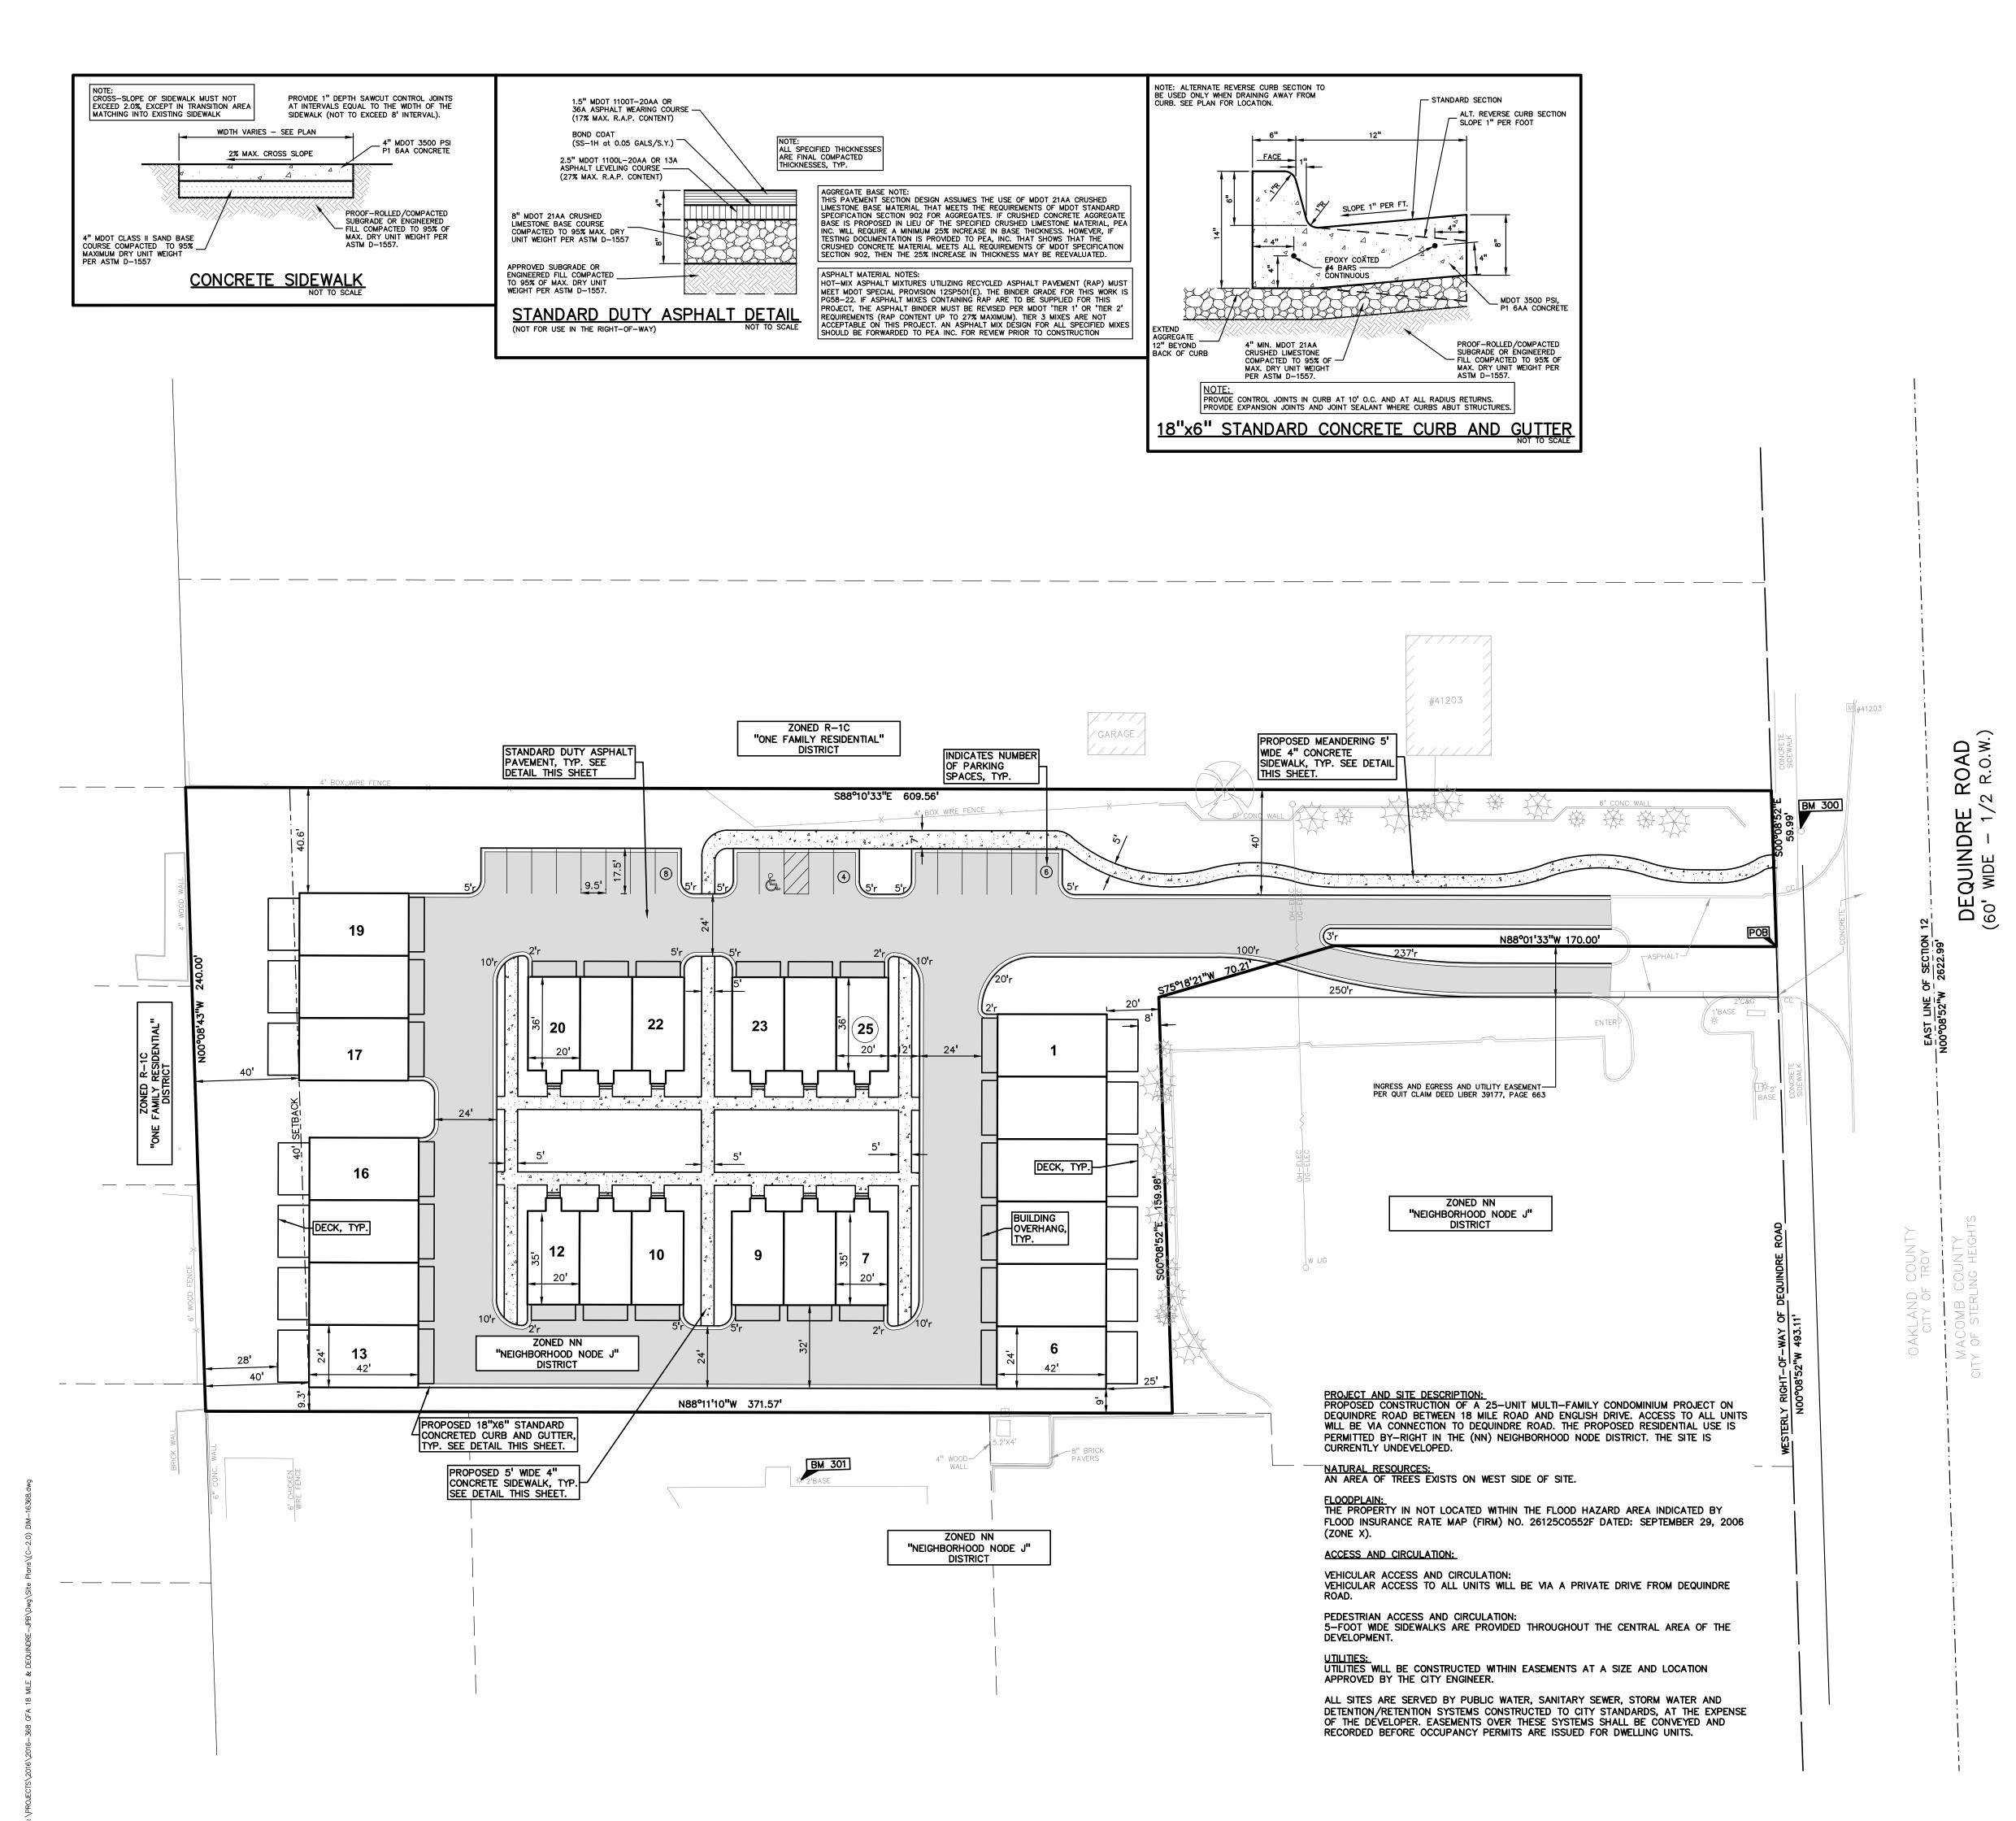

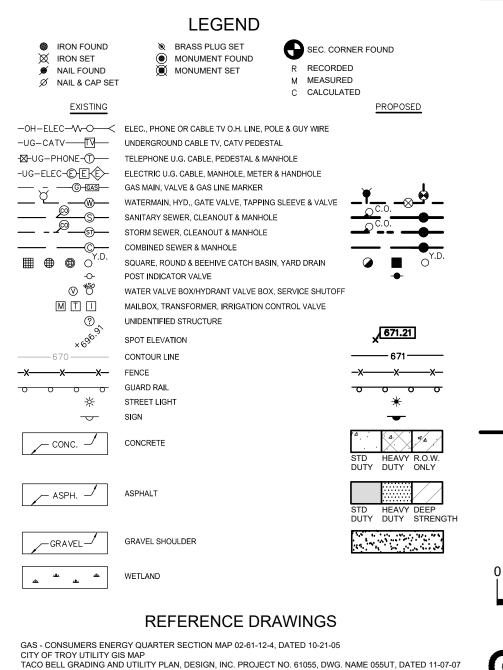

TACO BELL SITE PLAN, DESIGN, INC. PROJECT NO. 61055, DWG. NAME 055SP, DATED 06-27-07

t: 844.813.2949 www.peagroup.com

SCALE: 1" = 30'

CAUTION!! THE LOCATIONS AND ELEVATIONS OF EXISTING UNDERGROUND UTILITIES AS SHOWN ON THIS DRAWING ARE ONLY APPROXIMATE. NO GUARANTEE IS EITHER EXPRESSED OR IMPLIED AS TO THE COMPLETENESS OR ACCURACY THEREOF. THE CONTRACTOR SHALL BE EXCLUSIVELY RESPONSIBLE FOR DETERMINING THE EXACT UTILITY LOCATIONS AND ELEVATIONS PRIOR TO THE START OF CONSTRUCTION.

ALL WORK IN THE DEQUINDRE ROAD RIGHT-OF-WAY IS UNDER THE JURISDICTION OF THE ROAD COMMISSION FOR OAKLAND COUNTY AND REQUIRES A PERMIT.

20' PROVIDED

SITE DATA TABLE:

SITE AREA: 2.389 ACRES (104,056.4021 SQ.FT.) NET AND GROSS

EX. ZONING: (NN) NODE J AND EP

PR. ZONING: (NN), NODE J; SITE TYPE NN:B, STREET TYPE:A

PROPOSED USE: TOWNHOMES

BUILDING INFORMATION:

MAXIMUM ALLOWABLE BUILDING HEIGHT = 72 FEET (6 STORIES)

PROPOSED BUILDING HEIGHT = 3 STORY

SETBACK REQUIREMENTS:

NN: B ZONING DISTRICT:
FRONT SETBACK (EAST): 0 FEET REQUIRED

SIDE SETBACK (NORTH): 0 FEET REQUIRED 40' PROVIDED SIDE SETBACK (SOUTH): 0 FEET REQUIRED 9' PROVIDED

REAR SETBACK (WEST): 40 FEET REQUIRED 40' PROVIDED

PARKING CALCULATIONS:
MULTIFAMILY = 2 SPACES PER UNIT REQUIRED
TOTAL REQUIRED PARKING = 2 X 25 GARAGE = 50 SPACES
TOTAL GUEST PARKING = 18 SPACES

TOTAL PROVIDED PARKING = 68 SPACES (INCLUDES 2-CAR GARAGES)

OPEN SPACE:
MINIMUM OPEN SPACE REQUIRED = 15% + 15% LANDSCAPE
PROVIDED OPEN SPACE = 15%
PROVIDED LANDSCAPE > 15%

SITE SOILS INFORMATION:
ACCORDING TO THE USDA NATURAL RESOURCES CONSERVATION SERVICE WEB SOIL SURVEY FOR OAKLAND COUNTY, THE SITE CONSISTS OF THE FOLLOWING SOIL TYPES: 52A - SELFRIDGE LOAMY SAND, 0 TO 3 PERCENT SLOPES

986 ELMSFORD DR. TROY, MI 48083

PROJECT TITLE

DEVELOPMENT,

GFA 18 MILE &


DEQUINDRE PART OF THE SE 1/4 OF SECTION 12, ROY, OAKLAND COUNTY, MI


REVISIONS CONDITIONAL REZONE APP.

ORIGINAL ISSUE DATE: **SEPTEMBER 18, 2019**

DRAWING TITLE **PRELIMINARY** SITE PLAN

2016-368 PEA JOB NO. TMK DES. TMK DRAWING NUMBER:

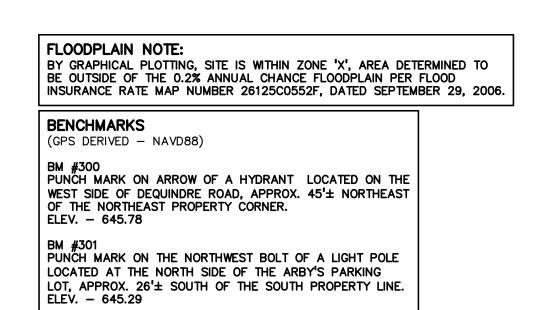

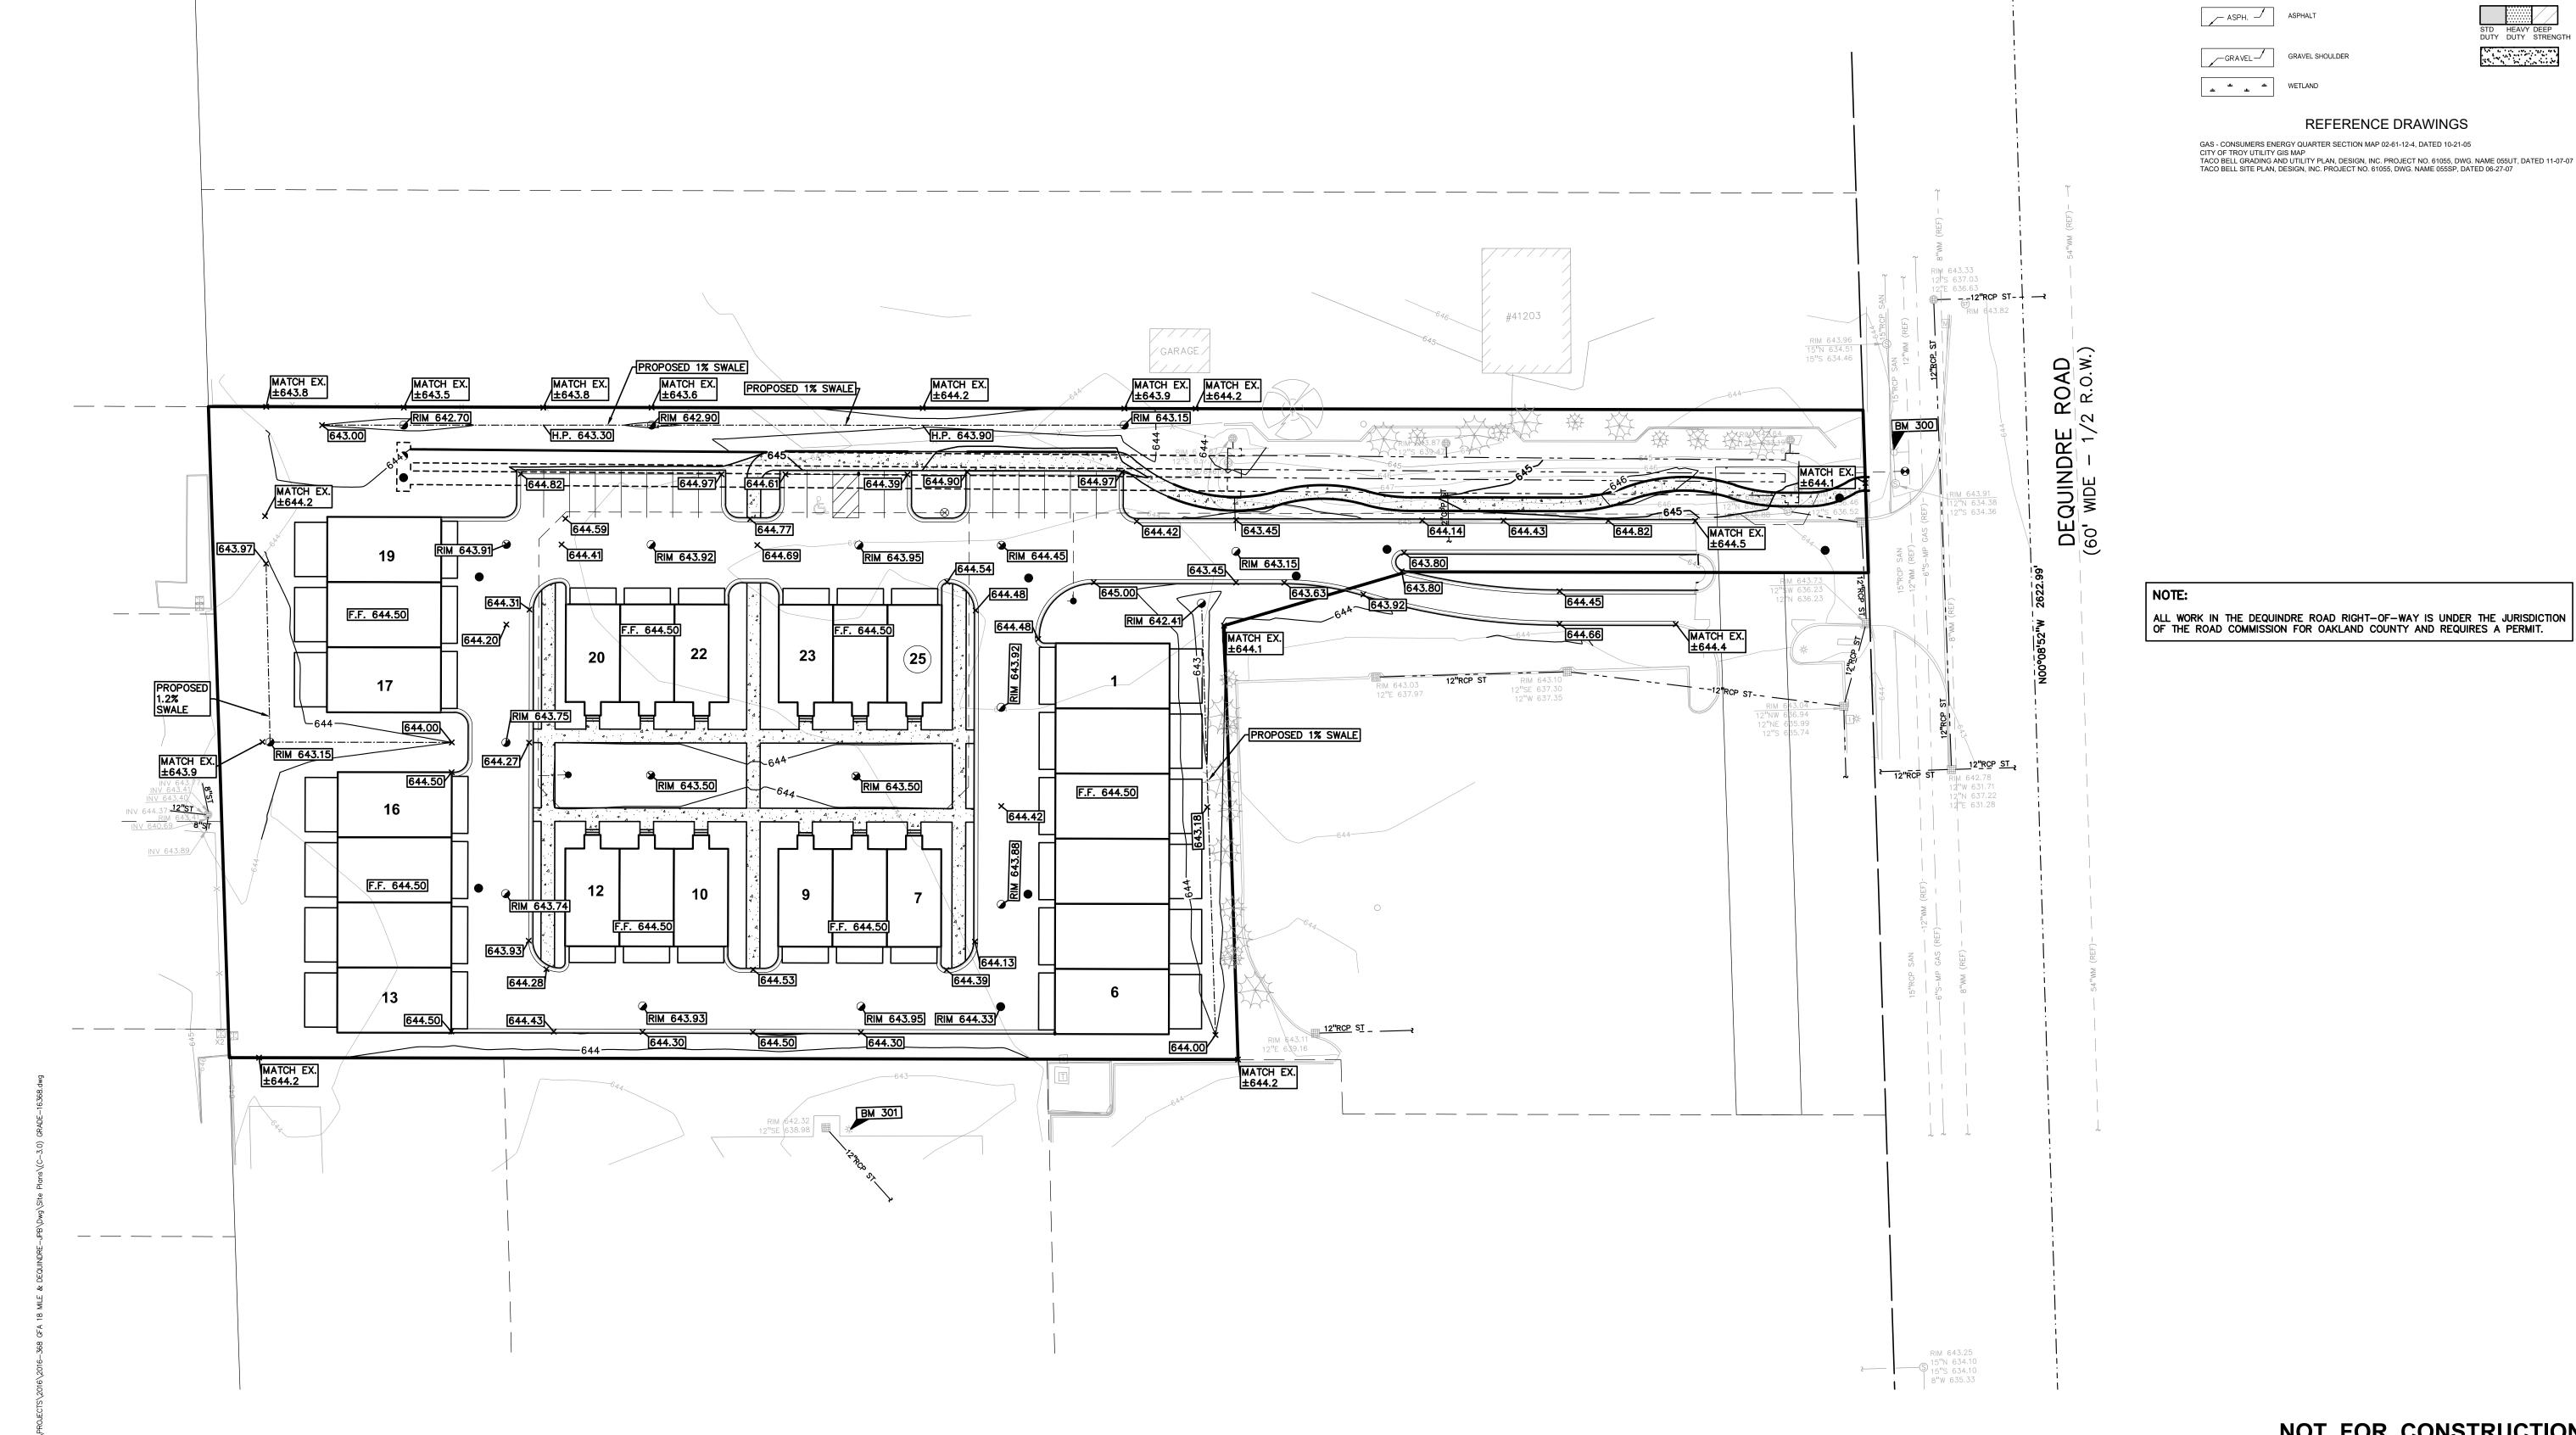

LEGEND

-OH-ELEC-W-O- ELEC., PHONE OR CABLE TV O.H. LINE, POLE & GUY WIRE

IRON FOUND RASS PLUG SET MONUMENT FOUND MAIL FOUND MONUMENT SET Ø NAIL & CAP SET

-UG-CATV-TV- UNDERGROUND CABLE TV, CATV PEDESTAL

SEC. CORNER FOUND R RECORDED M MEASURED C CALCULATED

671.21

671

-x----x---x-

_

GROUP www.peagroup.com

-UG-ELEC-E-E- ELECTRIC U.G. CABLE, MANHOLE, METER & HANDHOLE — _ GAS MAIN, VALVE & GAS LINE MARKER WATERMAIN, HYD., GATE VALVE, TAPPING SLEEVE & VALVE SANITARY SEWER, CLEANOUT & MANHOLE — — STORM SEWER, CLEANOUT & MANHOLE SQUARE, ROUND & BEEHIVE CATCH BASIN, YARD DRAIN POST INDICATOR VALVE WATER VALVE BOX/HYDRANT VALVE BOX, SERVICE SHUTOFF M T I MAILBOX, TRANSFORMER, IRRIGATION CONTROL VALVE UNIDENTIFIED STRUCTURE SPOT ELEVATION -----670 ------ CONTOUR LINE -X-X-X- FENCE

0 0 0 0 ☆ STREET LIGHT ── SIGN CONC. → ∕— ASPH. →

GRAVEL SHOULDER __GRAVEL ____

REFERENCE DRAWINGS

GAS - CONSUMERS ENERGY QUARTER SECTION MAP 02-61-12-4, DATED 10-21-05 CITY OF TROY UTILITY GIS MAP
TACO BELL GRADING AND UTILITY PLAN, DESIGN, INC. PROJECT NO. 61055, DWG. NAME 055UT, DATED 11-07-07
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SCALE: 1" = 30'

t: 844.813.2949



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GFA
DEVELOPMENT,
INC. 986 ELMSFORD DR. TROY, MI 48083

CLIENT

PROJECT TITLE

GFA 18 MILE & DEQUINDRE
PART OF THE SE 1/4 OF SECTION 12, T.02N., R.11E. TROY, OAKLAND COUNTY, MI

REVISIONS CONDITIONAL REZONE APP.

ORIGINAL ISSUE DATE: SEPTEMBER 18, 2019

DRAWING TITLE **PRELIMINARY GRADING PLAN**

2016-368 PEA JOB NO. TMK DES. DRAWING NUMBER:

C-3.0

GFA 18 MILE & DEQUINDRE Project: TROY, MI Location:

9/16/2019 Date: 2016-368 Project No:

25 YEAR STORM DETENTION DESIGN (OAKLAND COUNTY DESIGN METHOD)

Contributing Area (A): C.F.S. (= 0.2 CFS/AC.) 0.48 Allowable Discharge (Qa) Coefficient of Runoff (Cr): 0.56

Calculation of Required Discharge/Acre

0.36 Qo = ((Qa)/(A)(Cr): 125.25 T = -25 + ((8062.5/Qo))0.5:

Storage Volume Required:

Vs = (12900(T)/(T+25)) - 40Qo(T): 8964.29

11997.8 Vt = (Vs)(A)(Cr):

PIPE STORAGE: 612 ft. SIZE= 60 in. C.F./FT.= 19.625 c.f./ft. VOLUME= 12,010.50 c.f.

CALCULATIONS OF EXISTING U.G. DETENTION: PER TACO BALL AS-BUILT DRAWINGS DATED 11-09-07.

Contributing Area (A): 1.35 0.27 C.F.S. (=0.2 CFS/AC.) Allowable Discharge (Qa) 0.59 Coefficient of Runoff (Cr): Calculation of Required Discharge/Acre

EXISTING UNDERGROUND 25 YEAR STORM DETENTION DESIGN

Qo = ((Qa)/(A)(Cr):0.34 129 T = -25 + ((8062.5/Qo))0.5: Storage Volume Required:

Vs = (12900(T)/(T+25)) - 40Qo(T): 9057

Vt = (Vs)(A)(Cr): 7214

> PROVIDED STORAGE IN UNDERGROUND DETENTION DETENTION SYSTEM PROVIDED: 60" SLCPP PIPE

STORAGE PER LINEAR FOOT OF PIPE: 19.63 C.F NUMBER OF ROWS PROVIDED: 2 LENGTH OF ROWS PROVIDED: 200 L.F.

TOTAL STORAGE VOLUME PROVIDED (2 X 200 X 19.63): 7852 C.F

NOTE:

ALL WORK IN THE DEQUINDRE ROAD RIGHT-OF-WAY IS UNDER THE JURISDICTION OF THE ROAD COMMISSION FOR OAKLAND COUNTY AND REQUIRES A PERMIT.

SEC. CORNER FOUND MONUMENT FOUND R RECORDED MAIL FOUND MONUMENT SET M MEASURED Ø NAIL & CAP SET C CALCULATED -OH-ELEC-VV-O- ELEC., PHONE OR CABLE TV O.H. LINE, POLE & GUY WIRE -UG-CATV-TV- UNDERGROUND CABLE TV, CATV PEDESTAL -⊠-UG-PHONE-Ū--- TELEPHONE U.G. CABLE, PEDESTAL & MANHOLE -UG-ELEC-E-E-E-ELECTRIC U.G. CABLE, MANHOLE, METER & HANDHOLE GAS MAIN, VALVE & GAS LINE MARKER WATERMAIN, HYD., GATE VALVE, TAPPING SLEEVE & VALVE GOLD SANITARY SEWER, CLEANOUT & MANHOLE — – — ST)— STORM SEWER, CLEANOUT & MANHOLE COMBINED SEWER & MANHOLE SQUARE, ROUND & BEEHIVE CATCH BASIN, YARD DRAIN POST INDICATOR VALVE WATER VALVE BOX/HYDRANT VALVE BOX, SERVICE SHUTOFF M T I MAILBOX, TRANSFORMER, IRRIGATION CONTROL VALVE UNIDENTIFIED STRUCTURE 671.21 SPOT ELEVATION 671 -----670 ------ CONTOUR LINE **-X---X-** FENCE -x----x---x-OOOOOO GUARD RAIL 0 0 0 0 ☆ STREET LIGHT -∪ SIGN _ CONC. → __ ASPH. _/ | ASPHALT

LEGEND

RASS PLUG SET

IRON FOUND

REFERENCE DRAWINGS

GAS - CONSUMERS ENERGY QUARTER SECTION MAP 02-61-12-4, DATED 10-21-05

GRAVEL SHOULDER

GRAVEL

CITY OF TROY UTILITY GIS MAP
TACO BELL GRADING AND UTILITY PLAN, DESIGN, INC. PROJECT NO. 61055, DWG. NAME 055UT, DATED 11-07-07
TACO BELL SITE PLAN, DESIGN, INC. PROJECT NO. 61055, DWG. NAME 055SP, DATED 06-27-07



t: 844.813.2949

www.peagroup.com

CAUTION!! THE LOCATIONS AND ELEVATIONS OF EXISTING UNDERGROUND UTILITIES AS SHOWN ON THIS DRAWING ARE ONLY APPROXIMATE. NO GUARANTEE IS EITHER EXPRESSED OR IMPLIED AS TO THE COMPLETENESS OR ACCURACY THEREOF. THE CONTRACTOR SHALL BE EXCLUSIVELY RESPONSIBLE FOR DETERMINING THE EXACT UTILITY LOCATIONS AND ELEVATIONS PRIOR TO THE START OF CONSTRUCTION.

CLIENT GFA DEVELOPMENT, INC. 986 ELMSFORD DR. TROY, MI 48083

PROJECT TITLE

GFA 18 MILE & DEQUINDRE
PART OF THE SE 1/4 OF SECTION 12, T.02N., R.11E.
TROY, OAKLAND COUNTY, MI

REVISIONS CONDITIONAL REZONE APP.


ORIGINAL ISSUE DATE: SEPTEMBER 18, 2019

PRELIMINARY UTILITY PLAN

2016-368 PEA JOB NO. TMK DES.

NOT FOR CONSTRUCTION

DRAWING NUMBER:

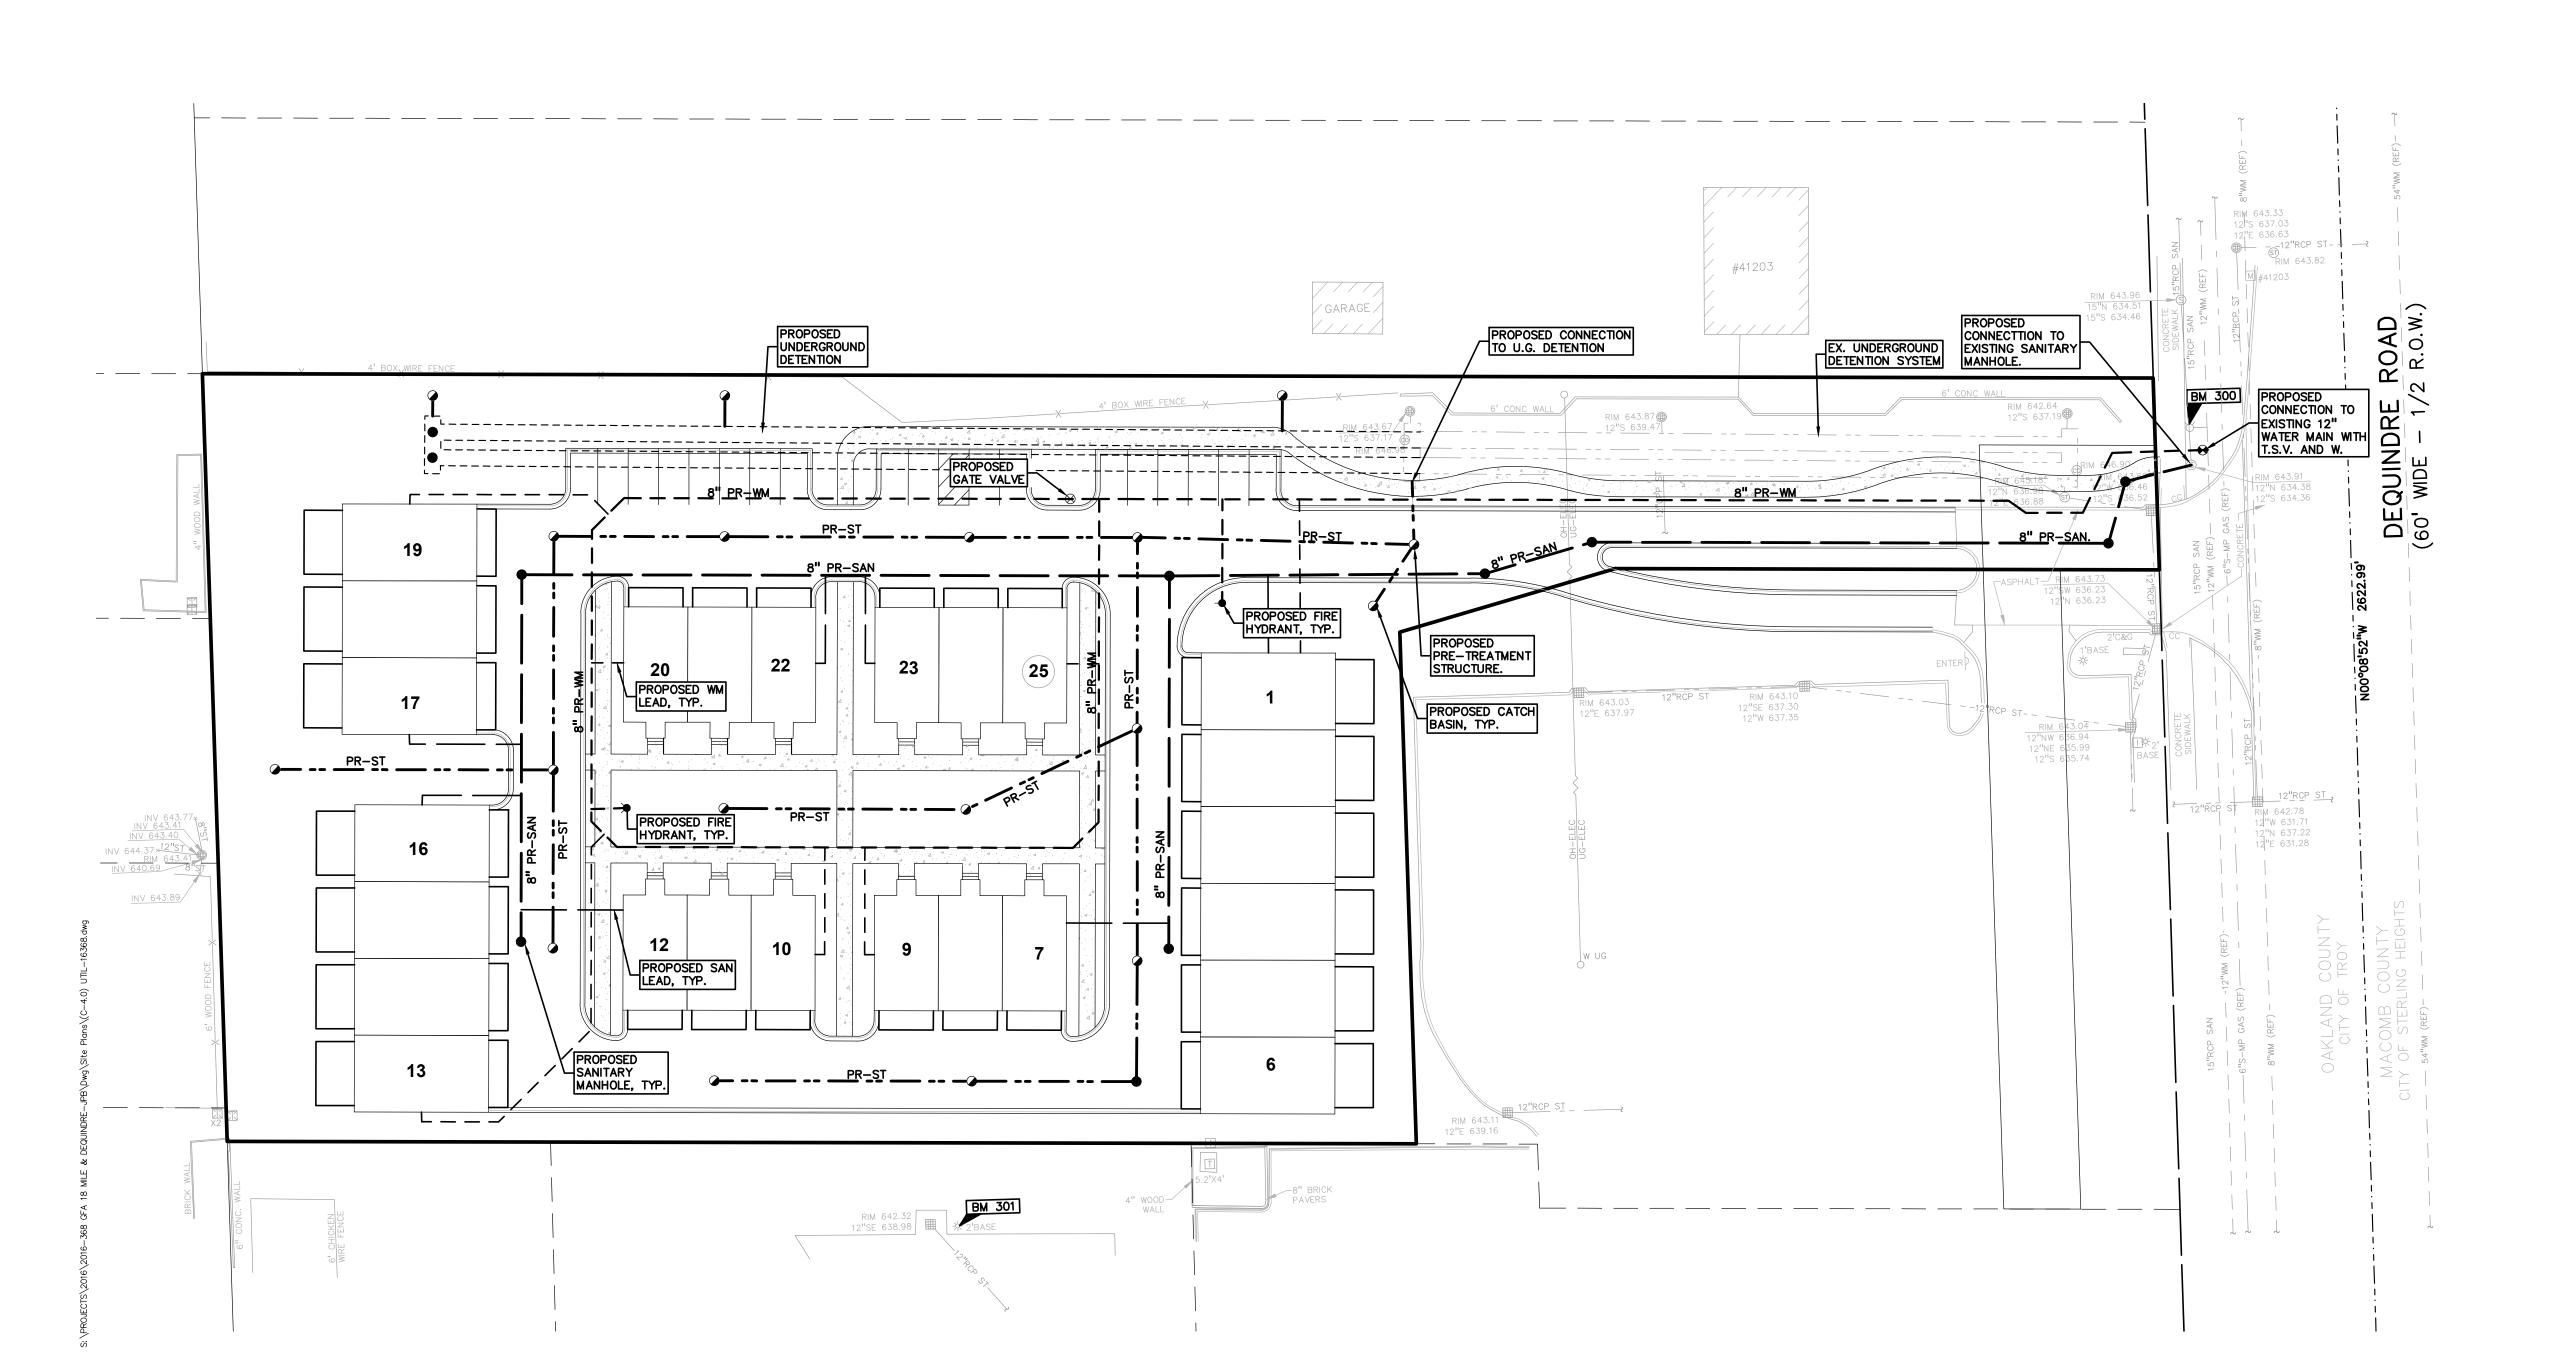

					1
DECIDUO	US TREE PL	ANT LIST:			
QUANTITY	KEY SYMBOL	COMMON NAME	SCIENTIFIC NAME	SIZE	SPEC
3	AS2.5	Sugar Maple	Acer saccharum 'Green Mountain'	2.5" Cal.	B&B
2	QR2.5	Red Oak	Quercus rubra	2.5" Cal.	В&В
5	TOTAL DEC.				
EVERGRE	EN TREE PL	ANT LIST:			
QUANTITY	KEY SYMBOL	COMMON NAME	SCIENTIFIC NAME	SIZE	SPEC
7	AC8	Concolor Fir	Abies concolor	8' Ht.	B&B
7	PA8	Norway Spruce	Picea abies	8' Ht.	B&B
8	PC8	Columnar Norway Spruce	Picea abies 'Cupressina'	8' Ht.	B&B
14	PG8	Black Hills Spruce	Picea glauca 'Densata'	8' Ht.	B&B
5	PO8	Serbian Spruce	Picea omorika	8' Ht.	B&B
6	PB8	Lacebark Pine	Pinus bungeana	8' Ht.	B&B
11	PN8	Austrian Pine	Pinus nigra	8' Ht.	B&B
7	PS8	Eastern White pine	Pinus strobus	8' Ht.	B&B
_		Para Para Para Para Para Para Para Para			

65 TOTAL EVG.

TREE PROTECTION DETAIL


TREES IS 6' FENCE ALONG

PROPERTY BOUNDARY.



GROUP

www.peagroup.com

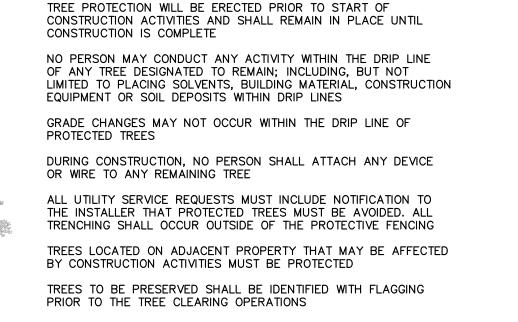

PROVIDE FENCE AROUND CRITICAL ROOT ZONE OF TREE FENCE SHALL BE PLACED IN A CIRCLE WITH A MINIMUM RADIUS OF 1' PER 1" DIAMETER OF THE TREE MEASURED AT 4.5' ABOVE GROUND

COORDINATE TREE

PLANTING LOCATIONS MIN

5' FROM ALL UTILITIES.

4'HIGH PROTECTIVE FENCING WITH STEEL POSTS - 10' O.C. - EXISTING SOIL

PLANT SO THAT TOP OF ROOT BALL IS FLUSH TO GRADE OR 1-2" HIGHER IF IN POORLY DRAINED SOILS STAKE JUST BELOW BRANCHES WITH 2"-3" STAKING/GUYING LOCATION WIDE NYLON OR PLASTIC STRAPS. CONNECT -FROM TREE TO STAKE AND ALLOW FOR FLEXIBILITY. REMOVE AFTER (1) ONE YEAR. (DO NOT USE WIRE & HOSE) THREE 2"X2" HARDWOOD STAKES OR STEEL T-POSTS DRIVEN A MIN. OF 18" DEEP FIRMLY INTO SUBGRADE PRIOR TO BACKFILLING SHREDDED HARDWOOD BARK MULCH TO DRIPLINE. 3" DEEP AND LEAVE 3" CIRCLE OF BARE SOIL AROUND TREE TRUNK, DO NOT PLACE MULCH IN CONTACT WITH TREE TRUNK. FORM SAUCER WITH 4" HIGH CONTINUOUS RIM -FINISH GRADE SPECIFIED PLANTING MIX, WATER & TAMP TO - REMOVE AIR POCKETS, AMEND SOIL PER SITE CONDITIONS & TREE REQUIREMENTS EXPOSE ROOT FLARE OF TREE. CONTRACTOR MAY HAVE TO REMOVE EXCESS SOIL FROM - TOP OF ROOTBALL. REMOVE ALL BURLAP FROM TOP 1 OF ROOTBALL. DISCARD ALL NON-BIODEGRADABLE MATERIAL OFF SITE PLACE ROOTBALL ON UNEXCAVATED OR TAMPED SOIL

EVERGREEN TREE PLANTING DETAIL

RESTORE DISTURBED AREA

WITH LAWN, TYP. CONTRACTOR TO FIELD VERIFY LIMITS.

ALTERNATIVE TO 39 EVG

PROPERTY BOUNDARY.

TREES IS 6' FENCE ALONG

IRRIGATED SEE

LAWN TYP.

PLANT SO THAT TOP OF ROOT BALL IS FLUSH TO GRADE OR 1-2" HIGHER IF IN POORLY DRAINED SOILS SECURE TREE WRAP WITH BIODEGRADABLE MATERIAL AT TOP & BOTTOM, REMOVE AFTER FIRST WINTER DO NOT PRUNE TERMINAL LEADER PRUNE ONLY DEAD, BROKEN BRANCHES AS DIRECTED BY LANDSCAPE ARCHITECT STAKE JUST BELOW BRANCHES WITH 2"-3" WIDE NYLON OR PLASTIC STRAPS. CONNECT FROM TREE TO STAKE AND ALLOW FOR FLEXIBILITY. REMOVE AFTER (1) ONE YEAR. (DO NOT USE WIRE & HOSE) (3) THREE 2"X2" HARDWOOD STAKES DRIVEN A MIN. OF 18" DEEP FIRMLY INTO SUBGRADE PRIOR TO BACKFILLING SHREDDED HARDWOOD BARK MULCH TO DRIPLINE. 3" DEEP AND LEAVE 3" CIRCLE OF BARE SOIL AROUND TREE TRUNK. DO NOT STAKING/GUYING PLACE MULCH IN CONTACT WITH TREE TRUNK. FORM SAUCER WITH 4" HIGH CONTINUOUS RIM SPECIFIED PLANTING MIX. WATER & TAMP TO - REMOVE AIR POCKETS, AMEND SOIL PER SITE CONDITIONS & TREE REQUIREMENTS -FINISH GRADE EXPOSE ROOT FLARE OF TREE. CONTRACTOR MAY HAVE TO REMOVE EXCESS SOIL FROM - TOP OF ROOTBALL. REMOVE ALL BURLAP FROM TOP 1 OF ROOTBALL. DISCARD ALL NON-BIODEĞRADABLE MATERIAL OFF SITE _ PLACE ROOTBALL ON UNEXCAVATED OR TAMPED SOIL DECIDUOUS TREE PLANTING DETAIL

SCALE: 1'' = 3'-0''

PROVIDE TREE PROTECTION

FENCE AROUND EXISTING TREES TO REMAIN, TYP.

REMAIN TYP.

= EXISTING TREES

W/ TREE PROTECTION FENCING

SCALE: 1" = 30' = IRRIGATED SEED LAWN

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LANDSCAPE CALCULATIONS:
PER CITY OF TROY ZONING ORDINANCE; NN

GREENBELT TREES REQUIRED: 1 DEC TREE / 30 LF OF STREET FRONTAGE. 60' OF RIGHT OF WAY/ 30 = 2 DEC TREES REQUIRED.

PROVIDED: 2 PROPOSED TREES

REQUIRED: 1 TREE / 8 PARKING SPACES. 18 SPACES / 8 = 3 TREES

= EVERGREEN SCREENING TREES

= PARKING LOT TREES

= GREENBELT TREES

PROVIDED: 3 TREES

ROAD R.o.w.

QUINDRE - 1/

25' CLEAR VISION TRIANGLE TYP.

REPLACEMENT TREES
REQUIRED: REPLACE 50% OF REMOVED DBH OF WOODLAND TREES, AND 100% OF REMOVED LANDMARK TREES DBH. 1 WOODLAND AND 1 LANDMARK TREES REMOVED, SEE CALCULATIONS THIS SHEET. 384" DBH CREDIT SAVED, O REPLACEMENT TREES REQUIRED. PROVIDED: 27 EXISTING TREES SAVED, NO REPLACEMENT REQUIRED.

SCREENING TREES REQUIRED: 1 LARGE EVG TREE / 10 LF (USE ALT 2: MULTIFAMILY ADJACENT TO SINGLE

FAMILY RESIDENTIAL -NORTH & WEST). - NORTH: 370 LF/10 = 37 LG EVG (6' FENCE ALONG REMAINING PROPERTY BOUNDARY.)

- WEST: 240 LF /10 = 24 LG EVG

PROVIDED: 65 TREES (NORTH- 39 LG EVG; WEST- 26 LG EVG)

GFA DEVELOPMENT, 986 ELMSFORD DR.

GENERAL PLANTING NOTES:

PLAN PRIOR TO PRICING THE WORK.

THE PLANT MATERIAL.

- . LANDSCAPE CONTRACTOR SHALL VISIT SITE, INSPECT EXISTING SITE CONDITIONS AND REVIEW PROPOSED PLANTING AND RELATED WORK. IN CASE OF DISCREPANCY BETWEEN PLAN AND PLANT LIST, PLAN SHALL GOVERN QUANTITIES. CONTACT LANDSCAPE ARCHITECT WITH ANY CONCERNS.
- 2. CONTRACTOR SHALL VERIFY LOCATIONS OF ALL ON SITE UTILITIES PRIOR TO BEGINNING CONSTRUCTION ON HIS/HER PHASE OF WORK. ELECTRIC, GAS, TELEPHONE, CABLE TELEVISION MAY BE LOCATED BY CALLING MISS DIG 1-800-482-7171. ANY DAMAGE OF INTERRUPTION OF SERVICES SHALL BE THE RESPONSIBILITY OF CONTRACTOR. CONTRACTOR SHALL COORDINATE ALL RELATED ACTIVITIES WITH OTHER TRADES ON THE JOB AND SHALL REPORT ANY UNACCEPTABLE JOB CONDITIONS TO OWNER'S REPRESENTATIVE PRIOR TO COMMENCING.
- . ALL PLANT MATERIAL TO BE PREMIUM GRADE NURSERY STOCK AND SHALL SATISFY AMERICAN ASSOCIATION OF NURSERYMEN STANDARD FOR NURSERY STOCK. ALL LANDSCAPE MATERIAL SHALL BE NORTHERN GROWN, NO. 1. GRADE.
- 4. CONTRACTOR IS RESPONSIBLE FOR VERIFYING ALL QUANTITIES SHOWN ON LANDSCAPE
- 5. THE OWNER'S REPRESENTATIVE RESERVES THE RIGHT TO REJECT ANY PLANT MATERIAL NOT MEETING SPECIFICATIONS.
- 6. ALL SINGLE STEM SHADE TREES TO HAVE STRAIGHT TRUNKS AND SYMMETRICAL
- '. ALL SINGLE TRUNK SHADE TREES TO HAVE A CENTRAL LEADER; TREES WITH FORKED
- OR IRREGULAR TRUNKS WILL NOT BE ACCEPTED.
- 8. ALL MULTI STEM TREES SHALL BE HEAVILY BRANCHED AND HAVE SYMMETRICAL CROWNS. ONE SIDED TREES OR THOSE WITH THIN OR OPEN CROWNS SHALL NOT BE
- 9. ALL EVERGREEN TREES SHALL BE HEAVILY BRANCHED AND FULL TO THE GROUND,
- SYMMETRICAL IN SHAPE AND NOT SHEARED FOR THE LAST FIVE GROWING SEASONS. 10.ALL TREES TO HAVE CLAY OR CLAY LOAM BALLS, TREES WITH SAND BALLS WILL BE
- 11.NO MACHINERY IS TO BE USED WITHIN THE DRIP LINE OF EXISTING TREES; HAND
- GRADE ALL LAWN AREAS WITHIN THE DRIP LINE OF EXISTING TREES. 12.ALL TREE LOCATIONS SHALL BE STAKED BY LANDSCAPE CONTRACTOR AND ARE SUBJECT TO THE APPROVAL OF THE LANDSCAPE ARCHITECT PRIOR TO INSTALLATION OF
- 13.IT IS MANDATORY THAT POSITIVE DRAINAGE IS PROVIDED AWAY FROM ALL BUILDINGS. 14.ALL PLANTING BEDS SHALL RECEIVE 3" SHREDDED HARDWOOD BARK MULCH WITH PRE EMERGENT, SEE SPECIFICATIONS. SHREDDED PALETTE AND DYED MULCH WILL NOT BE ACCEPTED.
- 15.ALL LANDSCAPED AREAS SHALL RECEIVE 3" COMPACTED TOPSOIL.
- 16.SEE SPECIFICATIONS FOR ADDITIONAL COMMENTS, REQUIREMENTS, PLANTING PROCEDURES AND WARRANTY STANDARDS.
- 17.FOR NON-LAWN SEED MIX AREAS, AS NOTED ON PLAN, BRUSH MOW ONCE SEASONALLY FOR INVASIVE SPECIES CONTROL.

PROJECT TITLE

TROY, OAKLAND COUNTY, MI

GFA 18 MILE & **DEQUINDRE** PART OF THE SE 1/4 OF SECTION 12,

REVISIONS CONDITIONAL REZONE APP.

ORIGINAL ISSUE DATE:

SEPTEMBER 18, 2019 DRAWING TITLE

PRELIMINARY LANDSCAPE

2016-368 PEA JOB NO. TMK DES. TMK DRAWING NUMBER:

NOT FOR CONSTRUCTION

PLAN

TAG	CODE	DBH	COMMON NAME	LATIN NAME	COND	NOTE	CLASS	SAVE / REMOVE	ON-SITE	REPLACE
601	EE	25	Siberian Elm	Ulmus pumila	Very Poor		INVASIVE	R	¥	-
602	NS	6	Norway Spruce	Picea Abies	Very Poor		WOODLAND	R	¥	-
603	EE	14	Siberian Elm	Ulmus pumila	Fair	4	INVASIVE	R	¥	-
604	CC	6	Choke Cherry	Prunus virginia	Poor		WOODLAND	R	¥	-
605	EE	6	Siberian Elm	Ulmus pumila	Good		INVASIVE	R	¥	-
606	EE	22	Siberian Elm	Ulmus pumila	Good		INVASIVE	R	¥	-
607	EE	7	Siberian Elm	Ulmus pumila	Very Poor		INVASIVE	R	¥	-
608	EE	22	Siberian Elm	Ulmus pumila	Very Poor		INVASIVE	R	¥	-
609	₽E	25	Siberian Elm	Ulmus pumila	Good		INVASIVE	R	¥	-
610	EE	6	Siberian Elm	Ulmus pumila	Very Poor		INVASIVE	R	¥	_
611	EE	1 3	Siberian Elm	Ulmus pumila	Poor		INVASIVE	R	¥	-
612	EE	14	Siberian Elm	Ulmus pumila	Fair		INVASIVE	R	¥	-
613	EE	17	Siberian Elm	Ulmus pumila	Fair		INVASIVE	R	¥	-
614	EE	13	Siberian Elm	Ulmus pumila	Poor		INVASIVE	R	¥	-
615	EE	19	Siberian Elm	Ulmus pumila	Fair		INVASIVE	R	¥	-
616	EE	8	Siberian Elm	Ulmus pumila	Poor		INVASIVE	R	¥	-
617	EE	2 4	Siberian Elm	Ulmus pumila	Poor		INVASIVE	R	¥	-
618	₽E	14	Siberian Elm	Ulmus pumila	Very Poor		INVASIVE	R	¥	_
619	EE	12	Siberian Elm	Ulmus pumila	Fair		INVASIVE	R	¥	-
620	₽E	13	Siberian Elm	Ulmus pumila	Poor		INVASIVE	R	¥	-
621	EE	18	Siberian Elm	Ulmus pumila	Fair		INVASIVE	R	¥	-
622	EE	8	Siberian Elm	Ulmus pumila	Poor		INVASIVE	R	¥	-
623	EE	8	Siberian Elm	Ulmus pumila	Fair		INVASIVE	R	¥	-
624	EE	9	Siberian Elm	Ulmus pumila	Very Poor		INVASIVE	R	¥	-
625	EE	20	Siberian Elm	Ulmus pumila	Fair		INVASIVE	R	¥	-
626	EE	9	Siberian Elm	Ulmus pumila	Poor		INVASIVE	R	¥	-
627	EE	11	Siberian Elm	Ulmus pumila	Very Poor		INVASIVE	R	¥	-
628	EE	8	Siberian Elm	Ulmus pumila	Very Poor		INVASIVE	R	¥	-
629	EE	20	Siberian Elm	Ulmus pumila	Fair		INVASIVE	R	¥	-
630	EE	13	Siberian Elm	Ulmus pumila	Very Poor		INVASIVE	R	¥	-
631	EE	6	Siberian Elm	Ulmus pumila	Very Poor		INVASIVE	R	¥	-
632	EE	19	Siberian Elm	Ulmus pumila	Fair		INVASIVE	R	¥	-
633	MW	8	White Mulberry	Morus alba	Fair		INVASIVE	R	¥	-
634	EE	12	Siberian Elm	Ulmus pumila	Fair		INVASIVE	R	¥	-
635	EE	14	Siberian Elm	Ulmus pumila	Fair		INVASIVE	R	¥	-
636	EE	8	Siberian Elm	Ulmus pumila	Poor		INVASIVE	R	¥	-
637	EE	20	Siberian Elm	Ulmus pumila	Poor		INVASIVE	R	¥	-

TAG	CODE	DBH	COMMON NAME	LATIN NAME	COND	NOTE	CLASS	SAVE / REMOVE	ON-SITE	REPLACE
638	EE	9	Siberian Elm	Ulmus pumila	Fair		INVASIVE	R	¥	-
639	EE	22	Siberian Elm	Ulmus pumila	Fair		INVASIVE	R	¥	-
640	MW	7	White Mulberry	Morus alba	Poor		INVASIVE	R	¥	-
641	E	12	American Elm	Ulmus americana	Fair		INVASIVE	R	¥	-
642	EE	8	Siberian Elm	Ulmus pumila	Very Poor		INVASIVE	R	¥	-
643	EE	22	Siberian Elm	Ulmus pumila	Poor		INVASIVE	R	¥	-
644	₽₩	7	Black Walnut	Juglans nigra	Poor		WOODLAND	R	¥	-
645	CA	11	Crab Apple	Malus caronaria	Very Poor		WOODLAND	R	¥	-
646	EE	20	Siberian Elm	Ulmus pumila	Poor		INVASIVE	R	¥	-
647	E	10	American Elm	Ulmus americana	Good		INVASIVE	R	¥	-
648	EE	16	Siberian Elm	Ulmus pumila	Good		INVASIVE	R	¥	-
649	EE	7	Siberian Elm	Ulmus pumila	Fair		INVASIVE	R	¥	-
650	ВХ	20	Box elder	Acer negundo	Very Poor		INVASIVE	S	Υ	-
651	EE	13	Siberian Elm	Ulmus pumila	Fair	1	INVASIVE	R	¥	-
652	DF	13	Douglas Fir	Pseudotsuga menziesii	Good		WOODLAND	S	Υ	-
653	BS	6	Blue Spruce	Picea pungens	Good		WOODLAND	S	Υ	-
654	NS	8	Norway Spruce	Picea Abies	Good		WOODLAND	S	Y	-
655	NS	10	Norway Spruce	Picea Abies	Good		WOODLAND	S	Υ	-
656	BS	7	Blue Spruce	Picea pungens	Poor		WOODLAND	S	Y	-
657	NS	10	Norway Spruce	Picea Abies	Good		WOODLAND	S	Υ	-
658	BS	7	Blue Spruce	Picea pungens	Good		WOODLAND	S	Y	-
659	NS	13	Norway Spruce	Picea Abies	Fair		WOODLAND	S	Υ	-
660	NS	6	Norway Spruce	Picea Abies	Good		WOODLAND	S	Y	-
661	NS	14	Norway Spruce	Picea Abies	Good		WOODLAND	S	Υ	-
662	BS	6	Blue Spruce	Picea pungens	Good		WOODLAND	S	Y	-
663	DF	13	Douglas Fir	Pseudotsuga menziesii	Good		WOODLAND	S	Y	-
664	BS	7	Blue Spruce	Picea pungens	Good		WOODLAND	S	Y	-
665	DF	15	Douglas Fir	Pseudotsuga menziesii	Good		WOODLAND	S	Υ	-
666	BS	6	Blue Spruce	Picea pungens	Good		WOODLAND	S	Y	-
667	BS	6	Blue Spruce	Picea pungens	Fair		WOODLAND	S	Υ	-
668	DF	8	Douglas Fir	Pseudotsuga menziesii	Good		WOODLAND	S	Υ	-
669	BS	7	Blue Spruce	Picea pungens	Good		WOODLAND	S	Υ	-
670	NS	12	Norway Spruce	Picea Abies	Good		WOODLAND	S	Υ	-
671	FC	6	Flowering Cherry	Prunus spp.	Good		WOODLAND	R	¥	REPLACE
672	DF	11	Douglas Fir	Pseudotsuga menziesii	Good		WOODLAND	S	Υ	-
673	BS	7	Blue Spruce	Picea pungens	Good		WOODLAND	S	Υ	-
674	NS	12	Norway Spruce	Picea Abies	Good		WOODLAND	S	Υ	-
675	RB	22	River Birch	Betula nigra	Fair		LANDMARK	R	¥	REPLACE




WOODLAND TRE	ES REMOVED:	1	(REPLA	CE AT 50% (OF REMOVED DBH)
6''	DBH x 0.5 =		3''	REPLACE	MENT
WOODLAND TRE	ES SAVED:	21	(CREDI	T OF 2X DBI	H)
197 [DBH x 2 =		394''	CREDIT	
-	3 -	394	=	-391	
	ა -	39 4		-331	
" <u>" DBH</u>	REQUIRED FOR				<u>IT</u>
LANDMARK TREE	REQUIRED FOR		LAND RE	PLACEMEN	_
	REQUIRED FOR		LAND RE	PLACEMEN	OF REMOVED DBH)
LANDMARK TREE	REQUIRED FOR		LAND RE	PLACEMEN	OF REMOVED DBH)
LANDMARK TREE	REQUIRED FOR ES ES REMOVED: DBH x 1 =		(REPLA	CE AT 100%	OF REMOVED DBH)
LANDMARK TREE LANDMARK TREE 22" LANDMARK TREE	REQUIRED FOR ES ES REMOVED: DBH x 1 =	1 1	(REPLA	CE AT 100%	OF REMOVED DBH)







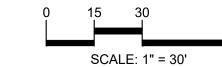



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GFA
DEVELOPMENT,
INC.
986 ELMSFORD DR.
TROY, MI 48083

PROJECT TITLE

GFA 18 MILE & DEQUINDRE

PART OF THE SE 1/4 OF SECTION 12, T.02N., R.11E.
TROY, OAKLAND COUNTY, MI

REVISIONS	
CONDITIONAL REZONE APP.	6/8/21

ORIGINAL ISSUE DATE: SEPTEMBER 18, 2019

PRELIMINARY
PRESERVATION
PLAN

PEA JOB NO.	2016-368
P.M.	JBT
DN.	TMK
DES.	TMK
DRAWING NUMBER:	

41203 DEQUINDRE ROAD	2
41203 DEQUINDRE ROAD PARCEL NO. 20–12–476–010 GARAGE GARAGE	RCP SAN REF) — 12"RCP SAN REF) — 12"RCP ST
FAM FEXISTING TREE TO BE REMOVED TYP. FAM FAM FAM FAM FAM FAM FAM FA	DEQUINDRE RO (60' WIDE - 1/2 R.F)
639 644 639 644 634 + 635 634 + 635 634 + 635 645 + 644	644 644 15"RCP SAN 15"RCP SAN 15"RCP SAN 12"MM (REF)
OWNER: GFA DEVELOPMENT, INC. Control of the cont	12 RCP ST
TACO BELL A1167 DEQUINDRE ROAD PARCEL NO. 20–12–476–071	-15"RCP SAN12"WM (REF)6"S-MP GAS (REF)
FEDORA DRIVE O. 20–12–476–031 White the state of the st	
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